




09/05/06 PERMIT RE-SUBMITTAL
09/19/06 AMPHITHEATER COORDINATION

DESIGN NUMBER
A545520
PROJECT NUMBER
F&A 04047
DATE
10/26/06
PROJECT MANAGER
R. JONES
DRAWN BY
RJ

SCOTTSDALE WATERFRONT RESIDENCES

LOCATION
SCOTTSDALE, ARIZONA

OVERALL
HARDSCAPE
PLAN

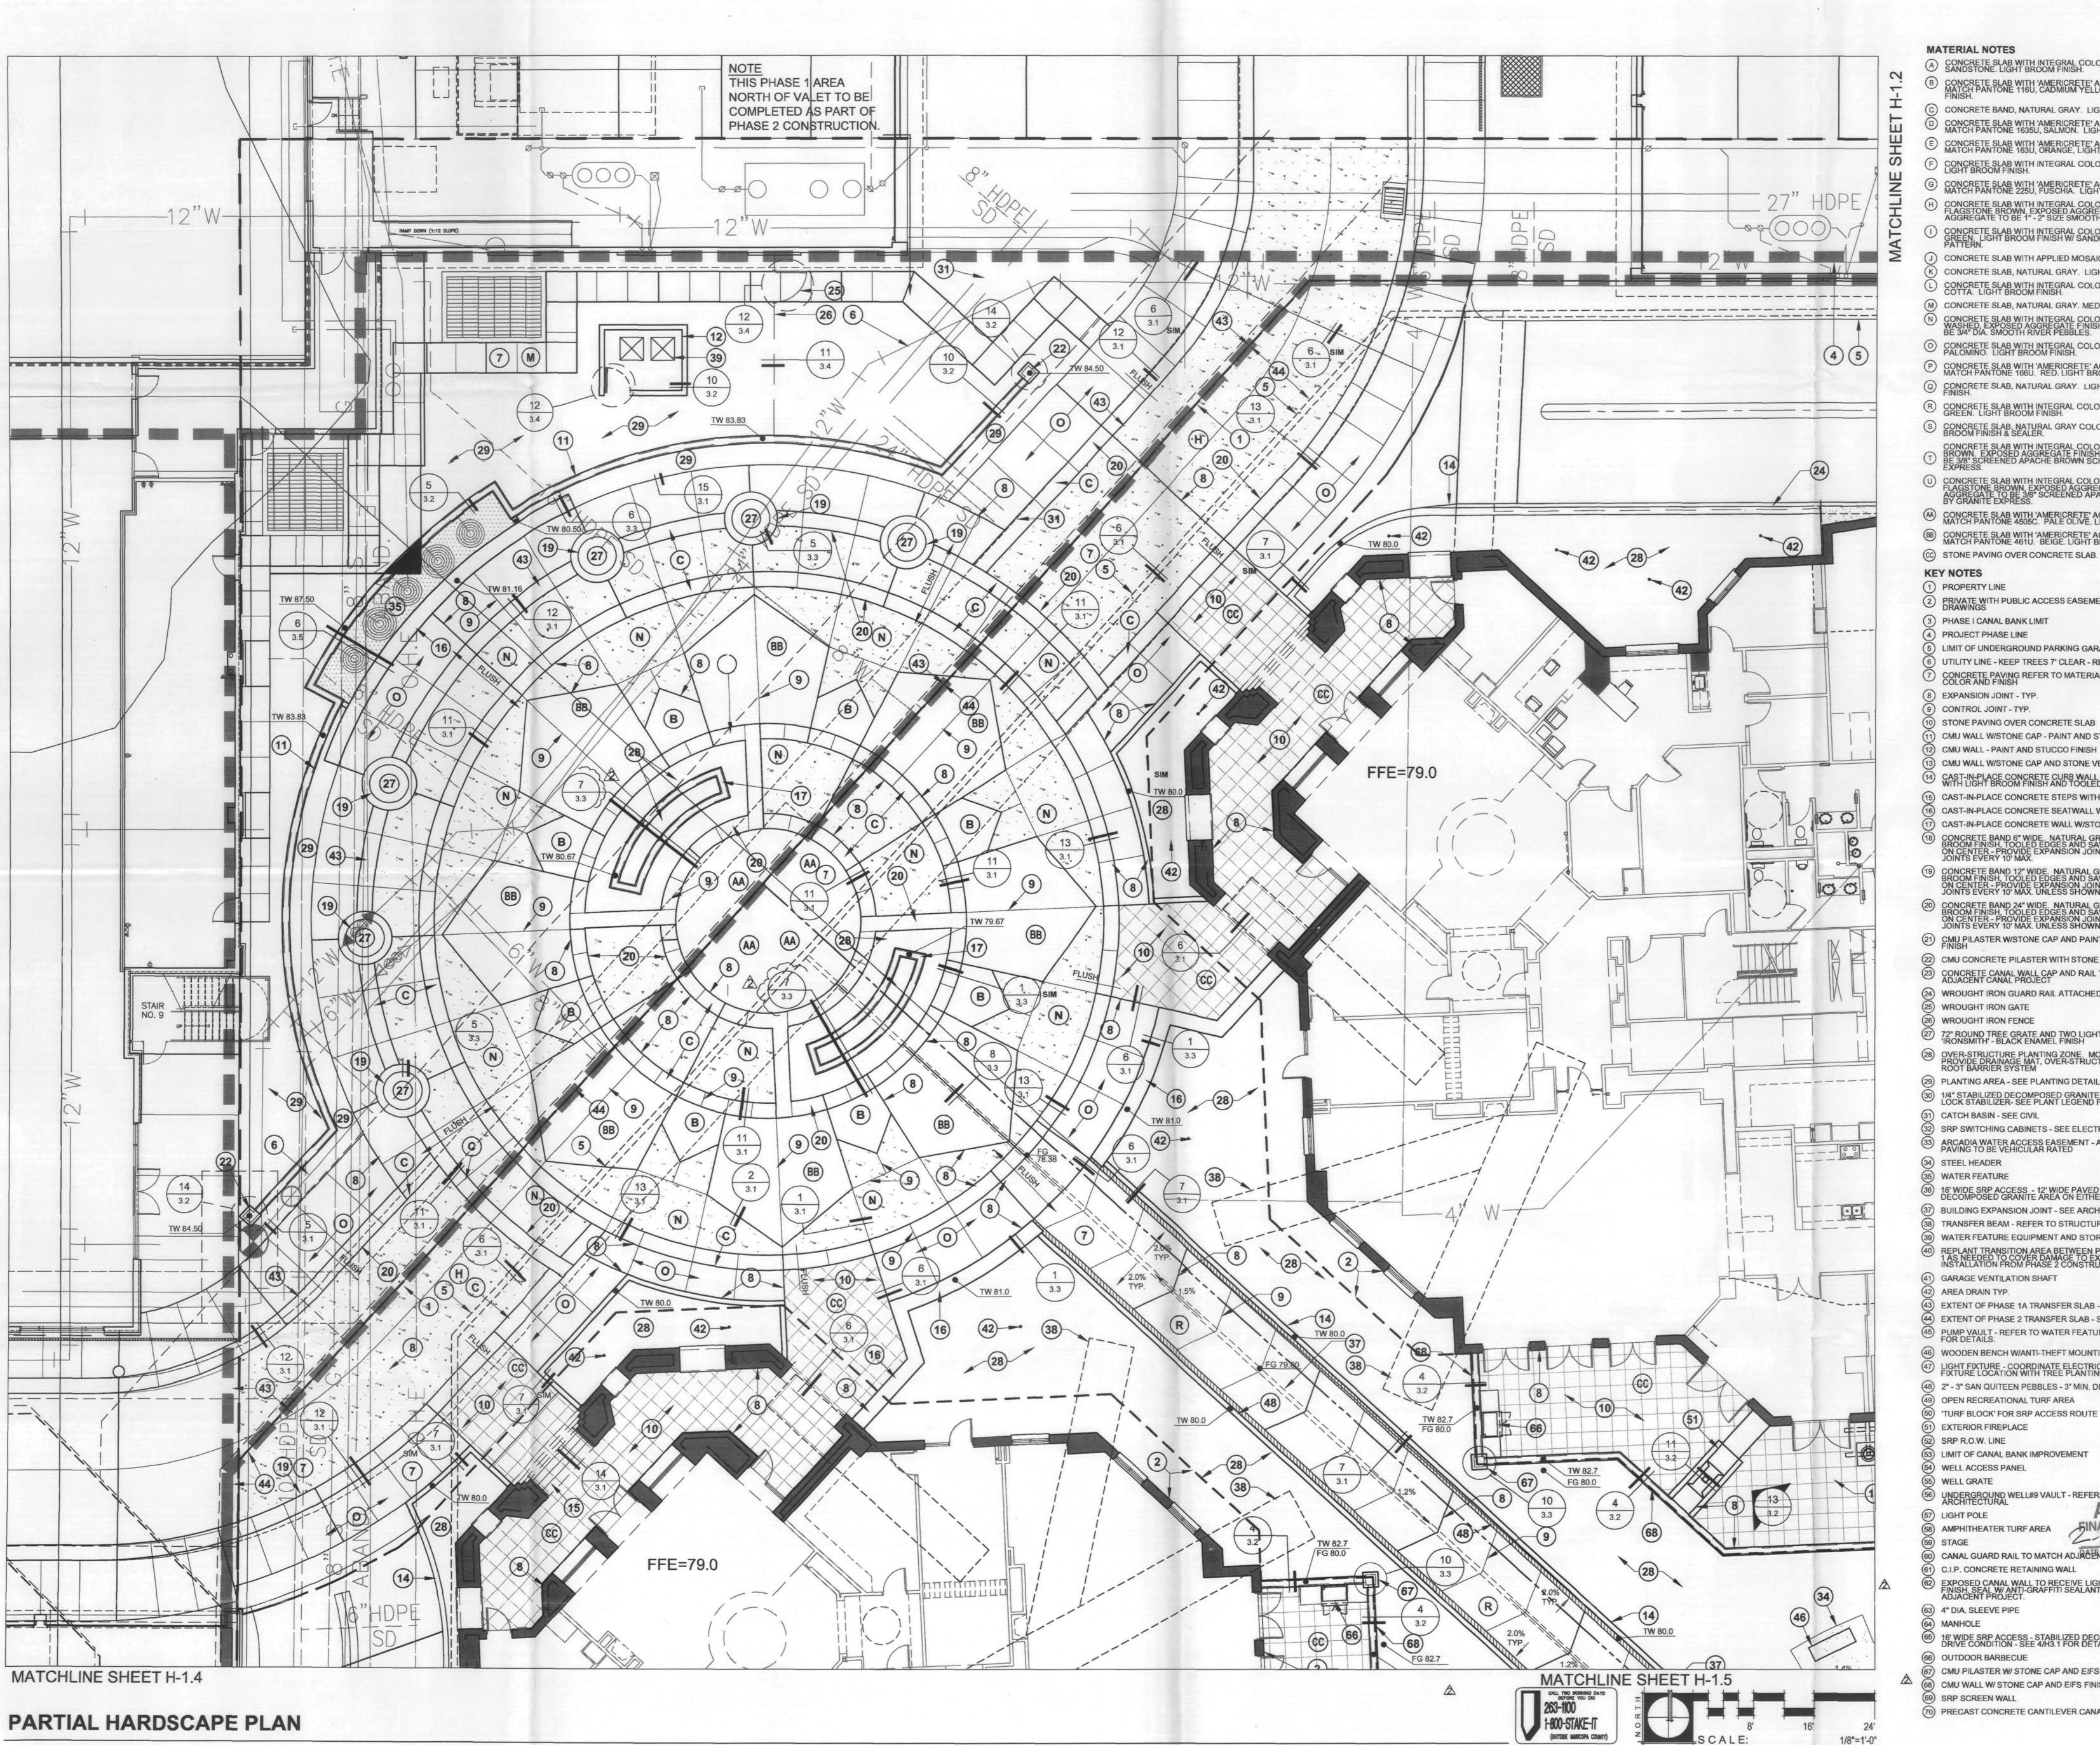

CONCRETE SLAB WITH APPLIED MOSAIC TILE.

CONCRETE SLAB WITH INTEGRAL COLOR: DAVIS, TERRA COTTA. LIGHT BROOM FINISH. (M) CONCRETE SLAB, NATURAL GRAY. MEDIUM BROOM FINISH.

O CONCRETE SLAB WITH INTEGRAL COLOR: DAVIS, PALOMINO. LIGHT BROOM FINISH. P CONCRETE SLAB WITH 'AMERICRETE' ACRYLIC STAIN TO MATCH PANTONE 166U. RED. LIGHT BROOM FINISH.

O CONCRETE SLAB, NATURAL GRAY. LIGHT SANDBLAST FINISH.

R CONCRETE SLAB WITH INTEGRAL COLOR: DAVIS, WILLOW GREEN. LIGHT BROOM FINISH. S CONCRETE SLAB, NATURAL GRAY COLOR WITH LIGHT BROOM FINISH & SEALER.

CONCRETE SLAB WITH INTEGRAL COLOR: DAVIS, YOSEMITI BROWN. EXPOSED AGGREGATE FINISH – AGGREGATE TO BE 3/8" SCREENED APACHE BROWN SCHIST BY GRANITE

KEY NOTES

PRIVATE WITH PUBLIC ACCESS EASEMENT - REFER TO CIVIL DRAWINGS

(3) PHASE I CANAL BANK LIMIT

b) LIMIT OF UNDERGROUND PARKING GARAGE STRUCTURE

8) EXPANSION JOINT - TYP.

10) STONE PAVING OVER CONCRETE SLAB CMU WALL W/STONE CAP - PAINT AND STUCCO FINISH

CMU WALL - PAINT AND STUCCO FINISH

3) CMU WALL W/STONE CAP AND STONE VENEER CAST-IN-PLACE CONCRETE CURB WALL - NATURAL GREY WITH LIGHT BROOM FINISH AND TOOLED EDGES

15) CAST-IN-PLACE CONCRETE STEPS WITH STONE VENEER (6) CAST-IN-PLACE CONCRETE SEATWALL W/STONE VENEER CAST-IN-PLACE CONCRETE WALL W/STONE VENEER BOUCRETE BAND 6" WIDE. NATURAL GREY WITH LIGHT BROOM FINISH, TOOLED EDGES AND SAWCUT JOINTS AT 3' ON CENTER - PROVIDE EXPANSION JOINTS AND CONTROL JOINTS EVERY 10' MAX.

CONCRETE BAND 24" WIDE. NATURAL GREY WITH LIGHT BROOM FINISH, TOOLED EDGES AND SAWCUT JOINTS AT 3' ON CENTER - PROVIDE EXPANSION JOINTS AND CONTROL JOINTS EVERY 10' MAX. UNLESS SHOWN OTHERWISE.

21) CMU PILASTER W/STONE CAP AND PAINT AND STUCCO

(22) CMU CONCRETE PILASTER WITH STONE VENEER.

(23) CONCRETE CANAL WALL CAP AND RAIL TO MATCH ADJACENT CANAL PROJECT 24) WROUGHT IRON GUARD RAIL ATTACHED TO WALL

WROUGHT IRON GATE WROUGHT IRON FENCE

OVER-STRUCTURE PLANTING ZONE. MOUND SOIL @ TREE. PROVIDE DRAINAGE MAT, OVER-STRUCTURE SOIL MIX, AND ROOT BARRIER SYSTEM

(29) PLANTING AREA - SEE PLANTING DETAILS FOR SOIL DEPTHS (30) 1/4" STABILIZED DECOMPOSED GRANITE W/MARLOC' SOIL LOCK STABILIZER- SEE PLANT LEGEND FOR DG COLOR 31) CATCH BASIN - SEE CIVIL

SRP SWITCHING CABINETS - SEE ELECTRICAL PLANS ARCADIA WATER ACCESS EASEMENT - ALL CONCRETE PAVING TO BE VEHICULAR RATED

(34) STEEL HEADER WATER FEATURE

(36) 16' WIDE SRP ACCESS - 12' WIDE PAVED ROAD W/2' CLEAR DECOMPOSED GRANITE AREA ON EITHER SIDE OF ROAD BUILDING EXPANSION JOINT - SEE ARCHITECTURAL

TRANSFER BEAM - REFER TO STRUCTURAL DRAWING WATER FEATURE EQUIPMENT AND STORAGE AREA

GARAGE VENTILATION SHAFT AREA DRAIN TYP.

EXTENT OF PHASE 1A TRANSFER SLAB - SEE STRUCTURAL EXTENT OF PHASE 2 TRANSFER SLAB - SEE STRUCTURAL PUMP VAULT - REFER TO WATER FEATURE SHOP DRAWINGS FOR DETAILS.

46) WOODEN BENCH W/ANTI-THEFT MOUNTING INSTALLATION 47 LIGHT FIXTURE - COORDINATE ELECTRICAL LINE ROUTE AND FIXTURE LOCATION WITH TREE PLANTING

(48) 2" - 3" SAN QUITEEN PEBBLES - 3" MIN. DEPTH OPEN RECREATIONAL TURF AREA TURF BLOCK' FOR SRP ACCESS ROUTE THROUGH TURF

EXTERIOR FIREPLACE SRP R.O.W. LINE 53) LIMIT OF CANAL BANK IMPROVEMENT (54) WELL ACCESS PANEL

(55) WELL GRATE 560 UNDERGROUND WELL#9 VAULT - REFER TO ARCHITECTURAL (57) LIGHT POLE

APPRO) 58) AMPHITHEATER TURF AREA
59) STAGE STAGE 60 CANAL GUARD RAIL TO MATCH ADJACENT CANAL PROJ

C.I.P. CONCRETE RETAINING WALL 62 EXPOSED CANAL WALL TO RECEIVE LIGHT SANDBLAST FINISH, SEAL WI ANTI-GRAFFITI SEALANT TO MATCH ADJACENT PROJECT.

(63) 4" DIA. SLEEVE PIPE (64) MANHOLE

65 16' WIDE SRP ACCESS - STABILIZED DECOMPOSED GRANITE DRIVE CONDITION - SEE 4/H3.1 FOR DETAIL. (66) OUTDOOR BARBECUE 67) CMU PILASTER W/ STONE CAP AND EIFS FINISH (68) CMU WALL W/ STONE CAP AND EIFS FINISH


(70) PRECAST CONCRETE CANTILEVER CANAL OVERLOOK

Opus Architects &

Engineers, Inc.

10350 Bren Road West Minnetonka, MN 55343-0110 952-656-4444 952-656-4529 fax



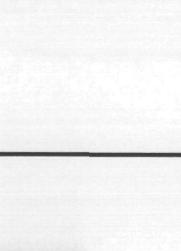



ISSUE RECORD

05/02/06 PERMIT SUBMITTAL ↑ 06/02/06 PH.1/2 OWNER REV.


09/05/06 PERMIT RE-SUBMITTAL 09/19/06 AMPHITHEATER COORDINATION 10/26/06 CANAL BANK IMPROVEMENTS \$\tilde{\Delta}\$ 12/11/06 CANAL BANK COORDINATION

DESIGN NUMBER A545520 PROJECT NUMBER F&A 04047 10/26/06

R. JONES DRAWN BY CHECKED BY

PROJECT MANAGER

KEY PLAN

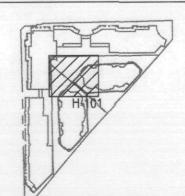


OWR Construction, Inc.

Suite 800
Phoenix, Arizona 85016
602-468-7000
602-468-7010 fax

WATERFRONT RESIDENCES

SCOTTSDALE, ARIZONA

SHEET TITLE PARTIAL **HARDSCAPE** PLAN

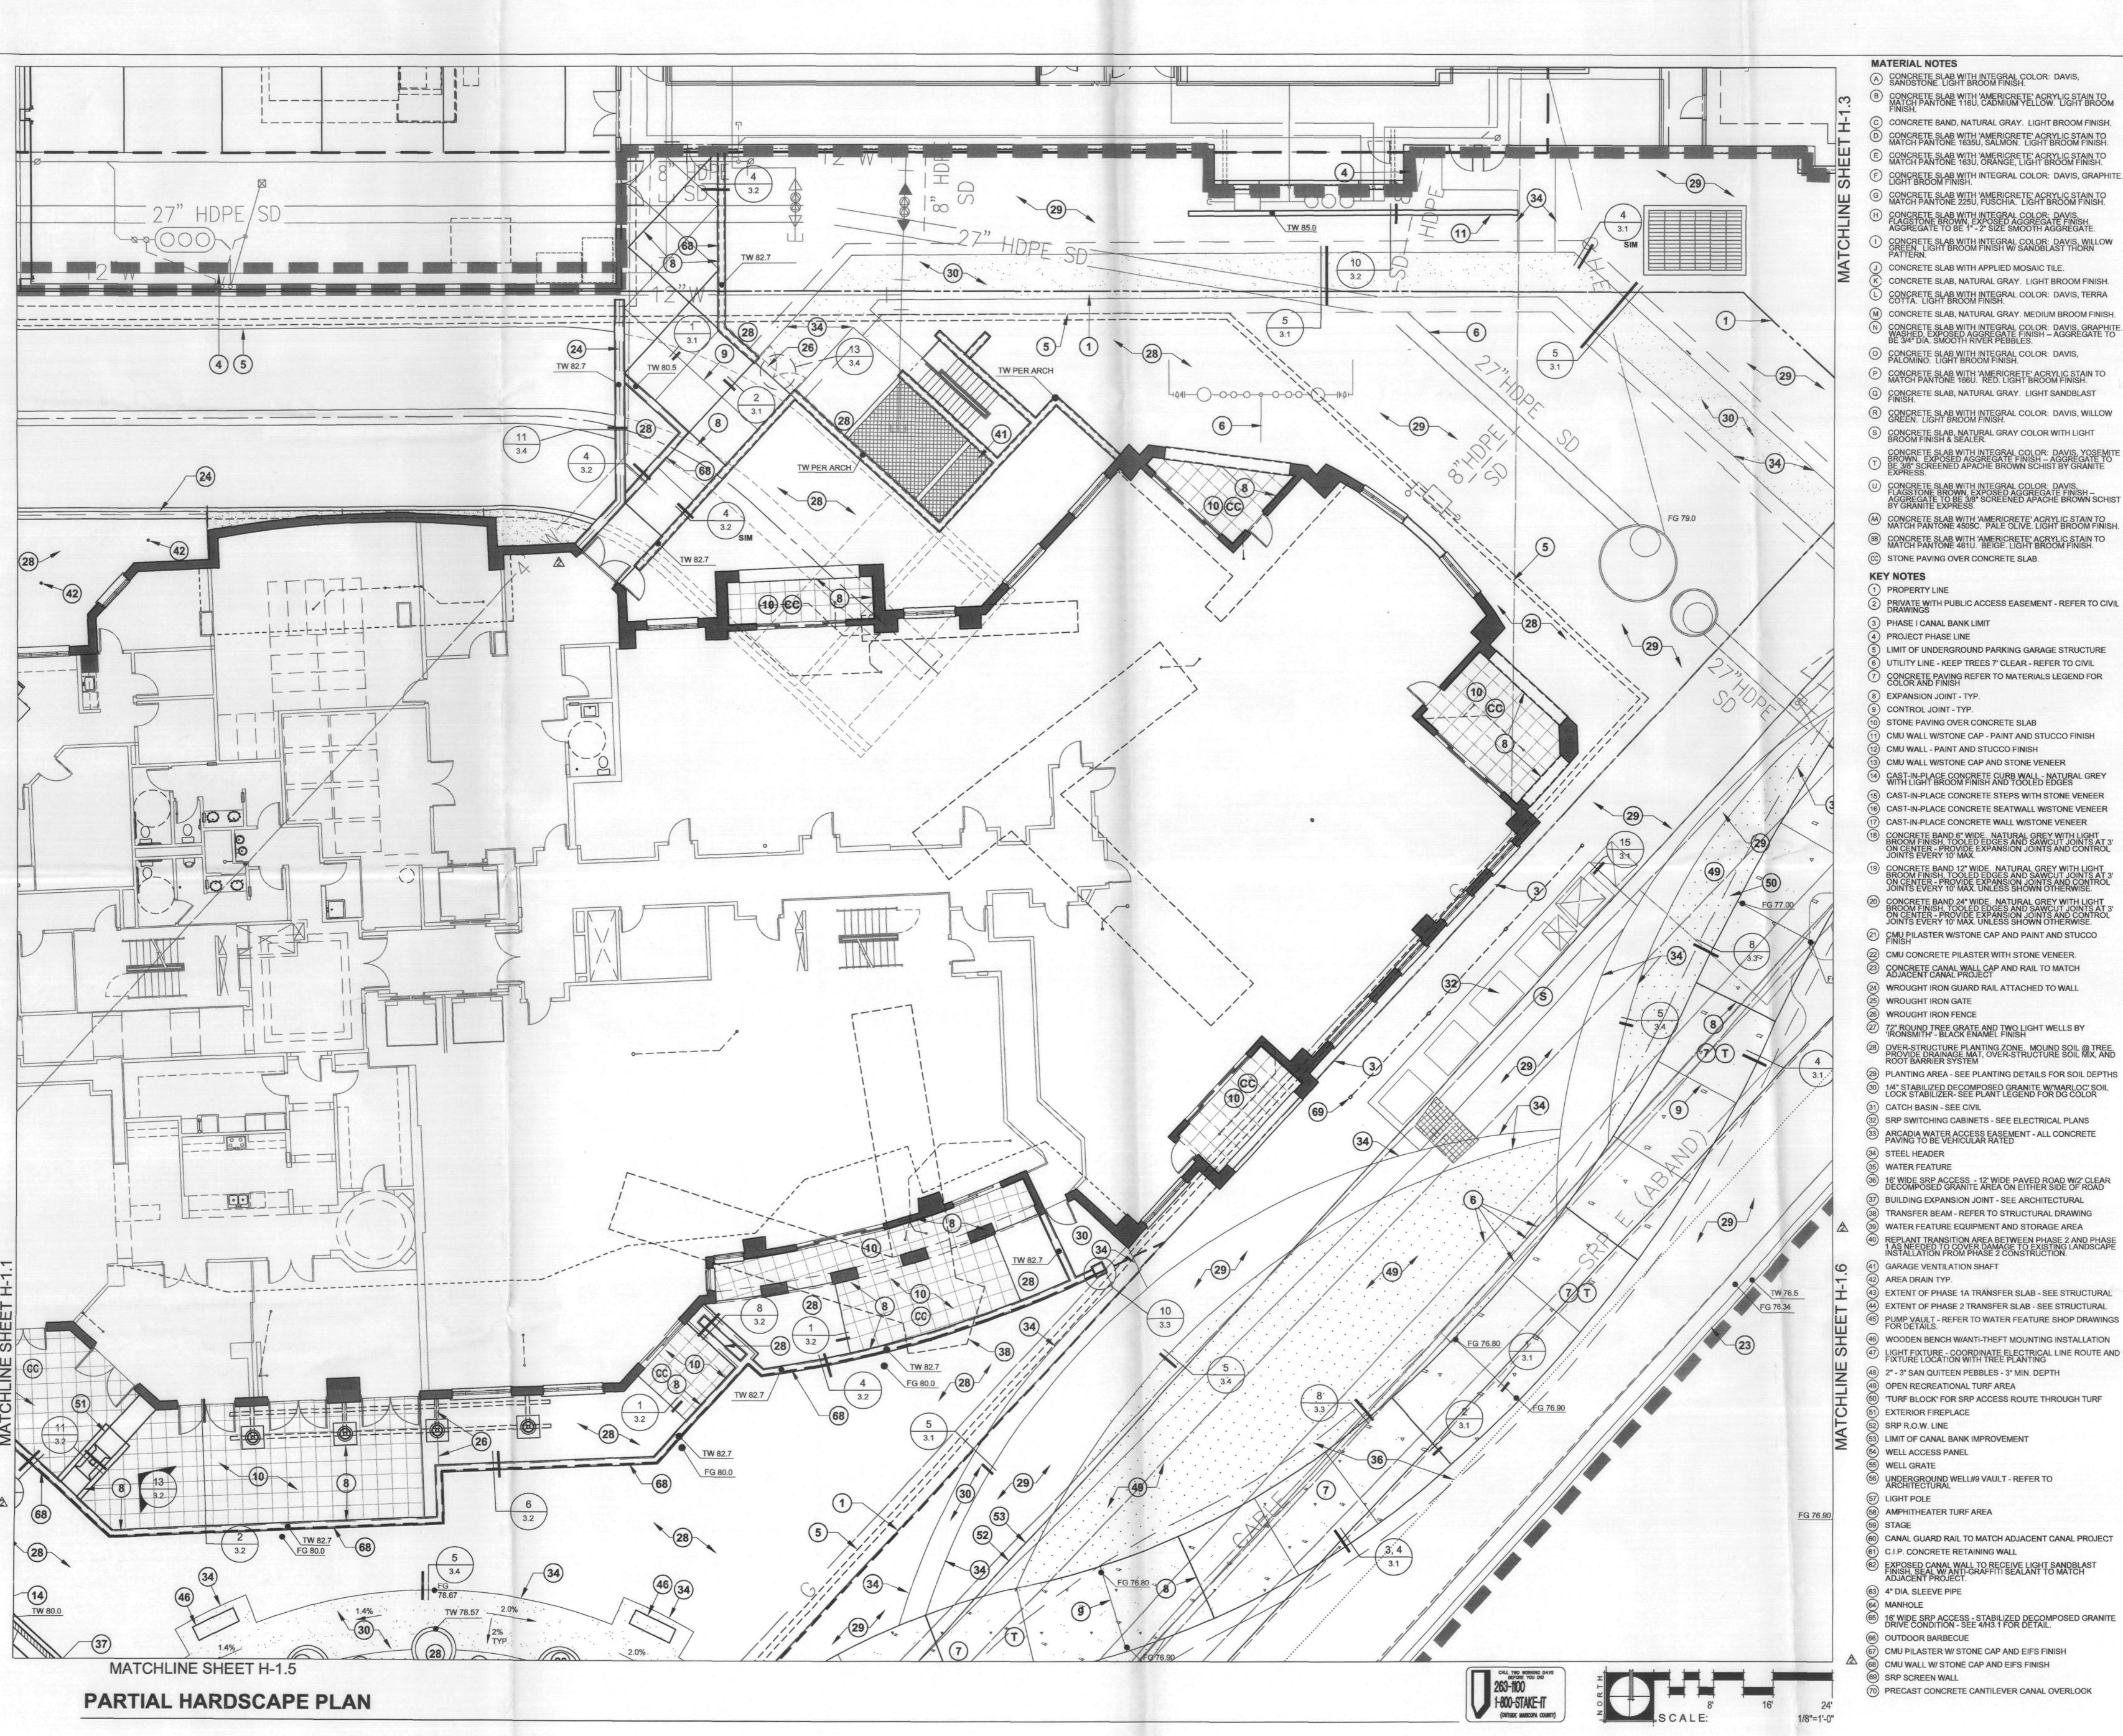

A CONCRETE SLAB WITH INTEGRAL COLOR: DAVIS, SANDSTONE. LIGHT BROOM FINISH.

CONCRETE BAND, NATURAL GRAY. LIGHT BROOM FINISH.

CONCRETE SLAB WITH INTEGRAL COLOR: DAVIS, GRAPHITE. LIGHT BROOM FINISH.

CONCRETE SLAB WITH INTEGRAL COLOR: DAVIS, WILLOW GREEN, LIGHT BROOM FINISH W/ SANDBLAST THORN

CONCRETE SLAB, NATURAL GRAY. LIGHT BROOM FINISH.

CONCRETE SLAB, NATURAL GRAY. LIGHT SANDBLAST FINISH.

CONCRETE SLAB WITH INTEGRAL COLOR: DAVIS, FLAGSTONE BROWN, EXPOSED AGGREGATE FINISH – AGGREGATE TO BE 3/8" SCREENED APACHE BROWN SCHIST BY GRANITE EXPRESS.

BB CONCRETE SLAB WITH 'AMERICRETE' ACRYLIC STAIN TO MATCH PANTONE 461U. BEIGE, LIGHT BROOM FINISH. CC STONE PAVING OVER CONCRETE SLAB.

PRIVATE WITH PUBLIC ACCESS EASEMENT - REFER TO CIVIL DRAWINGS

PROJECT PHASE LINE LIMIT OF UNDERGROUND PARKING GARAGE STRUCTURE

EXPANSION JOINT - TYP.

CONTROL JOINT - TYP.

STONE PAVING OVER CONCRETE SLAB

CMU WALL W/STONE CAP - PAINT AND STUCCO FINISH CMU WALL - PAINT AND STUCCO FINISH

CAST-IN-PLACE CONCRETE SEATWALL W/STONE VENEER CAST-IN-PLACE CONCRETE WALL W/STONE VENEER CONCRETE BAND 6" WIDE. NATURAL GREY WITH LIGHT BROOM FINISH, TOOLED EDGES AND SAWCUT JOINTS AT 3' ON CENTER - PROVIDE EXPANSION JOINTS AND CONTROL JOINTS EVERY 10' MAX.

CMU PILASTER W/STONE CAP AND PAINT AND STUCCO

CMU CONCRETE PILASTER WITH STONE VENEER.

WROUGHT IRON GUARD RAIL ATTACHED TO WALL WROUGHT IRON GATE

WROUGHT IRON FENCE

72" ROUND TREE GRATE AND TWO LIGHT WELLS BY 'IRONSMITH' - BLACK ENAMEL FINISH OVER-STRUCTURE PLANTING ZONE. MOUND SOIL @ TREE. PROVIDE DRAINAGE MAT, OVER-STRUCTURE SOIL MIX, AND ROOT BARRIER SYSTEM

PLANTING AREA - SEE PLANTING DETAILS FOR SOIL DEPTHS

30 1/4" STABILIZED DECOMPOSED GRANITE W/'MARLOC' SOIL LOCK STABILIZER- SEE PLANT LEGEND FOR DG COLOR CATCH BASIN - SEE CIVIL SRP SWITCHING CABINETS - SEE ELECTRICAL PLANS

ARCADIA WATER ACCESS EASEMENT - ALL CONCRETE PAVING TO BE VEHICULAR RATED

WATER FEATURE 16' WIDE SRP ACCESS - 12' WIDE PAVED ROAD W/2' CLEAR DECOMPOSED GRANITE AREA ON EITHER SIDE OF ROAD

BUILDING EXPANSION JOINT - SEE ARCHITECTURAL TRANSFER BEAM - REFER TO STRUCTURAL DRAWING WATER FEATURE EQUIPMENT AND STORAGE AREA REPLANT TRANSITION AREA BETWEEN PHASE 2 AND PHASE 1 AS NEEDED TO COVER DAMAGE TO EXISTING LANDSCAPE INSTALLATION FROM PHASE 2 CONSTRUCTION.

GARAGE VENTILATION SHAFT AREA DRAIN TYP.

EXTENT OF PHASE 1A TRANSFER SLAB - SEE STRUCTURAL EXTENT OF PHASE 2 TRANSFER SLAB - SEE STRUCTURAL PUMP VAULT - REFER TO WATER FEATURE SHOP DRAWINGS FOR DETAILS.

LIGHT FIXTURE - COORDINATE ELECTRICAL LINE ROUTE AND FIXTURE LOCATION WITH TREE PLANTING 8) 2" - 3" SAN QUITEEN PEBBLES - 3" MIN. DEPTH

OPEN RECREATIONAL TURF AREA 'TURF BLOCK' FOR SRP ACCESS ROUTE THROUGH TURF EXTERIOR FIREPLACE

LIMIT OF CANAL BANK IMPROVEMENT WELL ACCESS PANEL

UNDERGROUND WELL#9 VAULT - REFER TO ARCHITECTURAL

AMPHITHEATER TURF AREA

CANAL GUARD RAIL TO MATCH ADJACENT CANAL PROJECT C.I.P. CONCRETE RETAINING WALL

(63) 4" DIA. SLEEVE PIPE

(66) OUTDOOR BARBECUE CMU PILASTER W/ STONE CAP AND EIFS FINISH CMU WALL W/ STONE CAP AND EIFS FINISH

70) PRECAST CONCRETE CANTILEVER CANAL OVERLOOK

Opus Architects & Engineers, Inc.

10350 Bren Road West Minnetonka, MN 55343-0110 952-656-4444 952-656-4529 fax





ISSUE RECORD 05/02/06 PERMIT SUBMITTAL


1 06/02/06 PH.1/2 OWNER REV. 09/05/06 PERMIT RE-SUBMITTAL 09/19/06 AMPHITHEATER COORDINATION 10/26/06 CANAL BANK IMPROVEMENTS \$\textstyle 12/11/06 CANAL BANK COORDINATION

DESIGN NUMBER A545520 PROJECT NUMBER F&A 04047 10/26/06 PROJECT MANAGER

CHECKED BY

R. JONES

DRAWN BY

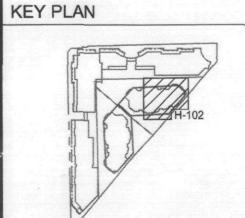

OWR Construction, Inc.

PROJECT SCOTTSDALE WATERFRONT RESIDENCES SCOTTSDALE, ARIZONA

SHEET TITLE PARTIAL **HARDSCAPE** PLAN



B CONCRETE SLAB WITH 'AMERICRETE' ACRYLIC STAIN TO MATCH PANTONE 116U, CADMIUM YELLOW. LIGHT BROOM FINISH.

C CONCRETE BAND, NATURAL GRAY. LIGHT BROOM FINISH. CONCRETE SLAB WITH 'AMERICRETE' ACRYLIC STAIN TO MATCH PANTONE 1635U, SALMON. LIGHT BROOM FINISH.

E CONCRETE SLAB WITH 'AMERICRETE' ACRYLIC STAIN TO MATCH PANTONE 163U, ORANGE, LIGHT BROOM FINISH.

F CONCRETE SLAB WITH INTEGRAL COLOR: DAVIS, GRAPHITE. LIGHT BROOM FINISH. CONCRETE SLAB WITH 'AMERICRETE' ACRYLIC STAIN TO MATCH PANTONE 225U, FUSCHIA. LIGHT BROOM FINISH.

H CONCRETE SLAB WITH INTEGRAL COLOR: DAVIS, FLAGSTONE BROWN, EXPOSED AGGREGATE FINISH. AGGREGATE TO BE 1" - 2" SIZE SMOOTH AGGREGATE

CONCRETE SLAB WITH INTEGRAL COLOR: DAVIS, WILLOW GREEN. LIGHT BROOM FINISH W/ SANDBLAST THORN PATTERN.

(J) CONCRETE SLAB WITH APPLIED MOSAIC TILE. CONCRETE SLAB, NATURAL GRAY. LIGHT BROOM FINISH.

(M) CONCRETE SLAB, NATURAL GRAY. MEDIUM BROOM FINISH.

P CONCRETE SLAB WITH 'AMERICRETE' ACRYLIC STAIN TO MATCH PANTONE 166U. RED. LIGHT BROOM FINISH.

Q CONCRETE SLAB, NATURAL GRAY. LIGHT SANDBLAST FINISH. CONCRETE SLAB WITH INTEGRAL COLOR: DAVIS, WILLOW GREEN. LIGHT BROOM FINISH.

S CONCRETE SLAB, NATURAL GRAY COLOR WITH LIGHT BROOM FINISH & SEALER.

CONCRETE SLAB WITH INTEGRAL COLOR: DAVIS, YOSEMITE BROWN. EXPOSED AGGREGATE FINISH – AGGREGATE TO BE 3/8" SCREENED APACHE BROWN SCHIST BY GRANITE EXPRESS.

CONCRETE SLAB WITH INTEGRAL COLOR: DAVIS, FLAGSTONE BROWN, EXPOSED AGGREGATE FINISH – AGGREGATE TO BE 3/8" SCREENED APACHE BROWN SCHIST BY GRANITE EXPRESS.

(CC) STONE PAVING OVER CONCRETE SLAB.

KEY NOTES

PRIVATE WITH PUBLIC ACCESS EASEMENT - REFER TO CIVIL DRAWINGS

(3) PHASE I CANAL BANK LIMIT

PROJECT PHASE LINE LIMIT OF UNDERGROUND PARKING GARAGE STRUCTURE UTILITY LINE - KEEP TREES 7' CLEAR - REFER TO CIVIL

OCONCRETE PAVING REFER TO MATERIALS LEGEND FOR COLOR AND FINISH (8) EXPANSION JOINT - TYP.

CONTROL JOINT - TYP.

STONE PAVING OVER CONCRETE SLAB

CMU WALL W/STONE CAP - PAINT AND STUCCO FINISH

CMU WALL - PAINT AND STUCCO FINISH CMU WALL W/STONE CAP AND STONE VENEER

(4) CAST-IN-PLACE CONCRETE CURB WALL - NATURAL GREY WITH LIGHT BROOM FINISH AND TOOLED EDGES 15) CAST-IN-PLACE CONCRETE STEPS WITH STONE VENEER

CAST-IN-PLACE CONCRETE SEATWALL W/STONE VENEER CAST-IN-PLACE CONCRETE WALL W/STONE VENEER

CONCRETE BAND 6" WIDE. NATURAL GREY WITH LIGHT BROOM FINISH, TOOLED EDGES AND SAWCUT JOINTS AT 3' ON CENTER - PROVIDE EXPANSION JOINTS AND CONTROL JOINTS EVERY 10' MAX.

21) CMU PILASTER W/STONE CAP AND PAINT AND STUCCO

(22) CMU CONCRETE PILASTER WITH STONE VENEER.

(23) CONCRETE CANAL WALL CAP AND RAIL TO MATCH ADJACENT CANAL PROJECT

WROUGHT IRON GUARD RAIL ATTACHED TO WALL

WROUGHT IRON FENCE

72" ROUND TREE GRATE AND TWO LIGHT WELLS BY 'IRONSMITH' - BLACK ENAMEL FINISH

OVER-STRUCTURE PLANTING ZONE. MOUND SOIL @ TREE. PROVIDE DRAINAGE MAT, OVER-STRUCTURE SOIL MIX, AND ROOT BARRIER SYSTEM

(29) PLANTING AREA - SEE PLANTING DETAILS FOR SOIL DEPTHS (30) 1/4" STABILIZED DECOMPOSED GRANITE W/'MARLOC' SOIL LOCK STABILIZER- SEE PLANT LEGEND FOR DG COLOR

CATCH BASIN - SEE CIVIL SRP SWITCHING CABINETS - SEE ELECTRICAL PLANS

ARCADIA WATER ACCESS EASEMENT - ALL CONCRETE PAVING TO BE VEHICULAR RATED (34) STEEL HEADER

WATER FEATURE 16' WIDE SRP ACCESS - 12' WIDE PAVED ROAD W/2' CLEAR DECOMPOSED GRANITE AREA ON EITHER SIDE OF ROAD

TRANSFER BEAM - REFER TO STRUCTURAL DRAWING WATER FEATURE EQUIPMENT AND STORAGE AREA

GARAGE VENTILATION SHAFT

AREA DRAIN TYP. EXTENT OF PHASE 1A TRANSFER SLAB - SEE STRUCTURAL

46) WOODEN BENCH W/ANTI-THEFT MOUNTING INSTALLATION 47 LIGHT FIXTURE - COORDINATE ELECTRICAL LINE ROUTE AND FIXTURE LOCATION WITH TREE PLANTING

(48) 2" - 3" SAN QUITEEN PEBBLES - 3" MIN. DEPTH OPEN RECREATIONAL TURF AREA

'TURF BLOCK' FOR SRP ACCESS ROUTE THROUGH TURF

SRP R.O.W. LINE LIMIT OF CANAL BANK IMPROVEMENT WELL ACCESS PANEL

WELL GRATE UNDERGROUND WELL#9 VAULT - REFER TO ARCHITECTURAL

(57) LIGHT POLE AMPHITHEATER TURF AREA

CANAL GUARD RAIL TO MATCH ADJACENT CANAL PROJECT

C.I.P. CONCRETE RETAINING WALL EXPOSED CANAL WALL TO RECEIVE LIGHT SANDBLAST FINISH, SEAL W/ ANTI-GRAFFITI SEALANT TO MATCH ADJACENT PROJECT.

63) 4" DIA. SLEEVE PIPE

65 16' WIDE SRP ACCESS - STABILIZED DECOMPOSED GRANITE DRIVE CONDITION - SEE 4/H3.1 FOR DETAIL. 66 OUTDOOR BARBECUE

68) CMU WALL W/ STONE CAP AND EIFS FINISH (69) SRP SCREEN WALL (70) PRECAST CONCRETE CANTILEVER CANAL OVERLOOK



Opus Architects & Engineers, Inc.

10350 Bren Road West Minnetonka, MN 55343-0110 952-656-4444 952-656-4529 fax

REGISTRATION






05/02/06 PERMIT SUBMITTAL ↑ 06/02/06 PH.1/2 OWNER REV.

09/05/06 PERMIT RE-SUBMITTAL 09/19/06 AMPHITHEATER COORDINATION 10/26/06 CANAL BANK IMPROVEMENTS 2 12/11/06 CANAL BANK COORDINATION

DESIGN NUMBER A545520 PROJECT NUMBER F&A 04047 10/26/06

PROJECT MANAGER R. JONES DRAWN BY CHECKED BY

KEY PLAN

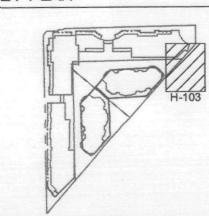


OWR Construction, Inc. 2555 East Camelback Road Suite 800 Phoenix, Arizona 85016 602-468-7000 602-468-7010 fax

SCOTTSDALE WATERFRONT RESIDENCES

SCOTTSDALE, ARIZONA

PARTIAL APPROVED HARDSCAPE PLANS PLANN PLAN DATE

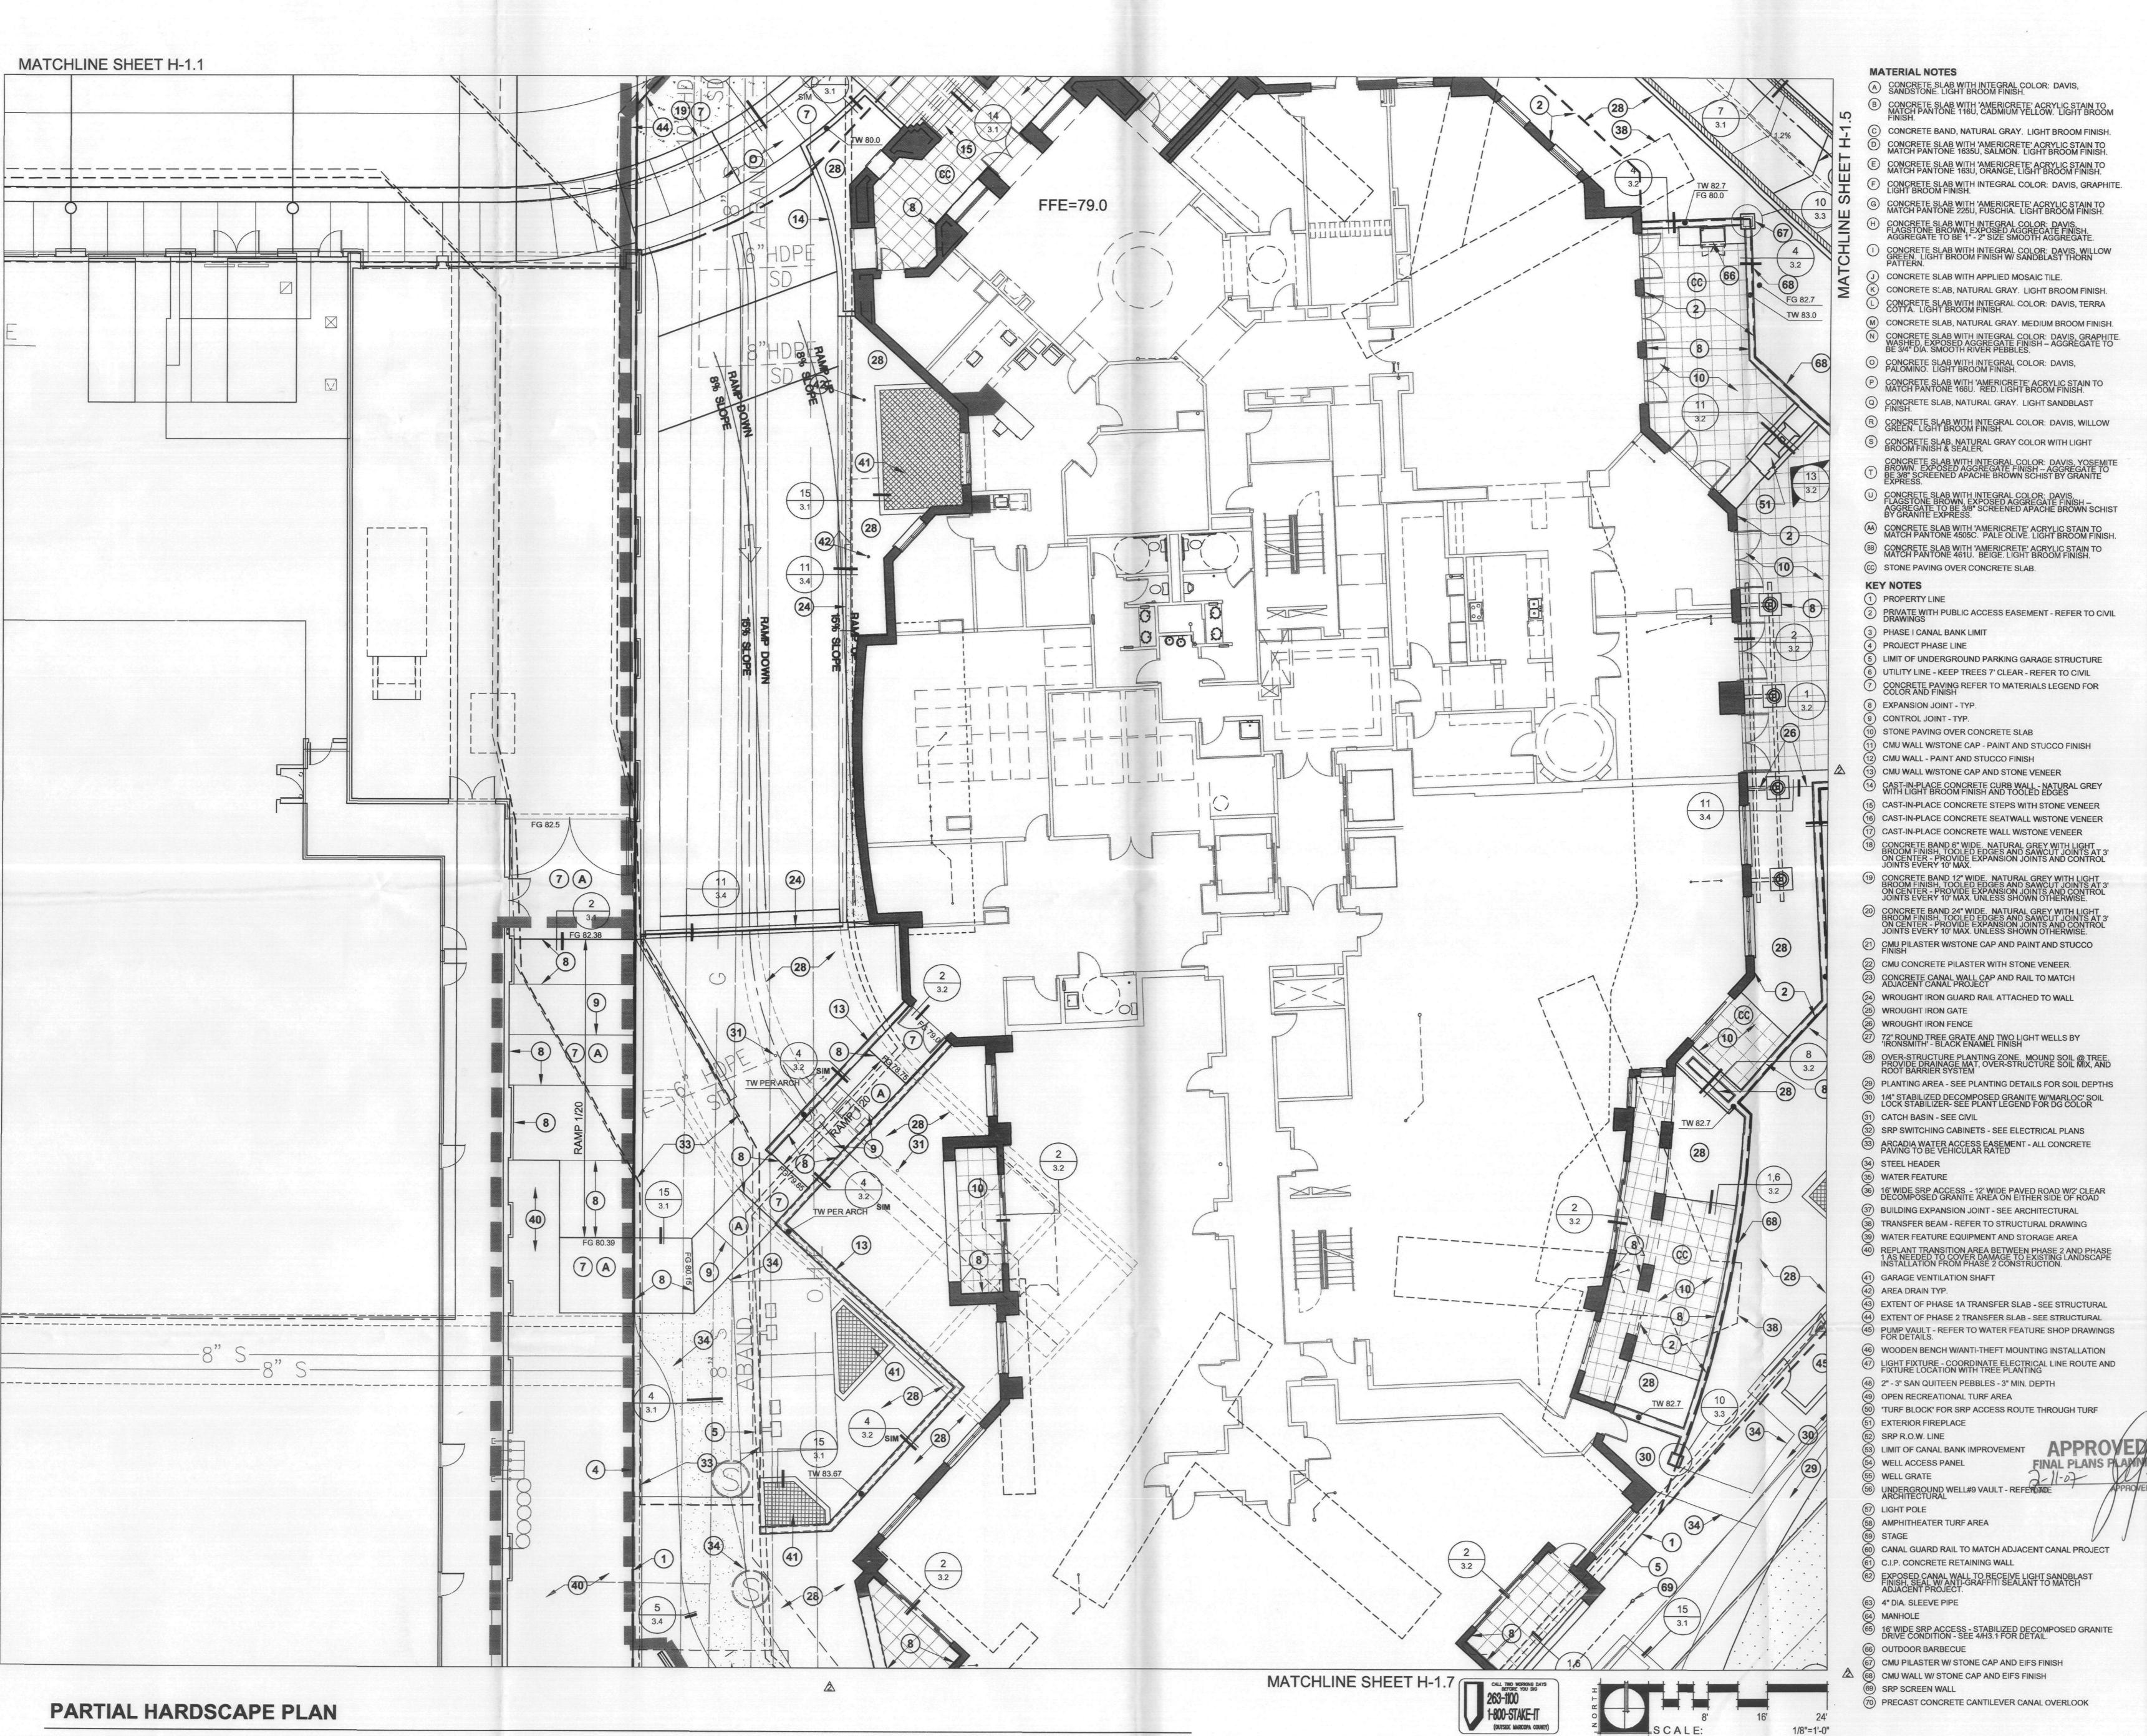



Opus Architects & Engineers, Inc.

10350 Bren Road West Minnetonka, MN 55343-0110 952-656-4444 952-656-4529 fax





ISSUE RECORD

05/02/06 PERMIT SUBMITTAL

106/02/06 PH.1/2 OWNER REV.

09/05/06 PERMIT RE-SUBMITTAL

09/19/06 AMPHITHEATER COORDINATION
10/26/06 CANAL BANK IMPROVEMENTS


12/11/06 CANAL BANK COORDINATION

DESIGN NUMBER
A545520
PROJECT NUMBER
F&A 04047
DATE
10/26/06
PROJECT MANAGER
R. JONES

KEY PLAN

DRAWN BY

CHECKED BY

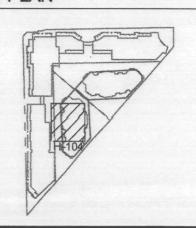

Prepared For

OWR Construction, Inc.

2555 East Camelback Road Suite 800 Phoenix, Arizona 85016 602–468–7000 602–468–7010 fax


SCOTTSDALE WATERFRONT RESIDENCES

SCOTTSDALE, ARIZONA

SHEET TITLE

PARTIAL

HARDSCAPE PLAN

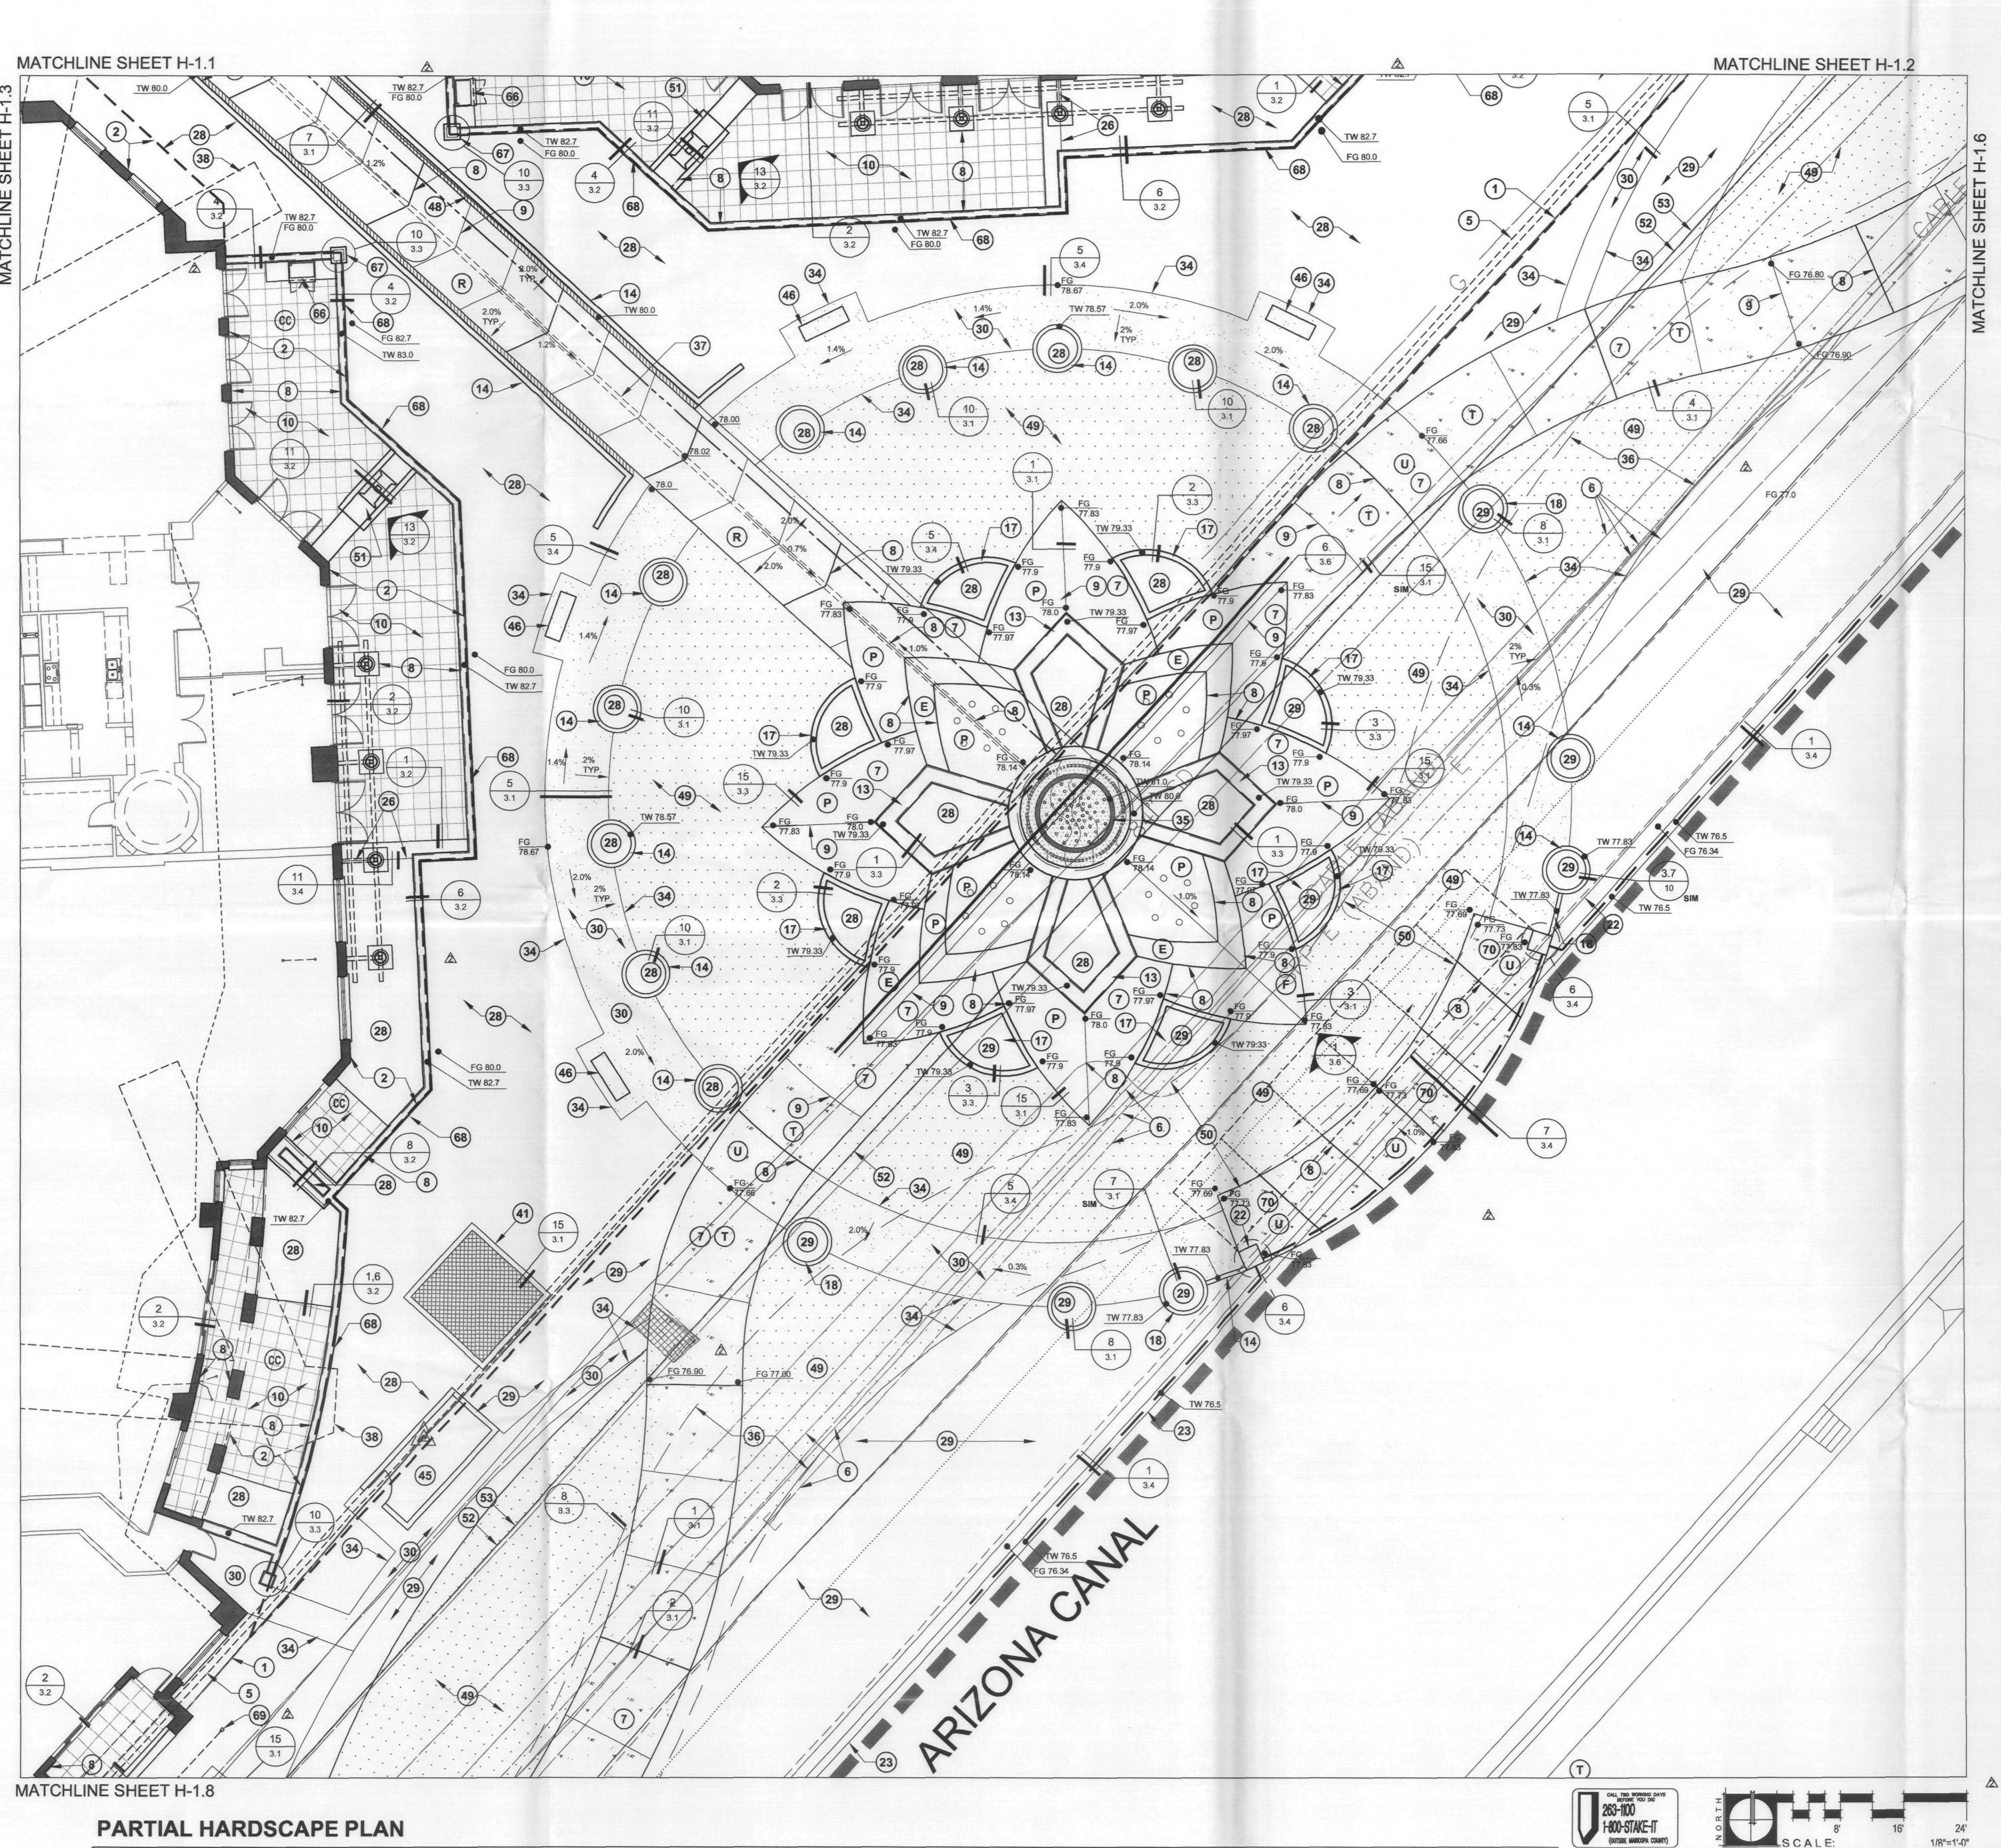

B CONCRETE SLAB WITH 'AMERICRETE' ACRYLIC STAIN TO MATCH PANTONE 116U, CADMIUM YELLOW. LIGHT BROOM

C CONCRETE BAND, NATURAL GRAY. LIGHT BROOM FINISH.

CONCRETE SLAB WITH APPLIED MOSAIC TILE.

O CONCRETE SLAB WITH INTEGRAL COLOR: DAVIS, PALOMINO, LIGHT BROOM FINISH.

P CONCRETE SLAB WITH 'AMERICRETE' ACRYLIC STAIN TO MATCH PANTONE 166U. RED. LIGHT BROOM FINISH.

R CONCRETE SLAB WITH INTEGRAL COLOR: DAVIS, WILLOW GREEN. LIGHT BROOM FINISH. S CONCRETE SLAB, NATURAL GRAY COLOR WITH LIGHT BROOM FINISH & SEALER.

CC STONE PAVING OVER CONCRETE SLAB.

KEY NOTES 1 PROPERTY LINE

PRIVATE WITH PUBLIC ACCESS EASEMENT - REFER TO CIVIL DRAWINGS

B) PHASE I CANAL BANK LIMIT

LIMIT OF UNDERGROUND PARKING GARAGE STRUCTURE

(8) EXPANSION JOINT - TYP. CONTROL JOINT - TYP.

STONE PAVING OVER CONCRETE SLAB CMU WALL W/STONE CAP - PAINT AND STUCCO FINISH

CMU WALL - PAINT AND STUCCO FINISH CMU WALL WISTONE CAP AND STONE VENEER

CAST-IN-PLACE CONCRETE STEPS WITH STONE VENEER

CAST-IN-PLACE CONCRETE SEATWALL W/STONE VENEER CAST-IN-PLACE CONCRETE WALL W/STONE VENEER

CMU PILASTER W/STONE CAP AND PAINT AND STUCCO 22) CMU CONCRETE PILASTER WITH STONE VENEER.

WROUGHT IRON GUARD RAIL ATTACHED TO WALL WROUGHT IRON GATE

WROUGHT IRON FENCE 72" ROUND TREE GRATE AND TWO LIGHT WELLS BY 'IRONSMITH' - BLACK ENAMEL FINISH

OVER-STRUCTURE PLANTING ZONE. MOUND SOIL @ TREE. PROVIDE DRAINAGE MAT, OVER-STRUCTURE SOIL MIX, AND ROOT BARRIER SYSTEM 29) PLANTING AREA - SEE PLANTING DETAILS FOR SOIL DEPTHS

(30) 1/4" STABILIZED DECOMPOSED GRANITE W/'MARLOC' SOIL LOCK STABILIZER- SEE PLANT LEGEND FOR DG COLOR CATCH BASIN - SEE CIVIL

SRP SWITCHING CABINETS - SEE ELECTRICAL PLANS ARCADIA WATER ACCESS EASEMENT - ALL CONCRETE PAVING TO BE VEHICULAR RATED

STEEL HEADER WATER FEATURE

TRANSFER BEAM - REFER TO STRUCTURAL DRAWING

GARAGE VENTILATION SHAFT AREA DRAIN TYP.

EXTENT OF PHASE 1A TRANSFER SLAB - SEE STRUCTURAL EXTENT OF PHASE 2 TRANSFER SLAB - SEE STRUCTURAL

WOODEN BENCH W/ANTI-THEFT MOUNTING INSTALLATION 3) 2" - 3" SAN QUITEEN PEBBLES - 3" MIN. DEPTH

OPEN RECREATIONAL TURF AREA 'TURF BLOCK' FOR SRP ACCESS ROUTE THROUGH TURF EXTERIOR FIREPLACE

SRP R.O.W. LINE LIMIT OF CANAL BANK IMPROVEMENT WELL ACCESS PANEL

WELL GRATE 66 UNDERGROUND WELL#9 VAULT - REFER TO ARCHITECTURAL

(57) LIGHT POLE 58) AMPHITHEATER TURF AREA

STAGE

60) CANAL GUARD RAIL TO MATCH ADJACENT CANAL PROJECT (1) C.I.P. CONCRETE RETAINING WALL

63) 4" DIA. SLEEVE PIPE

(64) MANHOLE 65) 16' WIDE SRP ACCESS - STABILIZED DECOMPOSED GRANITE DRIVE CONDITION - SEE 4/H3.1 FOR DETAIL.

(66) OUTDOOR BARBECUE 67) CMU PILASTER W/ STONE CAP AND EIFS FINISH (68) CMU WALL W/ STONE CAP AND EIFS FINISH 69 SRP SCREEN WALL

(70) PRECAST CONCRETE CANTILEVER CANAL OVERLOOK

OPUS. Opus Architects & Engineers, Inc. 10350 Bren Road West Minnetonka, MN 55343-0110 952-656-4444 952-656-4529 fax

REGISTRATION




05/02/06 PERMIT SUBMITTAL 1 06/02/06 PH.1/2 OWNER REV.

09/05/06 PERMIT RE-SUBMITTAL 09/19/06 AMPHITHEATER COORDINATION 10/26/06 CANAL BANK IMPROVEMENTS 2 12/11/06 CANAL BANK COORDINATION

A545520 PROJECT NUMBER F&A 04047 10/26/06 PROJECT MANAGER R. JONES DRAWN BY

KEY PLAN

CHECKED BY

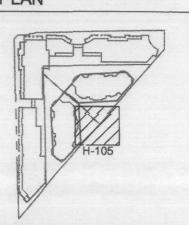

SCOTTSDALE WATERFRONT

SCOTTSDALE, ARIZONA

RESIDENCES

PARTIAL HARDSCAPE PLAN



- F CONCRETE SLAB WITH INTEGRAL COLOR: DAVIS, GRAPHITE. LIGHT BROOM FINISH.

- CONCRETE SLAB WITH APPLIED MOSAIC TILE. CONCRETE SLAB, NATURAL GRAY. LIGHT BROOM FINISH.
- CONCRETE SLAB, NATURAL GRAY. MEDIUM BROOM FINISH.

- CONCRETE SLAB, NATURAL GRAY. LIGHT SANDBLAST FINISH.

- CC STONE PAVING OVER CONCRETE SLAB.
- **KEY NOTES**
- PRIVATE WITH PUBLIC ACCESS EASEMENT REFER TO CIVIL DRAWINGS
- 3) PHASE I CANAL BANK LIMIT
- PROJECT PHASE LINE
- LIMIT OF UNDERGROUND PARKING GARAGE STRUCTURE
- UTILITY LINE KEEP TREES 7' CLEAR REFER TO CIVIL
- (8) EXPANSION JOINT TYP.
- 9) CONTROL JOINT TYP.
- STONE PAVING OVER CONCRETE SLAB CMU WALL W/STONE CAP - PAINT AND STUCCO FINISH
- CMU WALL PAINT AND STUCCO FINISH
- CMU WALL W/STONE CAP AND STONE VENEER
- CAST-IN-PLACE CONCRETE STEPS WITH STONE VENEER
- CAST-IN-PLACE CONCRETE SEATWALL W/STONE VENEER CAST-IN-PLACE CONCRETE WALL W/STONE VENEER

- 21 CMU PILASTER W/STONE CAP AND PAINT AND STUCCO
- CMU CONCRETE PILASTER WITH STONE VENEER.
- (23) CONCRETE CANAL WALL CAP AND RAIL TO MATCH ADJACENT CANAL PROJECT
- WROUGHT IRON GUARD RAIL ATTACHED TO WALL WROUGHT IRON GATE
- WROUGHT IRON FENCE
- OVER-STRUCTURE PLANTING ZONE. MOUND SOIL @ TREE. PROVIDE DRAINAGE MAT, OVER-STRUCTURE SOIL MIX, AND ROOT BARRIER SYSTEM
- 29 PLANTING AREA SEE PLANTING DETAILS FOR SOIL DEPTHS
- 30 1/4" STABILIZED DECOMPOSED GRANITE W/MARLOC' SOIL LOCK STABILIZER- SEE PLANT LEGEND FOR DG COLOR
- 31) CATCH BASIN SEE CIVIL SRP SWITCHING CABINETS - SEE ELECTRICAL PLANS

- (34) STEEL HEADER WATER FEATURE
- BUILDING EXPANSION JOINT SEE ARCHITECTURAL TRANSFER BEAM - REFER TO STRUCTURAL DRAWING
- WATER FEATURE EQUIPMENT AND STORAGE AREA
- (41) GARAGE VENTILATION SHAFT AREA DRAIN TYP.
- EXTENT OF PHASE 1A TRANSFER SLAB SEE STRUCTURAL EXTENT OF PHASE 2 TRANSFER SLAB - SEE STRUCTURAL
- PUMP VAULT REFER TO WATER FEATURE SHOP DRAWINGS FOR DETAILS. WOODEN BENCH WANTI-THEFT MOUNTING INSTALLATION 47 LIGHT FIXTURE - COORDINATE ELECTRICAL LINE ROUTE AND FIXTURE LOCATION WITH TREE PLANTING
- (48) 2" 3" SAN QUITEEN PEBBLES 3" MIN. DEPTH
- OPEN RECREATIONAL TURF AREA
- 'TURF BLOCK' FOR SRP ACCESS ROUTE THROUGH TURF EXTERIOR FIREPLACE
- SRP R.O.W. LINE
- LIMIT OF CANAL BANK IMPROVEMENT
- WELL ACCESS PANEL
- WELL GRATE
- 66 UNDERGROUND WELL#9 VAULT REFER TO ARCHITECTURAL
- (57) LIGHT POLE
- AMPHITHEATER TURF AREA
- CANAL GUARD RAIL TO MATCH ADJACENT CANAL PROJECT
- 61) C.I.P. CONCRETE RETAINING WALL EXPOSED CANAL WALL TO RECEIVE LIGHT SANDBLAST FINISH, SEAL W/ ANTI-GRAFFITI SEALANT TO MATCH ADJACENT PROJECT.
- 63 4" DIA. SLEEVE PIPE
- (64) MANHOLE 65 16' WIDE SRP ACCESS - STABILIZED DECOMPOSED GRANITE DRIVE CONDITION - SEE 4/H3.1 FOR DETAIL. 66) OUTDOOR BARBECUE
- CMU PILASTER W/ STONE CAP AND EIFS FINISH (68) CMU WALL W/ STONE CAP AND EIFS FINISH (69) SRP SCREEN WALL
- 70) PRECAST CONCRETE CANTILEVER CANAL OVERLOOK



Opus Architects & Engineers, Inc.

10350 Bren Road West Minnetonka, MN 55343-0110 952-656-4444 952-656-4529 fax

REGISTRATION





ISSUE RECORD 05/02/06 PERMIT SUBMITTAL

09/05/06 PERMIT RE-SUBMITTAL 09/19/06 AMPHITHEATER COORDINATION 10/26/06 CANAL BANK IMPROVEMENTS \$\frac{12}{11}\rightarrow{06} CANAL BANK COORDINATION

1 06/02/06 PH.1/2 OWNER REV.

DESIGN NUMBER A545520 PROJECT NUMBER F&A 04047 10/26/06 PROJECT MANAGER

DRAWN BY CHECKED BY

R. JONES

KEY PLAN


OWR Construction, Inc.

PROJECT SCOTTSDALE WATERFRONT RESIDENCES

SCOTTSDALE, ARIZONA

PARTIAL

H-1.6

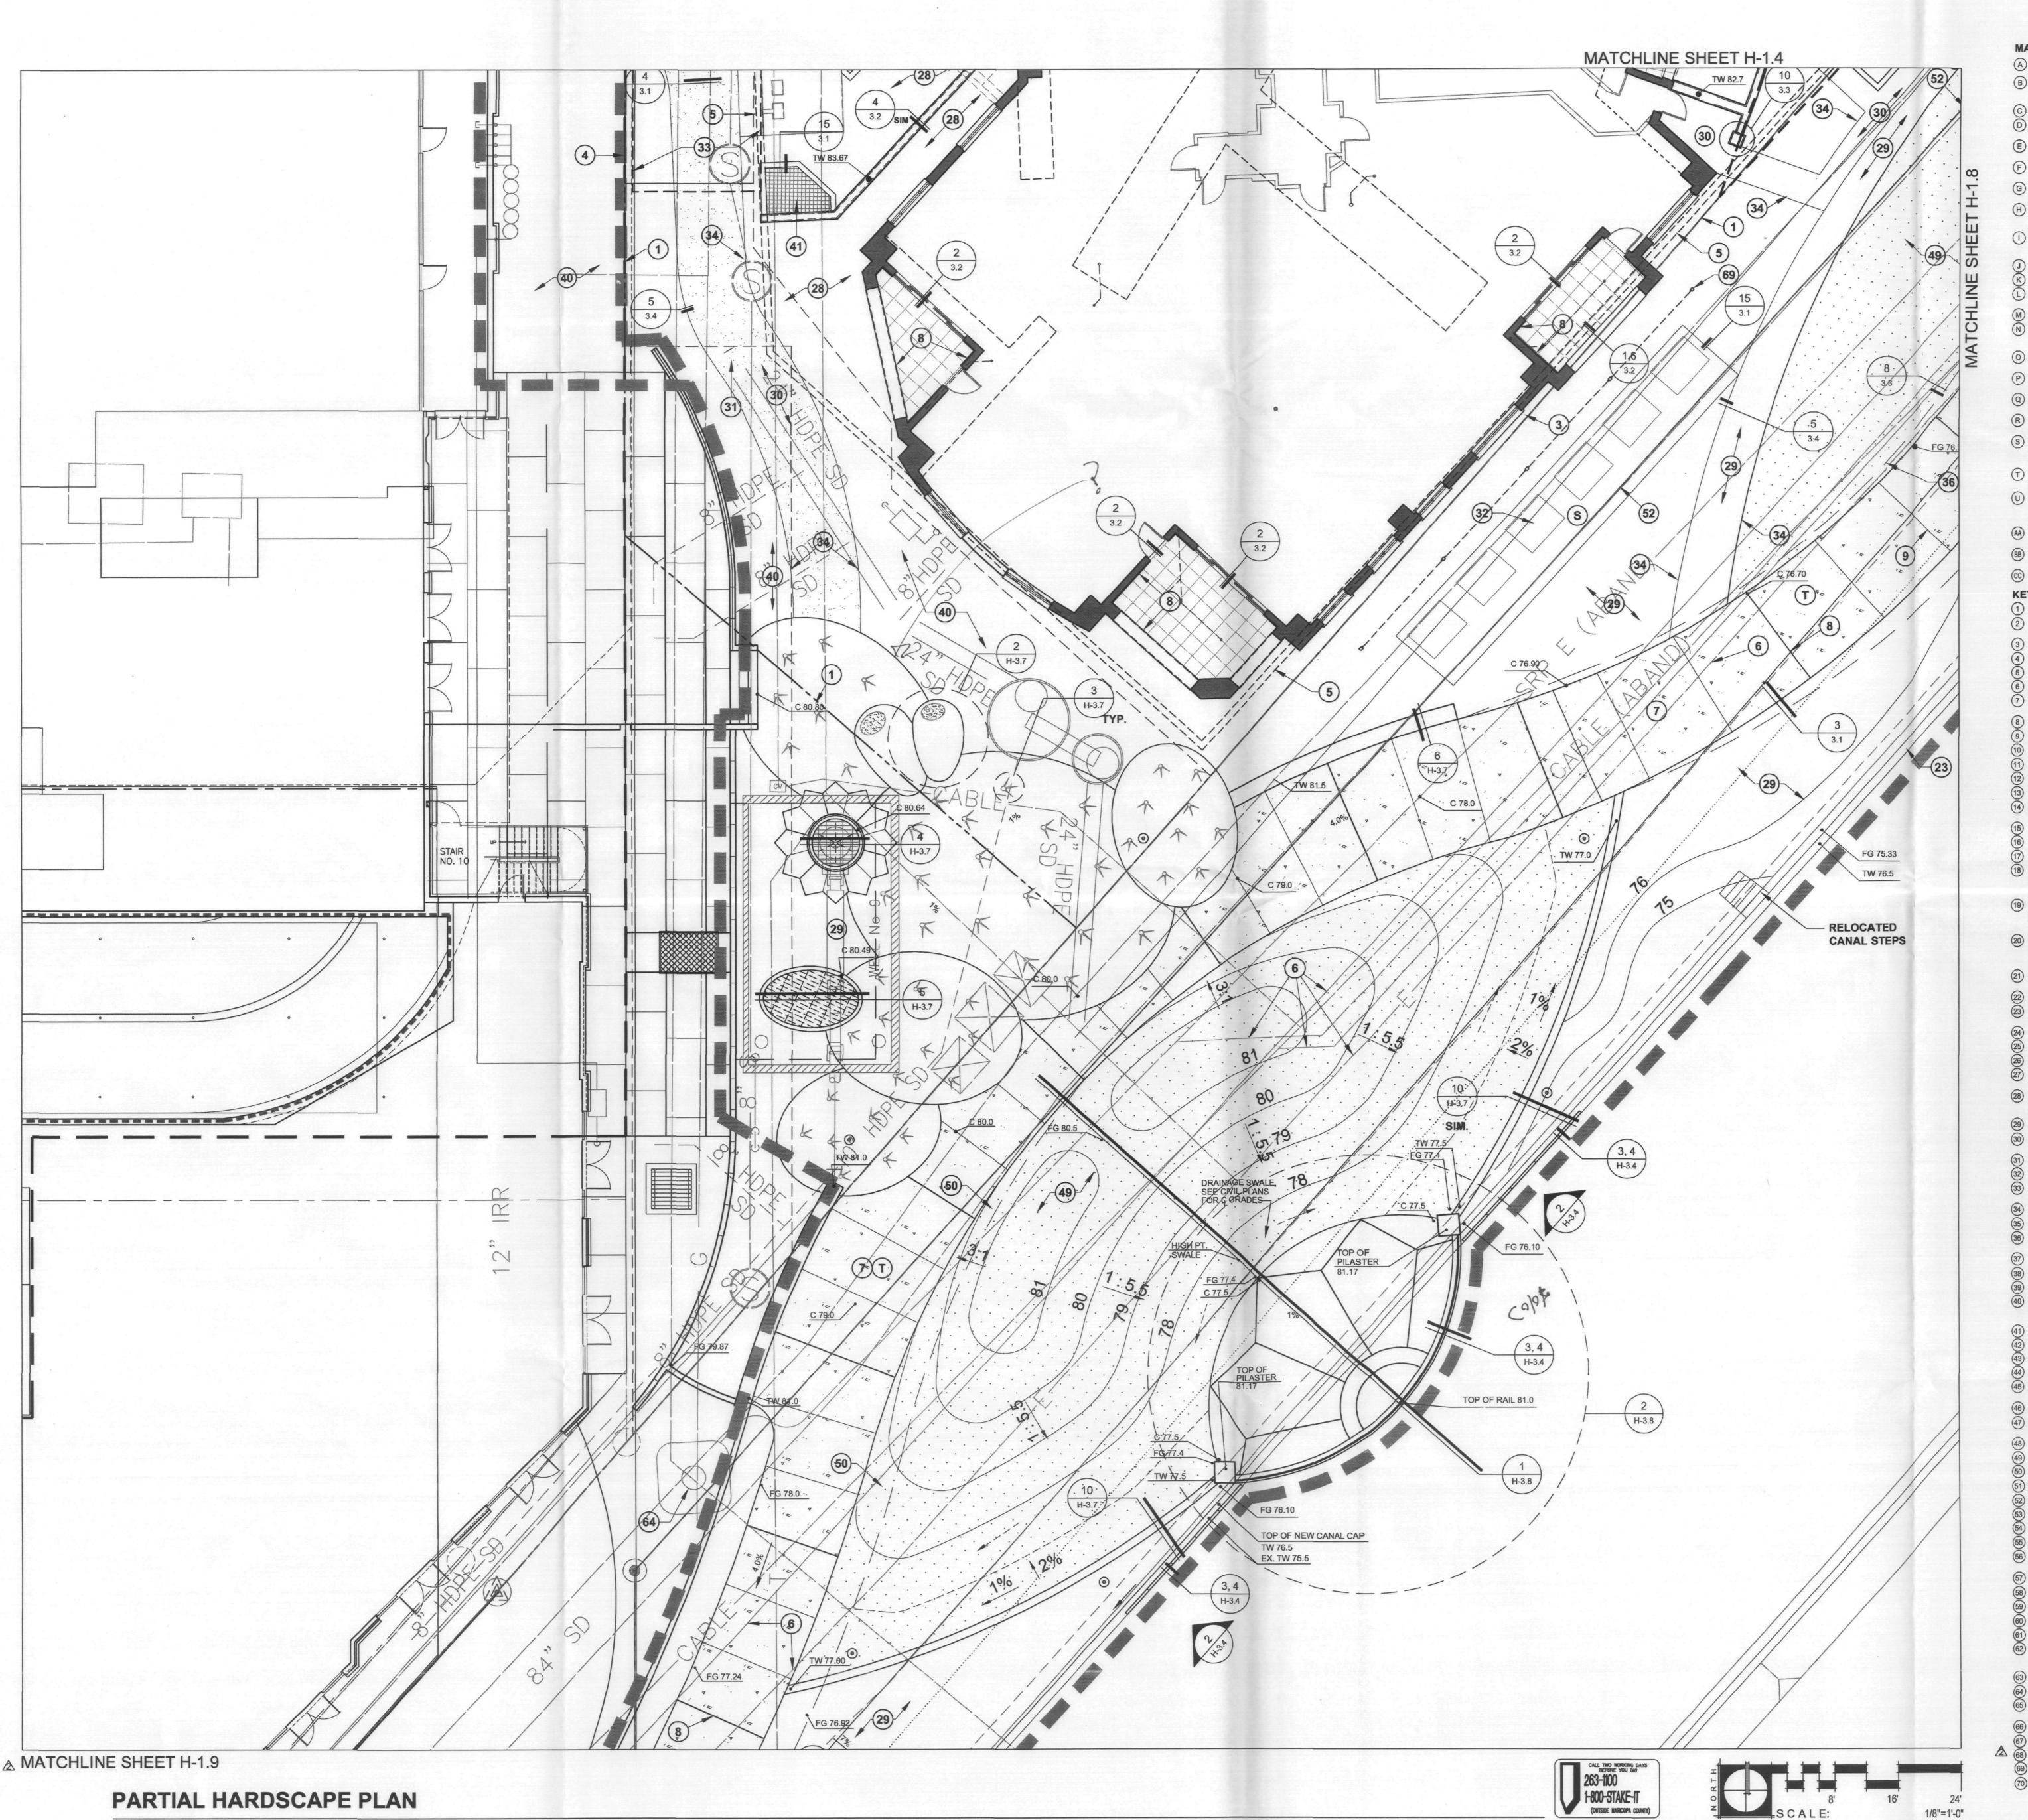

- B CONCRETE SLAB WITH 'AMERICRETE' ACRYLIC STAIN TO MATCH PANTONE 116U, CADMIUM YELLOW. LIGHT BROOM FINISH.
- C CONCRETE BAND, NATURAL GRAY. LIGHT BROOM FINISH. CONCRETE SLAB WITH 'AMERICRETE' ACRYLIC STAIN TO MATCH PANTONE 1635U, SALMON. LIGHT BROOM FINISH.
- E CONCRETE SLAB WITH 'AMERICRETE' ACRYLIC STAIN TO MATCH PANTONE 163U, ORANGE, LIGHT BROOM FINISH.
- F CONCRETE SLAB WITH INTEGRAL COLOR: DAVIS, GRAPHITE. LIGHT BROOM FINISH.
- G CONCRETE SLAB WITH 'AMERICRETE' ACRYLIC STAIN TO MATCH PANTONE 225U, FUSCHIA. LIGHT BROOM FINISH.
- CONCRETE SLAB WITH INTEGRAL COLOR: DAVIS, WILLOW GREEN, LIGHT BROOM FINISH W/ SANDBLAST THORN
- (J) CONCRETE SLAB WITH APPLIED MOSAIC TILE.
- CONCRETE SLAB, NATURAL GRAY. LIGHT BROOM FINISH. CONCRETE SLAB WITH INTEGRAL COLOR: DAVIS, TERRA COTTA. LIGHT BROOM FINISH.
- M) CONCRETE SLAB, NATURAL GRAY. MEDIUM BROOM FINISH.
- CONCRETE SLAB WITH INTEGRAL COLOR: DAVIS, PALOMINO. LIGHT BROOM FINISH.
- P CONCRETE SLAB WITH 'AMERICRETE' ACRYLIC STAIN TO MATCH PANTONE 166U. RED. LIGHT BROOM FINISH.
- Q CONCRETE SLAB, NATURAL GRAY. LIGHT SANDBLAST FINISH.
- R CONCRETE SLAB WITH INTEGRAL COLOR: DAVIS, WILLOW GREEN. LIGHT BROOM FINISH. S CONCRETE SLAB, NATURAL GRAY COLOR WITH LIGHT BROOM FINISH & SEALER.
- CONCRETE SLAB WITH INTEGRAL COLOR: DAVIS, YOSEMITE BROWN. EXPOSED AGGREGATE FINISH AGGREGATE TO BE 3/8" SCREENED APACHE BROWN SCHIST BY GRANITE EXPRESS.

- BB CONCRETE SLAB WITH 'AMERICRETE' ACRYLIC STAIN TO MATCH PANTONE 461U. BEIGE. LIGHT BROOM FINISH.
- © STONE PAVING OVER CONCRETE SLAB.

KEY NOTES

- 1 PROPERTY LINE 2 PRIVATE WITH PUBLIC ACCESS EASEMENT - REFER TO CIVIL DRAWINGS
- (3) PHASE I CANAL BANK LIMIT
- 4) PROJECT PHASE LINE 5) LIMIT OF UNDERGROUND PARKING GARAGE STRUCTURE
- 6) UTILITY LINE KEEP TREES 7' CLEAR REFER TO CIVIL
- 7) CONCRETE PAVING REFER TO MATERIALS LEGEND FOR COLOR AND FINISH
- (8) EXPANSION JOINT TYP.
- CONTROL JOINT TYP.
- 10) STONE PAVING OVER CONCRETE SLAB CMU WALL W/STONE CAP - PAINT AND STUCCO FINISH
- CMU WALL PAINT AND STUCCO FINISH
- 3) CMU WALL W/STONE CAP AND STONE VENEER
- 15) CAST-IN-PLACE CONCRETE STEPS WITH STONE VENEER
- 6) CAST-IN-PLACE CONCRETE SEATWALL W/STONE VENEER CAST-IN-PLACE CONCRETE WALL W/STONE VENEER

- (21) CMU PILASTER W/STONE CAP AND PAINT AND STUCCO FINISH
- 22) CMU CONCRETE PILASTER WITH STONE VENEER.
- 24) WROUGHT IRON GUARD RAIL ATTACHED TO WALL
- WROUGHT IRON FENCE
- 72" ROUND TREE GRATE AND TWO LIGHT WELLS BY 'IRONSMITH' BLACK ENAMEL FINISH
- (29) PLANTING AREA SEE PLANTING DETAILS FOR SOIL DEPTHS 30 1/4" STABILIZED DECOMPOSED GRANITE W/MARLOC' SOIL LOCK STABILIZER- SEE PLANT LEGEND FOR DG COLOR
- 31) CATCH BASIN SEE CIVIL
- 2) SRP SWITCHING CABINETS SEE ELECTRICAL PLANS 33 ARCADIA WATER ACCESS EASEMENT - ALL CONCRETE PAVING TO BE VEHICULAR RATED
- (34) STEEL HEADER
- WATER FEATURE 16' WIDE SRP ACCESS - 12' WIDE PAVED ROAD W/2' CLEAR DECOMPOSED GRANITE AREA ON EITHER SIDE OF ROAD
- 87) BUILDING EXPANSION JOINT SEE ARCHITECTURAL
- TRANSFER BEAM REFER TO STRUCTURAL DRAWING WATER FEATURE EQUIPMENT AND STORAGE AREA
- REPLANT TRANSITION AREA BETWEEN PHASE 2 AND PHASE 1 AS NEEDED TO COVER DAMAGE TO EXISTING LANDSCAPE INSTALLATION FROM PHASE 2 CONSTRUCTION.
- 41) GARAGE VENTILATION SHAFT AREA DRAIN TYP.
- EXTENT OF PHASE 1A TRANSFER SLAB SEE STRUCTURAL 4) EXTENT OF PHASE 2 TRANSFER SLAB - SEE STRUCTURAL
- 46) WOODEN BENCH W/ANTI-THEFT MOUNTING INSTALLATION
- (48) 2" 3" SAN QUITEEN PEBBLES 3" MIN. DEPTH OPEN RECREATIONAL TURF AREA
- 'TURF BLOCK' FOR SRP ACCESS ROUTE THROUGH TURF
- EXTERIOR FIREPLACE SRP R.O.W. LINE
- LIMIT OF CANAL BANK IMPROVEMENT
- WELL ACCESS PANEL WELL GRATE
- UNDERGROUND WELL#9 VAULT REFER TO ARCHITECTURAL
- 57) LIGHT POLE
- AMPHITHEATER TURF AREA


- CANAL GUARD RAIL TO MATCH ADJACENT CANAL PROJECT C.I.P. CONCRETE RETAINING WALL
- EXPOSED CANAL WALL TO RECEIVE LIGHT SANDBLAST FINISH, SEAL W/ ANTI-GRAFFITI SEALANT TO MATCH ADJACENT PROJECT. 63) 4" DIA. SLEEVE PIPE
- MANHOLE
- 65 16' WIDE SRP ACCESS STABILIZED DECOMPOSED GRANITE DRIVE CONDITION SEE 4/H3.1 FOR DETAIL. 66) OUTDOOR BARBECUE CMU PILASTER W/ STONE CAP AND EIFS FINISH
- 68 CMU WALL W/ STONE CAP AND EIFS FINISH 70) PRECAST CONCRETE CANTILEVER CANAL OVERLOOK



Opus Architects & Engineers, Inc.

10350 Bren Road West Minnetonka, MN 55343-0110 952-656-4444 952-656-4529 fax



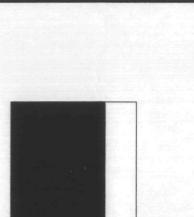

Phone 602.462.1425 Fax 602.462.1427

ISSUE RECORD

↑ 06/02/06 PH.1/2 OWNER REV. 09/05/06 PERMIT RE-SUBMITTAL 09/19/06 AMPHITHEATER COORDINATION 10/26/06 CANAL BANK IMPROVEMENTS


05/02/06 PERMIT SUBMITTAL

2 12/11/06 CANAL BANK COORDINATION

A545520 PROJECT NUMBER F&A 04047

10/26/06 PROJECT MANAGER R. JONES DRAWN BY

CHECKED BY

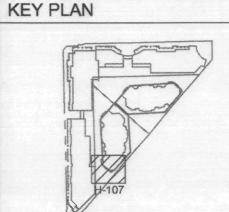


OWR Construction, Inc. 2555 East Camelback Road Phoenix, Arizona 85016 602-468-7000 602-468-7010 fax

SCOTTSDALE WATERFRONT

RESIDENCES SCOTTSDALE, ARIZONA

SHEET TITLE PARTIAL HARDSCAPE

PLAN AFPROVE

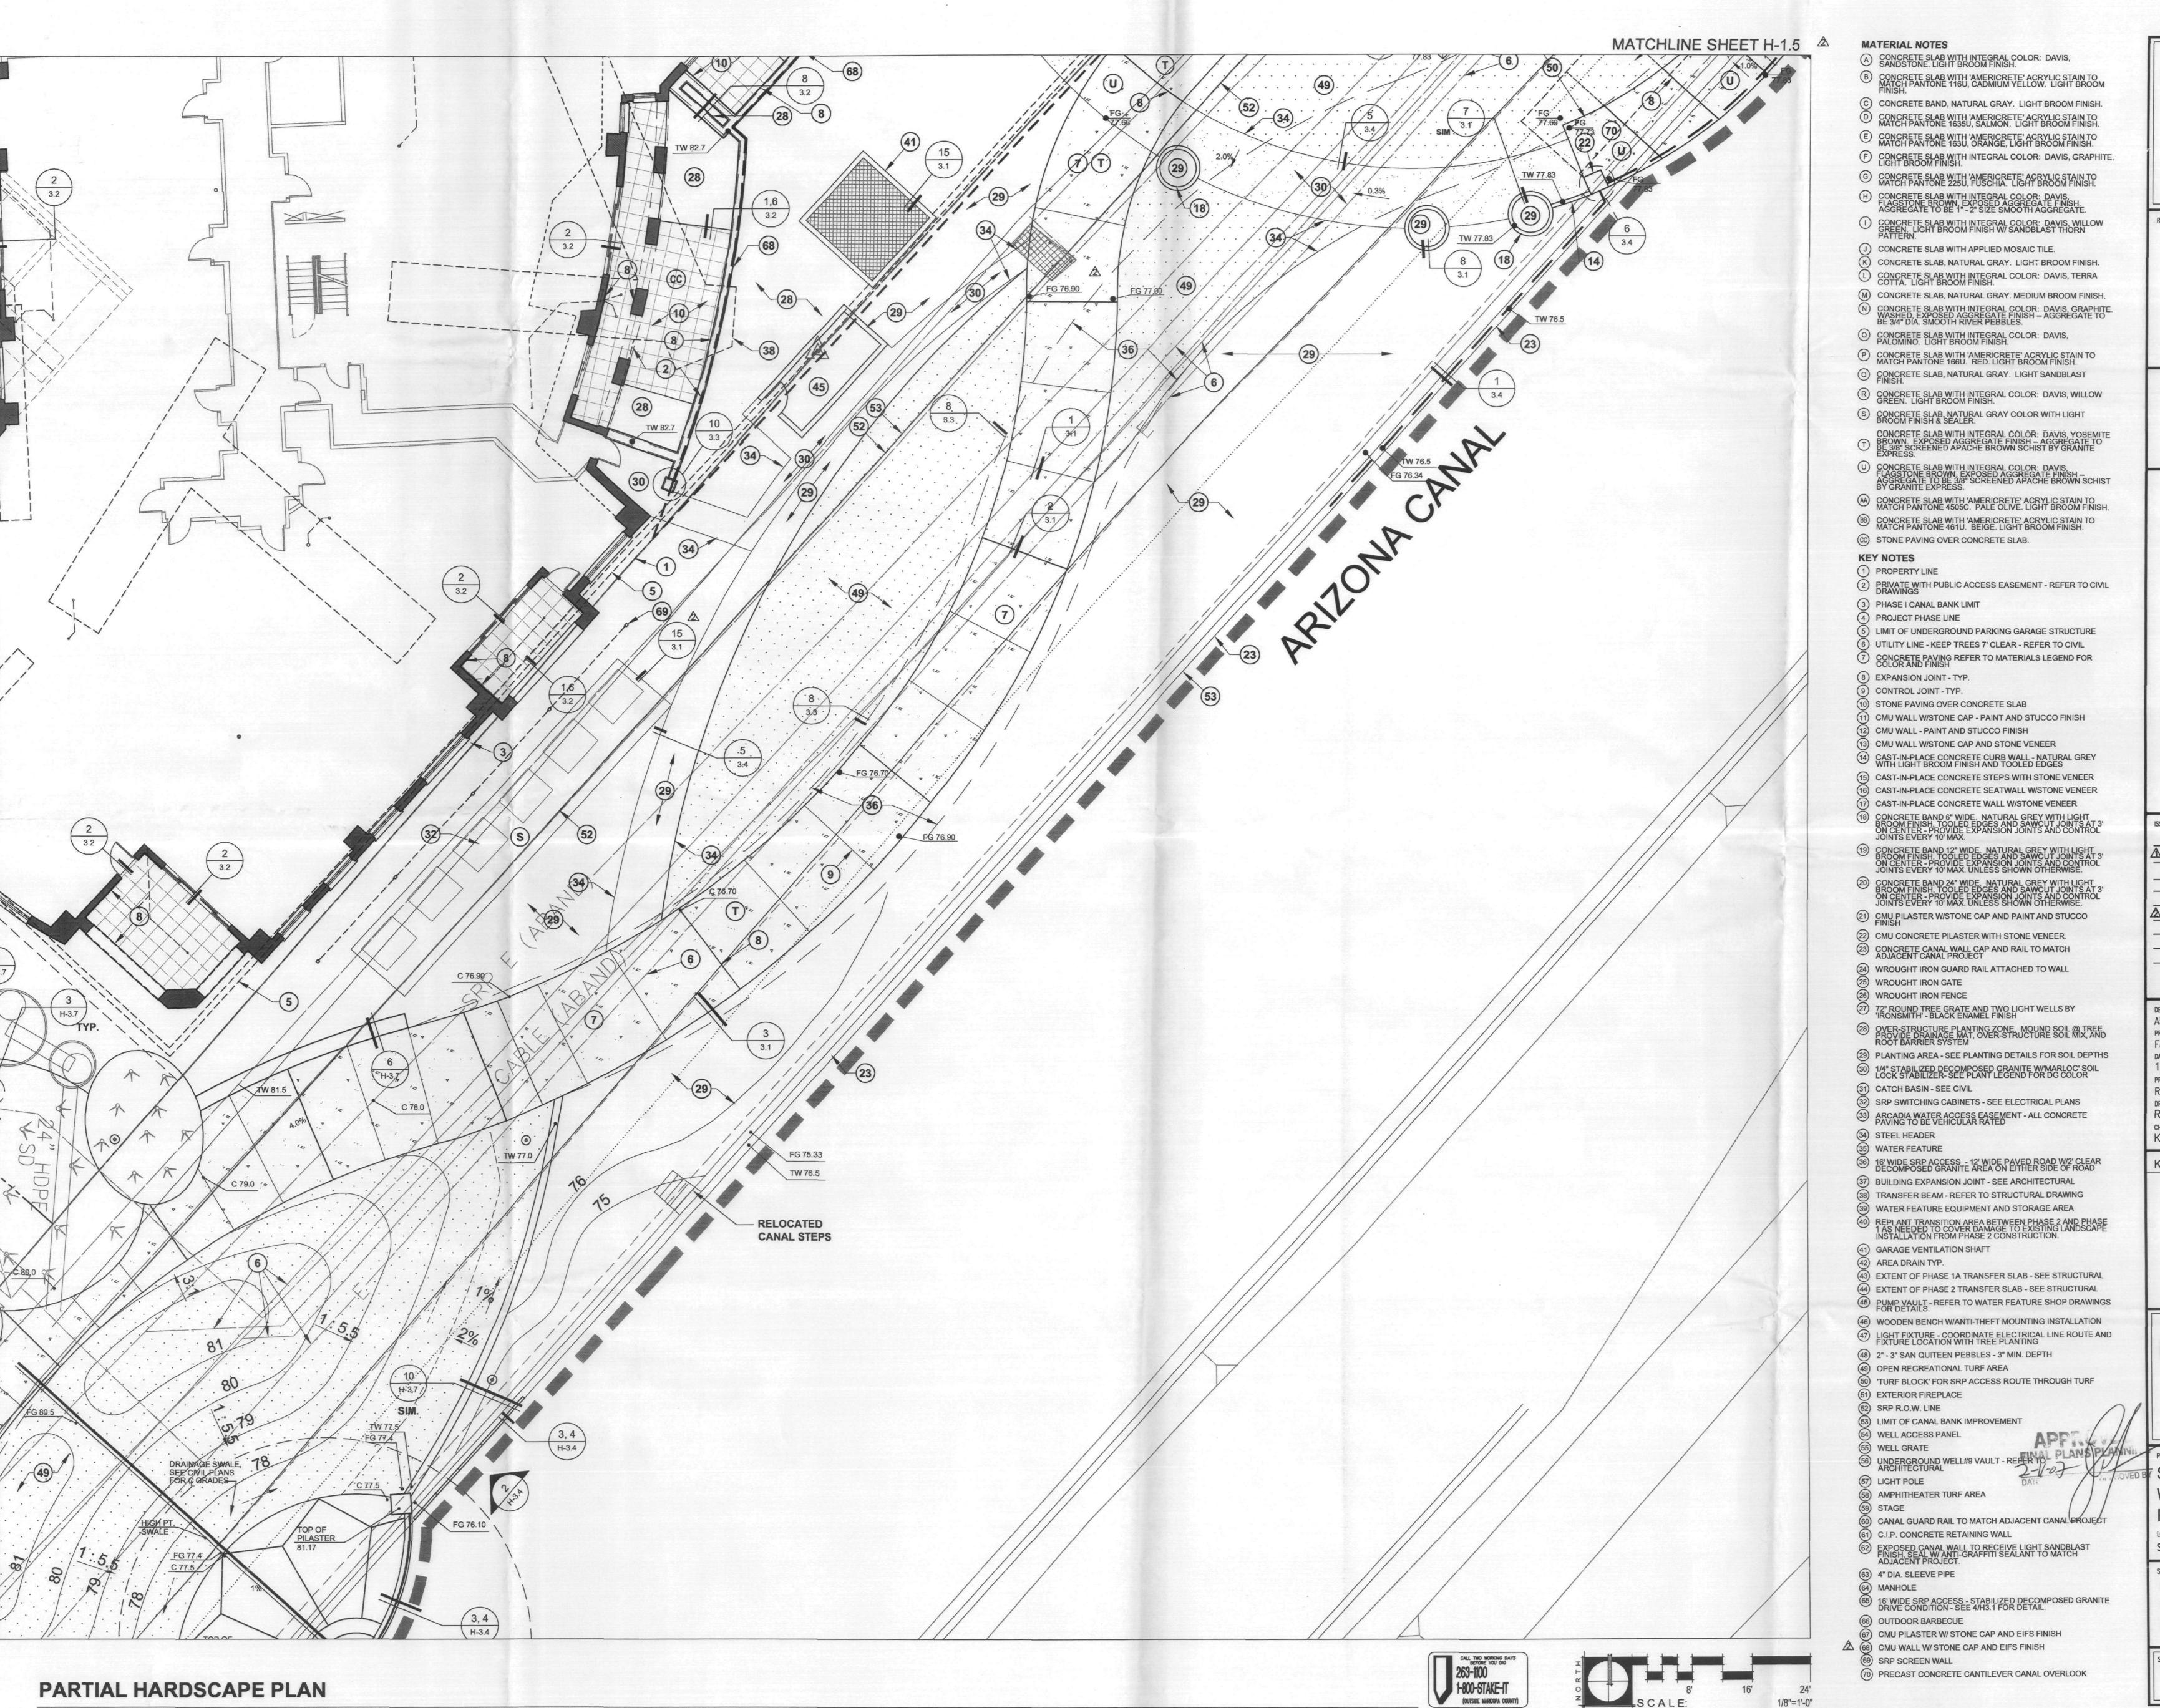

- (A) CONCRETE SLAB WITH INTEGRAL COLOR: DAVIS, SANDSTONE. LIGHT BROOM FINISH.
- B CONCRETE SLAB WITH 'AMERICRETE' ACRYLIC STAIN TO MATCH PANTONE 116U, CADMIUM YELLOW. LIGHT BROOM
- © CONCRETE BAND, NATURAL GRAY. LIGHT BROOM FINISH.
- CONCRETE SLAB WITH 'AMERICRETE' ACRYLIC STAIN TO MATCH PANTONE 1635U, SALMON. LIGHT BROOM FINISH.
- E CONCRETE SLAB WITH 'AMERICRETE' ACRYLIC STAIN TO MATCH PANTONE 163U, ORANGE, LIGHT BROOM FINISH. F CONCRETE SLAB WITH INTEGRAL COLOR: DAVIS, GRAPHITE. LIGHT BROOM FINISH.
- G CONCRETE SLAB WITH 'AMERICRETE' ACRYLIC STAIN TO MATCH PANTONE 225U, FUSCHIA. LIGHT BROOM FINISH.
- H CONCRETE SLAB WITH INTEGRAL COLOR: DAVIS, FLAGSTONE BROWN, EXPOSED AGGREGATE FINISH. AGGREGATE TO BE 1" 2" SIZE SMOOTH AGGREGATE.
- CONCRETE SLAB WITH INTEGRAL COLOR: DAVIS, WILLOW GREEN. LIGHT BROOM FINISH W/ SANDBLAST THORN PATTERN.
- (J) CONCRETE SLAB WITH APPLIED MOSAIC TILE. (K) CONCRETE SLAB, NATURAL GRAY. LIGHT BROOM FINISH.
- CONCRETE SLAB WITH INTEGRAL COLOR: DAVIS, TERRA COTTA. LIGHT BROOM FINISH.
- O CONCRETE SLAB WITH INTEGRAL COLOR: DAVIS, PALOMINO. LIGHT BROOM FINISH.
- P CONCRETE SLAB WITH 'AMERICRETE' ACRYLIC STAIN TO MATCH PANTONE 166U. RED. LIGHT BROOM FINISH.
- Q CONCRETE SLAB, NATURAL GRAY. LIGHT SANDBLAST FINISH.
- CONCRETE SLAB WITH INTEGRAL COLOR: DAVIS, WILLOW GREEN. LIGHT BROOM FINISH.
- S CONCRETE SLAB, NATURAL GRAY COLOR WITH LIGHT BROOM FINISH & SEALER. CONCRETE SLAB WITH INTEGRAL COLOR: DAVIS, YOSEMITE BROWN. EXPOSED AGGREGATE FINISH – AGGREGATE TO BE 3/8" SCREENED APACHE BROWN SCHIST BY GRANITE EXPRESS

- CONCRETE SLAB WITH 'AMERICRETE' ACRYLIC STAIN TO MATCH PANTONE 4505C. PALE OLIVE, LIGHT BROOM FINISH
- (CC) STONE PAVING OVER CONCRETE SLAB.
- **KEY NOTES** 1) PROPERTY LINE
- 2 PRIVATE WITH PUBLIC ACCESS EASEMENT REFER TO CIVIL DRAWINGS
- (3) PHASE I CANAL BANK LIMIT
- 4) PROJECT PHASE LINE 5) LIMIT OF UNDERGROUND PARKING GARAGE STRUCTURE
- (6) UTILITY LINE KEEP TREES 7' CLEAR REFER TO CIVIL 7 CONCRETE PAVING REFER TO MATERIALS LEGEND FOR COLOR AND FINISH
- (8) EXPANSION JOINT TYP.
- CONTROL JOINT TYP.
- 0) STONE PAVING OVER CONCRETE SLAB
- 1) CMU WALL W/STONE CAP PAINT AND STUCCO FINISH
- CMU WALL PAINT AND STUCCO FINISH 13) CMU WALL W/STONE CAP AND STONE VENEER
- (4) CAST-IN-PLACE CONCRETE CURB WALL NATURAL GREY WITH LIGHT BROOM FINISH AND TOOLED EDGES
- (15) CAST-IN-PLACE CONCRETE STEPS WITH STONE VENEER 16) CAST-IN-PLACE CONCRETE SEATWALL W/STONE VENEER 17) CAST-IN-PLACE CONCRETE WALL W/STONE VENEER

- (21) CMU PILASTER W/STONE CAP AND PAINT AND STUCCO (22) CMU CONCRETE PILASTER WITH STONE VENEER.
- (23) CONCRETE CANAL WALL CAP AND RAIL TO MATCH ADJACENT CANAL PROJECT
- (24) WROUGHT IRON GUARD RAIL ATTACHED TO WALL (25) WROUGHT IRON GATE
- (26) WROUGHT IRON FENCE
- 72" ROUND TREE GRATE AND TWO LIGHT WELLS BY 'IRONSMITH' BLACK ENAMEL FINISH
- (28) OVER-STRUCTURE PLANTING ZONE. MOUND SOIL @ TREE. PROVIDE DRAINAGE MAT, OVER-STRUCTURE SOIL MIX, AND ROOT BARRIER SYSTEM
- (29) PLANTING AREA SEE PLANTING DETAILS FOR SOIL DEPTHS (30) 1/4" STABILIZED DECOMPOSED GRANITE W/'MARLOC' SOIL LOCK STABILIZER- SEE PLANT LEGEND FOR DG COLOR
- 31) CATCH BASIN SEE CIVIL
- (32) SRP SWITCHING CABINETS SEE ELECTRICAL PLANS
- (34) STEEL HEADER
- 35) WATER FEATURE
- 38) TRANSFER BEAM REFER TO STRUCTURAL DRAWING
- REPLANT TRANSITION AREA BETWEEN PHASE 2 AND PHASE 1 AS NEEDED TO COVER DAMAGE TO EXISTING LANDSCAPE INSTALLATION FROM PHASE 2 CONSTRUCTION.
- (41) GARAGE VENTILATION SHAFT 42) AREA DRAIN TYP.
- 43) EXTENT OF PHASE 1A TRANSFER SLAB SEE STRUCTURAL (44) EXTENT OF PHASE 2 TRANSFER SLAB - SEE STRUCTURAL
- (46) WOODEN BENCH W/ANTI-THEFT MOUNTING INSTALLATION 47 LIGHT FIXTURE - COORDINATE ELECTRICAL LINE ROUTE AND FIXTURE LOCATION WITH TREE PLANTING
- (48) 2" 3" SAN QUITEEN PEBBLES 3" MIN. DEPTH (49) OPEN RECREATIONAL TURF AREA
- TURF BLOCK' FOR SRP ACCESS ROUTE THROUGH TURF
- EXTERIOR FIREPLACE SRP R.O.W. LINE
- LIMIT OF CANAL BANK IMPROVEMENT

- STAGE CANAL GUARD RAIL TO MATCH ADJACENT CANAL PROJECT
- C.I.P. CONCRETE RETAINING WALL
- EXPOSED CANAL WALL TO RECEIVE LIGHT SANDBLAST FINISH, SEAL W/ ANTI-GRAFFITI SEALANT TO MATCH ADJACENT PROJECT.
- 63) 4" DIA. SLEEVE PIPE
- MANHOLE

1/8"=1'-0"

- 65) 16' WIDE SRP ACCESS STABILIZED DECOMPOSED GRANITE DRIVE CONDITION SEE 4/H3.1 FOR DETAIL. (66) OUTDOOR BARBECUE
- CMU PILASTER W/ STONE CAP AND EIFS FINISH
- 70 PRECAST CONCRETE CANTILEVER CANAL OVERLOOK



10350 Bren Road West Minnetonka, MN 55343-0110 952-656-4444 952-656-4529 fax






05/02/06 PERMIT SUBMITTAL ⚠ 06/02/06 PH.1/2 OWNER REV. 09/05/06 PERMIT RE-SUBMITTAL 09/19/06 AMPHITHEATER COORDINATION

10/26/06 CANAL BANK IMPROVEMENTS \$\frac{12}{11}\rightarrow{16} CANAL BANK COORDINATION

A545520 PROJECT NUMBER F&A 04047 10/26/06 PROJECT MANAGER R. JONES

CHECKED BY

DRAWN BY RJ

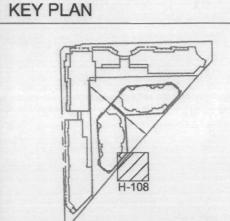

NUMBER:

Prepared For

OWR Construction, Inc. 2555 East Camelback Road Suite 800 Phoenix, Arizona 85016 602-468-7000 602-468-7010 fax


SCOTTSDALE WATERFRONT RESIDENCES

SCOTTSDALE, ARIZONA SHEET TITLE PARTIAL

HARDSCAPE

PLAN SHEET NUMBER

H-1.8

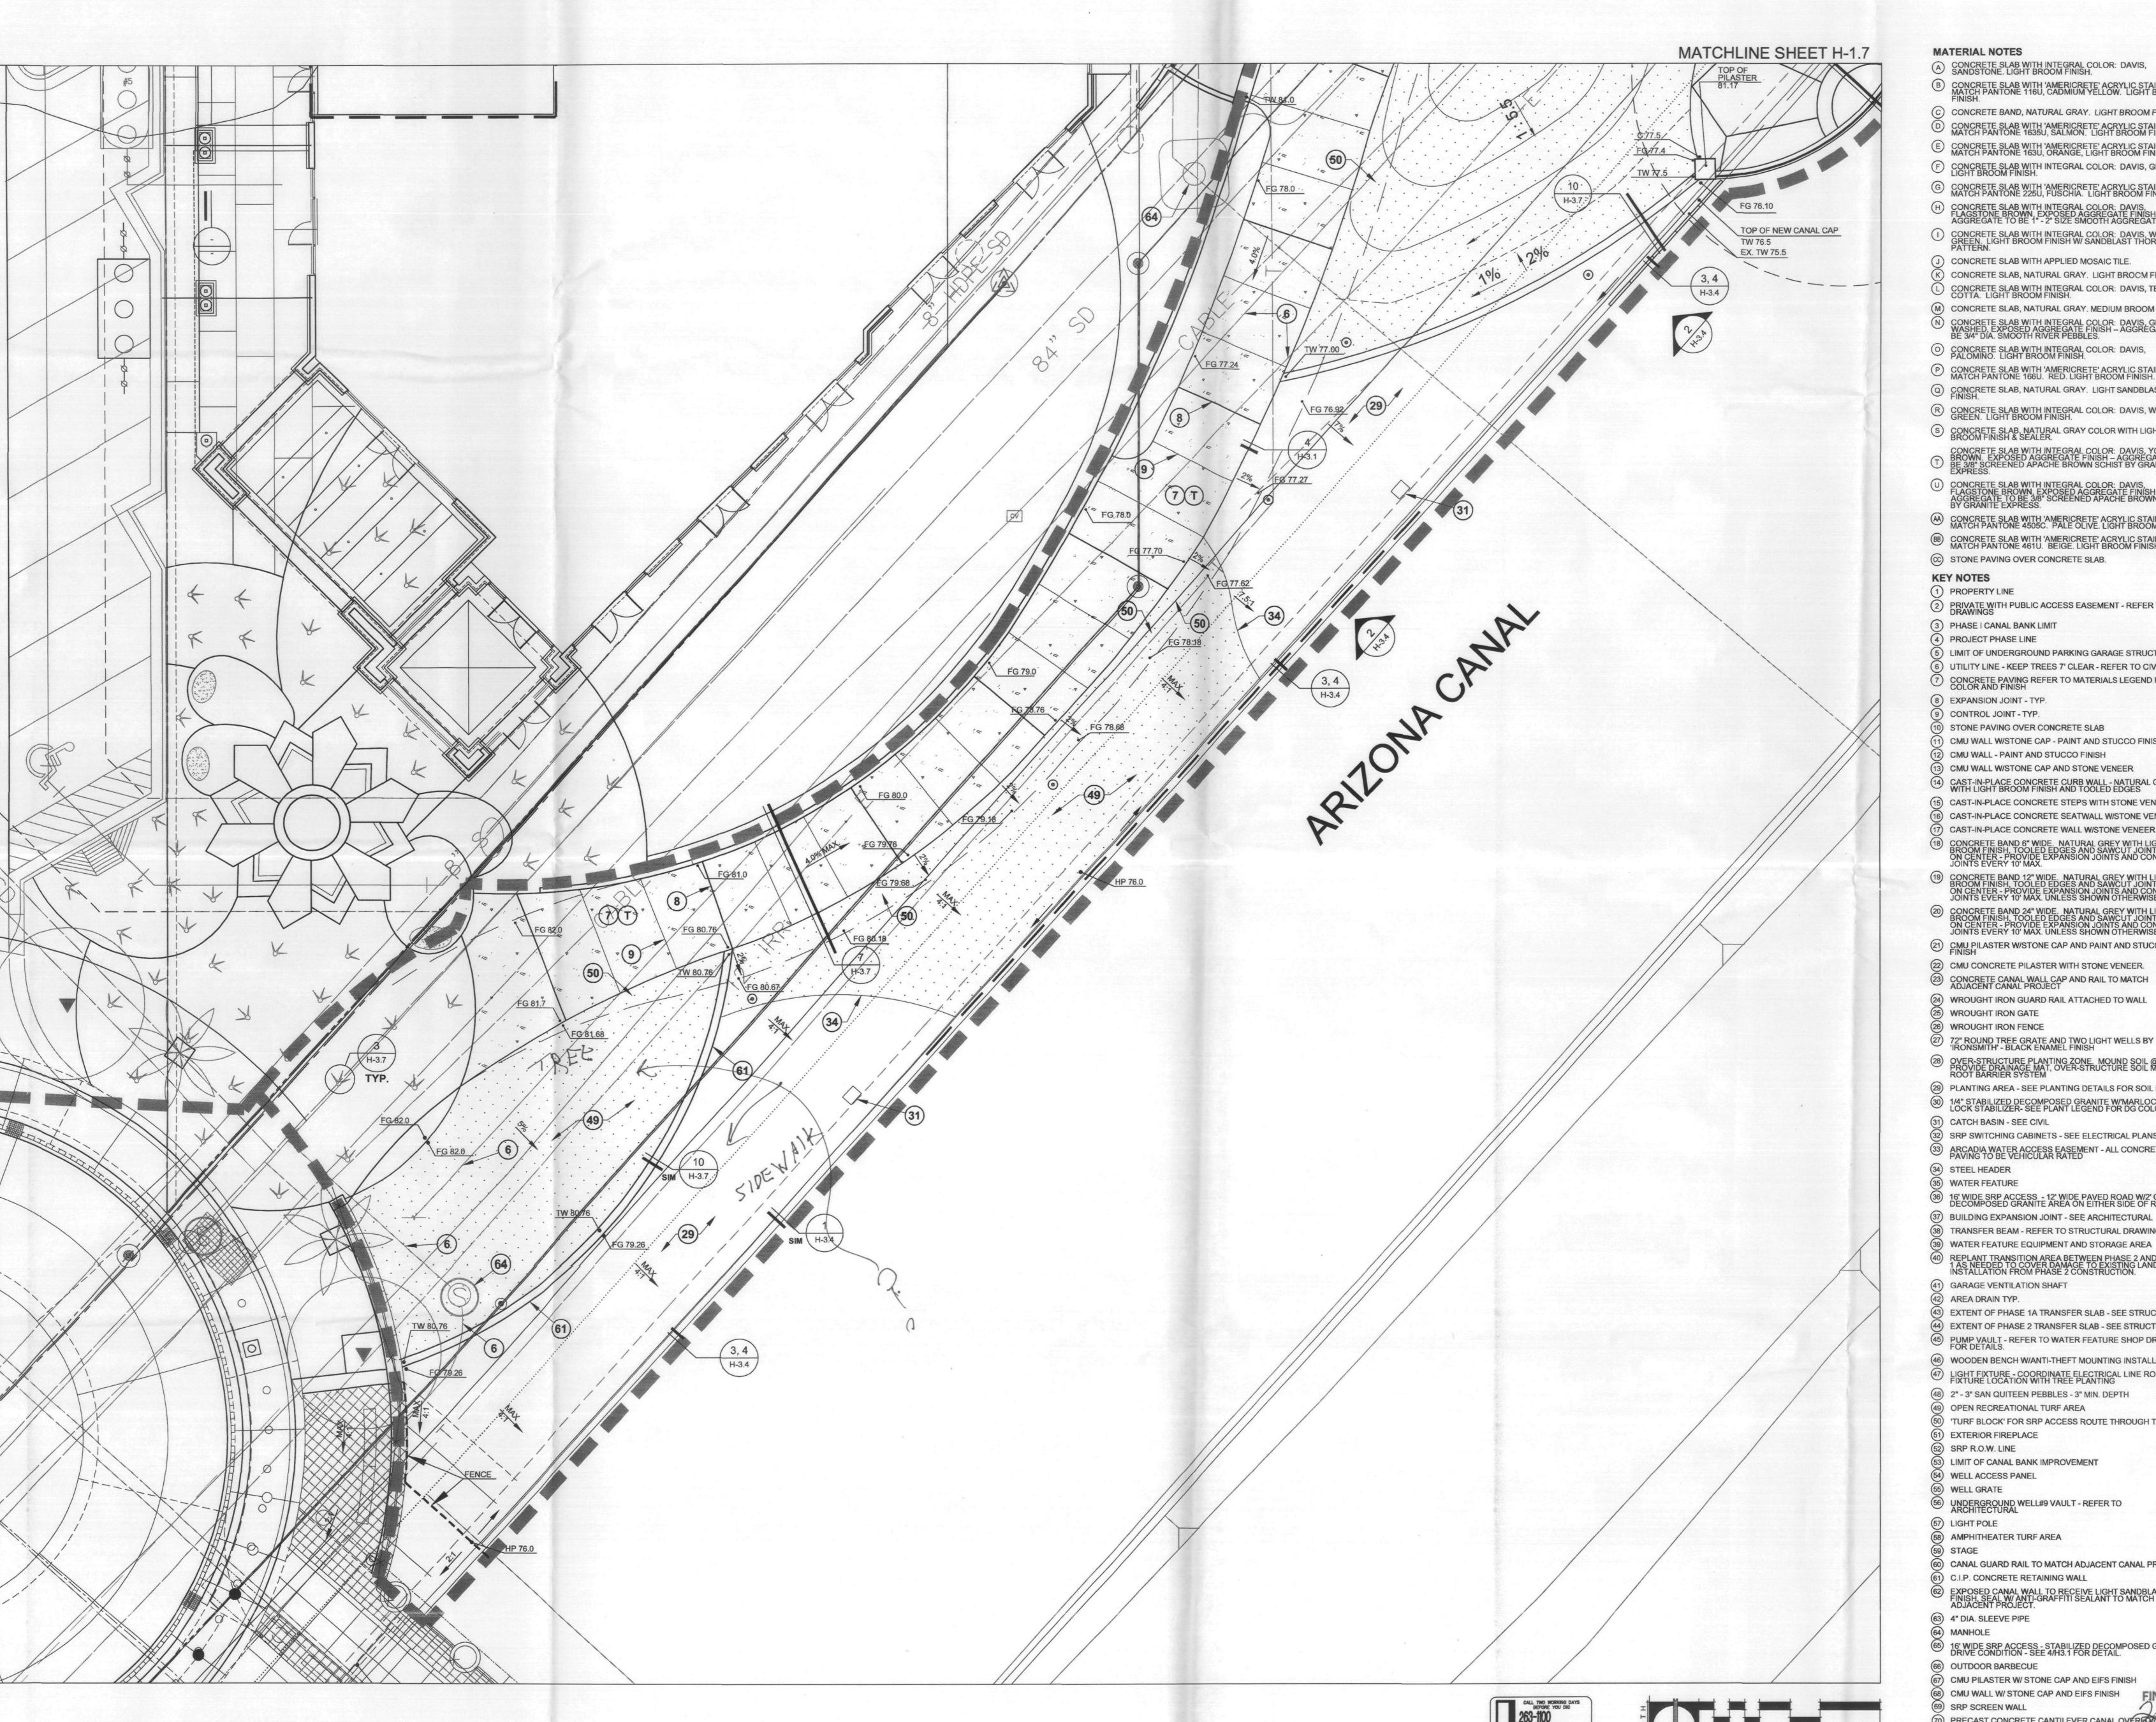



- A CONCRETE SLAB WITH INTEGRAL COLOR: DAVIS, SANDSTONE. LIGHT BROOM FINISH.
- B CONCRETE SLAB WITH 'AMERICRETE' ACRYLIC STAIN TO MATCH PANTONE 116U, CADMIUM YELLOW. LIGHT BROOM FINISH.
- C CONCRETE BAND, NATURAL GRAY. LIGHT BROOM FINISH.
- D CONCRETE SLAB WITH 'AMERICRETE' ACRYLIC STAIN TO MATCH PANTONE 1635U, SALMON. LIGHT BROOM FINISH.
- © CONCRETE SLAB WITH 'AMERICRETE' ACRYLIC STAIN TO MATCH PANTONE 163U, ORANGE, LIGHT BROOM FINISH.
- F CONCRETE SLAB WITH INTEGRAL COLOR: DAVIS, GRAPHITE. LIGHT BROOM FINISH.
- © CONCRETE SLAB WITH 'AMERICRETE' ACRYLIC STAIN TO MATCH PANTONE 225U, FUSCHIA. LIGHT BROOM FINISH.
- (H) CONCRETE SLAB WITH INTEGRAL COLOR: DAVIS, FLAGSTONE BROWN, EXPOSED AGGREGATE FINISH. AGGREGATE TO BE 1" 2" SIZE SMOOTH AGGREGATE.
- CONCRETE SLAB WITH INTEGRAL COLOR: DAVIS, WILLOW GREEN. LIGHT BROOM FINISH W/ SANDBLAST THORN PATTERN.
- CONCRETE SLAB WITH APPLIED MOSAIC TILE.
- K) CONCRETE SLAB, NATURAL GRAY. LIGHT BROCM FINISH. CONCRETE SLAB WITH INTEGRAL COLOR: DAVIS, TERRA COTTA. LIGHT BROOM FINISH.
- M CONCRETE SLAB, NATURAL GRAY. MEDIUM BROOM FINISH.
- O CONCRETE SLAB WITH INTEGRAL COLOR: DAVIS, PALOMINO. LIGHT BROOM FINISH. P CONCRETE SLAB WITH 'AMERICRETE' ACRYLIC STAIN TO MATCH PANTONE 166U. RED. LIGHT BROOM FINISH.
- © CONCRETE SLAB, NATURAL GRAY. LIGHT SANDBLAST FINISH.
- R CONCRETE SLAB WITH INTEGRAL COLOR: DAVIS, WILLOW GREEN. LIGHT BROOM FINISH.
- S CONCRETE SLAB, NATURAL GRAY COLOR WITH LIGHT BROOM FINISH & SEALER.
- CONCRETE SLAB WITH INTEGRAL COLOR: DAVIS, YOSEMITE BROWN. EXPOSED AGGREGATE FINISH AGGREGATE TO BE 3/8" SCREENED APACHE BROWN SCHIST BY GRANITE EXPRESS.
- CONCRETE SLAB WITH INTEGRAL COLOR: DAVIS, FLAGSTONE BROWN, EXPOSED AGGREGATE FINISH AGGREGATE TO BE 3/8" SCREENED APACHE BROWN SCHIST BY GRANITE EXPRESS.
- (A) CONCRETE SLAB WITH 'AMERICRETE' ACRYLIC STAIN TO MATCH PANTONE 4505C. PALE OLIVE, LIGHT BROOM FINISH.
- BB CONCRETE SLAB WITH 'AMERICRETE' ACRYLIC STAIN TO MATCH PANTONE 461U. BEIGE. LIGHT BROOM FINISH.
- © STONE PAVING OVER CONCRETE SLAB.

KEY NOTES

- 1 PROPERTY LINE 2 PRIVATE WITH PUBLIC ACCESS EASEMENT - REFER TO CIVIL DRAWINGS
- 3) PHASE I CANAL BANK LIMIT
- PROJECT PHASE LINE
- LIMIT OF UNDERGROUND PARKING GARAGE STRUCTURE 6 UTILITY LINE - KEEP TREES 7' CLEAR - REFER TO CIVIL
- (8) EXPANSION JOINT TYP.
- CONTROL JOINT TYP. STONE PAVING OVER CONCRETE SLAB
-) CMU WALL W/STONE CAP PAINT AND STUCCO FINISH
- CMU WALL PAINT AND STUCCO FINISH) CMU WALL W/STONE CAP AND STONE VENEER
- 5) CAST-IN-PLACE CONCRETE STEPS WITH STONE VENEER 6) CAST-IN-PLACE CONCRETE SEATWALL W/STONE VENEER
- CAST-IN-PLACE CONCRETE WALL W/STONE VENEER

- (21) CMU PILASTER W/STONE CAP AND PAINT AND STUCCO 22) CMU CONCRETE PILASTER WITH STONE VENEER.
- (24) WROUGHT IRON GUARD RAIL ATTACHED TO WALL
- 5) WROUGHT IRON GATE WROUGHT IRON FENCE

- (29) PLANTING AREA SEE PLANTING DETAILS FOR SOIL DEPTHS
- (30) 1/4" STABILIZED DECOMPOSED GRANITE W/'MARLOC' SOIL LOCK STABILIZER- SEE PLANT LEGEND FOR DG COLOR 31) CATCH BASIN - SEE CIVIL
- 2) SRP SWITCHING CABINETS SEE ELECTRICAL PLANS
- 33) ARCADIA WATER ACCESS EASEMENT ALL CONCRETE PAVING TO BE VEHICULAR RATED
- 34) STEEL HEADER
- WATER FEATURE
- 36) 16' WIDE SRP ACCESS 12' WIDE PAVED ROAD W/2' CLEAR DECOMPOSED GRANITE AREA ON EITHER SIDE OF ROAD
- 37) BUILDING EXPANSION JOINT SEE ARCHITECTURAL TRANSFER BEAM - REFER TO STRUCTURAL DRAWING

- 41) GARAGE VENTILATION SHAFT
- AREA DRAIN TYP.
- 3) EXTENT OF PHASE 1A TRANSFER SLAB SEE STRUCTURAL 44) EXTENT OF PHASE 2 TRANSFER SLAB - SEE STRUCTURAL PUMP VAULT - REFER TO WATER FEATURE SHOP DRAWINGS FOR DETAILS.
- 46) WOODEN BENCH W/ANTI-THEFT MOUNTING INSTALLATION 47 LIGHT FIXTURE - COORDINATE ELECTRICAL LINE ROUTE AND FIXTURE LOCATION WITH TREE PLANTING
- (48) 2" 3" SAN QUITEEN PEBBLES 3" MIN. DEPTH
- 49) OPEN RECREATIONAL TURF AREA
- TURF BLOCK' FOR SRP ACCESS ROUTE THROUGH TURF EXTERIOR FIREPLACE
- SRP R.O.W. LINE
- 53) LIMIT OF CANAL BANK IMPROVEMENT
- 54) WELL ACCESS PANEL
- WELL GRATE 66 UNDERGROUND WELL#9 VAULT - REFER TO ARCHITECTURAL
- (57) LIGHT POLE
- 58) AMPHITHEATER TURF AREA
- 59) STAGE
- 60) CANAL GUARD RAIL TO MATCH ADJACENT CANAL PROJECT 61) C.I.P. CONCRETE RETAINING WALL
- (63) 4" DIA. SLEEVE PIPE
- (64) MANHOLE
- 65 16' WIDE SRP ACCESS STABILIZED DECOMPOSED GRANITE DRIVE CONDITION SEE 4/H3.1 FOR DETAIL.
- 66 OUTDOOR BARBECUE
- 67) CMU PILASTER W/ STONE CAP AND EIFS FINISH 68) CMU WALL W/ STONE CAP AND EIFS FINISH

70 PRECAST CONCRETE CANTILEVER CANAL OVER 100 PROCESS OF THE PROCE



Opus Architects & Engineers, Inc.

10350 Bren Road West Minnetonka, MN 55343-0110 952-656-4444 952-656-4529 fax





ISSUE RECORD

05/02/06 PERMIT SUBMITTAL 1 06/02/06 PH.1/2 OWNER REV. 09/05/06 PERMIT RE-SUBMITTAL


09/19/06 AMPHITHEATER COORDINATION 10/26/06 CANAL BANK IMPROVEMENTS △ 12/11/06 CANAL BANK COORDINATION

DESIGN NUMBER A545520 PROJECT NUMBER F&A 04047 10/26/06 PROJECT MANAGER

CHECKED BY

R. JONES

DRAWN BY

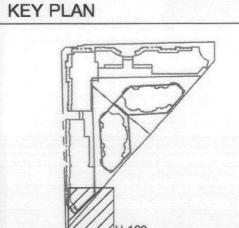

OWR Construction, Inc.

PROJECT SCOTTSDALE WATERFRONT **RESIDENCES**

SCOTTSDALE, ARIZONA

PARTIAL HARDSCAPE

SHEET TITLE

APPROVED

INAL PLANS PARTET WOMBER

OOK

APPROVED

APPRO

PARTIAL HARDSCAPE PLAN