



Development Review (Minor) Staff Approval

Notre Dame Prep Bleachers & Scoreboard

APPLICATION INFORMATION

LOCATION: 9701 E Bell Rd

APPLICANT: Dustin Simmons

PARCEL: 217-14-989

COMPANY: Todd & Associates

Q.S.: 36-51

ADDRESS: 4019 N 44Th St Phoenix, AZ 85018

CODE VIOLATION #: PHONE:

602-952-8280

Request: Request for approval of bleachers & scoreboard

STIPULATIONS

- Staff approval for the addition of "home" and "away" bleacher seats and electronic scoreboard. Bleacher seats
 and scoreboard limited to those locations and elevations as shown on sheet A1.1.2, prided by Todd & Associates,
 Inc., and stamped approved with Staff stamped date of April 10, 2015.
- Staff approval also includes the addition of four (4) new parking lot lights along the fire lane, and 4 lights located n
 the proposed bleacher columns. Lights limited to those locations and elevations as shown on sheet L4.2, prided
 by Todd & Associates, Inc., and stamped approved with Staff stamped date of April 10, 2015. All lights to be full
 cut-off, directed downwards, and not seen form off the property.
- 3. Bleacher seat colors limited to Hussey "hussy seating" color no. 268 "purple" and color no. 156 "tan." The bleacher seat stanchion shall be "hussy seating" color "platinum," and meet the ESL LRV factor of 30. See Todd & Associate memorandum stamped approved with Staff stamped date of April 10, 2015, for approved color scheme. Proposed track storage, located underneath proposed bleachers, shall be modified to meet all fire code and building ordinances.
- 4. Press box limited to the location, elevations, and height as shown on sheet A1.1.2, provided by Todd & Associates, Inc., and stamped approved with Staff stamped date of April 10, 2015. Press box limited to the Mueller Inc. "Panel Color Chart" color shown as "CF Panel" and Mueller color "Saddle Leather Brown."
- 5. Electronic scoreboard is limited to location and direction as shown on sheet A1.1.2, provided by Todd & Associates, Inc., and stamped approved with Staff stamped date of April 10, 2015. Scoreboard color shall be painted "matted black." Scoreboard height limited to 24 feet and 6 inches above natural grade.
- 6. Signage on scoreboard "street -facing" side shall require a separate review and permit.
- 7. All previous case and staff approval stipulation still apply.

CONSTRUCTION DOCUMENT PLAN REVIEW SUBMITTAL REQUIREMENTS

Submit one copy of this approval letter, and a completed permit application along with the following plan set(s) to the One-Stop-Shop for plan review:

ARCHITECTURAL:

4 sets of architectural plans and elevations.

IMPROVEMENTS:

4 sets of civil improvement plans

OTHER:

Insert other requirements as necessary

Please review submittal requirements of attached Construction Document

Application Requirements

Planning and Development Services

7447 East Indian School Road; Suite 105, Scottsdale, Arizona 85251 Phone: 480-312-7000 Fax: 480-312-7088 City of Scottsdale's Website: www.scottsdaleaz.gov

Page 1 of 2

Form Revision Date: 12/11/2014

Expiration of Development Review (Minor) Approval

This approval expires two (2) years from date of approval if a permit has not been issued, or if no permit is required, work for which approval has been granted has not been completed.

Staff Signature:

DATE:

April 10, 2015

Jesus Murillo, Senior Planner



TRACK

	TER RUN MEN 8 HEAT: 1	ING TIME 10.74
		TIME
	B. ANDERSON	
700	K. JACOBS	2:00.37
		2:01.08
		2:03.71
7		2:05.69
		2:06.10
	C. DARNEL	2:08.43
	T. PETERSON	2:10.74

SAINTS

SAINTS

2 TOL 1

ARCADIA

DOWN BALL ON TO GO

- Overall Dimensions 17'8" high x 25'6" wide
- Daktronics Sound System w/ Logo 3'0" high x 8'0" wide (above Video Display)
- Daktronics Game Clock/ Time of Day Clock 2'7" high x 7'0" wide w/ a 5" Filler Panel above TI-2032-A-PV (beside Sound System)
- Daktronics Delay of Game Clock 3'0" high x 4'0" wide w/ an 18" Filler Panel on each end TI-2003-A-PV (beside Sound System)
- Daktronics Video Display DVX-103-20MT-HC-216x378 14'8" high x 25'6" wide

- (Future Logo)

Rear View of Scoreboard

← 10'0" tall x 21" wide Columns @2 by Others

NOTRE DAME PREPARATORY HIGH SCHOOL SCOTTSDALE, AZ

15'-0" CTR. to CTR.

Do not use for design/engineering or ad copy approval.

DAKTRONICS

ALL DIMENSIONS ARE APPROXIMATE

Copyright © 2015 Daktronics DD3028432 [03-26-15 (Rev0 revised 00-00-00) DWG# 0000000 Rev0]
The details and expressions shown are conceptual in nature, confidential and proprietary. Final design and appearance may differ from artwork shown.

All registered trademarks are the property of the registrant and their use does not imply endorsement of Daktronics. Do not reproduce by any means without the expressed written consent of Daktronics, Inc.

Signage Square Footage

Total Scoring System: 428 sq ft

Front:

Sound System: 24 sq ft (6% of total)

Clocks: 30 sq ft (7% of total)

Video Display: 374 sq ft (87% of total)

Total: 428 sq ft (100% of total)

ALL DIMENSIONS ARE APPROXIMATE





TODD & ASSOCIATES, INC.

Critical Thinking • Creative Design

Phoenix • Olympia

MEMORANDUM

Date:

March 27, 2015

To:

City of Scottsdale

From:

Dustin Simmons

Subject:

Project Narrative of Changes

Project No.:

12-9001-01

Project Name:

NDPHS Phase IIA

The staff approval change requested in this set adds the home bleachers & scoreboard to the sports complex. The changes include:

- 1. Asphalt Firelane
- 2. 4" Concrete PAD under home bleacher location
- 3. Pre-Manufactured Home Bleachers by Norconn
- 4. Location and list of track equipment for storage & fence location
- 5. Scoreboard design by Daktronics
- 6. 12' high Pedestrian / Security lighting for the home bleachers

The drawings that will be submitted include:

- Architectural Site Plan L4.2 (DR Approved Parking Counts and location of bleachers / scoreboard)
- Home Bleachers Site Plan A1.1.2
- Civil Plans Cover, Notes & P1
- Electrical Site Plan E1.2, Lights added to bleacher pathway
- Home Bleacher Plans A1, A2, A3, APB3
- Home Bleacher Seat Layout Color 11x17 exhibit
- Scoreboard Color Elevation 8x11 ½ Exhibits
- Material Samples: Home Bleacher Seats & Press Box Color / Finish
- Color Photos Examples of material finishes for guardrails

End of Memorandum

(DSS)

cc: File



TODD & ASSOCIATES, INC.

Critical Thinking - Creative Design

Phoenix • Olympia

March 27, 2015

Jesus Murillo
CITY OF SCOTTSDALE
7447 E. Indian School road
Scottsdale, Arizona

RE:

NDPHS – Phase IIA Staff Approval Submittal Project No. 12-9001-01

Dear Mr. Murillo:

Notre Dame is authorizing Todd & Associates to submit a plan change for Staff Approval and Final Plans Submittal for Home Bleachers & Scoreboard for Phase IIA Sports Complex.

This letter of documentation is per the request of Jesus Murillo, with the agreement that the City of Scottsdale will work diligently to accommodate a swift review for Staff Approval and Final Plan Drawings submittal.

The following plans are being submittal as this change:

- Architectural Site Plan A1.1
- Home Bleachers Site Plan A1.1.2
- Civil Plans Cover, Notes & P1
- Electrical Site Plan E1.2
- Home Bleacher Plans A1, A2, A3, APB3
- Home Bleacher Seat Layout Color 11x17 exhibit
- Scoreboard Color Elevation 8x11 1/2 Exhibits
- Material Samples: Home Bleacher Seats & Press Box Color / Finish
- Color Photos Examples of material finishes for guardrails

If you have any questions, please don't hesitate to give me a call.

Sincerely.

Dustin Signmons, PM

TODD & ASSOCIATES, Inc.

∐im Gmelich

DIOCESE OF PHOENIX / NDP

(DS/ms)

ARCHITECTURE PLANNING LANDSCAPE ARCHITECTURE

4019 N. 44th Street • Phoenix, AZ 85018 • (602) 952-8280 p • (602) 952-8995 f • www.toddassoc.com w L:\Prit2\12-9001-01\Con\Aurilio Staff Approval#1-3-27-15.docx

Dustin Simmons

From:

Murillo, Jesus < JMurillo@ScottsdaleAz,Gov>

Sent:

Friday, March 27, 2015 10:42 AM

To:

Dustin Simmons

Subject:

RE: Staff Approval - Home Bleachers

Nope, just the staff approval application and materials we described. Well, take this email just in case so they know I am expecting it.

Jesus

From: DSimmons@toddassoc.com [mailto:DSimmons@toddassoc.com]

Sent: Friday, March 27, 2015 10:03 AM

To: Murillo, Jesus

Subject: Staff Approval - Home Bleachers

Jesus,

I was planning to submit the home bleachers and scoreboard today for the staff approval. Is there anything I need from you in order to submit it?

THANKS!!!

Dustin Simmons
Director of Technology, Landscape Designer
Certified Desert Landscape Professional
(m) 623-451-6941



TODD & ASSOCIATES, INC.

ARCHITECTURE • PLANNING • LANDSCAPE ARCHITECTURE 4019 N. 44th Street Phoenix, Arizona 85018 602.952.8280 p 602.952.8995 f www.toddassoc.com

TA Project Number: 12-9001-01

CITY OF SCOTT SDALE

Staff Approval Application

Submittal Requirements

UV91 PURE		
Project Name: NDPHS Phase IIA	City S	Staff Contact: Jesus Murillo
Project Address: 9701 E. Bell Road, Scottsda	le A	Z 85260-2125
Project Address: 9701 E. Bell Road, Scottsda Zoning: R1-35 PCD-ESL A.P.N.: 217-14	-00	7E Quarter Section: 36_51
Associated References: Project Number: 351PA-2012 p	Plan C	Check Number Case(s) 12-ZN.2009
Request: Staff Approval for Home Bleachers	s / S	coreboard - Phase IIA
Is there an outstanding Code Enforcement citation or No	tice o	of Compliance? ☐Yes ☑No If yes, provide a copy.
Owner: Jim Gmelich	Ar	pplicant: Dustin Simmons / Brad Winkler
Company: Diocese of Phoenix / NDP		Todd & Associates, Inc.
Phone: 480-634-8201 Fax: NA		one: 602-952-8280 Fax: 602-952-8995
E-mail: jgmelich@notredamepreparatory.org		mail: dsimmons@toddassoc.com
Address: 9701 E. Bell Rd. 85260	Ad	dress: 4019 N. 44th St., Pnoenix AZ 85018
		terials requested below. All plans must be folded.
Completed Application (this form) and Application Fee \$ 87.00 (fee subject to change every July)	Ц	Cross Sections- for all cuts and fills
Context Aerial with site highlighted		Floor Plan(s) of additions, alterations, or new structures. The floor plan shall be dimensioned and clearly delineate
☐ Site Location Map		existing and proposed construction.
Maricopa County Assessor's Parcel Map with site location highlighted		Landscape Plan indicating location of existing and new plants, location and dimension of paving, a plant palette
Narrative describing nature of request		with names, symbols, sizes, spacing & quantities, and open space/landscaping calculations.
Property Owner's Authorization, or signature below		Elevation Drawings or Color Photosimulations of new additions, buildings, or other changes with materials and
Homeowners/Property Owners Association Approval (if applicable).	C7	colors noted and keyed to material samples. Material Samples- color chips, awning fabric, glazing, etc.
Color Photographs of site- including all areas of		Conceptual Grading & Drainage Plan showing existing
change.		& proposed drainage flows, channels and retention.
Site plan indicating extent and location of additions, buildings and other structures, indicate dimensions of existing and proposed structures, sidewalks, or		Copy of Liquor License Application (For all bars/ restaurants/patios)
driveways as well as any required setbacks.		Airport Vicinity Development Checklist- provided
Lighting- provide cut sheets, details, photometric for any proposed lighting.		Other: NAOS Exhibit
any proposed agrange		Other: 17700 Exhibit
Please Note: After staff review, it may be determined that through the public hearing process. If approved at staff level permit is required but has not been issued.		equest requires approval by the Development Review Board approval expires twelve (12) months from date of approval if a
·		3-27-15
Signature Circle One: Applicant Owner	_	Date
Officia	u Use	e Only:
Submittal Date:		City Staff Signature:
Planning & Develonm	enf	Services Department
		·

7447 E Indian School Road, Suite 105, Scottsdale, AZ 85251 • Phone: 480-312-7000 • Fax: 480-312-7800



Application for Permitting

*Required All Project Types - Excludes Demo, Fire, Pools & Backflow Preventer

*PROJECT ADDRESS:	9701 E. Bell Road, Sc	ottsdale AZ 8526	0Suite #	Unit #
Subdivision:				Lot #:
Zoning District(s): R1-3	5 PCD ESL	Parcel Number(s):	217-14-011E	
Quarter Section(s): 36-5	5 PCD ESL	_ Flood Zone(s):		
*PROJECT NAME:	NDPH PHASE IIA	·		· ·
*Associated Plan/Case N	Numbers <u>46-41-12-6</u>	·		(If Applicable)
*PERMIT/PLAN TYPE:			·	
•	levision to Approved Plan	? Mr Yes LINo	Green Building Po	rogram? ∐ Yes ∐ No
SINGLE FAMILY RESID	<u>. </u>	7		
	Remodel Addition [
Minimum:	Mechanical Plumbing	☐ Electrical ☐ B	Building LI Comi	00
COMMERCIAL:	New Commercial New S	hell 🏻 Tenant Impr	ovement D Additio	na
	nterior Remodel		_	
	Electrical Building			oder 11 14ew encerwall
		Mechanical Linu	inding [] combo	
CIVIL: Number of She	ets <u>4. </u>			•
☑ Grading □ D	rainage 🔲 Water 🔲 Se	wer Pavi	ng 🗹 Concrete	
☐ Utilities ☑ La	andscaping/Misc.	sc Row Encroachme	nt	lular
MULTI FAMILY: Numb	er of Units 🔲 Ap	eartment	ndominium [Townhouse
Final Plat	OF DEDICATION: Number of Minor Subdivision		daion	
	Easements & RO	_	ndo Plat	
	Attached Narrative, For			•
Scope of work:	7 ALGORIO TAGRATUO, 1 OF	TIOME DICACHERS	·	
*PROJECT SQ FOOTAG	GE COMMERCIAL & RESI	DENTIAL: Lot Sa Fi		IAOS Sa Ft
	New Non A/C			•
Addition A/C	_ Addition Non A/C	Fence LF	Retaining	Wall LF
Guest House A/C	Guest House N	on A/C		
*PROJECT DETAILS CO	OMMERCIAL: Occupant Ty	pe Constru	uction Type	_ Occupant Load
Plann	ing, Neighborho	od & Transp	ortation Di	vision



*Required

Application for Permitting

All Project Types - Excludes Demo, Fire, Pools & Backflow Preventer

*Property Owner: DIOCESE OF PHOENIX - NDF	Contractor: TBD	
Address: 9701 E. BELL RD.	Address:	No.
CitySCOTTSDALE State AZ Zip 85260	CityStateZip	
Phone: Fax:	Phone: Fax:	
Phone: Fax: Email: jgmelich@notredamepreparatory.org	Email:	
Lindai.	Roc# COS Tax License#	
Architect: BRAD WINKLER	Civil Engineer: RYAN WEED	
Company: TODD & ASSOCIATES, INC.	Company: COE & VAN LOO	7
Address: 4019 N. 44TH ST.	Address: 4550 N. 12TH ST.	
City PHOENIX State AZ Zip 85018 Phone: 602-952-8280 Fax: 602-952-8995	City PHOENIX State AZ Zin 8	5014
Phone: 602-952-8280 Fey: 602-952-8995	City_PHOENIX State_AZ Zip8 Phone: 602-264-6831 Fax:	
Email: BWINKLER@TODDASSOC.COM	Email: RWEED@CVLCI.COM	
Email:	Email:	
PLANS & PERMITS WILL ONLY BE RELEASED TO THE PERS		
	Company: KGM Construction	N LISTED.
*Applicant Contact: Kevin Markham	Company: KGM Construction Phone: 602.695.8211 Fax:	
*Applicant Contact: Kevin Markham *E-mail: kevin@kgmbuilders.com	Company: KGM Construction	
*Applicant Contact: Kevin Markham	Company: KGM Construction Phone: 602.695.8211 Fax: City Phoenix State AZ Zip 85 in Simmons (dsimmons@toddassoc.com) e permit for which I am applying does not relieve me of the soft the City of Scottsdale, Maricopa County and the State pority to enforce adopted building codes and appropriate	5018 le e of Arizona. I state,
*Applicant Contact: Kevin Markham *E-mail: kevin@kgmbuilders.com Address: 2424 West Missouri *Others authorized to pick up plans & permits: Dusting the plant of the plant	Company: KGM Construction Phone: 602.695.8211 Fax: City Phoenix State AZ Zip 85 in Simmons (dsimmons@toddassoc.com) e permit for which I am applying does not relieve me of the soft the City of Scottsdale, Maricopa County and the State pority to enforce adopted building codes and appropriate	5018 le e of Arizona. I state,
*Applicant Contact: Kevin Markham *E-mail: kevin@kgmbuilders.com Address: 2424 West Missouri *Others authorized to pick up plans & permits: Dusting the plant of the plant	Company: KGM Construction Phone: 602.695.8211 Fax: City Phoenix State AZ Zip 85 in Simmons (dsimmons@toddassoc.com) e permit for which I am applying does not relieve me of the soft the City of Scottsdale, Maricopa County and the State pority to enforce adopted building codes and appropriate	5018 le e of Arizona. I state,
*Applicant Contact: Kevin Markham *E-mail: kevin@kgmbuilders.com Address: 2424 West Missouri *Others authorized to pick up plans & permits: Dusting the plant of the plant	Company: KGM Construction Phone: 602.695.8211 Fax: City Phoenix State AZ Zip 85 in Simmons (dsimmons@toddassoc.com) e permit for which I am applying does not relieve me of the soft the City of Scottsdale, Maricopa County and the State pority to enforce adopted building codes and appropriate	5018 le e of Arizona. I state,
*Applicant Contact: Kevin Markham *E-mail: kevin@kgmbuilders.com Address: 2424 West Missouri *Others authorized to pick up plans & permits: Dusting the plant of the plant	Company: KGM Construction Phone: 602.695.8211 Fax: City Phoenix State AZ Zip 85 in Simmons (dsimmons@toddassoc.com) e permit for which I am applying does not relieve me of the soft the City of Scottsdale, Maricopa County and the State pority to enforce adopted building codes and appropriate fruction documents. I acknowledge that this application were	de e of Arizona. I e State, ill expire 180
*Applicant Contact: Kevin Markham *E-mail: kevin@kgmbuilders.com 2424 West Missouri *Others authorized to pick up plans & permits: Dusting the plans of the presponsibility that this work will be done in conformity with the laws further agree that the Scottsdale Inspections Division has the authonomy and City laws and regulations not indicated on the constructions after the last plan submittal.	Company: KGM Construction Phone: 602.695.8211 Fax: City Phoenix State AZ Zip 85 in Simmons (dsimmons@toddassoc.com) e permit for which I am applying does not relieve me of the soft the City of Scottsdale, Maricopa County and the State pority to enforce adopted building codes and appropriate ruction documents. I acknowledge that this application were considered to the construction documents. I acknowledge that the construction documents are considered to the construction documents. I acknowledge that the construction documents are constructed to the construction documents. I acknowledge that the construction documents are constructed to the construction documents. I acknowledge that the construction documents are constructed to the construction documents.	de e of Arizona. I e State, ill expire 180

Planning, Neighborhood & Transportation Division

7447 E Indian School Road, Suite 100, Scottsdale, AZ 85251 • Phone: 480-312-2500 • Fax: 480-312-7088



Construction Document Application Request for Site Visits and/or Inspections

Pr	oject Name:	NDPHS Phase IIA	
Pr	oject Address:	9701 E. BELL RD.	
\$1	TATEMENT OF	AUTHORITY:	
1.	have the aut	hority from the owner to	am the duly and lawfully appointed agent of the property and sign this request on the owner's behalf. If the land has more or all owners, and the word "owner" refer to them all.
2.	and all deve	•	o act for the owner before the City of Scottsdale regarding any sulatory or related matter of every description involving all document.
S1	TATEMENT OF	REQUEST FOR SITE VISITS	AND/OR INSPECTIONS
	•		
1.			ottsdale's staff conduct site visits and/or inspections of the tapplication in order to efficiently process the application.
1. 2.	property ide I understand and/or inspe	ntified in the developmen I that even though I hav	ottsdale's staff conduct site visits and/or inspections of the tapplication in order to efficiently process the application. The requested the City of Scottsdale's staff conduct site visits ermine that a site visit and/or an inspection is not necessary,
2.	property ide I understand and/or inspe and may opt	ntified in the developmen I that even though I hav ections, city staff may det not to perform the site vi	ottsdale's staff conduct site visits and/or inspections of the tapplication in order to efficiently process the application. The requested the City of Scottsdale's staff conduct site visits that a site visit and/or an inspection is not necessary,
2.	property ide I understand and/or inspe and may opt	ntified in the developmen I that even though I havections, city staff may det	ottsdale's staff conduct site visits and/or inspections of the tapplication in order to efficiently process the application. The requested the City of Scottsdale's staff conduct site visits ermine that a site visit and/or an inspection is not necessary,
2.	property ide I understand and/or inspe and may opt	ntified in the developmen I that even though I hav ections, city staff may det not to perform the site vi	ottsdale's staff conduct site visits and/or inspections of the it application in order to efficiently process the application. The requested the City of Scottsdale's staff conduct site visits ermine that a site visit and/or an inspection is not necessary, sit and/or an inspection.
2.	property ide I understand and/or inspe and may opt	ntified in the developmen I that even though I hav ections, city staff may det not to perform the site vi	ottsdale's staff conduct site visits and/or inspections of the it application in order to efficiently process the application. The requested the City of Scottsdale's staff conduct site visits ermine that a site visit and/or an inspection is not necessary, sit and/or an inspection. Print Name
2.	property ide I understand and/or inspe and may opt	ntified in the developmen I that even though I hav ections, city staff may det not to perform the site vi	ottsdale's staff conduct site visits and/or inspections of the it application in order to efficiently process the application. The requested the City of Scottsdale's staff conduct site visits ermine that a site visit and/or an inspection is not necessary, sit and/or an inspection. Print Name

Planning, Neighborhood & Transportation Division

7447 E Indian School Road, Suite 105, Scottsdale, AZ 85251 ♦ Phone: 480-312-7000 ♦ Fax: 480-312-7088



Review Methodologies For Application for Permitting and Development Applications

Review Methodologies

The City of Scottsdale maintains a business and resident friendly approach to new development and improvements to existing developments. In order to provide for flexibility in the review of Development Applications, and Applications for Permitting, the City of Scottsdale provides two methodologies from which an owner or agent may choose to have the City process the application. The methodologies are:

1. Enhanced Application Review Methodology

Within the parameters of the Regulatory Bill-of-Rights of the Arizona Revised Statutes, the Enhanced Application Review method is intended to increase the likelihood that the applicant will obtain an earlier favorable written decision or recommendation upon completion of the city's reviews. To accomplish this objective, the Enhanced Application Review allows:

- the applicant and City staff to maintain open and frequent communication (written, electronic, telephone, meeting, etc.) during the application review;
- City staff and the applicant to collaboratively work together regarding an application; and
- City staff to make requests for additional information and the applicant to submit revisions to address code, ordinance, or policy deficiencies in an expeditious manner.

Generally, the on-going communication and the collaborative work environment will allow the review of an application to be expedited within the published Staff Review Time frames.

Standard Application Review Methodology:

Under the Standard Application Review, the application is processed in accordance with the Regulatory Bill-of-Rights of the Arizona Revised Statutes. These provisions significantly minimize the applicant's ability to collaboratively work with City Staff to resolve application code, ordinance, or policy deficiencies during the review of an application. After the completion the city's review, a written approval or denial, recommendation of approval or denial, or a written request for additional information will be provided.

The City is not required to provide an applicant the opportunity to resolve the application deficiencies, and staff is not permitted to discuss or request additional information that may otherwise resolve a deficiency during the time the City has the application. Since the applicant's ability to collaboratively work with Staff's to resolve deficiencies is limited, the total Staff Review Time and the likelihood of a written denial, or recommendation of denial is significantly increased.

In addition to the information above, please review the Development Application, and/or the Application for Permitting flow charts. These flow charts provide a step-by-step graphic representation of the application processes for the associated review methodologies.

	Enhanced Application Review:	I hereby authorize the City of Scottsdale to review this application utilizing the Enhanced Application Review methodology.			
	Standard Application Review:	I hereby authorize the City of Scottsdale to review this application utilizing the Standard Application Review methodology.			
		EDITO D			
Owner Signature		Agent/Applicant Signature			
Official Use Only: Submittal Date:		Development Application No.:			
THE SERVICE		Rlanning Neighborhood & Transportation			

chool Road Suite 105, Scottsdale, Afrizona, 85251, Phone: 480-312-7,000

wolsousdele's Websice www.sousdelenz.gov



MEMORANDUM

Date: March 27, 2015

To: Jesus Murillo

From: Dustin Simmons

Subject: Sample Photos for Bleachers

Project No.: 12-9001-01

Project Name: NDPHS Phase IIA

Sample Seats:

1. The stanchoin – will be platinum (Lower Legs)

2. Seat color - Purple or Tan per plans


3. Side arms - Will match purple / tan color - Different then photo

4. Some portions will be metal & plastic material.



MEMORANDUM (12-9001-01) March 27, 2015 Page 2

Sample Railings: The photos are samples of the existing bleachers. The Home bleachers will match the railing type and color.

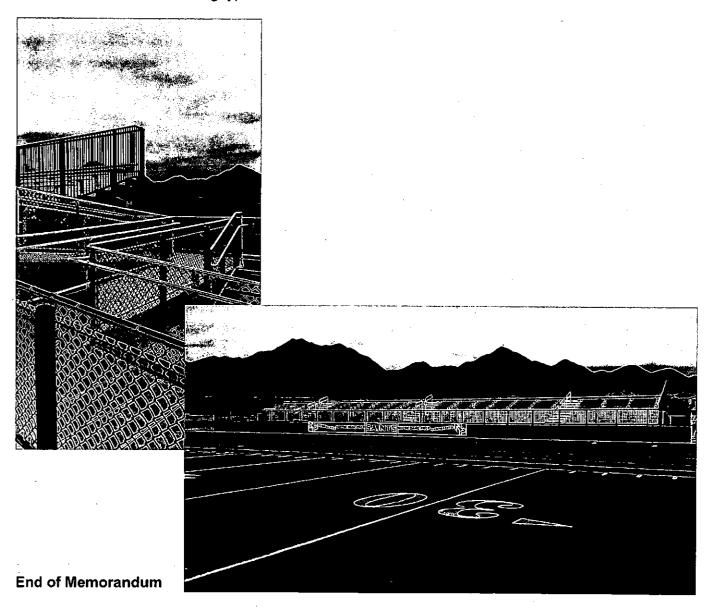

(DSS)

CC:




MUELLER PANEL COLOR CHART



www.muellerinc.com

PANEL OPTIONS

AP PANEL

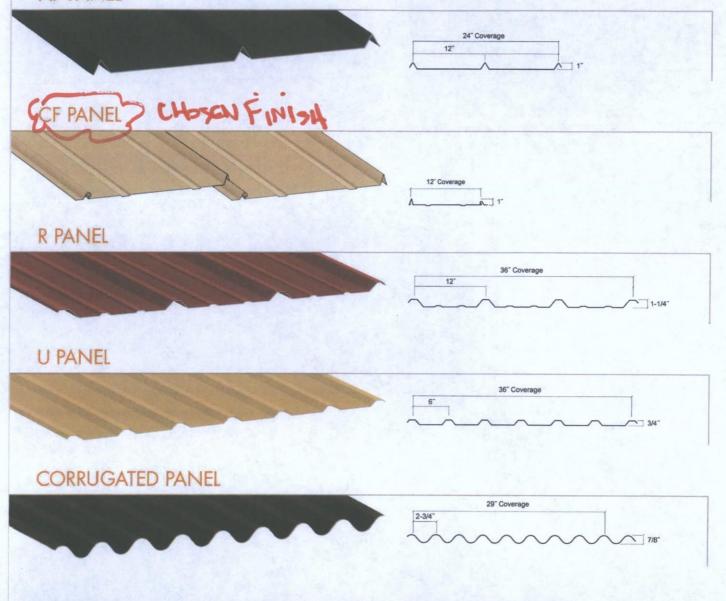



AP Panel

Choose from Column A

CF Panel

Choose from Columns A or B

R, U & C Panel

Choose from Columns A, B or C

Column A



Light Stone

Tan

Mueller, Inc. reserves the right to add or discontinue colors without notice. Please contact your sales representative, or visit our website at www.muellerinc.com for our current color selection.

Printed colors may vary. Please contact us for color samples.

*Galvalume has a protective top coat which may possibly change the color of the panels over a period of time, giving a slight brownish tint to the panels. For consistent color retention, Mueller recommends using painted panels.

Column B Twilight Gray Smokey Pewter Smokestack Gray Deep River Blue Coco Brown Forest Green Saddle Leather Chestnut Brown Brown Rustic Brown Sunset Red

Desert Tan



CHOSEN ColoR.

Our highly advanced paint system ensures color and beauty that lasts.

Have you ever wondered why some metal roofs fade over time, and others stay looking fresh and vibrant? The answer lies in the roof's exterior coating. The strength of the resins and the choice of pigmentation are the most vital factors in the performance of any metal paint system. The resins bind and protect the pigments and form a protective barrier against the elements. The pigments create the color of the roof and reflect solar radiation that can destroy the resins and the underlying primer.

With Mueller's paint system, you get the best of both. We use a high-performance exterior coating that can deliver better performance over time and reduce your cooling and heating load. The cool pigments in Mueller metal roofing panels offer higher solar reflectance. As a result, they reflect infrared radiation while absorbing the same amount of visible light. This allows the panel to appear the same color as lesser-reflecting pigments, yet stay much cooler. And most of our colors are Energy Star approved, further demonstrating their superior energy efficiency.

MUELLER PANEL BENEFITS:

- · Fire Resistant
- Hail Resistant –
 Underwriters Laboratories

 Class 4 Rating
- 30-Year Limited Paint Warranty
- A Wide Range of Designer Colors
- Wind Resistant up to 140 mph
- 26-Gauge Commercial Grade Steel
- Energy Efficient
- Greater Life Expectancy
- Outstanding Durability
- Practically
 Maintenance Free
- Possible Insurance Savings
- Easy application



FIND OUT MORE ABOUT MUELLER PRODUCTS



Convenient Locations Across the Southwest!



CALL 877-2-MUELLER (877-268-3553)

This toll-free number connects you to one of our sales locations across the Southwest.

CLICK

www.muellerinc.com

Our interactive website offers photos and all the details of our metal products.

COME BY

Our branches are staffed with experts who are always happy to answer any questions you may have.

FIND US

On Facebook, check out our latest news and events.



The second secon	Territoria de la constitución de	CHIPPING PROPERTY AND	PROGRAMMA AND RECEIVE	Wes Solar Ser	Samuel Company	120120010010013-0100
		L S PAGE PAGE	100 (100 (100 (100 (100 (100 (100 (100	Reflectance	. Ught	A. A
Product to	Thermal	Gloss'	Sheen	(TSR) 1 20190	Reflectance	Energy
Description As a real real	Emittance .	Range 0 to 100	Ronga o to 180	O to 1	Value (LRV)	Star Rated
	a Range 0 to 120			25 km linerby star;	Range 0 to 1	
	20年2年1	3.00	1 30 E. W.	经验验证金		
Galvaluma Plus (New)	0.31 ± 0.02	28 ± 5	53 ± 10	0.68	65	Yes
Galvalume Plus (Aged -12 Years)	0.13 ± 0.02	12 ± 5	44 ± 10	0.54	42	Yes
					7	
White CERAM-A-START 1050 CC	0.89 ± 0.02	35 ± 5	70 ± 10	0.59	68	Yes
LE Gray CERAM-A-STAR 1050 CC	0.87 ± 0.02	35 ± 5	70 ± 10	0.48	40	Yes
Tan WeatherX**	0.85 ± 0.02	28 ± 5	65 ± 10	0.47	36	Yes
Taniceram-A-START 1050 CC	0.84 ± 0.02	35 ± 5	70 ± 10	0.50	32	Yes
Lightstone WeatherX**	0.86 ± 0.02	30 ± 5	59 ± 10	0.57	53	Yes
Lt. Stone CERAM-A-START 1050 CC	0.83 ± 0.02	35 ± 5	70 ± 10	0.59	50	Yes
MANAGE CONTROL SANCE SEED OF STREET		<u> </u>				
Banner Red TRINAR	0.89 ± 0.02	35 ± 5	70 ± 10	0.40	11	Yes
Black WeatherX**	0.89 ± 0.02	30 ± 5	59 ± 10	0.08	6	No
Black GERAM-A-STAR 1050 CC	0.87 ± 0.02	35 ± 5	70 ± 10	0.25	1	No
Bright Copper CERAM-A-STAR 1950	0.89 ± 0.02	25 ± 5	50 ± 10	0.42	29	Yes
Bright Silver Valspar Kynar**	0.89 ± 0.02	18 ± 5	25 ± 10	0.60	42	Yes
Bright Silver TRINAR TO A STATE OF THE STATE	0.83 ± 0.02	25 ± 5	50 ± 10	0.57	41	Yes
Burgundy CERAM-A-START 1050	0.89 ± 0.02	35 ± 5	70 ± 10	0.16	7	No
Burnished Slate CERAM-A-STARM 1050 GC 3000	0.89 ± 0.02	35 ± 5	70 ± 10	0.26	10	Yes
Charcoal GERAM-A-START 1050 CC	0.89 ± 0.02	35 ± 5	70 ± 10	0.33	14	Yes
Cocoa Brown CERAM-A-STAR 1050 CC	0.89 ± 0.02	35 ± 5	70 ± 10	0.31	11	Yes
Colony Green CERAM-A-STAR 1050 CC	0.89 ± 0.02	35 ± 5	70 ± 10	0.38	21	Yes
Crimson Red CERAM-A-STAR 940	0.89 ± 0.02	35 ± 5	70 ± 10	0.42	12	Yes
Deep Blue CERAM-A-START 1050 CC	0.89 ± 0.02	35 ± 5	70 ± 10	0.27	12	Yes
Deep Green GERAM A STAR 1050 GC	0.89 ± 0.02	35 ± 5	70 ± 10	0.25	- 10	Yes
GOIL CERAM-A-START-1050	0.89 ± 0.02	35 ± 5	70 ± 10	0.49	45	Yes
HawalianiBlue CERAM-A-START 1050	0.89 ± 0.02	35 ± 5	70 ± 10	0.20	18	Yes
IVy Green CERAM-A-START-1050 CC	0.89 ± 0.02	<u>35 ± 5</u>	70 ± 10	0.31	8	Yes
Mansord Brown CERAM-A-STAR 1050 CC	0.89 ± 0.02	35 ± 5	70 ± 10	0.25	8	Yes
Marine Green CERAM-A-STAR" 1050 CC	0.89 ± 0.02	35 ± 5	70 ± 10	0.39	29	Yes
ORANGE CERAM-A-STAR 1950	0.69 ± 0.02	35 ± 5	70 ± 10	0.51	22	Yes
Red CERAM-A-STAR! 1050 CC	0.86 ± 0.02	35 ± 5	70 ± 10	0.36	12	Yes
司法规则是在法律不同的概定在明显的主义。1972年1972年第二世		ļ				<u> </u>
New Primer	N/A	N/A	N/A	0.45	44	N/A
Off White Backer	0.89 ± 0.02	35 ± 5	N/A	0.46	62	N/A
	0.00 / 0.00	 	20 : 20			├ ── <u></u>
Chestnut Brown CERAM A STAR@ 1050 CC	0.89 ± 0.02	15 ± 5	30 ± 10	0.29	13	Yes
Deep River Blue CERAM-A-STAR® 1050 CC"	0.89 ± 0.02	15 ± 5	30 ± 10	0.26	12	Yes
Desert Tan Valspar Weather X** Desert Tan CERAM A STAR® 1050 CC	0.85 ± 0.02	15 ± 5	30 ± 10	0.46	31	Yes
Forest Green CERAM-A-STAR® 1050 CCC	0.87 ± 0.02 0.89 ± 0.02	15 ± 5 15 ± 5	30 ± 10	0.44	28	Yes
Patriot Red CERAM-A-STAR* 1050 CC	0.80 ± 0.02	15 ± 5	30 ± 10	0.25	9 9	Yes
Rustle Brown CERAM-A-STAR@1050/CCM	0.89 ± 0.02	15 ± 5	30 ± 10	0.42		- Pending
Saddle Leather Tan CERAM-A-STAR® 1050 CC	0.89 ± 0.02	15 ± 5	30 ± 10	0.31	. 14	Yes "
Smokestack Gray Valspar Weather X**	0.86 ± 0.02	15 ± 5	30 ± 10	0.35	20	Yes
Smoke Stack Gray CERAM-A-STAR® 1050 CC	0.88 ± 0.02	15 ± 5	30 ± 10	0.33	17	Yes
Smokey Pewter CERAM-A-STAR®/1050 CC	0.84 ± 0.02	15 ± 5	30 ± 10	0.45	31	Yes
SUNSET RED CERAM-A-STARO 1050 CC	0.89 ± 0.02	15 ± 5	30 ± 10	0.39	15	Yes
Twilight Gray Valspar Weather X**	0.85 ± 0.02	15 ± 5	30 ± 10	0.59	53	Yes
TWIIGHT Gray CERAM-A-STAR® 1050 CCM	0.84 ± 0.02	15 ± 5	30 ± 10	0.59	51	Yes
	2107 - 4.46		_ <u> </u>	V.39	72	163

ASTM E 408 "Standard Test Methods for Total Normal Emittance of Surfaces Using Inspection-Meter Techniques"

ASTM D 523 "Standard Test Method for Specular Gloss". Measured at 60 degree geometry.

ASTM D 523 Standard Test Method for Specular Gloss". Measured at 85 degree geometry.


*ASTM C 1549 "Standard Test Method for Determination of Solar Reflectance Near Ambient Temperature Using a Portable Solar Reflectometer"


ASTM C 1349 Standard Test Method for Determination of Solar Reflectance Near Ambient Temperature Using a Portable Solar Reflectameter."

SASTM E 1477 "Standard Test Method for Luminous Reflectance Factor of Acoustical Materials by Use of Integrating-Sphere Reflectometers". Cap Y tristimulus value is measured using D65 Illuminant.

CC'm Means Paint is Energy Star and Cool Roof Rated

*** Older (No longer used Valspar Paint Ssytem)

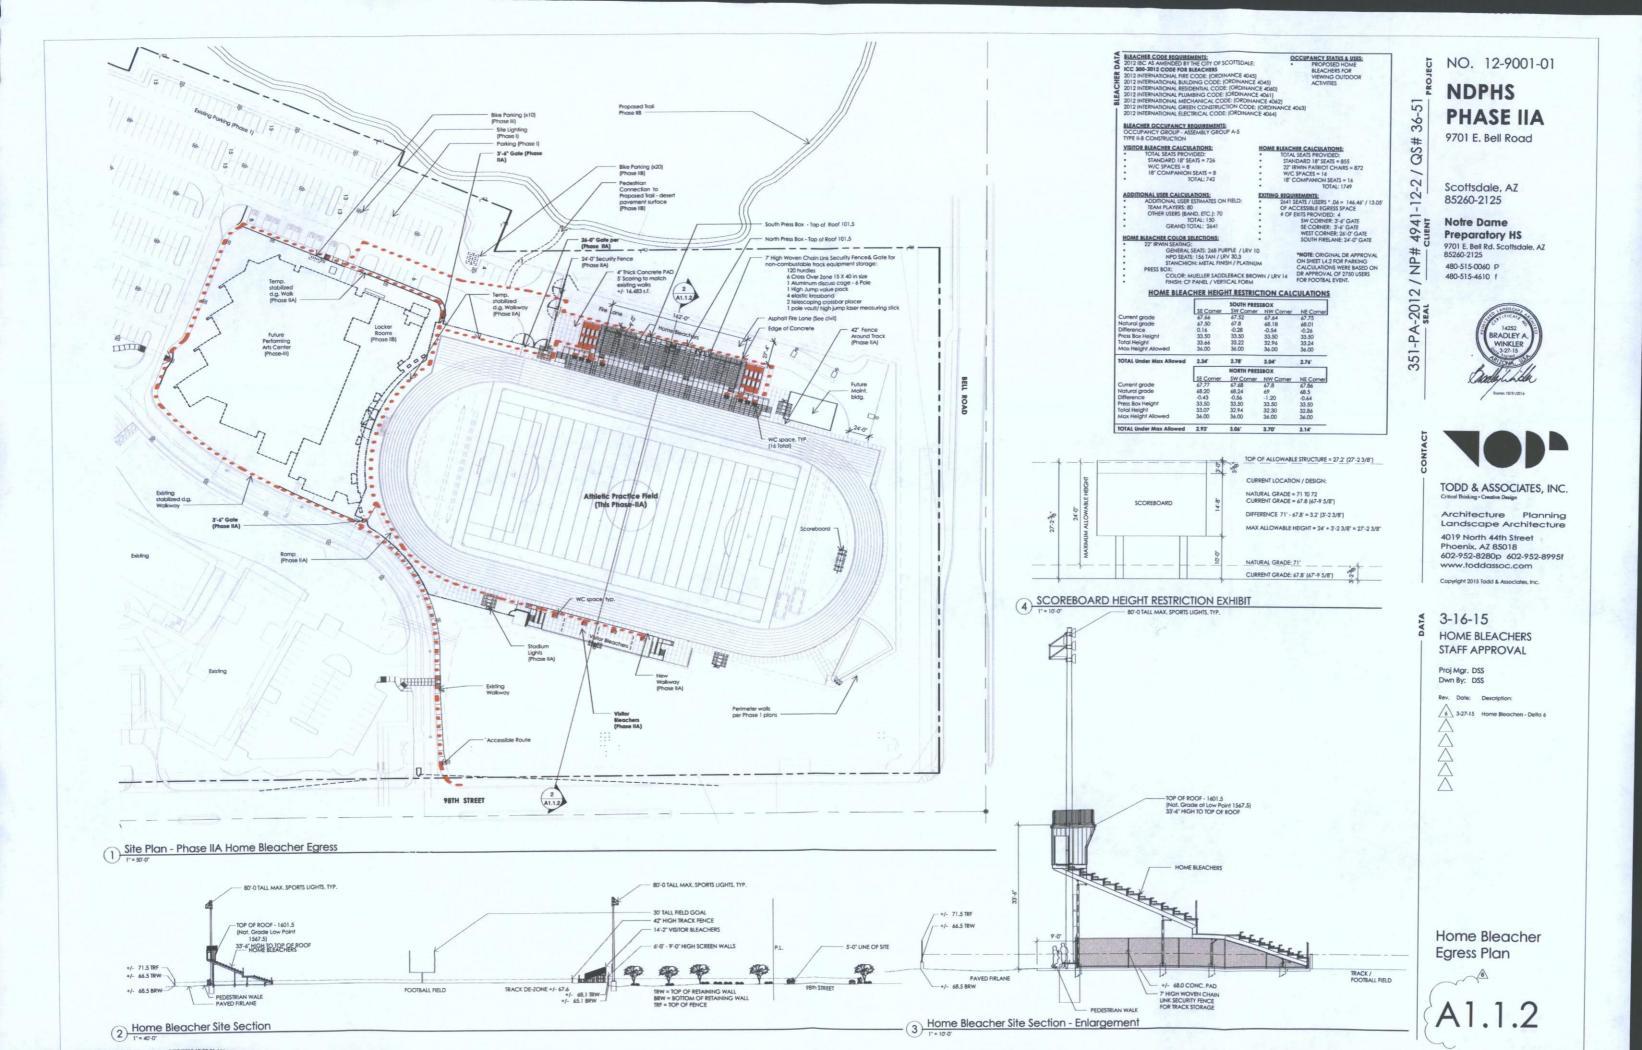

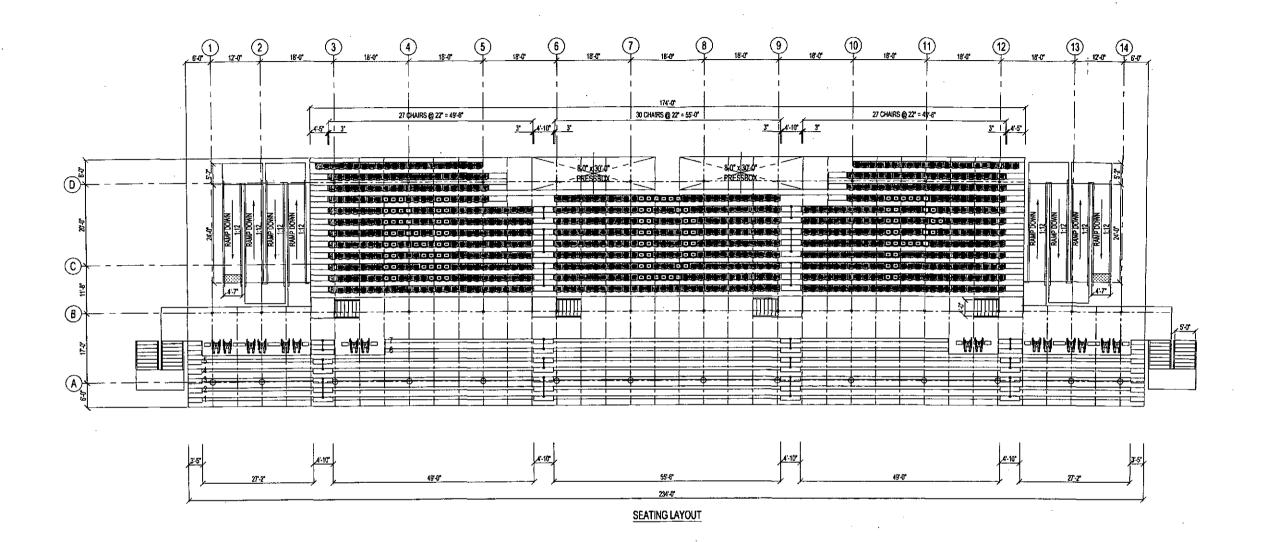


18" COMPANION SEATS WHEELCHAIR SPACES ... TOTAL SEATS COLOR LEGEND:

158 TAN 268 PURPLE JOB NUMBER: 601-XXXX SHEET NUMBER:

(1) 19 ROW x 246:0"
STAND A (HOME FOOTBALL)
SCOTTSDALE, AZ
NOTRE DAME PREP

A1

Economical Mill Finish Footboards have been specified for all aluminum walking surfaces in this contract. These mill finish footboards will likely have water stains (dark black, brown, or white) present resulting from unavoidable condensation that occurs during packaging, transporting and storage preceding installation. Removal of these stains or board replacement upon completion of installation is not part of this contract because stained mill finish boards meet all specified requirements. Clear anodized aluminum may be purchased to avoid any water stains if selected as an upgrade finish at additional cost by signed contract change order prior to the start of fabrication.

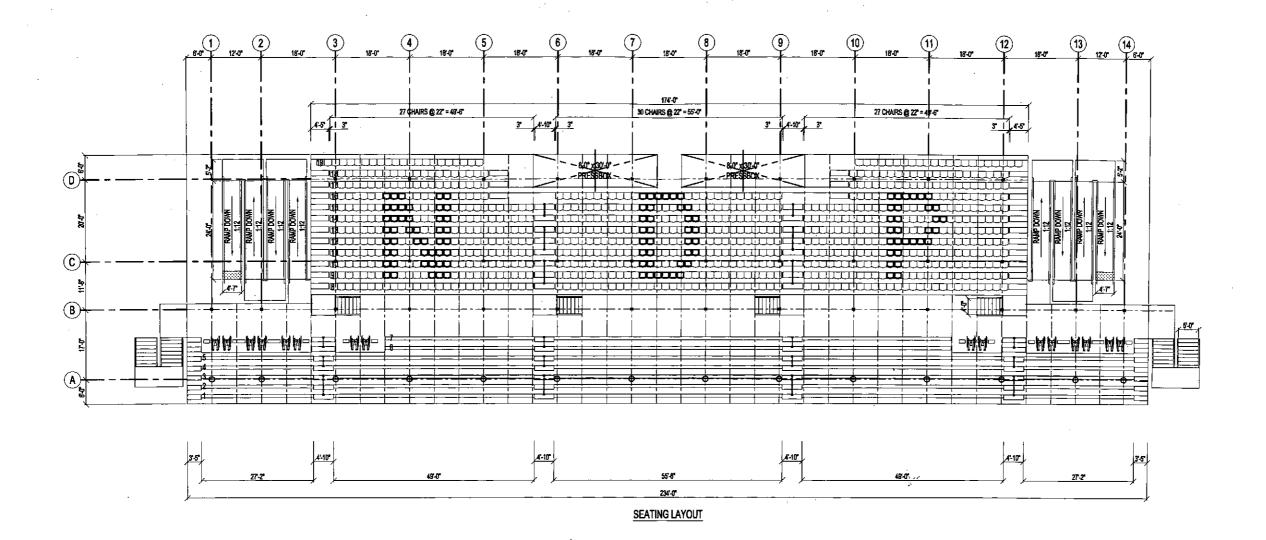


18" BEN	CH SEATS	•••••
22° IRW	IN PATRIOT C	HAIRS
18" CON	IPANION SEA	T\$
WHEEL	CHAIR SPACE	S

JOB NUMBER: 601-XXXX SHEET NUMBER:

Economical Mill Finish Footboards have been specified for all aluminum walking surfaces in this contract. These mill finish footboards will likely have water stains (dark black, brown, or white) present resulting from unavoidable condensation that occurs during packaging, transporting and storage preceding installation. Removal of these stains or board replacement upon completion of installation is not part of this contract because stained mill finish boards meet all specified requirements. Clear anodized aluminum may be purchased to avoid any water stains if selected as an upgrade finish at additional cost by signed contract change order prior to the start of fabrication.

STAND A (HOME FOOTBALL)
SCOTT SDALE, AZ
NOTRE DAME PREP


A1

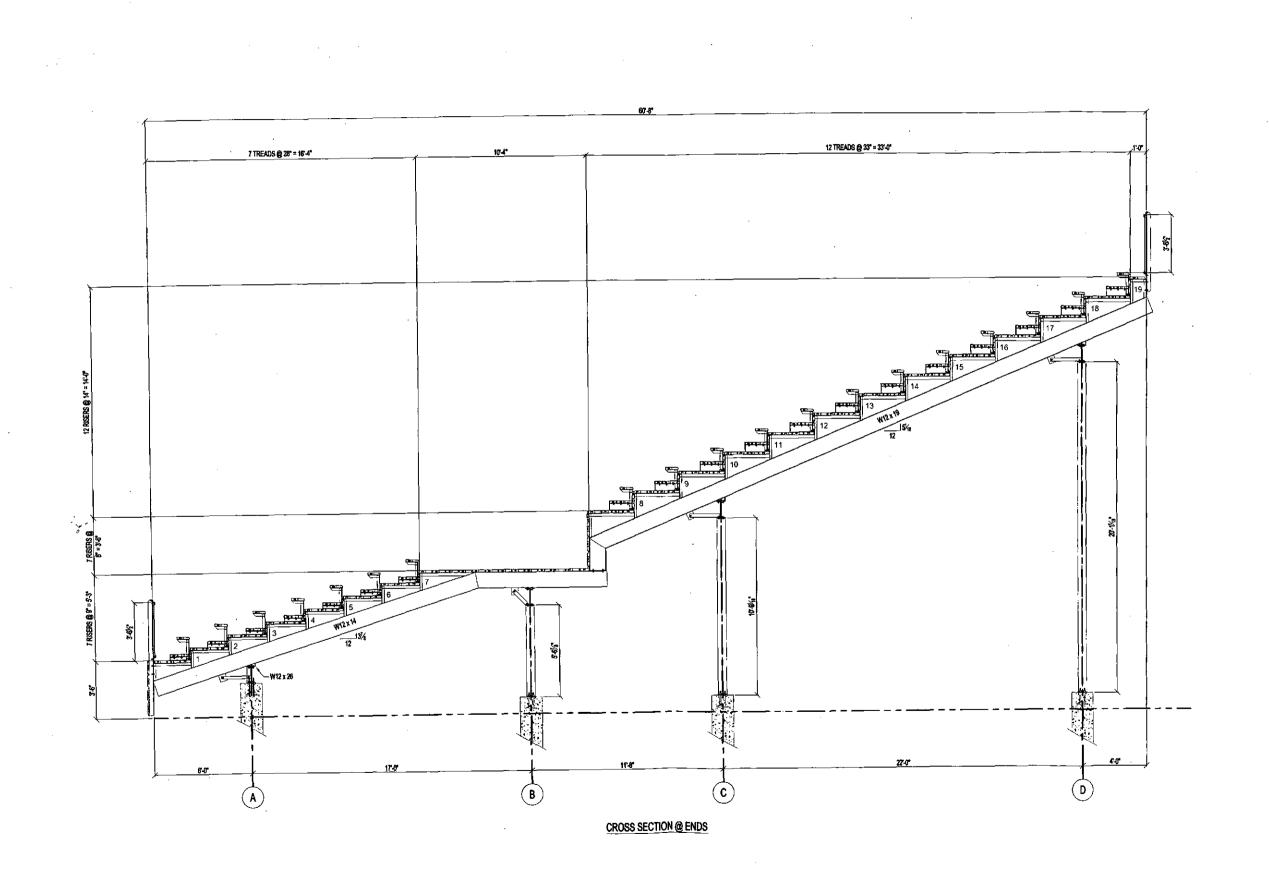

STAND A (HOME FOOTBALL)
SCOTTSDALE, AZ
NOTRE DAME PREP


JOS NUMBER: 601-XXXX SHEET NUMBER:

A2

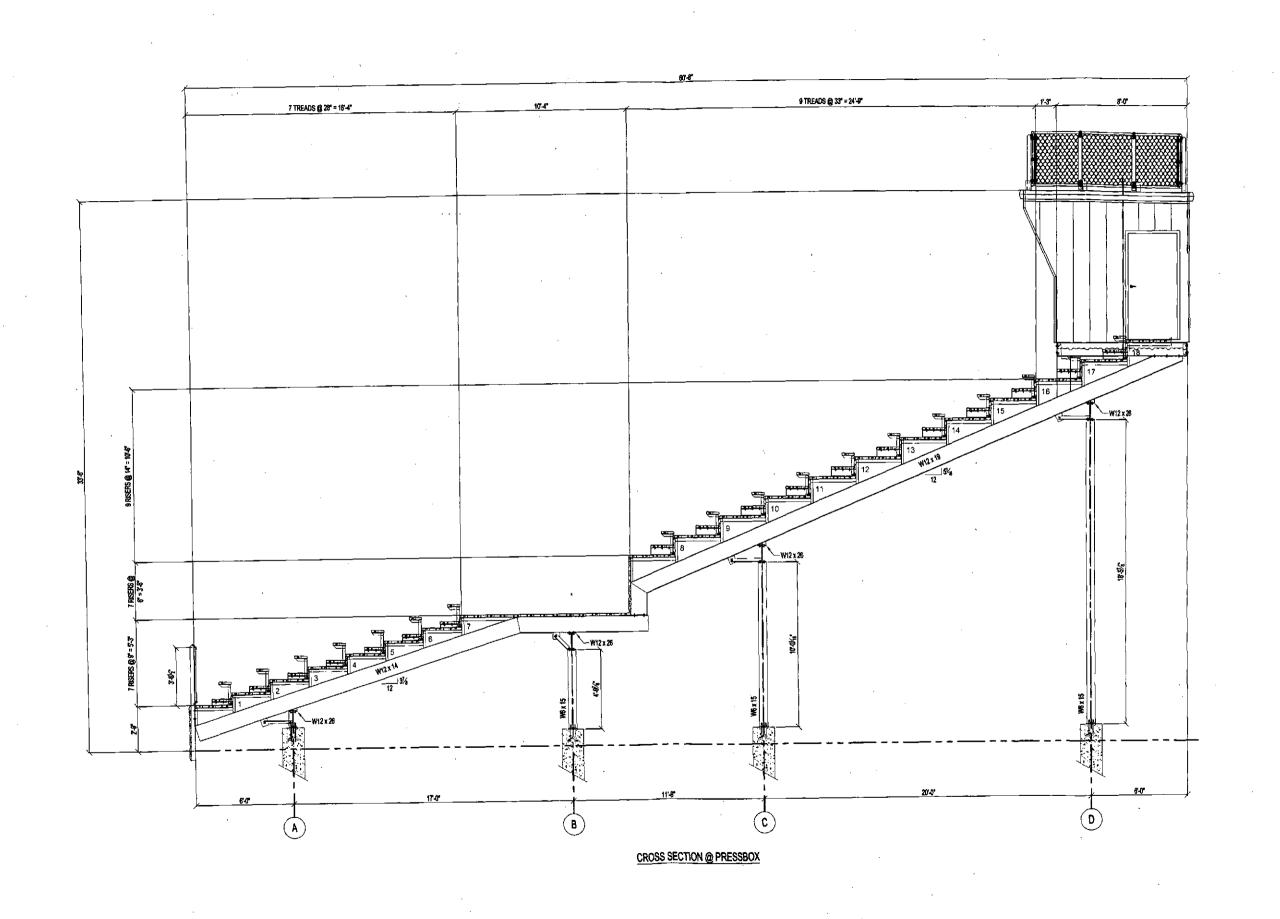


JOB NUMBER: 601-XXXX SHEET NUMBER:


A3

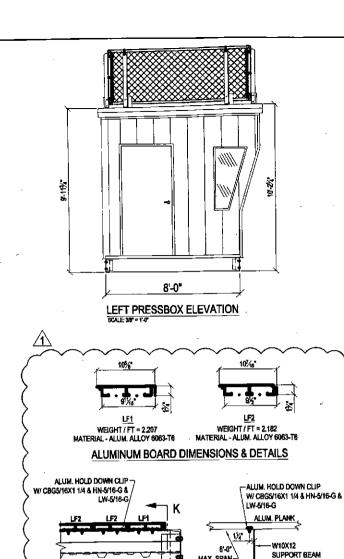



- W10X12 SUPPORT BEAM

SECTION K 1"=1'-0" APB1

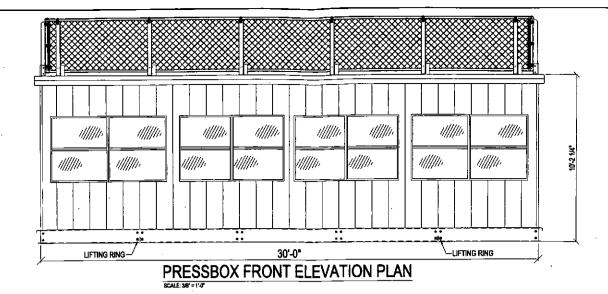

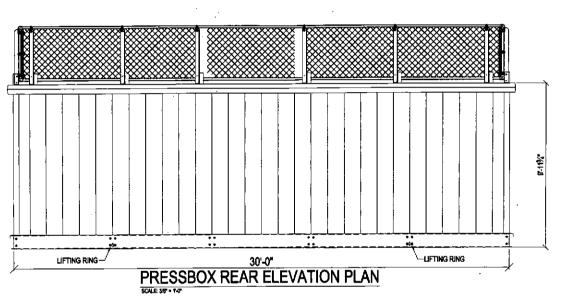

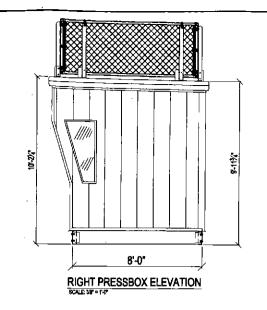


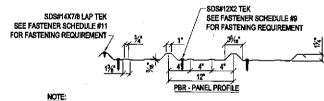

NOTE: PANIEL PROPERTIES, ALLOWABLE LOADS AND FASTENER SPACING REQUIREMENTS PER MBCI.

	R-PANEL PROPERTIES							
PANEL	Fy	THK.	wt	lx IN*	_ 5x IN ³	Jx IN⁴	Sx IN ³	
GAUGE	PSI	IN.	PSF	POS.	BEND	NEG.	BEND	
26	60,000	0.0179	0.96	0.0369	0.0372	0.0302	0.0511	

		1	PBR PAN	EL				
	ALLOWABLE	UNIFORM I	LOADS IN	POUNDS P	ER SQUAR	E FOOT		
26 Gauge (Fy =	60 KSI)							
SPAN TYPE	LOAD TYPE	SPAN IN FEET						
SPAN TIPE		3.D	4.0	5.0	6.0	7.0	8.0	9.0
SINGLE	NEGATIVE WIND LOAD	136.0	76.5	49.0	34.0	25.0	19.1	15.1
SINGLE	LIVE LOAD / DEFLECTION	99.1	50.4	25.8	14.9	9.4	6.3	4.4
2-SPAN	NEGATIVE WIND LOAD	99.1	: 55.7	35.7	24.B	18.2	13.9	11.0
Z-SPAN	LIVE LOAD / DEFLECTION	87.3	54.6	35,2	24.5	18.1	13.9	10.7

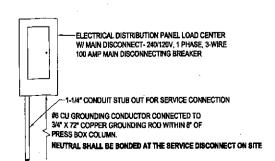

NOTE: ELECTRICAL SERVICE PANEL GROUNDING AND SERVICE LATERAL IS THE RESPONSIBILITY OF THE OWNER AND WILL BE INSPECTED UNDER THE AUTHORITY OF THE LOCAL AUTHORITY HAVING JURISDICTION.

PANEL ELEVATION

·

(1 OF 2) 8X30 METAL PRESS BOX STAND A (HOME FOOTBALL) SCOTTSDALE, AZ NOTRE DAME PREP

> JOB NUMBER: SHEET NUMBER:

APB3