Full Size 8.5 x 11 11 x 17 (site plan, landscape, elevations)

DRB STIPULATIONS:

1. SCHEDULE A PRE-CONSTRUCTION MEETING BY CONTACTING INSPECTION SERVICES AT 480-312-5750.

I - Mobile -

SITE #: PH10233D

SITE NAME: MONARCH PROPERTY

CITY: SCOTTSDALE

STATE: AZ

COUNTY: MARICOPA

DESIGN TYPE: EXISTING MONOPOLE

PROJECT INFORMATION

ADDRESS

409 N. SCOTTSDALE RD. SCOTTSDALE, AZ 85257

LANDLORD

MONARCH HOLDING PROPERTIES 409 N. SCOTTSDALE ROAD SCOTTSDALE, AZ 85257

JURISDICTION

CITY OF SCOTTSDALE

LAND DESCRIPTION OF SUBJECT PARCEL

ZONING: R-5 APN#: 131-16-141E

PROJECT OWNER

T-MOBILE WEST CORP. 2625 S. PLAZA DRIVE, #400 TEMPE, ARIZONA, 85282 CONTACT: JEREMY WEBSTER PHONE: (602) 332-7675

PROJECT DESCRIPTION

PROPOSED REPLACEMENT OF (2) T-MOBILE ANTENNAS PER SECTOR, PROPOSED INSTALLATION OF (1) NEW T-MOBILE ANTENNA PER SECTOR. MOUNTED TO EXISTING MOUNTS ON THE EXISTING MONOPALM. NO ELECTRICAL UPGRADE PROPOSED IN THIS PROJECT

CONSULTING TEAM

ARCHITECT

YOUNG DESIGN CORP. 10245 E. VIA LINDA #211 SCOTTSDALE, AZ, 85258 CONTACT: JOHN SULTZBACH PHONE: (480) 451-9609


ZONING

COAL CREEK CONSULTING 2520 E. UNIVERSITY DRIVE, # 107 TEMPE, AZ, 85281 CONTACT: DECLAN MURPHY PHONE: (602) 326-0111

INDEX OF DRAWINGS

NUMBER	NAME OF SHEET	REV.
T-1	TITLE PAGE	0
A-1	SITE PLAN	0
A-2	ENLARGED SITE PLAN	0
A-3	ANTENNA INFORMATION	0
A-4	ELEVATIONS	0
A-5	NOT USED	0
A-6	DETAILS	0

VICINITY MAP

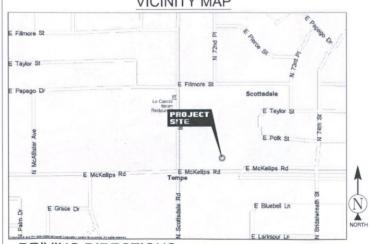

DRIVING DIRECTIONS

TAKE 101 NORTH TO McKELLIPS ROAD EXIT. HEAD WEST ON McKELLIPS TO SCOTTSDALE ROAD. MAKE A RIGHT ON SCOTTSDALE ROAD, SITE WILL BE ON EAST SIDE OF THE ROAD IN SIDE OF RESIDENTUAL COMPLEX. SITE IS A MONOPALM WITH EQUIPMENT INSIDE OF A TRASH ENCLOSURE.

24-UP-2005#3

Ayoung design corp

103-DR-200

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SIGN

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24-UP-2005#2

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24-UP-2005

RMIT:

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CONDITIONAL

HISTORY

CASE

10245 F. Via Linda Scottsdale A7 85258 ph: 480 451 9609 fax: 480 451 9608



140.	DAIL	TULSCRIT TION
1	8/16/12	REVIEW
2	08/21/12	FINAL CD'S
3	1/25/13	RE-SUBMITTAL
4	11/6/13	RE-SUBMITTAL
l		

YDC - 4004

PH10233D MONARCH PROPERTY

409 N SCOTTSDALE RD

PROJECT INFORMATION AND DATA

I - 1

8/4/16

ZONING: C-3 EXISTING PROPERTY LINE -ZONING: C-3 APN: 131-16-141C EXISTING PROPERTY LINE SCOTTSDALE RD. EXISTING MONOPALM, SEE -SHEET A-3 EXISTING T-MOBILE LEASE -AREA, SEE SHEET A-2 ± 342'-8" TO PROPERTY LINE ż EXISTING BUILDING -EXISTING BUILDINGS -- EXISTING PROPERTY E. MCKELLIPS ST.

ZONING: CSS

ZONING: R3

STIPULATION SET **RETAIN FOR RECORDS APPROVED**

11-14-16

1 SITE PLAN



ZONING: R1-7

2625 S. PLAZA DR. #400, TEMPE, ARIZONA, 85282 PHONE: (480) 638-2600 FAX: (480) 638-2852

architecture / project management 10245 E. Via Linda, Scottsdale, AZ 85258 ph: 480 451 9609 fax: 480 451 9608



	PRELIM	NARY UNLESS SIGNED
NO.	DATE	DESCRIPTION
1	8/16/12	REVIEW
2	08/21/12	FINAL CD'S
3	1/25/13	RE-SUBMITTAL
4	11/6/13	RE-SUBMITTAL

YDC - 4004

- PROJECT INFORMATION -


PH10233D

MONARCH PROPERTY

409 N SCOTTSDALE RD SCOTTSDALE, ARIZONA

SITE PLAN

SHEET NUMBER A-1

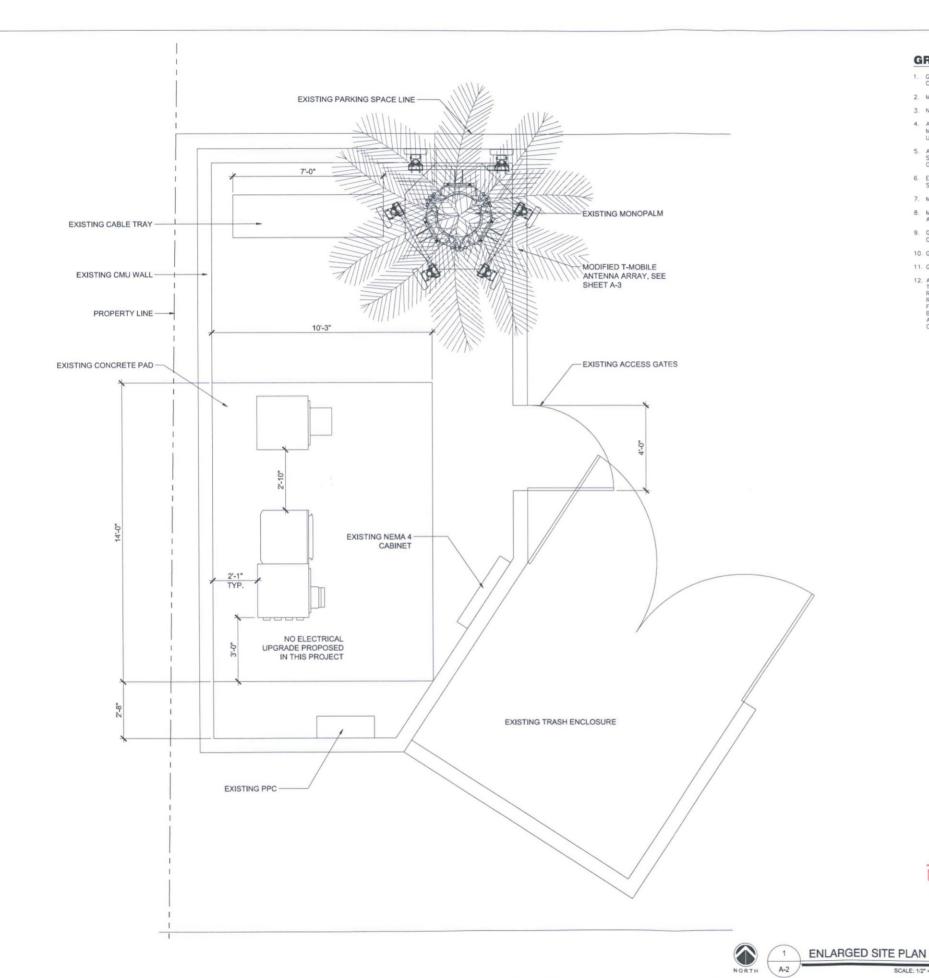

GROUNDING NOTES:

- GROUNDING SHALL COMPLY WITH LATEST EDITION OF THE NATIONAL ELECTRICAL CODE
- 2. MINIMUM BENDING RADIUS FOR GROUND CONDUCTOR IS 8".
- 3. NO SPLICES PERMITTED IN GROUND CONDUCTORS
- ALL GROUNDING CONNECTORS TO BE CLEAN AND FREE OF PAINT AT THEIR MATING SURFACES AND INSTALLED PER MANUFACTURER'S RECOMMENDATIONS. USE PENETROX OR EQUIVALENT ANTIOXIDANT GREASE.
- ALL GROUND BAR CONNECTIONS ARE TO BE 2 HOLE LUG COMPRESSION TYPE. STACKED CONNECTIONS ARE NOT ACCEPTABLE. BACK TO BACK CONNECTIONS ON OPPOSITE SIDES OF THE GROUND BAR WILL BE PERMITTED.
- ENSURE ALL MECHANICAL CONNECTORS ARE TORQUED TO THE MANUFACTURER'S SPECIFIED VALUES.
- 7. MULTIPLE BONDS ON GROUND RODS TO BE SEPARATED BY ATLEAST 6".
- MAXIMUM RESISTANCE OF THE COMPLETED GROUND SYSTEM SHALL NOT EXCEED A RESISTANCE OF 5 OHMS TO EARTH.
- GROUND WIRES SHALL NOT BE INSTALLED THROUGH HOLES IN ANY METAL OBJECTS OR SUPPORTS: TO PRECLUDE ESTABLISHING A "CHOKE" POINT.
- 10. GROUND BARS SHALL NOT BE FIELD MODIFIED.
- 11. GROUND RING BURIAL DEPTH SHALL BE 30".
- 12. A CERTIFIED CONTRACTOR WILL MAKE ALL MEASUREMENTS REQUIRED TO TEST THE GROUNDING SYSTEM USING A MEGGER OR EQUIVALENT. THE ACCEPTABLE RESISTANCE MEASURED FOR THE GROUNDING SYSTEM WILL NOT EXCEED 5 OMMS RESISTANCE. THREE DISTANCES SHALL BE USED: 1 AT 100 FEET, 1 AT 70 FEET, AND 1 AT 35 FEET. THESE DISTANCES ARE SUBJECT TO A SITE BY SITE BASIS. T—MOBILE—WITS SHALL BE GIVEN 24 HOURS NOTICE. ALL COSTS ASSOCIATED WITH GROUND TESTING WILL BE AT THE EXPENSE OF THE CONTRACTOR.

GROUNDING NOTE:

GROUND HYBRID CABLE TOP & BOTTOM USING UNIVERSAL 1-5/8" GROUNDING STRAP, PART #252172

STIPULATION SET **RETAIN FOR RECORDS APPROVED**



SCALE: 1/2" = 1'-0"

INITIALS

SCALE: 1/2" = 1'-0'

2625 S. PLAZA DR. #400, TEMPE, ARIZONA, 85282 PHONE: (480) 638-2600 FAX: (480) 638-2852



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4	11/6/13	RE-SUBMITTAL

-ARCHITECTS JOB NO. -YDC - 4004


PH10233D

MONARCH PROPERTY

409 N SCOTTSDALE RD SCOTTSDALE, ARIZONA

ENLARGED SITE PLAN

SHEET NUMBER

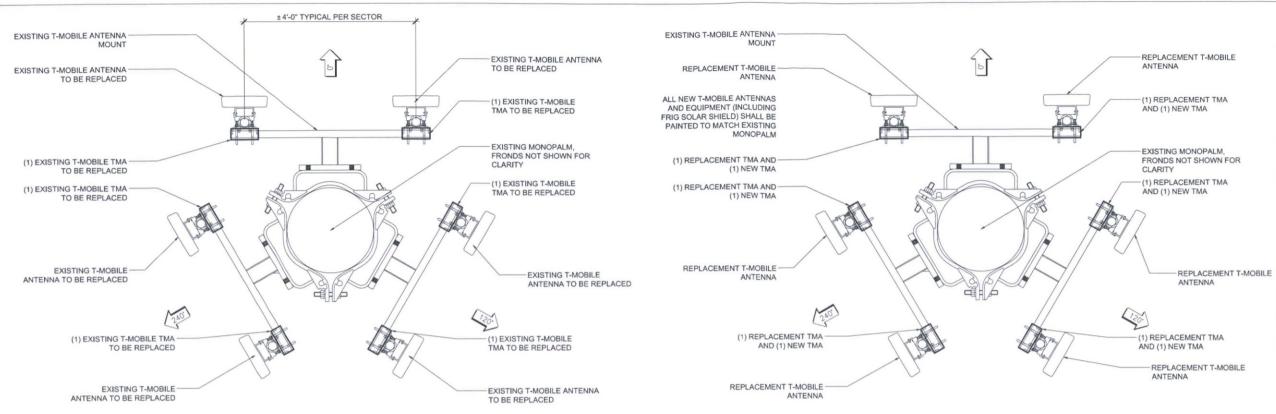





SIDE B NEW / EXISTING ANTENNA

EXISTING ANTENNA LAYOUT

STIPULATION SET RETAIN FOR RECORDS **APPROVED**

INITIALS

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08/21/12 1/25/13 11/6/13

ANTENNA INFORMATION

HISTORY

CASE

A-3

DESIGN REVIEW 103-DR-2005

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24-UP-2005#2

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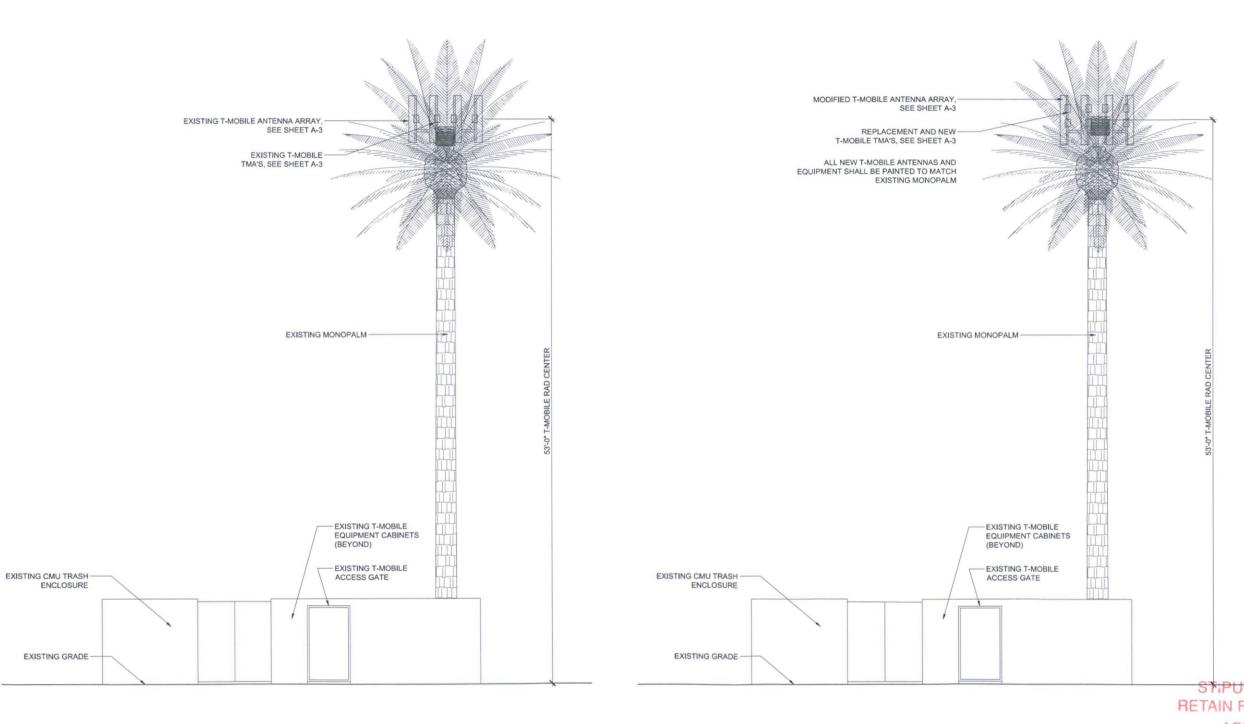
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PERMIT:

USE

HISTORY CONDITIONAL

CASE



EXISTING SOUTH ELEVATION

SCALE: 1/4" = 1'-0"

SCALE: 1/4" = 1'-0"

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architecture / project management 10245 E. Via Linda, Scottsdale, AZ 85258 ph: 480 451 9609 fax: 480 451 9608



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PH10233D

MONARCH PROPERTY

409 N SCOTTSDALE RD SCOTTSDALE, ARIZONA

ELEVATIONS

STIPULATION SET RETAIN FOR RECORDS APPROVED

11-14-16

SCALE: 1/4" = 1'-0"

NEW SOUTH ELEVATION

INITIALS

- SHEET NUMBER