Full Size or Largest Size (site plan, landscape, elevations)





# SITE PHOTO

ZONING - POLE:

JURISDICTION:

BUILDING CODES:

ZONING - EQUIPMENT

APN - EQUIPOMENT:

APN - POLE:

- T-1 PROJECT INFORMATION AND DATA
- T-2 GENERAL INFORMATION
   LS-1 SURVEY
- Z-1 SITE PLAN

SHEET INDEX

- Z-2 ENLARGED SITE PLAN
- Z-3 EXISTING EAST ELEVATION
   Z-4 PROPOSED EAST ELEVATION
- Z-5 EXISTING SOUTH ELEVATION
- Z-6 PROPOSED SOUTH ELEVATION
- Z-7 SITE DETAILS
- S-1 CABLE SHROUD DETAILS

### PROJECT DATA

VERIZON WIRELESS 126 W. GEMINI DR. TEMPE, ARIZONA, 85283 CONTACT: TERRY SKULA

PROPERTY OWNER - POLE

PHONE: T.B.D.

CITY OF SCOTTSDALE
7447 E. INDIAN SCHOOL RD
SCOTTSDALE, AZ, 85251
CONTACT: TBD
PHONE: (480) 312-7250

## PROPERTY OWNER - EQUIPMENT

MSR PROPERTIES LLC 15035 N 73RD ST, STE 102 SCOTTSDALE, AZ, 85260 CONTACT: TBD PHONE: TBD

# SITE ACQUISITION

SMARTLINK, I, I. C. 605 W. KNOX ROAD, STE 210 TEMPE, AZ, 8\$284 CONTACT: MARCK SAWYER PHONE: (480) 550-2088

# ARCHITECT

YOUNG DESIGN CORP.

10245 E. VIA LINDA, SUITE 211
SCOTTSDALE, ARIZONA, 85258
CONTACT: MATT YOUNG
PHONE: (480) 451-9609
FAX: (480) 451-9609

# SURVEYOR

RLF CONSULTING 1214 N. STADEM DR. TEMPE, AZ, \$5281 CONTACT: RYAN FIDLER PHONE: (480) 445-9189

# PROJECT DESCRIPTION

VERIZON WIRELESS

CITY OF SCOTTSDALE

51-DR-2016

10/12/16

TEMPE, ARIZONA, 85283

126 W. GEMINI DR.

C-3

C-3

N/A (R.O.W.)

130-11-1744

2012 I.B.C.

2011 N.E.C

2012 I.M.C.


THE PROJECT CONSISTS OF THE INSTALLATION OF (2) ANTENNAS ON A REPLACEMENT CITY OF SCOTTSDALE STREET LIGHT POLE AND THE INSTALLATION OF AN ADJACENT GROUND MOUNTED SQUIPMENT CABINET ON THE ADJACENT PARCEL, FACILITY IS UNMANNED AND NOT FOR HUMAN HABITATION.

# SITE COORDINATES

LATITUDE: 33° 29' 35.506" N LONGITUDE: 111" 56' 04.412" GROUND ELEVATION: 1266.5' A.M.S.L.

### SITE DIRECTIONS

FROM VERIZON OFFICE IN TEMPE. ARIZONA: HEAD WEST ON W. GEMINI DR TOWARD S. ASH AVE. TURN LIEFT ONTO S. ASH AVE. TURN RIGHT ONTO W. GALDALUPE RD. TURN RIGHT THE 1ST CROSS STREET ONTO S. KYRENE RD. TURN RIGHT TO MERGE ONTO I-10 W TOWARD PHOENIX, US-80 W. TAKE EXIT 153A FOR AZ-143 N TOWARD SKY HARBOR. CONTINUE ONTO AZ-143 N HOHOCAM EXPY. TURN RIGHT ONTO E. MODOWEL RD. TURN LEFT ONTO N. 84TH ST. TURN RIGHT ONTO E. THOMAS RD. TURN LEFT ONTO N. 85TH ST. THE VERIZON LIGHT POLE IS ON THE EAST SIDE OF N. 85TH ST. JUST AFTER THE FIRST DRIVEWAY TO THE VALLETHO HOTEL.

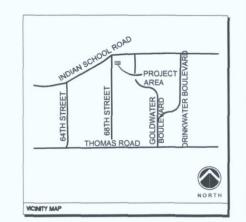



CONSTRUCTION SIGNATURE

RF SIGNATURE

FACILITIES SIGNATURE

REAL ESTATE SIGNATURE



architecture / project management 10245 E. Via Linda, Scottsdale, AZ 85258 ph: 480 451 9609 fax: 480 451 9608 e mail: corporate@ydcoffice.com

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PRELIMINARY UNLESS SIGNED

NO.	DATE	DESCRIPTION
0	8/24/2016	PRELIM REVIEW
	-	

PROJECT INFORMATION -

PHO\_ZUZU-VALLEYHO\_SC

6850 E. MAIN STREET SCOTTSDALE, AZ 85251

TITLE SHEET

JURISDICTION APPROVAL -

T-1

STIPULATION SET RETAIN FOR RECORDS APPROVED

12-15-16

INITIALS

#### **GENERAL NOTES:**

DRAWINGS ARE NOT TO BE SCALED, WRITTEN DIMENSIONS TAKE PRECEDENCE. THIS SET OF DOCUMENTS IS INTENDED TO BE USED FOR DIAGRAMMATIC PURPOSES ONLY, UNLESS NOTED OTHERWISE. THE GENERAL CONTRACTOR'S SCOPE OF WORK SHALL INCLUDE FURNISHING ALL MATERIALS, EQUIPMENT, LABOR, AND ANY REQUIREMENTS DEEMED NECESSARY TO COMPLETE

PRIOR TO THE SUBMISSION OF BIDS, CONTRACTORS INVOLVED SHALL VISIT THE JOB SITE TO FAMILIARIZE THEMSELVES WITH ALL CONDITIONS AFFECTING. THE NEW PROJECT: CONTRACTORS VERBY FILE DE CONDITIONS AND CONFIRM THAT THE PROJECT WILL BE ACCOMPLISHED AS SHOWN. PRIOR TO PROCEEDING WITH CONSTRUCTION. ANY ERRORS, OMISSIONS, OR DISCREPANCIES SHALL BE BROUGHT TO THE ATTENTION OF THE ARCHITECT/ENGINEER VERBALLY AND IN

THE ARCHITECTS/ENGINEERS HAVE MADE EVERY EFFORT TO SET FORTH IN THE CONSTRUCTION AND CONTRACT DOCUMENTS THE COMMETTE SCOPE OF WORK. CONTRACTORS BIDDING THE JOI ARE NEVERTHELESS CAUTIONED THAT MINOR OMISSIONS OR ERRORS IN THE DRAWINGS AND OF SPECIFICATIONS SHALL NOT EXCUSE SAID CONTRACTOR FROM COMMETTE HIND THE PROJECT AND IMPROVEMENTS IN ACCORDANCE WITH THE INTERT OF THESE DOCUMENTS. THE BIDDER SHALL CONFILICITS ERRORS. OR OMISSIONS PRIOR TO SUBMISSION OF CONTRACTORS PROPOSAL. IN THE EVENT OF DISCREPANCIES THE CONTRACTOR SHALL PRICE THE MORE COSTLY OR EXTENSIVE WORK. UNLESS DIRECTED OTHERWISE.

THE CONTRACTOR SHALL SUPERVISE AND DIRECT THE PROJECT DESCRIBED IN THE CONT DOCUMENTS. THE CONTRACTOR SHALL BE SOLELY RESPONSIBLE FOR ALL CONSTRUCTION MEANS, METHODS. TECHNIQUES, SEQUENCES, AND PROCEDURES FOR COORDINATING ALL

THE CONTRACTOR SHALL INSTALL ALL EQUIPMENT AND MATERIALS ACCORDING TO MANUFACTURERS/VENDOR'S SPECIFICATIONS UNLESS NOTED OTHERWISE OR WHERE LOCAL CODES OR ORDINANCES TAKE PRECEDENCE.

ALL WORK PERFORMED ON THE PROJECT AND MATERIALS INSTALLED SHALL BE IN STRICT ACCORDANCE WITH ALL APPLICABLE CODES, REGULATIONS, AND ORDINANCES, CONTRACTOR SHALL GIVE ALL NOTICES AND COMPLY WITH ALL LAWS, ORDINANCES, RULES, REGULATIONS AND AND LOCAL, AND STATE, JURISDICTIONA, CODES BEARING ON THE PERFORMANCE OF THE WORK.

GENERAL CONTRACTOR SHALL PROVIDE, AT THE PROJECT SITE, A FULL SET OF CONSTRUCTION DOCUMENTS UPDATED WITH THE LATEST REVISIONS AND ADDENDA OR CLARIFICATIONS FOR USE BY ALL PERSONNEL INVOLVED WITH THE PROJECT. THIS SET IS A VALID CONTRACT DOCUMENT ONLY IF THE TITLE SHEET IS STAMPED "FOR CONSTRUCTION" AND EACH SUCCESSIVE SHEET BEARS THE ARCHITECTS SIGNED WET STAMP.

THE STRUCTURAL COMPONENTS OF ADJACENT CONSTRUCTION OR FACILITIES ARE NOT TO BE ALTERED BY THIS CONSTRUCTION PROJECT UNLESS NOTED OTHERWISE.

SEAL ALL PENETRATIONS THROUGH FIRE-RATED AREAS WITH U.L. LISTED OR FIRE MARSHALL APPROVED MATERIALS IF APPLICABLE TO THIS FACILITY AND OR PROJECT SITE.

CONTRACTOR TO PROVIDE A PORTABLE FIRE EXTINGUISHER WITH A RATING OF NOT LESS THAN 2-A OR 2-410BC WITHIN 75 FEET TRAVEL DISTANCE TO ALL PORTIONS OF PROJECT AREA DURING CONSTRUCTION.

CONTRACTOR SHALL MAKE NECESSARY PROVISIONS TO PROTECT EXISTING IMPROVEMENTS, EASEMENTS, PAVING, CURRING, ETC. DURING CONSTRUCTION. UPON COMPLETION OF WORK, CONTRACTOR SHALL REPAIR ANY DAMAGE THAT MAY HAVE OCCURRED DUE TO CONSTRUCTION ON OR ABOUT THE PROPERTY.

CONTRACTOR SHALL KEEP GENERAL WORK AREA CLEAN AND HAZARD FREE DURING CONSTRUCTION AND DISPOSE OF ALL DRITT DEBRIS. AND RUBBISH. CONTRACTOR SHALL REMOVE EQUIPMENT NOT SPECIFIED AS REMAINING ON THE PROPERTY OR PREMISES. SITE SHALL BE LEFT IN CLEAN CONDITION AND PREE FROM PAINT SPOTS, DUST, OR SMUDGES OF ANY NATURE.

THE GENERAL CONTRACTOR SHALL RECEIVE WRITTEN AUTHORIZATION TO PROCEED WITH CONSTRUCTION PRIOR TO STARTING WORK ON ANY ITEM NOT CLEARLY DEFINED BY THE CONSTRUCTION DRAWINGS/CONTRACT DOCUMENTS.

THE CONTRACTOR SHALL PERFORM WORK DURING OWNER'S PREFERRED HOURS TO AVOID DISTURBING NORMAL BUSINESS.

THE CONTRACTOR SHALL PROVIDE COMPANY WITH. PROPER INSURANCE CERTIFICATES NAMING (COMPANY). AS ADDITIONAL INSURED, AND (COMPANY) PROOF OF LICENSE(S) AND PE & PD INSURANCE.

CONTRACTOR SHALL BE RESPONSIBLE FOR SCHEDULING AND COORDINATING ALL INSPECTIONS.
CAUTION: CALL BEFORE YOU DIG! BURIED UTILITIES EXIST IN THE AREA AND UTILITY INFORMATION SHOWN MAY NOT BE COMPLETE. CONTACT THE ONE-CALL UTILITY LOCATE SERVICE A MINIMUM OF 40 HOURS PRIOR TO CONSTRUCTION. 1-960-382-2944.

CONTRACTOR TO DOCUMENT ALL WORK PERFORMED WITH PHOTOGRAPHS AND SUBMIT TO (COMPANY) ALONG WITH REDLINED CONSTRUCTION SET.

CONTRACTOR TO DOCUMENT ALL CHANGES MADE IN THE FIELD BY MARKING UP (REDLINING) THE APPROVED CONSTRUCTION SET AND SUBMITTING THE REDLINED SET TO (COMPANY) REPRESENTATIVE UPON COMPLETION.

FOR COLLOCATION SITES: CONTACT TOWER OWNER REPRESENTATIVE FOR PARTICIPATION IN BID WALK.

GENERAL CONTRACTOR IS TO COORDINATE ALL POWER INSTALLATION WITH POWER COMPANY AS REQUIRED. CONTRACTOR TO REPORT POWER INSTALLATION COORDINATION SCULUTION(S) TO NETWORK CARRIER REPRESENTATIVE, PROJECT CONSTRUCTION MANAGER AND ARCHITECT. ANY SUBSTITUTIONS OF MATERIALS AND/OR EQUIPMENT, MUST BE APPROVED BY (COMPANY) CONSTRUCTION MANAGER.

IN THE CASE OF ROOFTOP SQLUTIONS FOR EQUIPMENT AND/OR ANTENNA FRAMES WHERE PENETRATION OF EXISTING ROOFNO MATERIALS OCCUR, THE GENERAL CONTRACTOR SHALL COORDINATE WITH BUILDING OWNER AND BUILDING ROOFING GONTRACTOR OF RECORD FOR INSTALLATION, PATCH, REPAIR OR ANY AUGMENTATION OT THE ROOF, AND HAVE THE WORK GUARANTEED UNDER THE ROOFING CONTRACTOR'S WARRANTY FOR MOISTURE PENETRATION OR AND OTHER FUTURE BREACH OF ROOFING INTEGRITY.

CONTRACTOR SHALL SUPERVISE AND DIRECT ALL WORK, AND PROVIDE CONTINUOUS SUPERVISION WHILE ANY SUBCONTRACTORS OR WORKMEN ARE ON THE JOB SITE.

CONTRACTOR SHALL BE SOLELY RESPONSIBLE FOR ALL CONSTRUCTION MEANS, METHODS, TECHNIQUES, SEQUENCES, AND PROCEDURES OF THE WORK UNDER THE CONTRACT.

CONTRACTOR SHALL PROTECT ALL EXISTING IMPROVEMENTS AND FINISHES THAT ARE TO REMAIN, CONTRACTOR SHALL REPAIR ANY DAMAGE THAT MAY OCCUR DURING CONSTRUCTION TO SATISFACTION OF VERIZON WIRELESS WIRELESS REPRESENTATIVE.

CONTRACTOR SHALL KEEP THE CONSTRUCTION SITE CLEAN, HAZARD FREE AND DISPOSE OF ALL DIFF. DEERIS DURING COMBITACITION, LEAVE PREMISES IN A VACIJUM AND BROWN LEAV CONDITION, FREE FROM PAINT SPOTS, DUST, SMUDGES OF ANY NATURE AND IN WORKING ORDER UNTIL ACCEPTANCE BY VERICON WIRELESS AND PROPERTY OWNER.

IN THE CASE OF ROOFTOP SOLUTIONS WITH THE INSTALLATION OF ANTENNAS WITHIN CONCEALED (HIROUDED) SUPPORT FRAMES OR TRIPODS. THE GENERAL CONTRACTOR SHALL IS CONCEALED (HIROUDED) SUPPORT FRAMES OR TRIPODS. THE GENERAL CONTRACTOR SHALL IS SMULATING (IN APPERANCE) DESIGNATE DUSTRING OF THE THAT THE FINAL FROM SHILDING PRADE ME HE FRALS. SMULATING (IN APPERANCE) DESIGNATED DESIGNATED OR SHILDING FRAMES HE FRALS. COUNTRESSUM FASTENERS IN ALL FRP CONSTRUCTION. WHEN PHOTOSIMULATIONS ARE PROVIDED TO SHALL ENSURE THAT FINAL CONSTRUCTION REPRESENTS WHAT IS INDICATED IN PHOTOSIMULATION. SHOP DRAWINGS SHALL BE PROVIDED TO THE GENERAL CONTRACTOR CONSTRUCTION COORDINATION, AND

IN THE CASE OF ROOFTOP SOLUTIONS FOR EQUIPMENT AND/OR ANTENNA FRAMES WHERE ANCHORING TO A CONCRETE ROOF SLAB IS REQUIRED, CONTRACTORS SHALL CONFIRM (PRIOR TO SUBMITTING BID) WITH CONSULTING CONSTRUCTION COORDINATOR AND ARCHITECT THE PRESENCE OF POST TENSION TENDONS WITHIN THE ROOF SLAB - RESULTING FROM AN UNDOCUMENTED DESIGN CHANGE IN THE EXISTING BUILDING "AS-BUILT DRAWNING SET - HAVING INDICATED NO RIGIGAL DESIGN SOLUTION OF REINFORCED CONCRETE WE DISECUSED STEEL DEPROVISIONS FOR X-RAY PROCEDURES (INCLUDED IN BID) FOR ALL PENETRATION AREAS WHERE ANCHORING OCCURS.

GENERAL & SUB CONTRACTORS SHALL USE STAINLESS STEEL METAL LOCKING TIES FOR ALL CABLE TRAY TIE DOWNS AND ALL OTHER GENERAL TIE DOWNS (WHERE APPLICABLE), PLASTIC ZIP TIES SHALL NOT BE PERMITTED FOR USE ON VERIZON WIRELESS WHELESS PROJECTS. THE SHALL NOT BE PERMITTED FOR USE ON VERIZON WIRELESS WHELESS PROJECTS. ON MICHAEL OF WHICH CAPPED HEALL LOCKING TIES MODEL NO. MICHAEL SHALL BE PANDUIT OF OPP. METAL LOCKING TIES MODEL NO. MICHAEL SHALL S

THE GENERAL CONTRACTOR IS RESPONSIBLE FOR RED-LINING THE CONSTRUCTION PLANS TO ILLUSTRATE THE AS-BUILT CONDITION OF THE SITE. FOLLOWING THE FINAL INSPECTION BY VERIZON WIRELESS WIRELESS, THE CONTRACTOR SHALL PROVIDE VERIZON WIRELESS WIRELESS WITHOUT OF 10 COPY OF ALL RED-LINED DRAWINGS. NOTE ALL OF THE FOLLOWING:
MODIFICATIONS OF ANY SCHEDULE

SUBSTITUTIONS AND/OR MODEL NUMBERS OF EQUIPMENT

VERIFY ALL FINAL EQUIPMENT WITH VERIZON WIRELESS WIRELESS REPRESENTATIVE ALL TELEPHONE:RADIO EQUIPMENT LAYOUT, SPECIFICATIONS, PERFORMANCE INSTALLATION AND THEIR FINAL LOCATION ARE TO BE APPROVED BY VERIZON WIRELESS WIRELESS. THE CONTRACTOR SHALL BE RESPONSIBLE FOR COORDINATING HIS WORK WITH THE WORK AND CLEARANCES REQUIRED BY OTHERS RELATED TO SAID INSTALLATIONS.

## STANDARD CIVIL NOTES:

ALL SITE WORK SHALL BE AS INDICATED ON THE DRAWINGS AND STIPULATED IN THE SPECIFICATIONS PROJECT SUMMARY.

RUBBISH, STUMPS, DEBRIS, STICKS, STONES AND OTHER REFUSE SHALL BE REMOVED FROM THE SITE AND DISPOSED OF LEGALLY.

NO FILL OR EMBANKMENT MATERIAL SHALL BE PLACED ON FROZEN GROUND, FROZEN MATERIALS, SNOW OR ICE SHALL NOT BE PLACED IN ANY FILL OR EMBANKMENT.

THE SUB GRADE SHALL BE COMPACTED AND BROUGHT TO A SMOOTH HINLEDDIN GRADE DRICK!

THE SUB GRADE SHALL BE COMPACTED AND BROUGHT TO A SMOOTH UNIFORM GRADE PRIOR TO THE CRUSHED STONE APPLICATION.
ALL EXISTING ACTIVE SEMER WATER GAS ELECTRIC AND OTHER LITLIFIES WHERE

ALL EXISTING ACTIVE SEWER, WATER, GAS, ELECTRIC, AND OTHER UTILITIES WHERE ENCOUNTERED IN THE WORK, SHALL BE PROTECTED AT ALL TIMES, AND WHERE RECURRED FOR THE PROPER EXECUTION OF THE WORK, SHALL BE RELOCATED AS DIRECTED BY ENGINEERS. EXTREME CAUTION SHOULD BE USED BY THE CONTRACTOR WHEN EXCAVATING OF THE DRILLING AROUND OR NEAR UTILITIES. CONTRACTOR SHALL PROVIDE SAFETY TRAINING FOR THE WORKING GREW.

ALL EXISTING INACTIVE SEWER, WATER, OAS, ELECTRIC AND OTHER UTILITIES, WHICH INTERFERE WITH THE EXECUTION OF THE WORK, SHALL BE REMOVED AND SHALL BE CAPPED, PLUGGED OR OTHERWISE DISCONNECTED AT POINTS WHICH WILL NOT INTERFERE WITH THE EXECUTION OF THE WORK, SHALL BEATER OTHER WORK, SHALL BEATER OTHER WORK, SHALL BEATER OTHER PROVALO FOR THE ENGINEERS.

THE AREAS OF THE CUSTOMER'S PROPERTY DISTURBED BY THE WORK AND NOT COVERED BY THE BUILDING DRIVEWAY OR CRUSHED STONE, SHALL BE GRADED TO A UNIFORM SLOPE, FERTILIZED, SEEDED, AND COVERED WITH MULCH AS SPECIFIED IN THE SPECIFICATION LANDSCAPE WORK.

# **GENERAL CONCRETE NOTES:**

ALL CONCRETE CONSTRUCTION SHALL BE IN ACCORDANCE WITH ACI-318.

CONCRETE SHALL BE MIXED, PROPORTIONED, CONVEYED AND PLACED IN ACCORDANCE WITH CHAPTER 19 OF THE CURRENT BUILDING CODE. STRENGTHS AT 28 DAYS AND MIX CRITERIA SHALL BE AS FOLLOWS.

	PE OF CONSTRUCTION	28 DAY STRENGTHS (fc)	W/C	MINIMUM CEMENT CONTENT
A.	SLABS ON GRADE	V-7	RATIO	PER CUBIC YARD
	TOPPING SLABS CONCRETE PIERS	2,400 PSI	≤ .45	5 1/2 SACKS
В.	ALL STRUCTURAL CONCRETE EXCEPT WALLS	4,000 PSI	≤ .45	6 1/2 SACKS
C.	CONCRETE WALLS	4,000 PSI	≤ .45	6 1/2 SACKS
CE	MENT SHALL BE ASTM C150, PORT	LAND CEMENT TYPE II U.N.	Ο.	

THE GENERAL CONTRACTOR SHALL SUPERVISE AND BE RESPONSIBLE FOR THE METHODS AND PROCEDURES OF CONCRETE PLACEMENT.

ALL CONCRETE WITH SURFACES EXPOSED TO STANDING WATER SHALL BE AIR-ENTRAINED WITH AN AIR-ENTRAINING AGENT CONFORMING TO ASTIM CSG, C494, C618, C698 AND C1017. TOTAL AIR CONTENT SHALL BE IN ACCORDANCE WITH TABLE 1904.2.1 OF THE CURRENT BUILDING CODE.

RENPORCING STEEL SHALL CONFORM TO ASTM A915 (INCLUDING SUPPLEMENT S1), GRADE 60, 1940,000 PSI. EXCEPTIONIS: ANY BARS SPECIFICALLY SO NOTED ON THE DRAWINGS SHALL BE GRADE 64, 1949,000 PSI. GRADE 64, DENFORCING BARS INDICATED ON DRAWINGS TO BE WELDED

SHALL CONFORM TO ASIM A70B. REINFORCING COMPLYING WITH ASIM AB15(S1) MAY 9E WELDE ONLY IF MATERIAL PROPERTY REPORTS INDICATING COMPLYING WITH WELDING PROCEDURES SPECIFIED IN A W.S. D14 ARE SUBMITTED.

REINFORCING STEEL SHALL BE DETAILED (INCLUDING HOCKS AND BENDS) IN ACCORDANCE WITH ACT 315 AND 318. LAP ALL CONTINUOUS REINFORCEMENT AT LEAST 30 BAR DIAMETERS OR A MINIMUM OF 2°-2°. PROVIDE CORNER BARS AT ALL WALL AND FOOTING INTERSECTIONS. LAP CORNER BARS AT LEAST 30 BAR DIAMETERS OR A MINIMUM OF 2°-2°. TRANDE CORNER SHARS AT ALL WALL AND FOOTING INTERSECTIONS. LAP CORNER BARS AT LEAST 30 BAR DIAMETERS OR A MINIMUM OF 2°-2° LAP ADJACENT MATS OF WELDED WITE FABRIC A MINIMUM OF 8°-2°. STORE AS TO STORE SHARE AS THE WALL AS THE STORE AND ENDOS.

WELDED WIRE FABRIC SHALL CONFORM TO ASTM A-185.

SPIRAL REINFORCEMENT SHALL BE PLAIN WIRE CONFORMING TO ASTM A615, GRADE 60, fy=60,000 PSI.

NO BARS PARTIALLY EMBEDDED IN HARDENED CONCRETE SHALL BE FIELD BENT UNLESS SPECIFICALLY SO DETAILED OR APPROVED BY THE CONSULTANT.

CONCRETE PROTECTION (COVER) FOR REINFORCING STEEL SHALL BE AS FOLLOWS:

FOOTINGS AND OTHER UNFORMED SURFACES, EARTH FACE	3"
FORMED SURFACES EXPOSED TO EARTH OR WEATHER (#6 BARS OR LARGER)	2" 1 1/2"
SLABS AND WALLS (INTERIOR FACE) (#5 BARS OR SMALLER)	3/4"
BARS SHALL BE SUPPORTED ON CHAIRS OR DOBIE BRICKS.	3/4

ANCHOR BOLTS TO CONFORM TO ASTM A307.

NON-SHRINK GROUT SHALL BE FURNISHED BY AN APPROVED MANUFACTURER AND SHALL BE MIXED AND PLACED IN STRICT ACCORDANCE WITH THE MANUFACTURER'S PUBLISHED RECOMMENDATIONS. GROUT STRENGTH SHALL BE AT LEAST EQUAL TO THE MATERIAL ON WHICH IT IS PLACED (3,000 PSI MINIMUM).

ALL EXPANSION ANCHORS TO BE HILTI BRAND. ADHESIVE ANCHORS REQUIRE TESTING TO CONFIRM CAPACITY UNLESS WAIVED BY ENGINEER.

# STRUCTURAL STEEL NOTES:

SHOP DRAWINGS FOR STRUCTURAL STEEL SHALL BE SUBMITTED TO THE CONSULTANT FOR REVIEW PRIOR TO FABRICATION.

STRUCTURAL STEEL DESIGN, FABRICATION AND ERECTION (INCLUDING FIELD WELDING, HIGH STREMGITH FIELD BOLTING, EXPANSION BOLTS, AND THREADED EXPANSION ANCHORS) SHALL BE BASED ON THE ALS.C. "SPECIFICATION FOR THE DESIGN, FABRICATION, AND ERECTION OF STRUCTURAL STEEL FOR BUILDINGS" LATEST EDITION. SUPERVISION SHALL BE IN ACCORDANCE WITH CURRENT BUILDING CODE, BY A QUALIFIED TESTING AGENCY DESIGNATED BY THE CONSULTANT. THE CONSULTANT SHALL BE FURNISHED WITH A COPY OF ALL INSPECTION REPORTS AND TEST RESULTS.

STRUCTURAL STEEL SHALL CONFORM TO THE FOLLOWING REQUIREMENTS

TYPE OF MEMBER	
A. PLATES, SHAPES, ANGLES, AND RODS B. SPECIAL SHAPES AND PLATES C. PIPE COLUMNS D. STRUCTURAL TUBING	ASTM A36, Fy 36 KSI ASTM A572, Fy 50 KSI ASTM A53, Fy 35 KSI ASTM A500, Fy 46 KSI ASTM A307

ALL MATERIAL TO BE HOT DIPPED GALVANIZED AFTER FABRICATION PER A123/

ALL WILLING SHALL BE IN CONFORMANCE WITH ALLS.C. AND AWS STANDARDS AND SHALL BE PERFORMED BY W.A. B.C. CERTIFIED WELDERS USING ETO XX. ELECTRODES. ONLY PREQUALIFIED WELDS (AS DEFINED BY AWS) SHALL BE USED. WELDING OF GRADE OR BEINFORCING BARS (IF REQUIRED) SHALL BE PERFORMED USING LOW HYDROGEN ELECTRODES. WELDING OF GRADE OR REINFORCING BARS (IF REQUIRED) SHALL BE PERFORMED USING ETO XX. ELECTRODES. WELDING OF GRADE OF COLD BENDS IN REINFORCING SHALL BE PERFORMED USING ETO XX. ELECTRODES. WELDING WITHIN 4" OF COLD BENDS IN REINFORCING STEEL IS NOT PERMITTED. SEE REINFORCING NOTE FOR MATERIAL REQUIREMENTS OF WELDED BARS.

COLD-FORMED STEEL FRAMING MEMBERS SHALL BE OF THE SHAPE. SIZE, AND GAGE SHOWN ON THE PLANS. PROVIDE MINIMUM SECTION PROPERTIES INDICATED. ALL COLD-FORMED STEEL FRAMING SHALL CONFORM TO THE ALS.S. "SPECIFICATION FOR THE DESIGN OF COLD-FORMED STEEL STRUCTURAL MEMBERS."

BOLTED CONNECTIONS SHALL USE BEARING TYPE ASTM A325 BOLTS (3/4" DIA.) AND SHALL HAVE A MINIMUM OF TWO BOLTS UNLESS NOTED OTHERWISE.

NON-STRUCTURAL CONNECTIONS FOR STEEL GRATING MAY USE 5/8" DIA. ASTM A307 BOLTS UNLESS NOTED OTHERWISE.

ALL STEEL WORK SHALL BE PAINTED IN ACCORDANCE WITH THE DESIGN & CONSTRUCTION SPECIFICATION AND IN ACCORDANCE WITH ASTM A36 UNLESS NOTED OTHERWISE.

ILL WELDS TO BE 1/4" FILLET UNLESS NOTED OTHERWISE.

TOUCH UP ALL FIELD DRILLING AND WELDING WITH 2 COATS OF GALVACON (ZINC RICH PAINT) OR APPROVED EQUAL.

# MASONRY

WORK

PROVIDE EVERYTHING REQUIRED TO COMPLETE UNIT MASONRY AS SHOWN ON THE DRAWINGS AND SPECIFIED HEREIN.

PROVIDE EXPERIENCED, WELL-TRAINED WORKERS COMPETENT TO COMPLETE THE WORK AS SPECIFIED.

MATERIALS

MORTAR AS PER ASTM C270. TYPE S. ONE PART PORTLAND CEMENT. ONE-HALF PART LIME. NOT MORE THAN FOUR AND ONE-HALF PARTS SAND, MEASURED DAMP AND LOOSE. COMPRESSIVE STRENGTH OF 1800 PSI AT 28 DAYS.

MORTAR MATERIALS: PORTLAND CEMENT, TYPE I OR II. AGGREGATE, CLEAN, SHARP SAND. LIME, QUICK LIME ASTM C5. HYDRATED LIME, TYPE S. WATER, CLEAN AND POTABLE.

PROVIDE CONCRETE UNIT MASONRY WHERE SHOWN ON THE DRAWINGS AND SPECIFIED HEREIN AS MANUFACTURED BY:

CONCRETE UNIT MASONRY UNITS SHALL COMPLY WITH ASTM STANDARDS:

CONCRETE BRICKS, ASTM C55. HOLLOW LOAD-BEARING UNITS, ASTM 000. HOLLOW NON-LOAD-BEARING UNITS, ASTM C104.

GRADES AND TYPES: HOLLOW, LOAD-BEARING UNITS GRADE N, TYPE I, MEDIUM WEIGHT FOR EXTERIOR. HOLLOW, LOAD-BEARING UNITS GRADE S, TYPE II, LIGHTWEIGHT FOR INTERIOR.

GROUT SHALL BE TYPE II CEMENT CONFORMING TO ASTM C-150. AGGREGATE SHALL CONFORM TO ASTM C-144, SAND TO CONFORM TO ASTM C-404 AND LIME SHALL CONFORM TO ASTM C-207.

SEE CONCRETE SECTION THIS SPECIFICATION FOR THE REINFORCING STEEL MATERIAL REQUIREMENTS.

ACCESSORIES AND OTHER RELATED MATERIALS

PROVIDE ALL ACCESSORIES AND MATERIALS AS REQUIRED FOR COMPLETE, PROPER INSTALLATION.

UNIT MASONRY INSTALLATION AND MORTAR APPLICATION

COMPLETE THIS WORK IN A TIMELY FASHION, WITHOUT INTERFERING WITH, OR DELAYING THE WORK OF OTHER TRADES.

COMPLETE ALL WORK ACCORDING TO APPLICABLE CODES AND REGULATIONS.

COMPLETE ALL WORK ACCORDING TO THE STANDARDS AND SPECIFICATIONS OF THE MASONRY INSTITUTE OF AMERICA.

MASONRY ACCESSORIES AND REINFORCING - INSTALLATION

INSTALL METAL TIES FOR BONDING AS PER DETAILS AND REFERENCED TRADE STANDARDS ASSURE COMPLIANCE IN TYPES, SIZES, SPACING, DEPTH OF ANCHORING AND CORROSION RESISTANCE.

INSTALL REINFORCING AS PER DETAILS AND REFERENCED TRADE STANDARDS.

# **PAINTING**

- THE CONTRACTOR SHALL PREPARE SURFACES, FURNISH ALL PAINT, MATERIAL, LABOR AND EQUIPMENT REQUIRED FOR THE PAINTING OF ALL SURFACES AS REQUIRED BY THE DRAWINGS AND SPECIFIED HEREIN.
- PAINTS TO BE APPLIED IN ALL WORKMANLIKE MANNER. UPON COMPLETION, REMOVE ALL MATERIALS AND DEBRIS CAUSED BY THIS CONTRACTOR, ALL HARDWARE, FLOORS, GLASS FRAMES FIXTURES AND THE LIKE SHALL BE THOROLIGHTY OF BANKED OF BAILED.
- 3. REGULATORY REQUIREMENTS: ALL MATERIALS MUST COMPLY WITH AIR POLLUTION CONTROL REGULATIONS, SUCH AS L.A. COUNTY APCD RULE 1113 AND BAY AREA PCD REG. 3.
- MATERIAL SHALL BE AS INDICATED ON PAINT SCHEDULE BELOW AND DRAWINGS.
  ALL STEEL COLUMNS AND MISC. METALS SHALL BE PRIMED AND PAINTED.
- ALL STEEL COLUMNS AND MISC. METALS SHALL BE PRIMED AND PAINTED.
   FIRE PREVENTION: TAKE EVERY PRECAUTION AT THE END OF THE DAY TO REMOVE OILY RAGS AND COMBUSTIBLE MATERIALS FROM THE SITE OR STORE IN METAL CONTAINER WITH TIGHT COVERS.
- 7. EXTERIOR PAINT SYSTEMS (EPS):
- ALUMINUM OR GALVANIZED STEEL: (MDF) 1-2 MILS PER COAT FRAZEE PAINT COLOR PER PLAN IST COAT: 681 METAL PLAN 2ND COAT: 124 MIRROGLIDE S/G ACRYLIC SEMI-GLOSS 3RD COAT: 124 MIRROGLIDE S/G ACRYLIC SEMI-GLOSS.
- C. PLASTER, CONCRETE, MASONRY: (MDF) 1-2 MILS PER COAT FRAZEE PAINT COLOR TO MATCH EXISTING BUILDING 1ST COAT: 061 AQUA SEAL 2ND COAT: 124 MIRROGLIDE S/G 3RD COAT: SEMI-GLOSS - 124 MIRROGLIDE S/G
- 8. INTERIOR PAINT SYSTEMS (IPS):
- A. GYPSUM DRYWALL (NON-EPOXY): RADIO FACILITY (MDF) 1-2 MILS PER COAT FRAZEE PAINT -COLOR TO BE WHITE IST COAT: 061 AQUA SEAL 2ND COAT: 124 MIRROGLIDE SIG 3RD COAT: SEM-9L.05S - 124 MIRROGLIDE SIG
- B. TELEPHONE BACKBOARD: FRAZEE PAINT COLOR TO BE WHITE 1ST COAT: 867 FRAFLO VIC 2ND COAT: FLAT FIRE PAINT #505 BY FLANECRETE (AS SPECIFIED) 3RD COAT: 124 MIRROGILDE SIG AGRYLIC SEMI-GLOSS OVERCOAT: 124 MIRROGILDE SIG AGRYLIC SEMI-GLOSS (TINT TO MATCH
- C. PLASTER, CONCRETE, MASONRY: (MDF) 1-2 MILS PER COAT FRAZEE PAINT COLOR TO BE WHITE 1ST COAT: LATEX PRIME SEALER - 065 ACRY PRIME 2ND COAT: SEMI-GLOSS - 124 MIRROGLIDE SIG 3RD COAT: SEMI-GLOSS - 124 MIRROGLIDE SIG

# SIGNS

- INSTALL EMERGENCY INFORMATION PLACARD NEAR ENTRANCE GATE OF EQUIPMENT AREA (OR MOST VISIBLE PLACE ON OUTSIDE COMPOUND WALL). PLACARD IS TO CONTAIN SITE NAME, SITE NUMBER, COMPANY NAME, ADDRESS INFORMATION, AND A "800" NUMBER TO DIAL IN CASE OF EMERGENCY. PLACARD IS TO CONSIST OF HIGH CONTRAST LETTERING (WHITE BACK GROUND WI RED LETTERING) BEHIND VANDAL RESISTANT LEXAN COVER.
- INSTALL ADDRESS PLACARD NEAR ENTRANCE GATE OF EQUIPMENT AREA (OR FACING STREET OF ASSOCIATED ADDRESS). PLACARD IS TO CONTAIN 12" TALL HIGH CONTRAST LETTERING (WHITE BACK GROUND AND RED LETTERS) BEHIND VANDAL RESISTANT LEXAN COVER.

# LEGEND

-	NEW ANTENNA		
£ 2.	EXISTING ANTENNA	D0000000000000000000000000000000000000	GROUT OR PLASTER
$\otimes$	GROUND ROD		(E) BRICK
-	GROUND BUS BAR		(E) MASONRY
•	MECHANICAL GRND. CONN.	[25] (S. 15)	CONCRETE
	CADWELD		
$\otimes$	GROUND ACCESS WELL		EARTH
Ε	ELECTRIC BOX	000000000000000000000000000000000000000	GRAVEL.
T	TO TOWN AND ADDRESS.		PLYW000
	TELEPHONE BOX		STUCCO
$\Rightarrow$	LIGHT POLE		WOOD CONT.
0	FNO, MONUMENT		WOOD BLOCKING
•	SPOT ELEVATION		STEEL
な	FRE HYDRANT		CENTERLINE
$\triangle$	REVISION		PROPERTY/LEASE LINE
(x)	GRID REFERENCE		LEASE LINE
			GROUND CONDUCTOR
X X X	DETAIL REFERENCE	— т——	TELEPHONE CONDUIT
		—— E——	ELECTRICAL CONDUIT
X-X	ELEVATION REFERENCE	A	COAXBAL CABLE
	SECTION REFERENCE	——T/E——	OVERHEAD SERVICE CONDUCTORS
4-1		x	CHAIN LINK FENCING



TEMPE, AZ 85283

INTERNAL REVIEW

CONSTRUCTION SIGNATURE

RF SIGNATURE

FACILITIES SIGNATURE

PLANS PREPARED BY

COPP

architecture / project management 10245 E. Via Linda, Scottsdale, AZ 85258 ph: 480 451 9609 fax: 480 451 9608

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NO.—DATE—DESCRIPTION—
0 8/24/2016 PRELIM REVIEW

YDC-6153

- PROJECT INFORMATION -

- ARCHITECTS JOB NO. -

PHO\_ZUZU-VALLEYHO\_SC

6850 E. MAIN STREET SCOTTSDALE, AZ 85251


-SHEET TITLE -

GENERAL INFORMATION

—JURISDICTION APPROVAL =

SHEET NUMBER

T-2

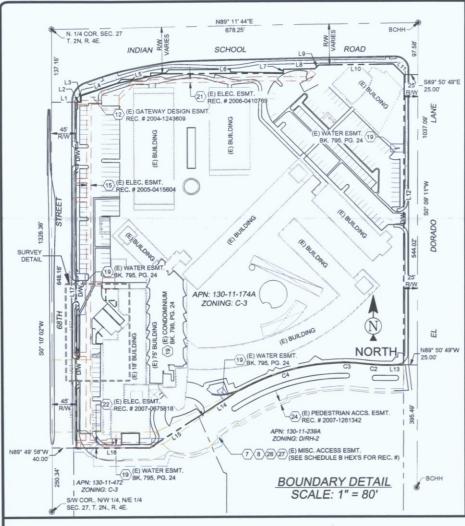

# PROJECT META DATA

- ROJECT META DATA 
  ELEVATIONS SHOWN HEREON ARE REPRESENTED IN NORTH

  AMERICAN VERTICAL DATUM OF 1988 (NAVD88) ESTABLISHED FROM

  GPS DERIVED ELLIPSOID HEIGHTS, APPLYING GEOID 09 SEPARATIONS

  CONSTRAINING TO NOS CORS STATIONS PROVIDED IN THE "ONLINE

  POSITIONING USER SERVICE" (OPUS) SOLUTION FOR THIS SPECIFIC
- 2. BEARINGS SHOWED HEREON ARE BASED UPON U.S. STATE PLANE NAD83 COORDINATE SYSTEM ARIZONA STATE PLANE COORDINATE ZONE CENTRAL, DETERMINED BY GPS OBSERVATIONS.
- 3. FIELD WORK FOR THIS PROJECT WAS PERFORMED ON 04/20/15.



GRADE = 1266.5' (0.0 A.G.L.)

#### SCHEDULE B EXCEPTIONS

- AN EASEMENT FOR DITCH AND ALL OTHER MATTERS AS SET FORTH THEREIN, RECORDED IN BOOK 109 OF DEEDS, PAGE 114 OF OFFICIAL RECORDS. (BLANKET IN NATURE)
- AN EASEMENT FOR TROLLEY ACCESS AND ALL OTHER MATTERS AS SET FORTH THEREIN, RECORDED IN 2004-1041584 OF OFFICIAL RECORDS. AN EASEMENT FOR EMERGENCY VEHICLE ACCESS AND ALL OTHER MATTERS AS SET FORTH THEREIN, RECORDED IN 2004-1041588 OF OFFICIAL RECORDS.
- ALL MATTERS AS SET FORTH IN HISTORIC PRESERVATION OF VALLEY HO PROPERTY DEVELOPMENT AGREEMENT RECORDED AS 2004-1082842.

  AMENDMENT RECORDED AS 2004-1258948 AND SECOND AMENDMENT RECORDED AS 2006-0034783 AND RE-RECORDED 2006-0108822 OF OFFICIAL RECORDS.
- ALL MATTERS AS SET FORTH IN EASEMENT AGREEMENT RECORDED AS 2004-1149906 AND RE-RECORDED AS2004-1173425 OF OFFICIAL RECORDS.
- AN EASEMENT FOR GATEWAY DESIGN FEATURE AND ALL OTHER MATTERS AS SET FORTH THEREIN, RECORDED IN 2004-1243609 OF OFFICIAL RECORDS.
- AN EASEMENT FOR ELECTRICAL LINES AND ALL OTHER MATTERS AS SET FORTH THEREIN, RECORDED IN 2005-0415604 OF OFFICIAL RECORDS.
- 19) A MAP PURPORTED TO SHOW SAID PROPERTY RECORDED AS BOOK 795 OF MAPS, PAGE 24 OF OFFICIAL RECORDS.
- AN EASEMENT FOR ELECTRICAL LINES AND ALL OTHER MATTERS AS SET FORTH THEREIN, RECORDED IN 2008- 0410769 OF OFFICIAL RECORDS.
- AN EASEMENT FOR ELECTRICAL LINES AND ALL OTHER MATTERS AS SET FORTH THEREIN, RECORDED IN 2007-0675818 OF OFFICIAL RECORDS. AN EASEMENT FOR PEDESTRIAN PUBLIC ACCESS AND ALL OTHER MATTERS AS SET FORTH THEREIN, RECORDED IN 2007-1261342 OF OFFICIAL RECORDS.
- 25. ANY ACTION THAT MAY BE TAKEN BY THE FLOOD CONTROL DISTRICT OF MARICOPA COUNTY TO ACQUIRE EASEMENTS, RIGHTS OF WAY, OR RESTRICTIVE RIGHTS FOR DRAINAGE AS DISCLOSED BY RESOLUTION RECORDED IN 2008-1029204 OF OFFICIAL RECORDS. (BLANKET IN
- 26 ALL MATTERS AS SET FORTH IN ACCESS EASEMENT AGREEMENT RECORDED IN 2009-1015046 AND RERECORDED IN 2010-0082546 OF OFFICIAL RECORDS.
- 27. AN EASEMENT FOR ACCESS EASEMENT AGREEMENT AND ALL OTHER MATTERS AS SET FORTH THEREIN, RECORDED IN 2009-1047056 OF OFFICIAL RECORDS.

# **LEGEND**

FACE OF CURB RIGHT OF WAY

	LINE T	ARIE	PV ASPHALT
	LINE I	ADEL	D/W ACCESS DRIVEWAY
INE	LENGTH	BEARING	SW SIDEWALK CMU CONCRETE MASONRY UNIT
			C CONCRETE MASONRY UNIT
L1	45.00	S89° 49' 58"E	1418.18 SPOT ELEVATION
L2	9.74	S89° 59' 14"E	WM WATER METER
13	12.00	N0° 18' 18"E	₩ WATER CONTROL VALVE
-		110 10 10 0	₩ FIRE HYDRANT
L4	70.00	N71° 05' 50"E	FOUND AS NOTED
L5	86.77	N78° 12' 29"E	
LO	00.77	N/0 12 29 E	
L6	224.00	S89° 57' 22"E	■ ELECTRICAL PULL BOX
			■ ELECTRICAL METER
L7	7.50	N0° 42' 05"W	AC AIR CONDITIONING UNIT
L8	59.00	N89° 17' 55"E	TELEPHONE VAULT
L9	9.90	N44° 17' 55"E	-√- BREAKLINE  ③ SAN. SEWER MANHOLE
			SAN. SEWER MANHOLE SIRRIGATION CONTROL VALVE
.10	137.13	N89° 17' 55"E	BOLLARD
.11	28.53	S45° 42' 05"E	POSITION OF GEODETIC COORDINATES
.12	544.02	S0° 09' 11"W	— — PROPERTY LINE — — PROPERTY LINE (OTHER)
			— — PROPERTY LINE (OTHER)
.13	33.29	N89° 50' 49"W	— — EASEMENT LINE
.14	93.03	S57° 09' 07"W	
.15	107.83	S57* 09' 07"W	WOOD OR IRON FENCE
.10	107.63	337 09 07 44	U/G TELECOMMUNICATION LINE
.16	141.91	N89° 48' 13"W	WATER LINE
.17	648.17	N0° 10' 02"E	


		(	CURVE TA	BLE	
CURVE	LENGTH	RADIUS	DELTA	CHORD BRG.	CHORD LENGTH
C2	42.35	306.57	7°54'54"	S85° 53' 22"E	42.32
C3	58.24	251.92	13°14'45"	N88° 41' 15'W	58.11
C4	178.00	405.02	25°10'50"	S73° 44' 38"W	176.57

LESSOR'S LEGAL DESCRIPTION

LOT 1A, OF HOTEL VALLEY HO LAND DIVISION, ACCORDING TO THE PLAT OF
RECORD IN THE OFFICE OF THE COUNTY RECORDER OF MARICOPA COUNTY,
ARIZONA, RECORDED BOOK 720 OF MAPS, PAGE 9;


EXCEPTING THEREFROM ANY PORTION LYING WITHIN "TOWER RESIDENCES AT HOTEL VALLEY HO, A CONDOMINIUM", ACCORDING TO BOOK 795 OF MAPS, PAGE 24, RECORDS OF MARICOPA COUNTY, ARIZONA.

- ALL TITLE INFORMATION IS BASED UPON A COMMITMENT FOR TITLE INSURANCE PREPARED BY GREAT AMERICAN TITLE AGENCY, ORDER NO.: 21501861 EFFECTIVE DATE: 04/17/15.
- SURVEYOR HAS NOT PERFORMED A SEARCH OF PUBLIC RECORDS TO DETERMINE ANY DEFECT IN TITLE.
- 3. THE BOUNDARY SHOWN HEREON IS PLOTTED FROM RECORD INFORMATION AND DOES NOT CONSTITUTE A BOUNDARY SURVEY OF THE PROPERTY.
- SURVEYOR DOES NOT GUARANTEE THAT ALL UTILITIES ARE SHOWN OR THEIR LOCATIONS: IT IS THE RESPONSIBILITY OF THE CONTRACTOR AND DEVELOPER TO CONTRACT BLUE STAKE AND ANY OTHER INVOLVED AGENCIES TO LOCATE ALL UTILITIES PRIOR TO CONSTRUCTION. REMOVAL, RELOCATION AND/OR REPLACEMENT IS THE RESPONSIBILITY OF THE CANTENDATOR.

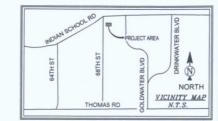





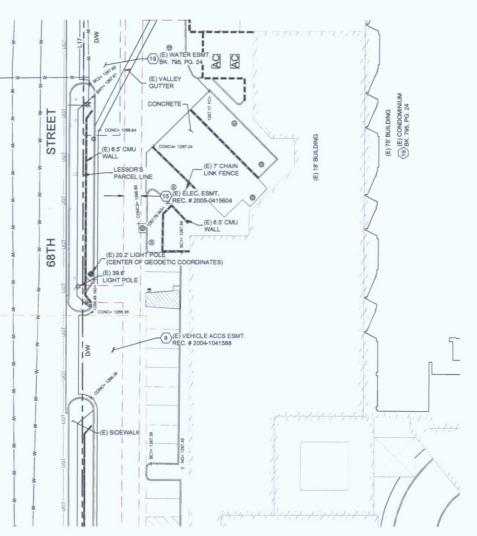





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ı	DRAWN BY:	ABM/JTJ	
ı	CHECKED BY:	ABM	

	F	REVISIONS	
-			
$\vdash$			
1	04/24/15	PRELIMINARY	
NO.	DATE	DESCRIPTION	



PROJECT No. 09006758 SITE NAME:

PHO\_ZUZU-VALLEYHO\_SC

SITE ADDRESS:


6850 E MAIN STREET SCOTTSDALE, AZ 85251


SHEET TITLE:

SITE SURVEY

SHEET NO REVISION: LS-1



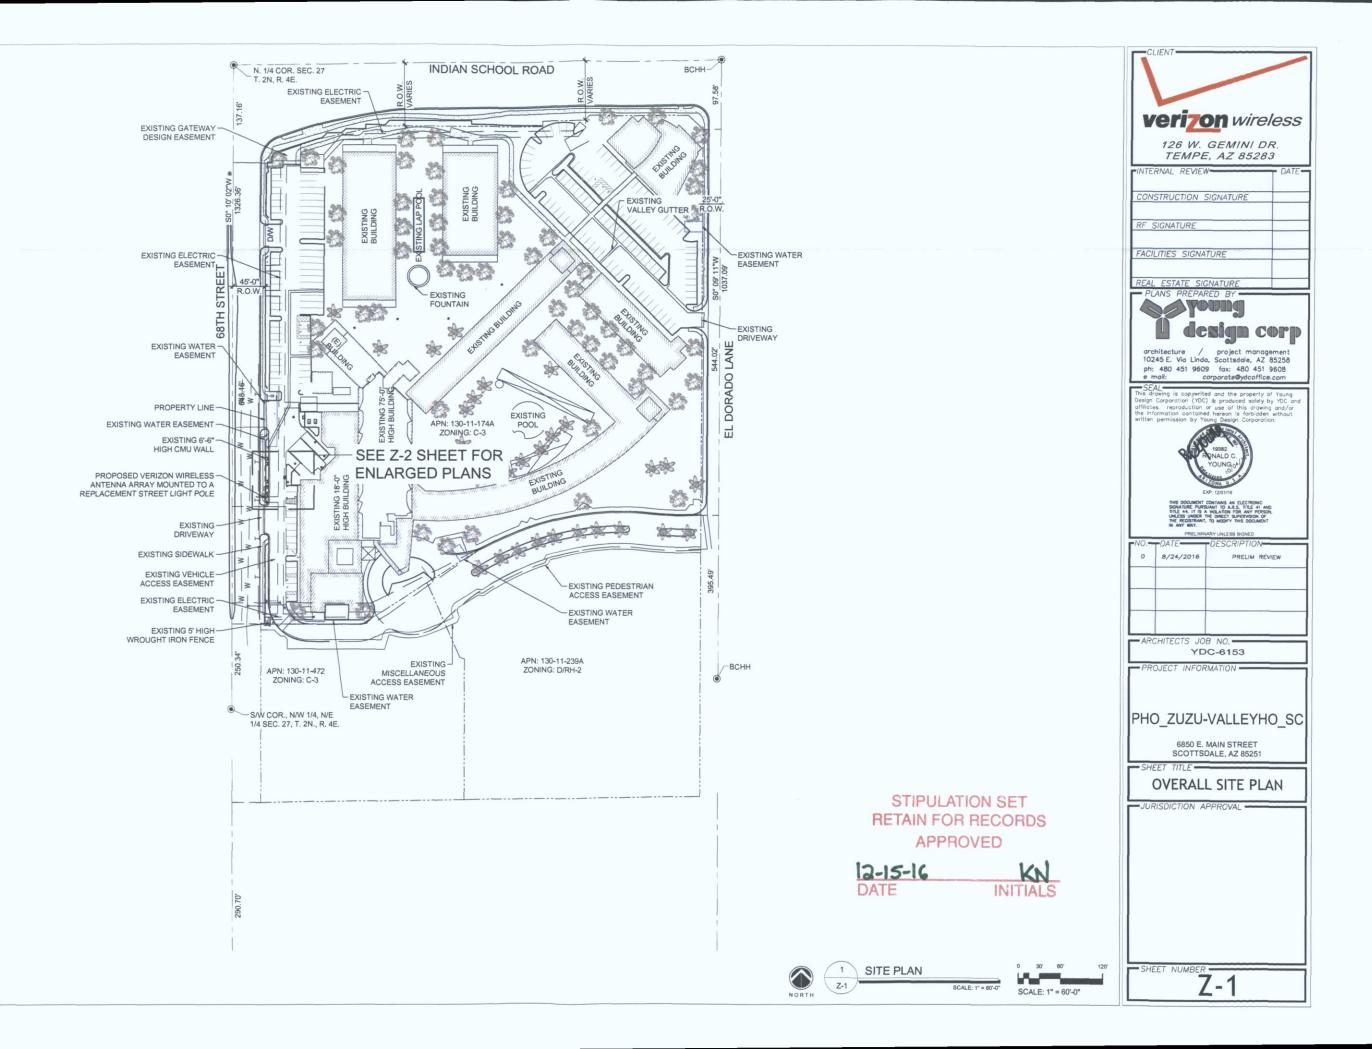

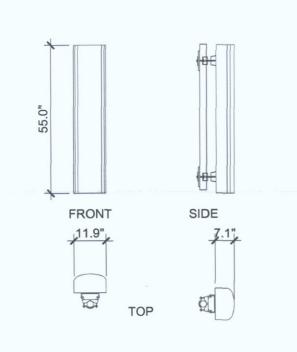


# ANTENNA DETAIL

COAXIAL CABLE TABLE					
SECTOR	AZIMUTH	LENGTH	QTY.	SIZE	TYPE
ALPHA	30°	± 42'-0"	4	1/2"	T.B.D.
BETA	170°	± 42'-0"	4	1/2"	T.B.D.


NOTE:
ALL AZIMUTHS SHOWN ARE RELATIVE TO TRUE NORTH, UNLESS NOTED OTHERWISE


"IT SHALL BE THE CONTRACTORS RESPONSIBILITY TO VERIFY AZIMUTHS DEPICTED HEREIN WITH RF DEPARTMENT PRIOR TO INSTALLING ANTENNAS.


# **COAX CABLE INFORMATION**

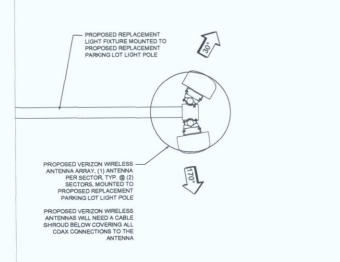


NEW ANTENNA CONFIG.

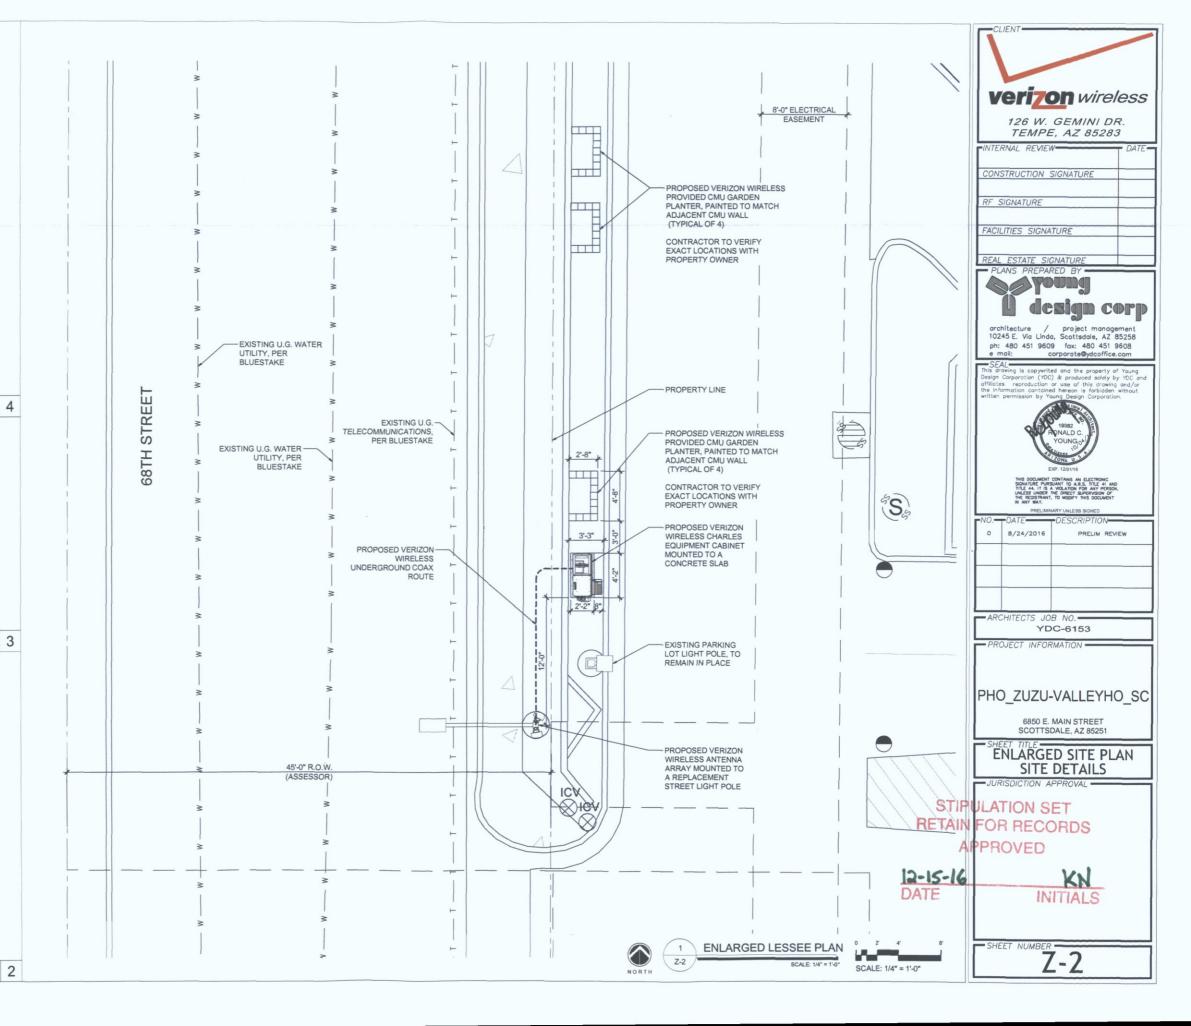

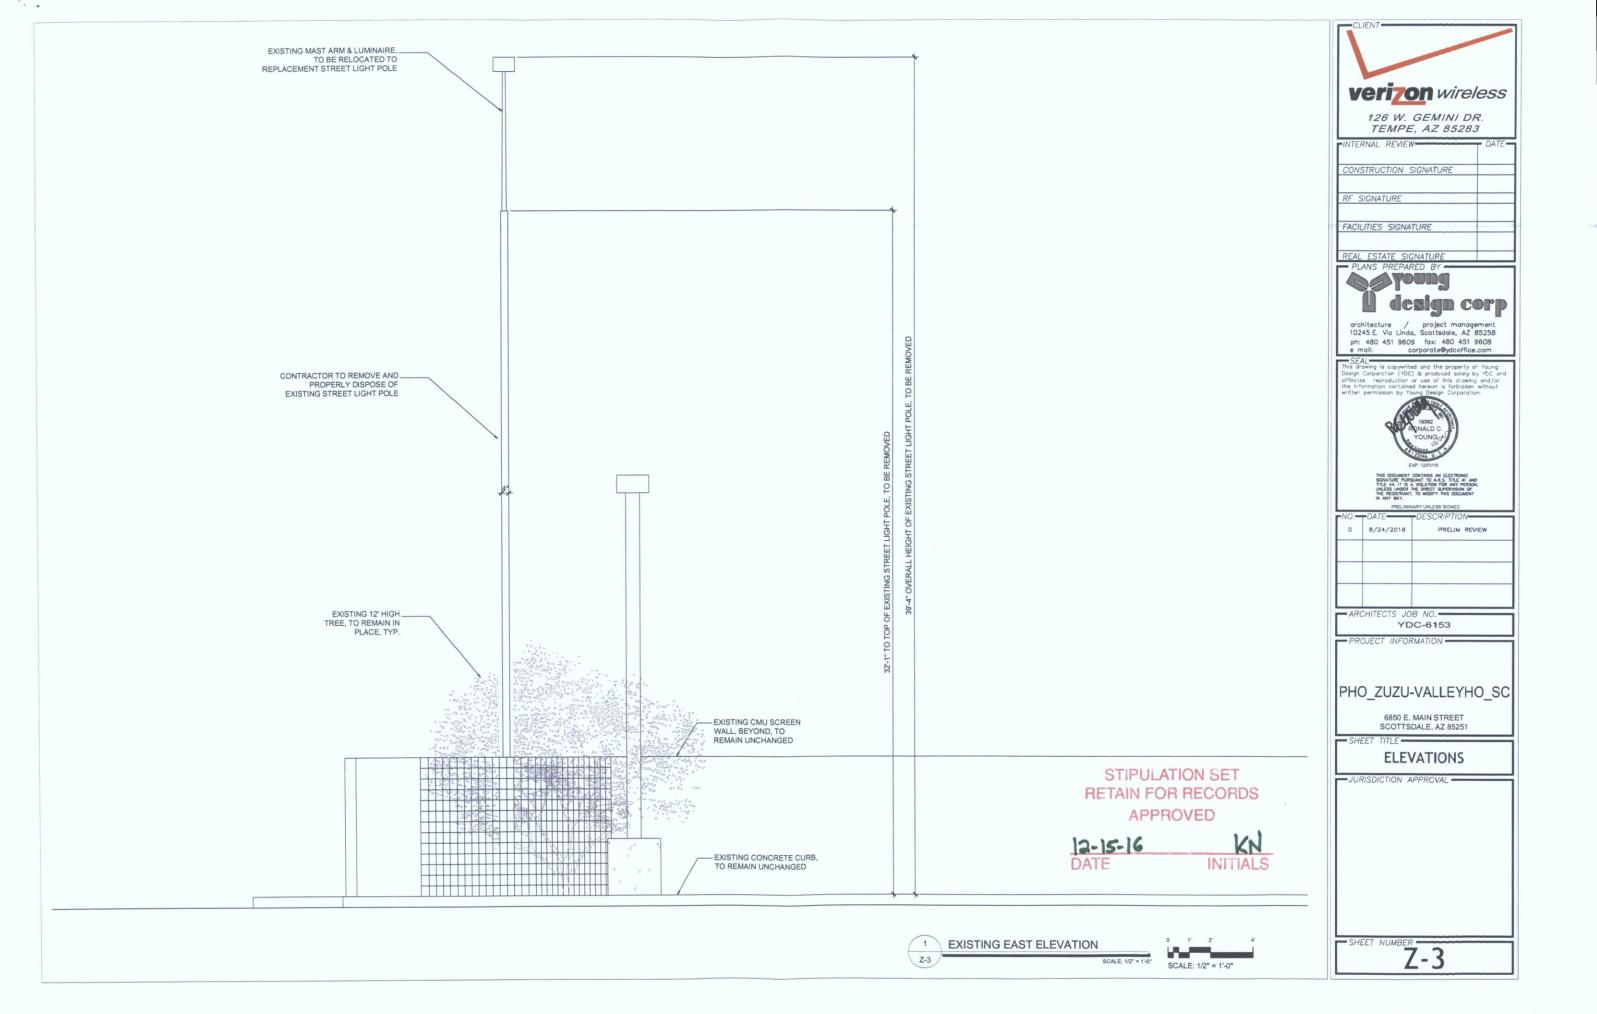

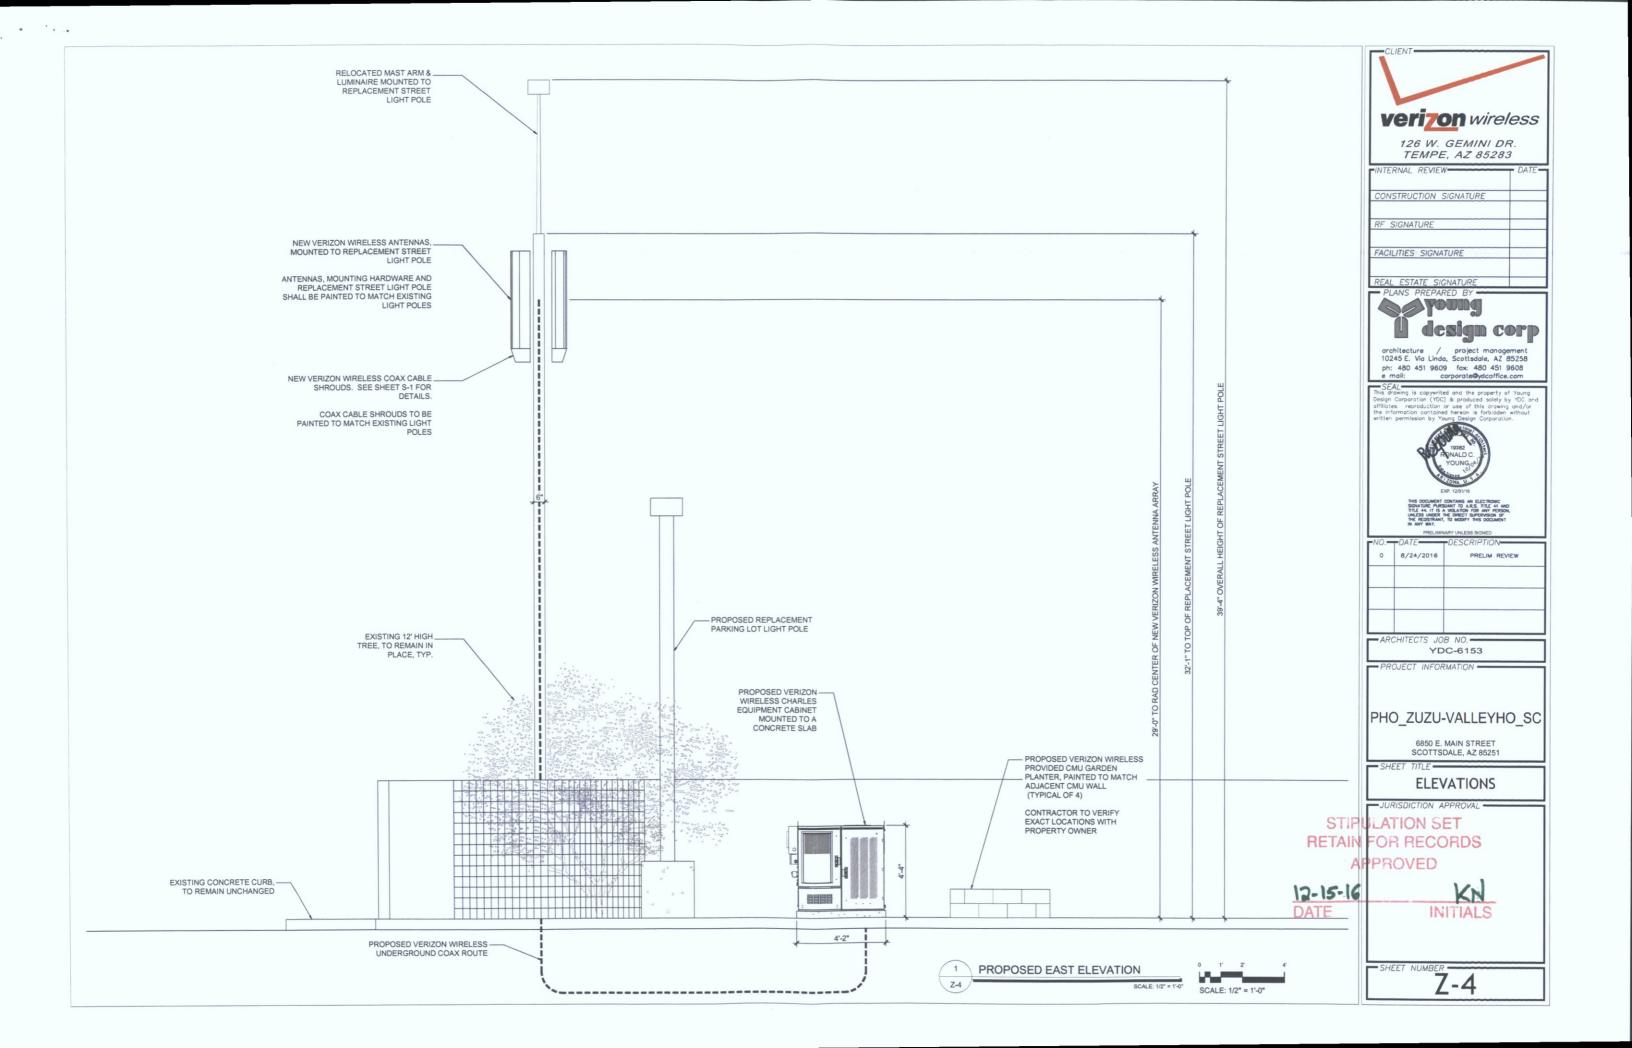

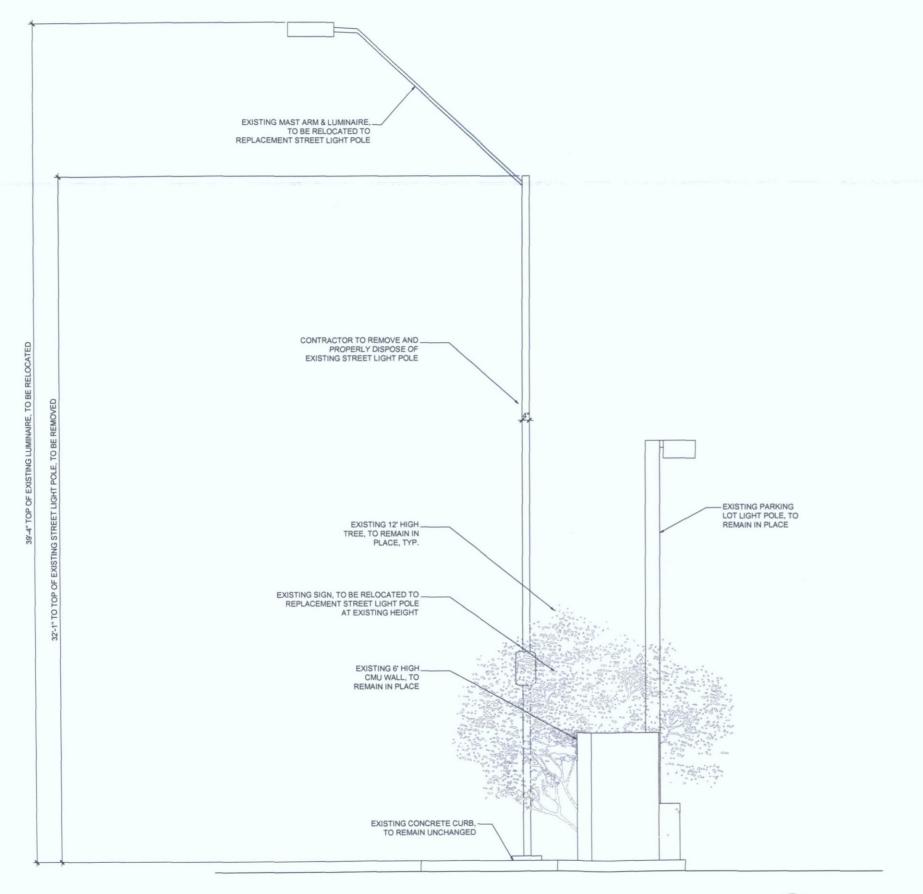



INTERNAL REVIEW—DATE—CONSTRUCTION SIGNATURE

RF SIGNATURE

FACILITIES SIGNATURE

REAL ESTATE SIGNATURE



architecture / project management 10245 E. Via Linda, Scottsdale, AZ 85258 ph: 480 451 9609 fax: 480 451 9608 e mail: corporate@ydcoffice.com

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0	8/24/2016	PRELIM REVIEW
	-	

ARCHITECTS JOB NO. YDC-6153

PROJECT INFORMATION -

PHO\_ZUZU-VALLEYHO\_SC

6850 E. MAIN STREET SCOTTSDALE, AZ 85251

-SHEET TITLE


**ELEVATIONS** 

-JURISDICTION APPROVAL -

EXISTING SOUTH ELEVATION

SCALE: 1/2" = 1'-0"

Z-5

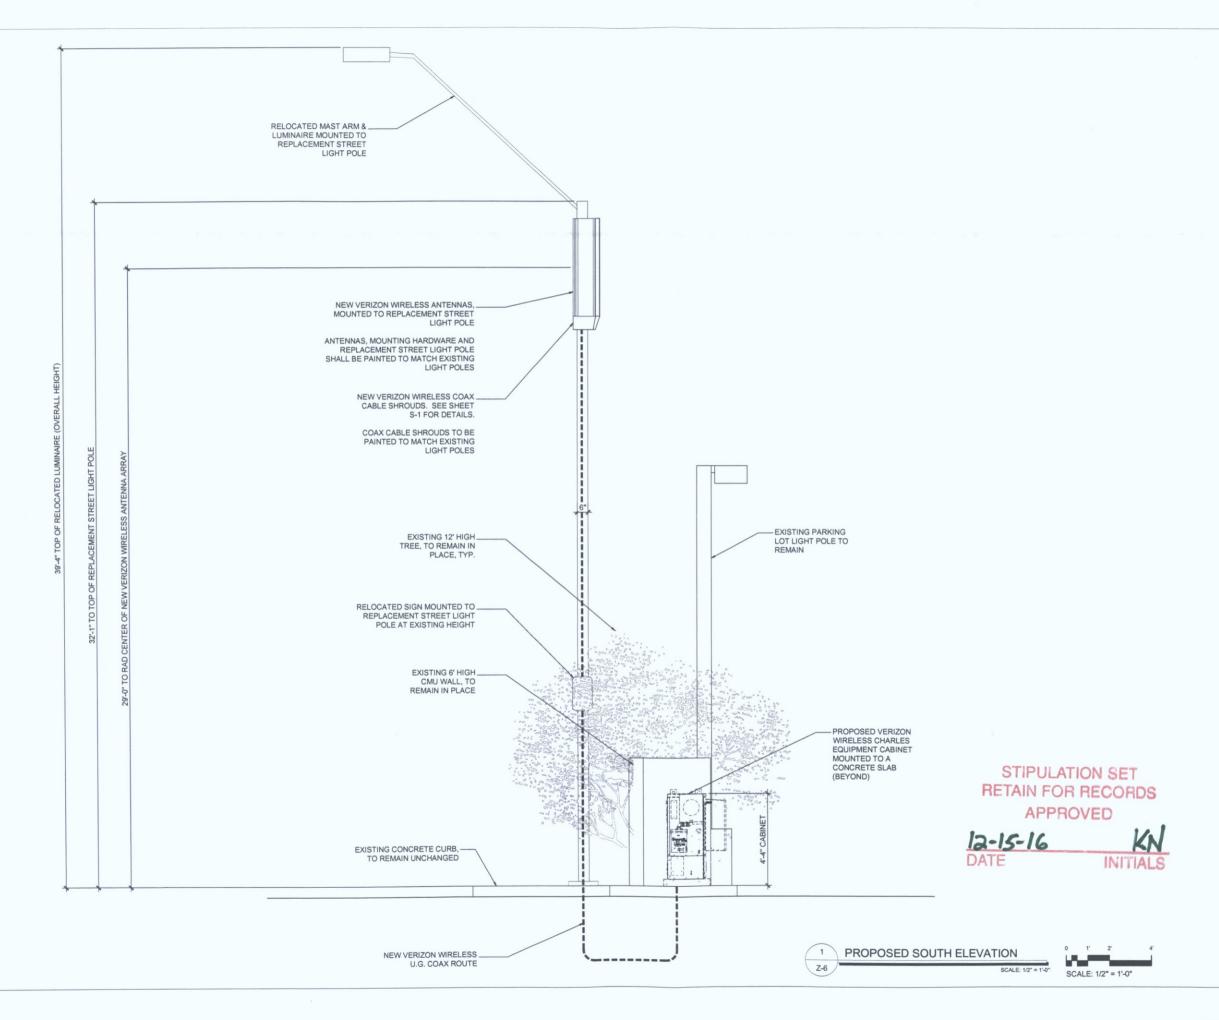



TEMPE, AZ 85283

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0	8/24/2016	PRELIM REVIEW

ARCHITECTS JOB NO. YDC-6153

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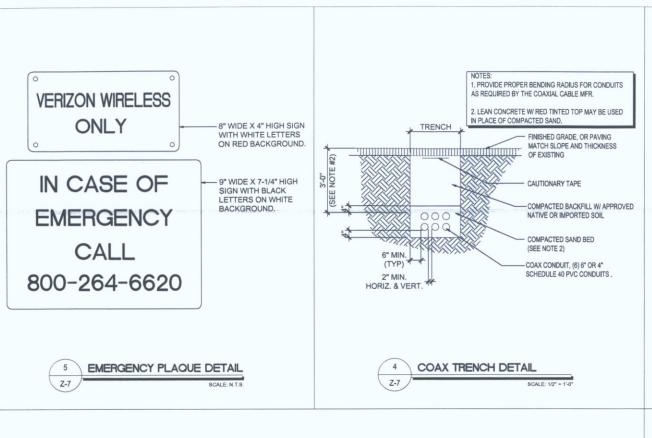
SHEET THEE


**ELEVATIONS** 


JURISDICTION APPROVAL

SHEET NUMBER

**Z-6** 




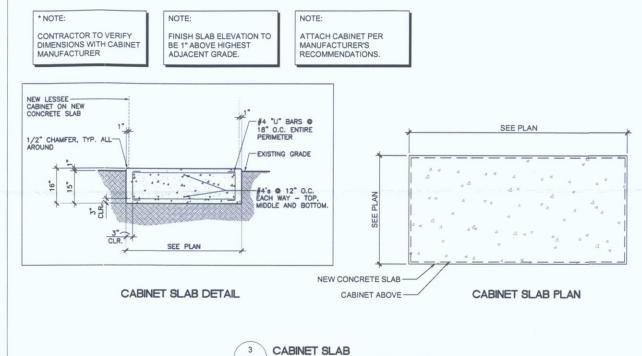

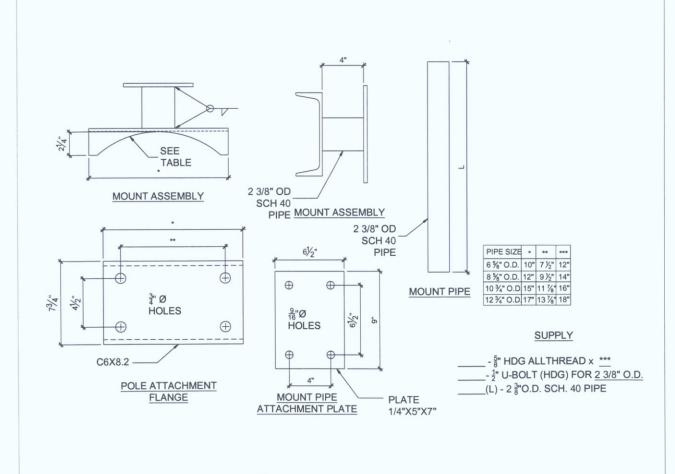

ANTENNA MOUNT DETAILS

Z-7

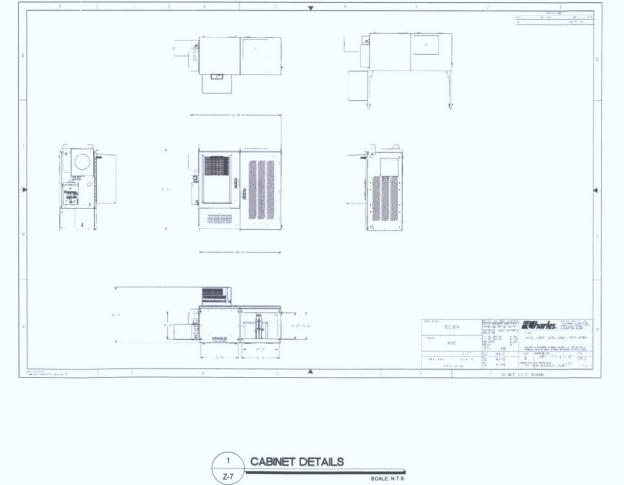



CONSTRUCTION SIGNATURE RF SIGNATURE

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PLANS PREPARED BY

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0	8/24/2016	PRELIM REVIEW

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**DETAILS** 

-JURISDICTION APPROVAL -

- SHEET NUMBER - 7