
Final Plans

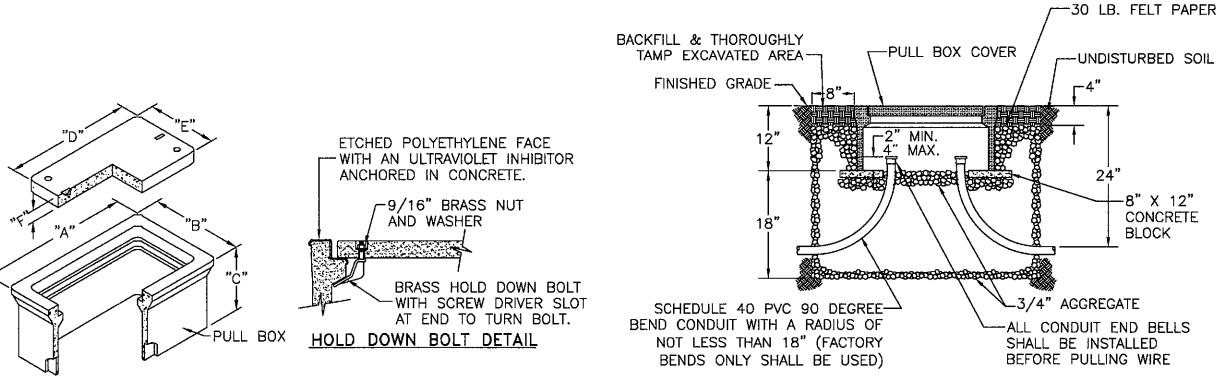

LID 'A' REINFORCED CONCRETE W/HOLD DOWN BOLTS

DATA TABLE								
PULLBOX TYPE	PULLBOX LENGTH	PULLBOX WIDTH	PULLBOX HEIGHT	LID LENGTH	WIDTH	LID HEIGHT		
	"A"	"B"	"C"	"D"	"E"	"F"		
#3 1/2	19-3/4"	14-1/4"	12"	15-1/4"	10"	1-3/4"		
#5	25-1/4"	15-3/4"	12"	20-5/8"	10-1/2"	2"		
# 7	34-3/4"	21-3/4"	12"	30-1/8"	17-5/8"	2"		


PULL BOX INSTALLATION

MONUMENT UPLIGHT DETAIL

GENERAL NOTES:

1. THE PULL BOX SHALL BE MADE OF A HIGH DENSITY REINFORCED CONCRETE MATERIAL WITH END & SIDE KNOCKOUTS, & NONSETTLING SHOULDERS TO MAINTAIN GRADE, MANUFACTURED WITH APPROXIMATE DIMENSIONS AS SHOWN.

- 2. STEEL REINFORCEMENT SHALL BE AS REGULARLY USED IN STANDARD PRODUCTS OF THE RESPECTIVE MANUFACTURER.
- 3. COVER LETTERING SHALL BE 1" LETTERS CAST IN STANDARD MARKINGS: "ELECTRIC" OR "HIGH VOLTAGE". AS REQUIRED.
- 4. THE PULL BOX SHALL HAVE AN ETCHED POLYETHYLENE FACE WITH AN ULTRAVIOLET INHIBITOR ANCHORED IN CONCRETE.
- 5. ALL CABLE & CONDUCTOR SPLICES SHALL BE CONNECTED WITH TYCO ELECTRONICS GELCAP-SL, NSI INDUSTRIES ESSLK-2/0, OR COPPER COMPRESSION H-TAP CONNECTOR OR APPROVED EQUAL & INSULATED WITH 3M SCOTCHCAST SPLICE KIT 85 SERIES, TYCO ELECTRONICS GELCAP SL, NSI INDUSTRIES GSS SERIES OR APPROVED EQUAL.

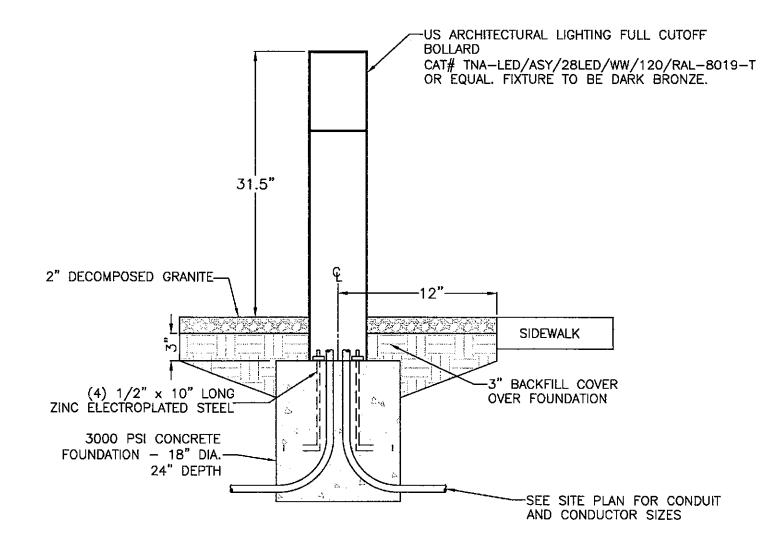



*FIXTURE 'C' TO BE PAINTED DARK BRONZE

SOLID STATE AREA LIGHTING

TORNADO SERIES-LED

SPECIFICATIONS

Durable corrosion resistant low copper cast aluminum alloy A356 (<0.2% Cu) having a minimum wall thickness of 4° . Top is crowned for water run off, and retainer screw cavities are open for drainage. Top is fully gasketed and secured by (4) stainless steel allen screws. Access Panel(s) is fully aasketed and retained by (2) stainless steel allen screws located below the lens. Body secures to Mounting Stanchion by means of a cast aluminum wedge lock secured by a single stainless steel bolt and accessed through the access panel.

VLED OPTICAL MODULE Low copper A356 alloy (<.2% copper) cast aluminum housing. Integrated clear tempered 3/16" glass lens sealed with a continuous silicone gasket protects emitters (LED's) and emitter Reflector-Prism optics, and seals the module from water intrusion and environmental contaminants. LED's are available in standard Neutral White (4000K), or optional Cool White (5000K) or Warm White (3000K). Each emitter is optically controlled by a Reflector-Prism injection molded from H12 acrylic (3 types per module; one from 0° - 50°; one from 50° - 65°; one from 65° - 72°). Each Reflector-Prism has indexing pins for aiming and is secured to an optical plate made of matte black anodized aluminum. The optical plate locates every Reflector-Prism over an emitter. Reflector-Prisms are secured to the optical plate with a UV curing adhesive. The Reflector-Prisms are arrayed to produce IES Type II. IES Type III, IES Type IV, and IES Type V-SQ distributions. The entire Optical Module is field rotatable in 90° increments. Both module and drivers are factory wired using water resistant. insulated cord. Lens, module and drivers are field replaceable.

High Output LED's are driven at 350mA for nominal 1 Watt output each. LED's are available in standard Neutral White (4000K), or optional Cool White (5000K) or Warm White (3000K). Consult Factory for other LED options.

LED DRIVER UL and CUL recognized High Power Factor, Constant Current LED drivers operate on input voltages from 120-277VAC, 50/60hz, Consult Factory for 347-480VAC. Driver is mechanically fastened to a retaining bracket. Main power quick disconnect provided. Driver has a minimum 4KV of internal surge protection, 10KV & 20KV Surge Protector optional. Dimming and High-Low Driver options available.

Electrostatically applied TGIC Polyester Powder Coat on substrate prepared with 20 PSI power wash at 140°F. Four step iron phosphate pretreatment for protection and paint adhesion. 400°F bake for maximum hardness and durability. Texture finish is standard.

TNS

MADE IN THE

* SHOWN WITH RIBBED ACCESS PANEL -RAP PATENT PENDING

PROJECT NAME:

FIXTURE TYPE:

2013030 U.S. ARCHITECTURAL

PATENT PENDING

FIXTURE "C"

U.S. Architectural Lighting

(1) LITHONIA LIGHTING DSXO, 35 WATT LED LUMINAIRE WITH TYPE III IES PHOTOMETRIC DISTRIBUTION, AND STANDARD DARK-BRONZE CAT#DSXO LED/20C/530/30K/T3M/120/SPA/DDBXD OR EQUAL (2) 5" SQUARE TUBE-STEEL DIRECT BURIED POLE. FINISH SHALL BE POLYESTER POWDER COAT WITH MINIMUM 2.5 MILS THICKNESS. COLOR TO MATCH FIXTURE.

(3) FLUSH MOUNTED HANDHOLE WITH TAMPERPROOF SCREWS. POLE MANUFACTURER TO PLACE HANDHOLE SO THAT IT WILL BE LOCATED 18" ABOVE FINISHED GRADE TO CENTER AFTER INSTALLATION. INSTALL POLE WITH HANDHOLE FACING AWAY FROM PATH/SIDEWALK, WHERE POSSIBLE. WHERE POLE IS INSTALLED AGAINST WALL, HANDHOLE TO FACE PATH. PROVIDE A FACTORY INSTALLED GROUND WIRE WHICH IS CONNECTED TO THE HANDHOLE, CONNECT THE ELECTRICAL SYSTEM GROUND WIRE TO THIS POLE GROUND WIRE. FOR TWO POLE CIRCUITS PROVIDE BUSSMAN #HEX FUSE HOLDER FOR INLINE FUSING. FOR SINGLE POLE CIRCUITS PROVIDE BUSSMAN #HEB FUSE HOLDER FOR INLINE FUSING.

(4) APERTURE IN POLE BASE FOR UNDERGROUND WIRING. PROVIDE TWO (2) EACH POLE AT 180 DEGREES FROM EACH OTHER AND 90 DEGREES FROM HANDHOLE. TAPE OPENINGS PRIOR TO BACKFILLING THE DRILLED HOLE.

(5) AFTER POLE HAS BEEN ALIGNED AND IS PLUMB, BLOCK POLE IN PLACE UNDERGROUND, BACKFILL HOLE WITH CEMENTIOUS EARTH BACKFILL TO A POINT 4" BELOW FINISHED GRADE, BACKFILL THE REMAINING 4" WITH SURROUNDING SOIL. CEMENTIOUS EARTH BACKFILL - MIX ONE PART DRY CEMENT POWDER TO FIFTEEN PARTS CLEAN, WASHED SAND.

(6) 1" WASHED RIVER ROCK, COMPACT BEFORE SETTING POLE.

(7) FINISHED GRADE.


(8) ELECTRICAL BRANCH CIRCUIT. SEE LIGHTING SITE PLAN FOR SIZES,

(9) INSTALL PVC SCHEDULE 40 CONDUIT INTO POLE BASE.


(10) COIL 20' OF #10 SOLID COPPER BOND, RUN BOND THROUGH POLE TO FACTORY INSTALLED GROUND WIRE IN HAND HOLE.

(1) PROVIDE BUSSMAN #HEB FUSE HOLDER, ON EACH UNGROUNDED CONDUCTOR, WITH 5 AMP FUSES FOR INLINE FUSING. WHERE CIRCUIT IS SPLICED IN HANDHOLE, MAKE ALL SPLICES WITH UL486D WET LISTED WIRE NUTS, EQUAL TO DRYCONN AQUA WATERPROOF CONNECTORS. PROVIDE 18" MINIMUM OF SLACK IN THE CONDUCTORS.


(12) POLE BASE TO BE DIPPED OR COATED INSIDE AND OUT WITH A COAL TAR EPOXY, 6-8 MILS THICK WHEN DRY, TO A POINT 6" ABOVE FINISHED GRADE. PAINT EXPOSED COATING TO MATCH POLE COLOR.

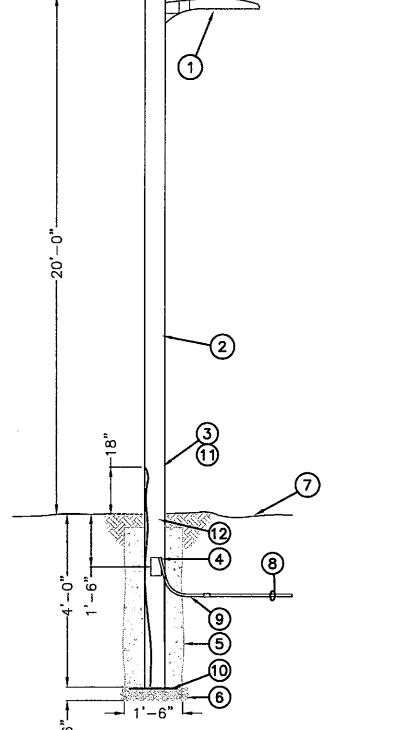



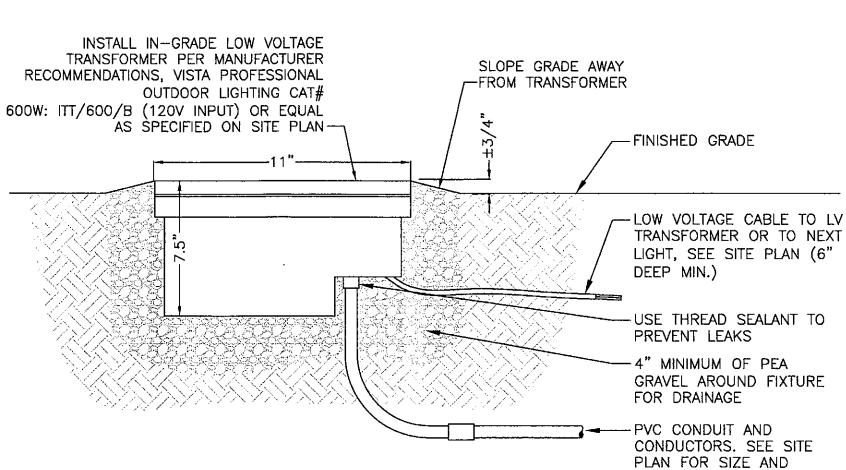

IN-GRADE LV TRANSFORMER NO SCALE

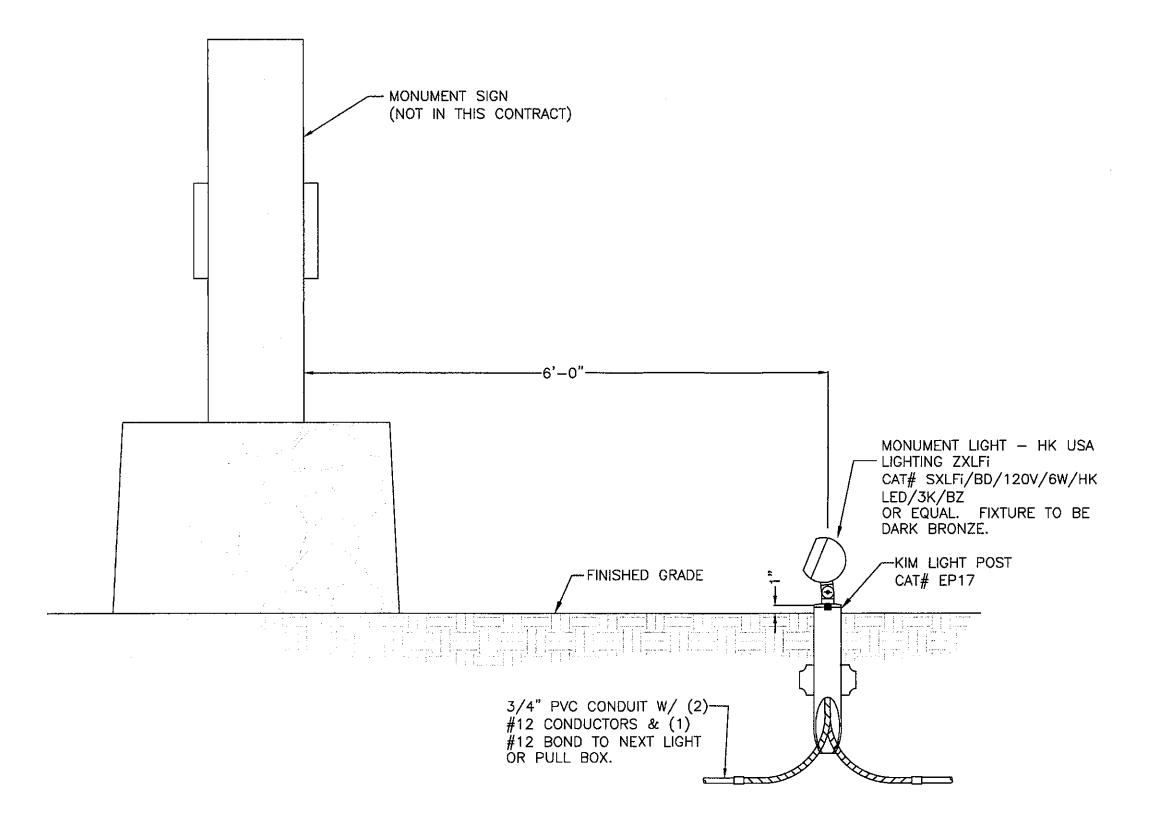

SITE LIGHT DETAIL NO SCALE

ARIZONA BLUE STAKE Dial 811 or 602-263-1100 1-800-STAKE-IT

DRAWING NO:

SE3.2

OF 6

QUANTITY

PROJECT: TITLE Ш


WRIGHT ENGINEERING

PROJECT NO:

DESIGN BY: DJE

DRAWN BY: DJE

CHECKED BY: CMT

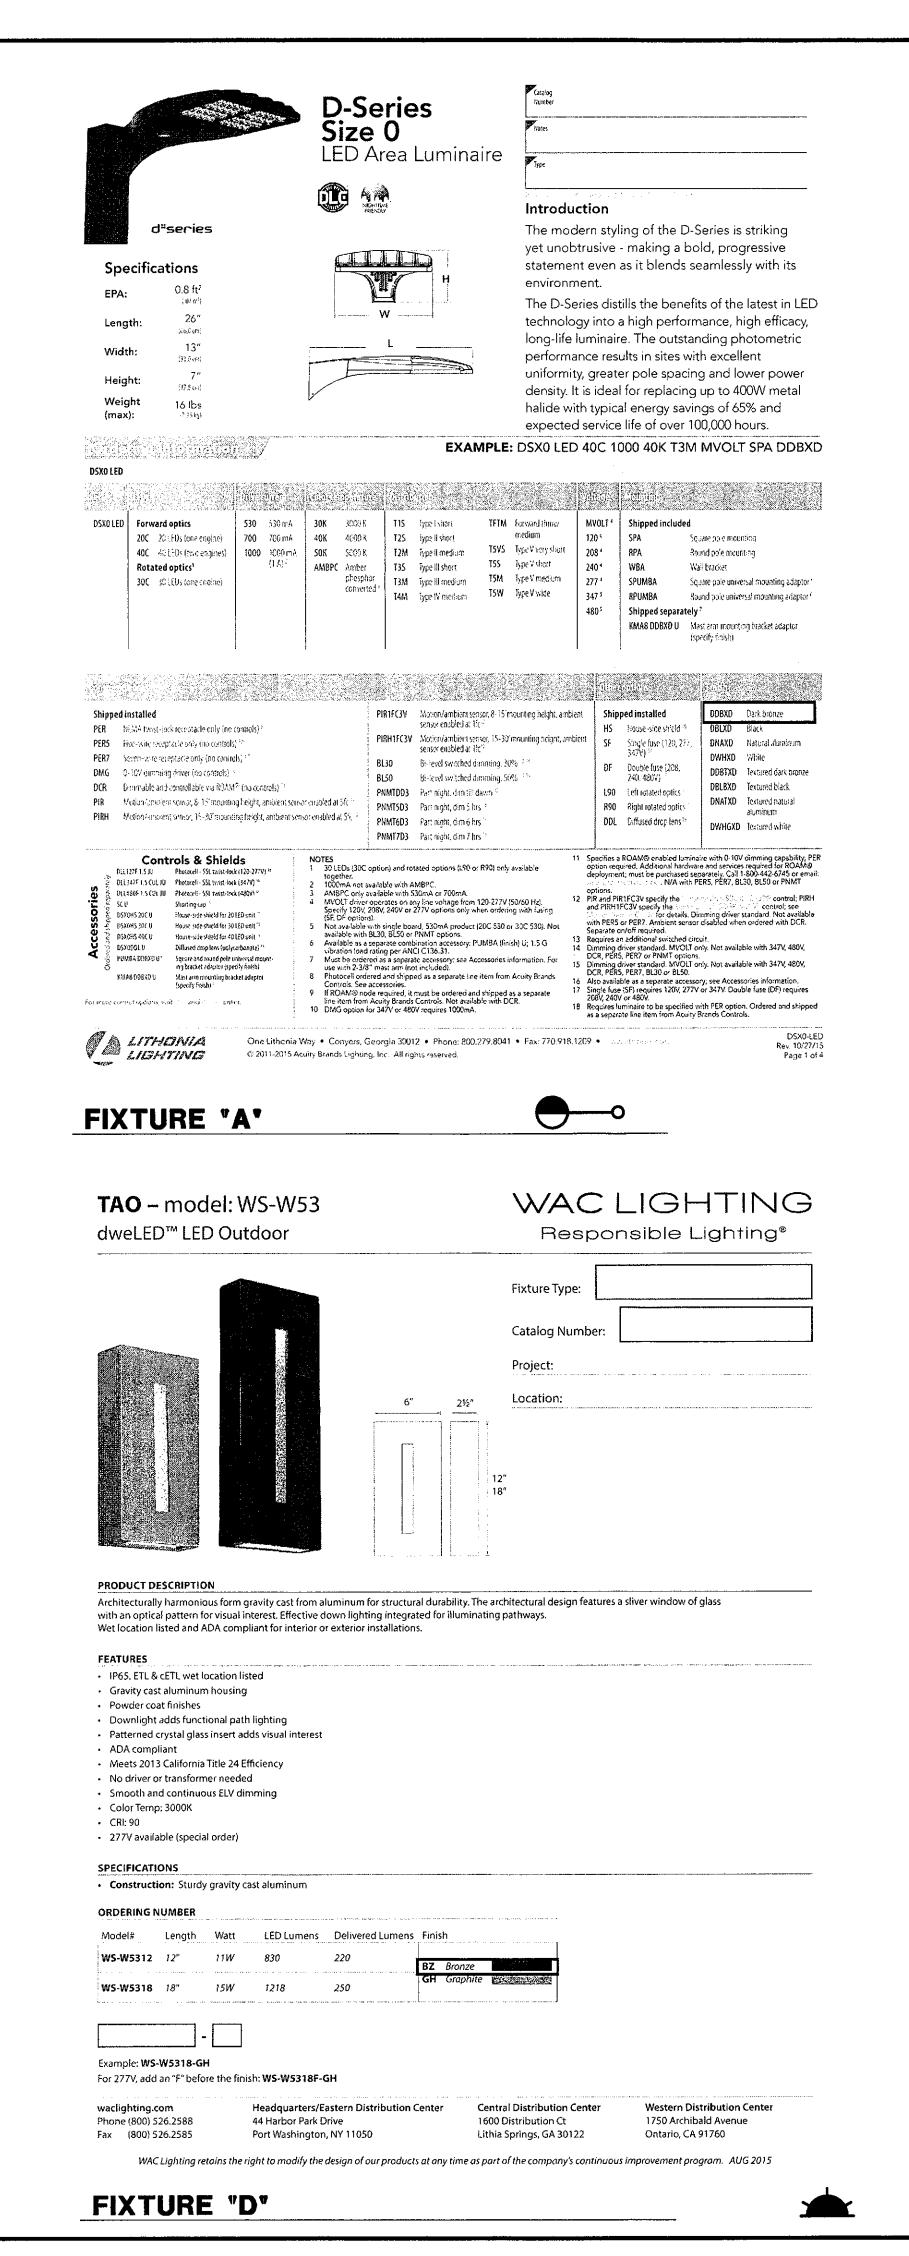

Kusa Lighting Group

ZXLFi

Flood ZXF Series

PROJECT FIXTURE TYPE

Technical Data Characteristics

PET Standard

 Wet/Dry location rated. For optics please consult the

Lamp HK LED Wattage 4W, 6W Color Temp 2.7K, 3K, 4K


Power Supply Integral LED Driver

silicone magnesium aluminum alloy (6061-T6) resistant to corrosion Stainless steel (SS304) hardware

Ordering Guide

Voltage

ACL (anodized clear) CC (custom)

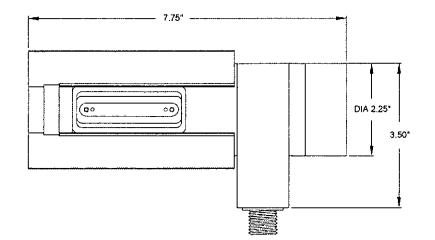

HK USA Lighting Group 3529 Old Conejo Road #118 Newbury Park CA 91320 TEL 805 480 4881 FAX 805 480 4811 sales@hklightinggroup.com

FIXTURE 'B"

LITHONIA LIGHTING

FEATURES & SPECIFICATIONS ment with exceptional energy efficiency and near zero maintenance. Great for retrofit into existing downlight cans or new construction and remodel applications. Unique torsion spring and friction clip retention allows fitment into nearly 100% of installed cans. The LED module maintains at least 70% CONSTRUCTION — Aluminum die cast reflector with deep baffle configuration for reduced glare.

Combined LED and driver printed circuit board attached. Inner reflector cone funnels light through the pressed-in diffused lens. Baffle and open trim inserts are available in multiple finishes. OPTICS — Diffused lens at end of mixing chamber to provide even light distribution for general illumina

tion, equivalent to 65W BR30 or 100W BR30 lamp. Wide flood beam angle at >45°. **ELECTRICAL** — Center 2 Edge™ (patent pending) technology created for a single point source. Primary power disconnect provided for simple connection to a dedicated LED connector in the housing.


Dimming down to 10%. For compatible dimmers, refer to Compatible Dimmers Chart. 725-lumen P series has an input wattage of 12.7 watts, 57 lumens per watt, equivalent to 65-watt P Series' patent pending driver has zero inrush, which allows power loads to be calculated with actual Example: 47 units of 6BPMW LED fixtures can be installed in line with a 600-watt dimmer, 600W/12.7W

*Actual wattage may differ by ÷/-5% when operating at 120V +/-10%. INSTALLATION — Suitable for installation in standard and shallow-height rough-in sections. E26 socket adapter and splice kit ships standard. This enables easy installation or permanent conversion to an LED source for Title 24 compliance. Twin torsion springs ensure easy installation.

950-lumen P series has an input wattage of 15.2 watts, 63 lumens per watt, equivalent to 100-watt

Friction clips included to allow fitment into cans without torsion brackets from an inside diameter of LISTINGS — CSA certified to US and Canadian safety standards. ENERGY STAR® qualified; California T24 compliant. Wet location listed for indoor use only. WSEC ASTM E283 for Air-Tight (with IC housings).

WARRANTY — 5-year limited warranty. Complete warranty terms located at www.acuitybrands.com/CustomerResources/Terms_and_conditions.aspx Actual performance may differ as a result of end-user environment and application. Note: Specifications subject to change without notice. Height: 3-7/8 (9.8)

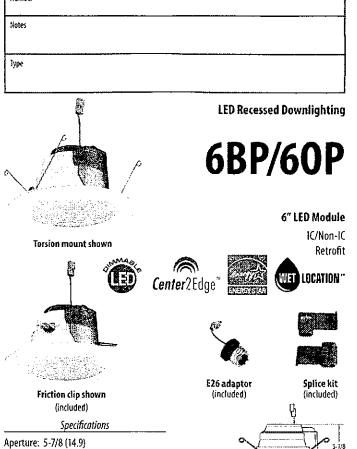

All dimensions are inches (centimeters) unless otherwise indicated. Example: 6BP TRMW LED 27K 90CRI ORDERING INFORMATION Lead times will vary depending on options selected. Consult with your sales representative Lamp (CT/CRI/W/Lumens¹ 6BPMW 6" Baffle LED module, matte white (blank) 3000 K / 83 CRI / 12.7W / 725L (blank) 120V L7XLED T24 New construction rough-in LED base 6BP TRMW 6" Baffle LED module, black baffle, matte 27K 90CRI 2700 K / 93 CRI / 10.25W / 600L L7XRLED T24 Remodel rough-in LED base 30K 90CRI 3000 K / 93 CRI / 10.25W / 600L LC6LED T24 New construction rough-in LED base 68PBN 6" Baffle LED module, brushed nickel 40K 90CRI 4000K / 92CRI / 9.9W / 650L New construction rough-in? 6" Baffle LED module, oil-rubbed bronze Remodel rough-in? HLLED (blank) 3000 K / 83 CRI / 15.2W / 950L New construction shallow rough-in³ 27K 90CRI 2700 K / 93 CRI / 16.7W / 860L Remodel shallow rough-in2 30K 90CRI 3000 K / 93 CRI / 16.7W / 860L New construction rough-in² 40K 90CRI 4000K / 92CRI / 16.4W / 950L New construction shallow rough-in² 6" Open LED module, clear diffuse 3000 K / 83 CRI / 12.7W / 725L L7XLED 124 New construction rough-in LED base 6" Open LED module, clear specular 27K 90CRI 2700 K / 93 CRI / 10.25W / 600L £7XRLED T24 Remodel rough-in LED base 30K 90CRI 3000 K / 93 CRI / 10.25W / 600L LC6LED T24 60PA TRMW 6" Open LED module, clear diffuse, matte New construction rough-in LED base 40K 90CRI 4000K/92CRI/9.9W/650L New construction rough-in² 60PAZ TRMW 6" Open LED module, clear specular, matte Remodel rough-in³ white flange HL1ED (blank) 3000 K / 83 CRI / 15.2W / 950L New construction shallow rough-in? 27K 90CRI 2700 K / 93 CRI / 16.7W / 860L Remodel shallow rough-in² 30K 90CRf 3000 K / 93 CRI / 16.7W / 860L New construction rough-in? 40K 90CRI 4000K/ 92CRI / 16.4W / 950L New construction shallow rough-in?

Ceiling opening: Determined by rough-in

Overlap trim: 7-5/8 (19.4)

Accessories: Order as separate catalog number: TSA6 Makes non-bracket housing compatible with the EED module; ships as units, J6 or J25 FLZLED Makes L7XF housings compatible with the LED module

1 Total system delivered lumens. 2 Must be ordered on a separate line. See page 2 for Trim Inserts.

68P-60P LED

*FIXTURE 'E' TO BE PAINTED DARK BRONZE

> Dial 811 or 602-263-1100 1-800-STAKE-IT

ARIZONA BLUE STAKE

FIXTURE "E"

DOWNLIGHTING

DRAWING NO:

SE3.3

OF 6

WRIGHT ENGINEERING

PROJECT NO:

DESIGN BY: DJE

DRAWN BY: DJE

CHECKED BY: CMT

PROJECT:

SC

TITLE:

PHOTOMETRIC RESULTS

Site Analasys 421 points at z=0, sp 10ft by 10ft HORIZONTAL FOOTCANDLES Average Maximum Minimum Avg:Min Max:Min 1.54 Coef Var UnifGrad

Perimiter Analasys 94 points at z=6 VERTICAL FOOTCANDLES 0.3 0.8 0.0 N/A Average Maximum Minimum Avg:Min Max:Min

LEGEND

- LITHONIA LIGHTING RECESSED DOWNLIGHTING CANDELA FILE: '6BPMW_LED.IES' LAMP: LED LAMP LUMENS: 610 COLOR TEMPERATURE: 3,000K 9'-0" FIXTURE LENS HEIGHT: TOTAL LIGHT LOSS FACTOR: 1.0
- WAC LIGHTING WALL MOUNTED LIGHT CANDELA FILE: 'WS-W5318-GH.ies' 250 3,000K LAMP LUMENS: COLOR TEMPERATURE: FIXTURE LENS HEIGHT: 6'-0" TOTAL LIGHT LOSS FACTOR: 1.0
- US ARCHITECTURAL LIGHTING BOLLARD 'TNS-28LED-NW.ies' CANDELA FILE: 1,346 LAMP LUMENS: COLOR TEMPERATURE: 3,000K 3'-0" FIXTURE LENS HEIGHT: TOTAL LIGHT LOSS FACTOR: 1.0
- HK LIGHTING GROUP INC. SIGN LIGHT CANDELA FILE: 'ZXL-Fi.IES' LED LAMP: LAMP LUMENS: 262 3,000K COLOR TEMPERATURE: 0'-6" FIXTURE LENS HEIGHT: TOTAL LIGHT LOSS FACTOR: 1.0
- LITHONIA LIGHTING AREA LIGHT CANDELA FILE: 'DSX0_LED_20C_530_30K_T3M_MVOLT.ies' LAMP: LAMP LUMENS: 4,142 COLOR TEMPERATURE: 3,000K FIXTURE LENS HEIGHT: 16'-0" TOTAL LIGHT LOSS FACTOR:
 - PROGRESS LIGHTING COACH LIGHT 'WS-W2605-BZ.ies' CANDELA FILE: LAMP LUMENS: 800 COLOR TEMPERATURE: 3,000K FIXTURE LENS HEIGHT: PER ARCHITECTURAL PLANS TOTAL LIGHT LOSS FACTOR: 1.0

EXERIOR LIGHTING


ORDINANCE

1. ALL EXTERIOR LUMINAIRES MOUNTED EIGHT (8) FEET OR HIGHER SHALL BE DIRECTED DOWNWARD.

2. ANY EXTERIOR LUMINAIRE WITH A TOTAL INITIAL LUMEN OUTPUT OF GREATER THAN 1600 SHALL HAVE AN INTEGRAL

DRB STIPULATIONS

- 1. ALL EXTERIOR LUMINARIES SHALL MEET ALL IES REQUIREMENTS FOR FULL CUTOFF, AND SHALL BE AIMED DOWNWARD AND AWAY FROM PROPERTY LINE EXCEPT FOR SIGN LIGHTING, PARKING LOT CANOPY LIGHTING AND
- 2. INCORPORATE THE FOLLOWING PARKING LOT AND SITE LIGHTING REQUIREMENTS INTO THE PROJECT'S DESIGN:
 - A. THE MAINTAINED AVERAGE HORIZONTAL LUMINANCE LEVEL, AT GRADE ON THE SITE, SHALL NOT EXCEED 2.5-FOOT-CANDLES. ALL EXTERIOR LUMINAIRES SHALL BE INCLUDED IN THIS CALCULATION.
 - B. THE MAINTAINED MAXIMUM HORIZONTAL LUMINANCE LEVEL, AT GRADE ON THE SITE, SHALL NOT EXCEED 8.0-FOOT-CANDLES. ALL EXTERIOR LUMINAIRES SHALL BE INCLUDED IN THIS CALCULATION.
 - C. THE INITIAL VERTICAL LUMINANCE AT 6-FOOT ABOVE, ALONG THE ENTIRE PROPERTY LINE SHALL NOT EXCEED 0.8-FOOT-CANDLES. ALL EXTERIOR LUMINAIRES SHALL BE INCLUDED IN THIS CALCULATION.
 - D. THE TOTAL LUMEN PER LUMINAIRE SHALL NOT EXCEED 24,000 LUMENS.

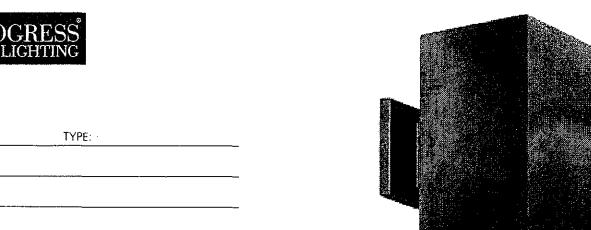

Halogen/incandescent


P5643-20

metal shade

PROJECT:

6" square with heavy duty aluminum construction and die cast wall bracket. Powder coated finish.

Category: Outdoor Construction: Aluminum construction

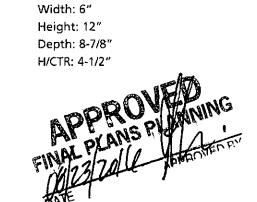

MOUNTING	ELECTRICAL	LAMPING	ADDITIONAL INFORMATION
Wall mounted Mounting strap for outlet box included Back plate covers a standard 4" hexagonal recessed outlet box	Pre-wired 6" of wire supplied 120V	Quantity: 1 250/150W PAR-38 or BR-40 Medium porcelain socket	cCSAus Wet location listed 1 year warranty Companion fixtures are available
4-1/2" sq.			

COACH LIGHT TO BE PAINTED DARK BRONZE


701 Millennium Blvd. Greenville, South Carolina 29607

www.progresslighting.com

Rev. 05/16

COACH LIGHT



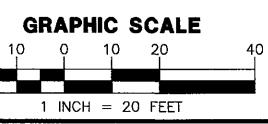





WRIGHT ENGINEERING PROJECT NO:

DESIGN BY: DJE


DRAWN BY: DJE CHECKED BY: CMT

PROJECT:


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TITLE:



DRAWING NO: **SE4.1** OF 6

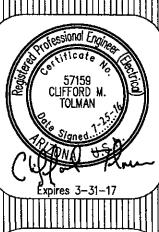

EXERIOR LIGHTING:

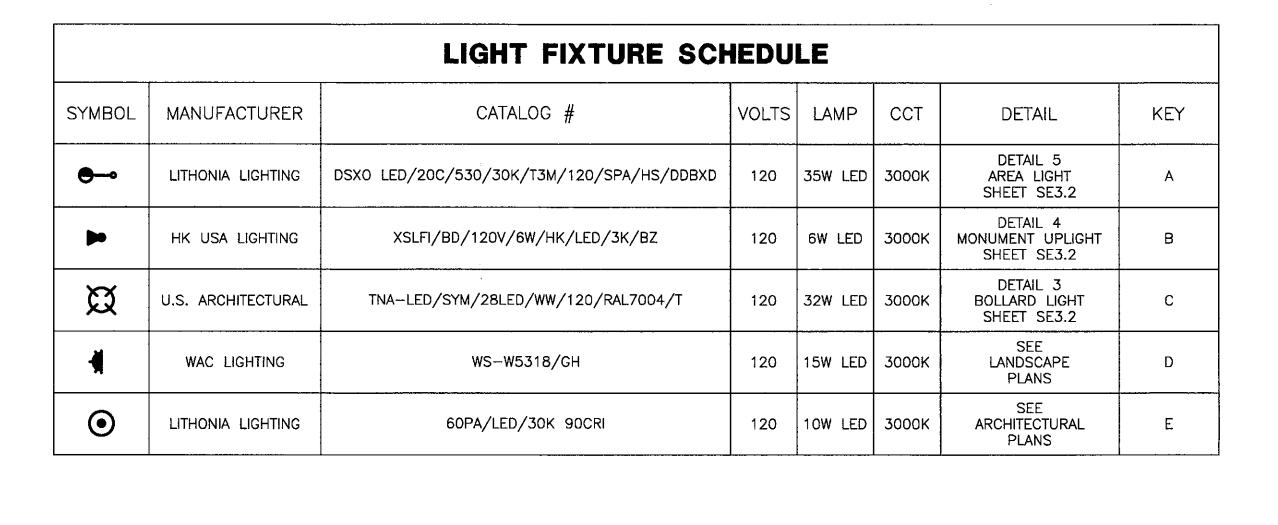ORDINANCE

SEE ENLARGEMENT

ON THIS SHEET

GRAPHIC SCALE

1 INCH = 20 FEET


- 1. ALL EXTERIOR LUMINAIRES MOUNTED EIGHT (8) FEET OR HIGHER SHALL BE DIRECTED DOWNWARD.
- 2. ANY EXTERIOR LUMINAIRE WITH A TOTAL INITIAL LUMEN OUTPUT OF GREATER THAN 1600 SHALL HAVE AN INTEGRAL LIGHT SHIELD.

DRB STIPULATIONS

- 1. ALL EXTERIOR LUMINARIES SHALL MEET ALL IES REQUIREMENTS FOR FULL CUTOFF, AND SHALL BE AIMED DOWNWARD AND AWAY FROM PROPERTY LINE EXCEPT FOR SIGN LIGHTING, PARKING LOT CANOPY LIGHTING AND
- 2. INCORPORATE THE FOLLOWING PARKING LOT AND SITE LIGHTING REQUIREMENTS INTO THE PROJECT'S DESIGN:
- A. THE MAINTAINED AVERAGE HORIZONTAL LUMINANCE LEVEL, AT GRADE ON THE SITE, SHALL NOT EXCEED 2.5-FOOT-CANDLES. ALL EXTERIOR LUMINAIRES SHALL BE INCLUDED IN THIS CALCULATION.
- B. THE MAINTAINED MAXIMUM HORIZONTAL LUMINANCE LEVEL, AT GRADE ON THE SITE, SHALL NOT EXCEED 8.0-FOOT-CANDLES. ALL EXTERIOR LUMINAIRES SHALL BE INCLUDED IN THIS CALCULATION.
- C. THE INITIAL VERTICAL LUMINANCE AT 6-FOOT ABOVE, ALONG THE ENTIRE PROPERTY LINE SHALL NOT EXCEED 0.8-FOOT-CANDLES. ALL EXTERIOR LUMINAIRES SHALL BE INCLUDED IN THIS CALCULATION.

1 INCH = 10 FEET

D. THE TOTAL LUMEN PER LUMINAIRE SHALL NOT EXCEED 24,000 LUMENS.

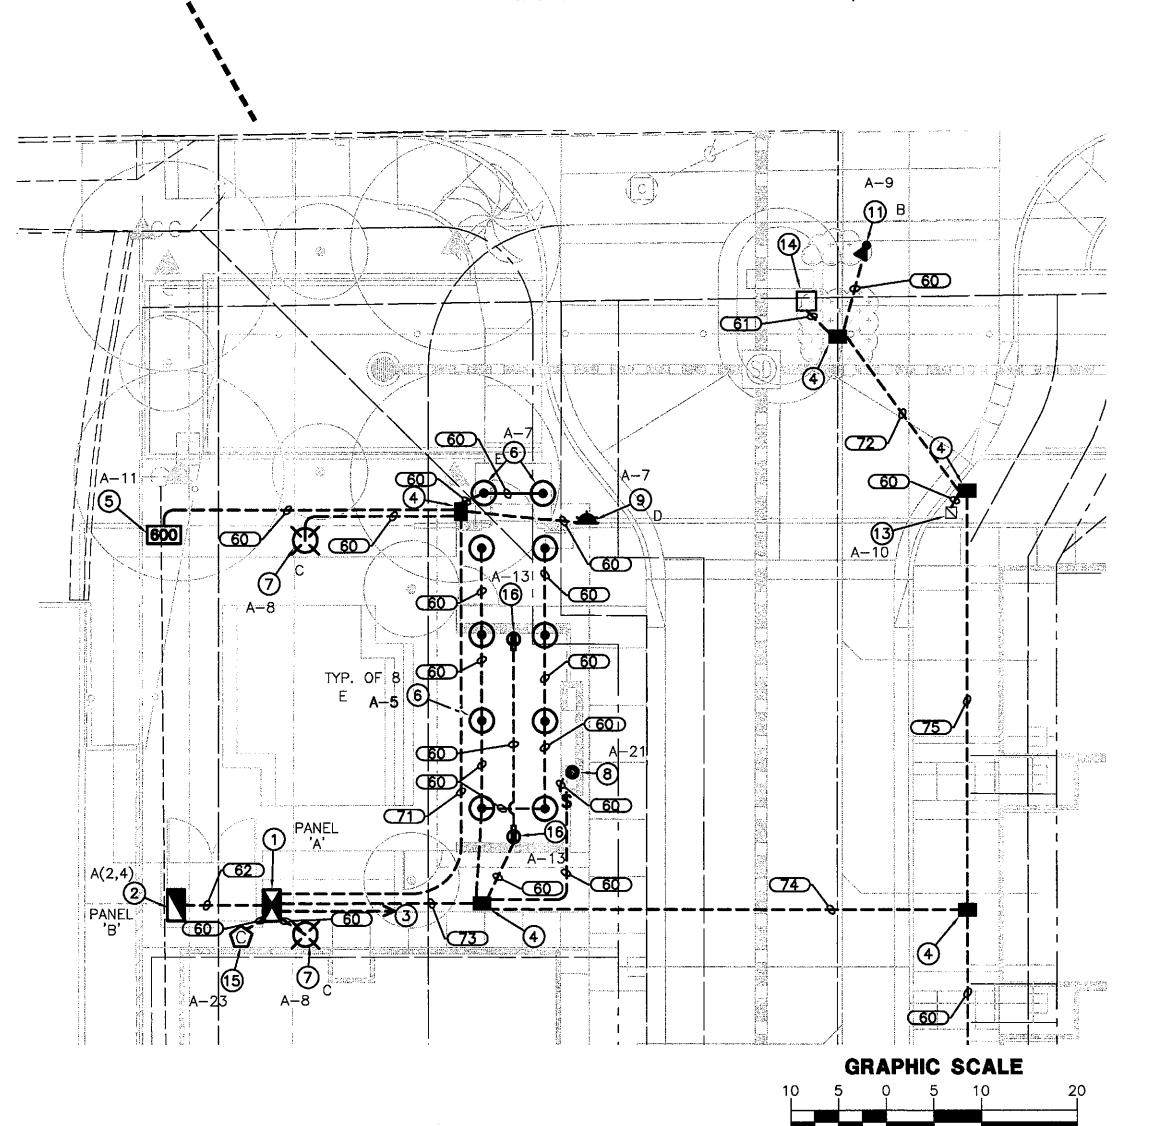

NOTES

- (1) 100 AMP, 120/240V, 1ø, 3W, METERED WALL MOUNTED SERVICE ENTRANCE SECTION AND CONTROL EQUIPMENT. SEE DETAILS ON SHEET SE3.1.
- (2) 60 AMP, 120/240V, 1ø, 3W, WALL MOUNTED PANEL. SEE DETAILS ON SHEET SE3.1.
- 3 PROPOSED POWER CO. SECONDARY CONDUIT. INSTALL PER POWER CO. REQUIREMENTS AND SPECIFICATIONS. EXTEND FROM PROPOSED TRANSFORMER LOCATION TO PROPOSED ELECTRICAL SERVICE. LOCATIONS SHOWN FOR CONTRACTOR CONVENIENCE ONLY. POWER CO. PLANS WILL DETERMINE EXACT LOCATION OF CONDUIT AND TAKE PRECEDENCE OVER THESE DRAWINGS.
- (4) #3-1/2 CONCRETE PULL BOX, SEE DETAIL 1 ON SHEET SE3.2.
- (5) LOW VOLTAGE TRANSFORMER PER DETAIL 6 ON SHEET SE3.2. NUMBER IN TRANSFORMER SYMBOL ON SITE PLAN REPRESENTS WATTAGE OF TRANSFORMER.
- (6) RECESSED CEILING LIGHT, SEE ARCHITECTURAL PLANS FOR INSTALLATION DETAILS AND LOCATION. INSTALL 1/2" CONDUIT WITH 2-#12 CU CONDUCTORS AND 1-#12 GROUND CONCEALED IN CEILING BETWEEN LIGHTS. SEE LIGHT FIXTURE SCHEDULE.
- (7) LED BOLLARD PER DETAIL C ON SHEET SE3.2.
- (8) FIREPLACE IGNITOR. ELECTRICAL CONTRACTOR IS RESPONSIBLE FOR ELECTRICAL CONDUIT, CONDUCTORS AND CONNECTIONS BETWEEN IGNITOR AND ELECTRICAL SERVICE. COORDINATE WITH LANDSCAPE PLANS FOR EXACT LOCATION AND DETAILS. ROUTE POWER THROUGH WALL MOUNTED WEATHERPROOF SWITCH AT 42" ABOVE GRADE LOCATED ON SIDE OF FIREPLACE AS SHOWN ON SITE PLAN.
- (9) 15W WALL MOUNTED SCONCE WAC LIGHTING CAT# WS-W5318/GH OR EQUAL.
- (10) IN-GRADE UP LIGHT PER DETAIL 2 ON SHEET SE3.2.
- (11) STEM MOUNTED FLOOD PER DETAIL B ON SHEET SE3.2.
- **(12)** POLE MOUNTED AREA LIGHT PER DETAIL A ON SHEET SE3.2.
- (13) GATE CONTROLLER LOCATION. COORDINATE WITH GATE CONTRACTOR FOR EXACT LOCATION AND DETAILS. ELECTRICAL CONTRACTOR IS RESPONSIBLE FOR CONDUIT, STUB UPS, 120V CONDUCTORS, 120V SPLICES AND OTHER NECESSARY COMPONENTS FOR A COMPLETE
- GATE KEYPAD. COORDINATE WITH GATE CONTRACTOR FOR EXACT LOCATION AND DETAILS. ELECTRICAL CONTRACTOR IS RESPONSIBLE FOR CONDUIT.
- 15 IRRIGATION CONTROLLER. ELECTRICAL CONTRACTOR IS RESPONSIBLE FOR ELECTRICAL CONDUIT, CONDUCTORS AND CONNECTIONS BETWEEN CONTROLLER AND ELECTRICAL SERVICE. COORDINATE WITH LANDSCAPE PLANS FOR EXACT LOCATION AND DETAILS.
- (16) 20A GFCI DUPLEX RECEPTACLE WITH METAL WEATHERPROOF WHILE IN USE COVER WALL MOUNTED 24" ABOVE GRADE. ROUTE CONDUIT THROUGH STRUCTURE SUPPORT. COORDINATE WITH OTHER TRADES.

LEGEND

- 100 AMP, 120/240V, 1ø, 3W, METERED ELECTRIC PEDESTAL.
- 60 AMP, 120/240V, 1ø, 3W, METERED ELECTRIC PEDESTAL
- #3-1/2 CONCRETE PULL BOX
- **600** LOW VOLTAGE TRANSFORMER
- ☐ GATE MOTOR
- GATE KEYPAD
- (C) IRRIGATION CONTROLLER
- ✓ UNDERGROUND CONDUIT
- ABOVE GROUND CONDUIT
- A-1 CIRCUIT NUMBER
- CONDUIT TAG, SEE WIRE & CONDUIT TABLE
- FIREPLACE IGNITOR
- **⇒** RECEPTACLE
- \$ FIREPLACE SWITCH

WIRE & CONDUIT TABLE

CONDUIT		W	IRE	REMARKS
NO.	SIZE	POWER	GROUND	(CKT #)
60	1"	2-#12	1-#12	TYP,
61	1"	DETECTABLE	PULL ROPE	TYP.
62	1.5"	3#6	1-#10	A(2,4)
71	1.5"	2-#12	1-#12	A-7
	ļ	2-#12]	A-8
	1	2-#12]	A-11
	1"	DETECTABLE	PULL ROPE	TYP.
72	1"	2-#12	1-#12	A-9
	1"	DETECTABLE	PULL ROPE	TYP.
73	1"	2-#12	1-#12	A-5
		2-#12		A-6
		2-#12] .	A-9
	1"	2-#12	1-#12	A-10
		2-#12		A-13
		2-#12]	A-21
	1"	DETECTABLE PULL ROPE		TYP.
74	1.5"	2-#12	1-#12	A-6
		2-#12		A-9
		2-#12		A-10
	1"	DETECTABLE	PULL ROPE	TYP.
75	1"	2-#12	1-#12	A-9
		2-#12		A-10
	1"	DETECTABLE	PULL ROPE	TYP.






WRIGHT ENGINEERING PROJECT NO:


DESIGN BY: DJE DRAWN BY: DJE CHECKED BY: CMT

PROJECT:

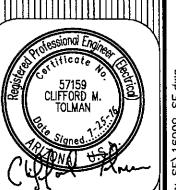


DRAWING NO: **SE2.1**




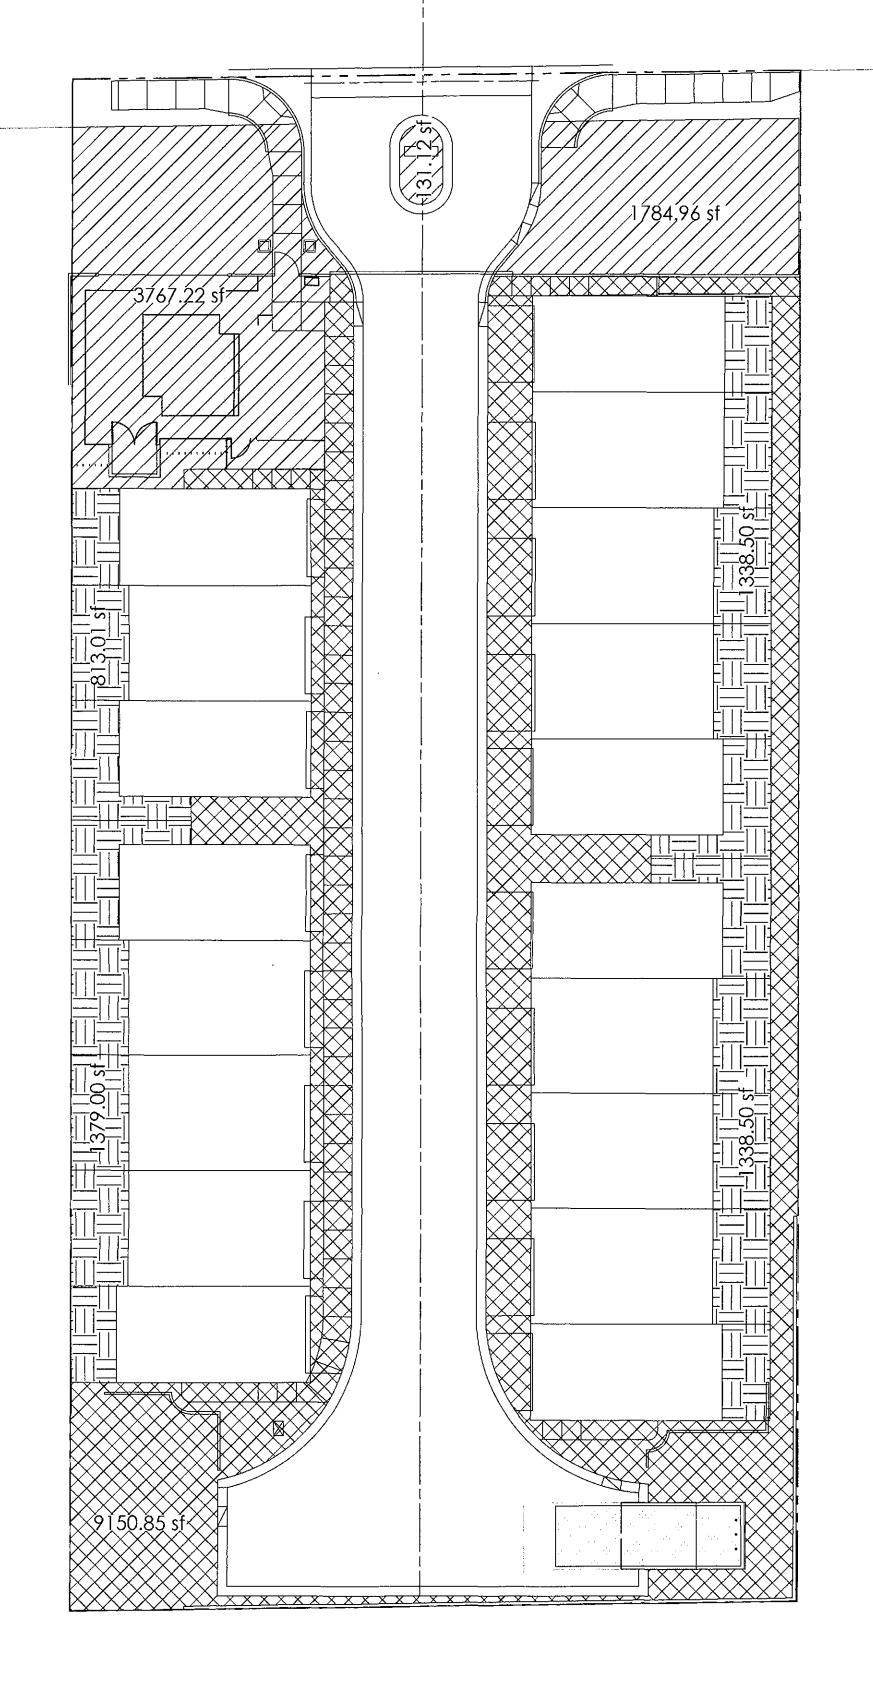

OPEN SPACE PLAN

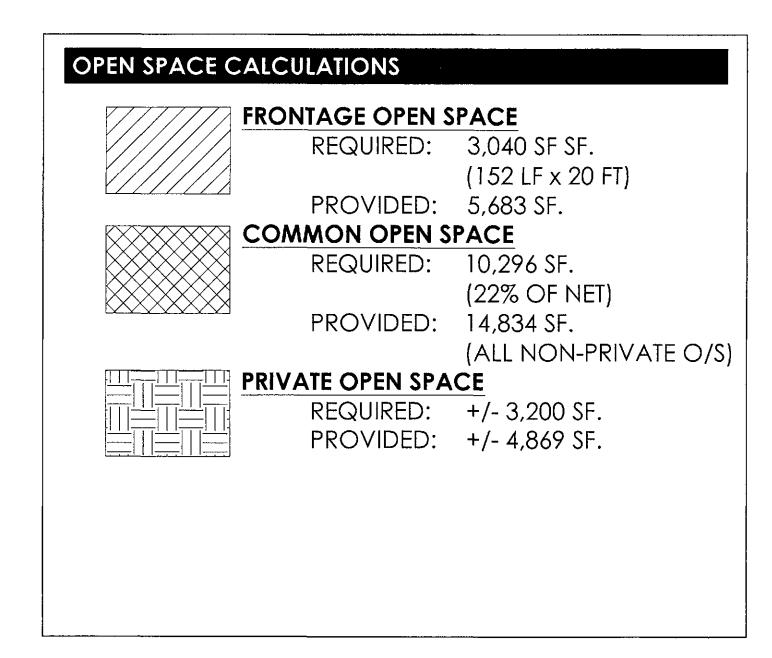

SITE DATA:	
SITE AREA (NET): SITE AREA (GROSS): GROSS DENSITY: CURRENT ZONING: PROPOSED ZONNING: PROPOSED # OF LOTS: PARKING REQUIRED:	46,800 SF. (1.1 AC. +/-) 51,400 SF. (1.2 AC. +/-) 15 DU/AC. C-3 R-5 18 2 SPACES/UNIT TO BE PROVIDED IN GARAGE - ALL OTHER PARKING TO BE OFF-SITE.

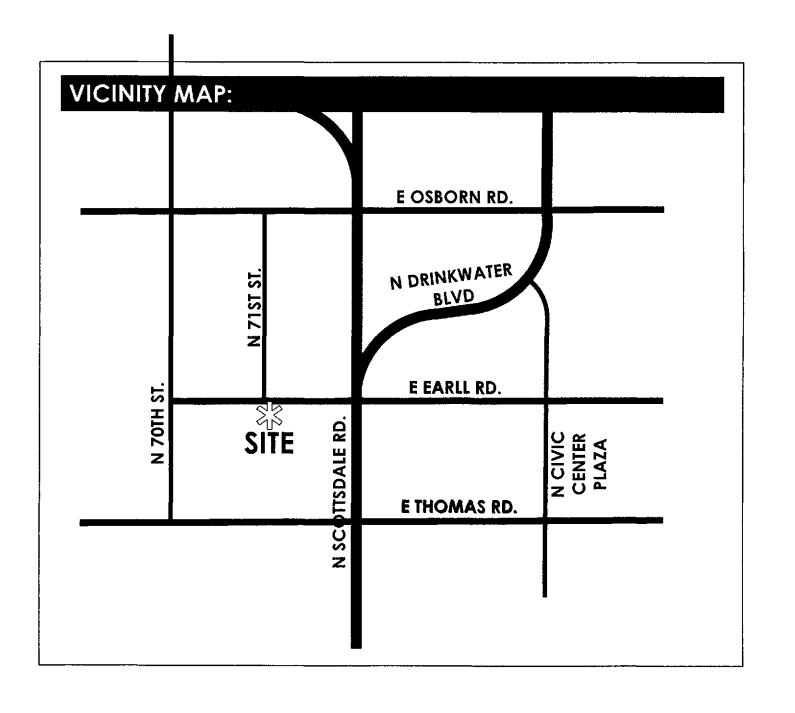




PLAN REVIEW 6910-15-5 | PRELIMINARY PLAT 4-PP-2015 | ZONING 12-ZN-2015 | ABANDONMENT 6-AB-2015 | THEME WALL 6910-15-8 | AMENITY 6910-15-7 | POOL 3977-1




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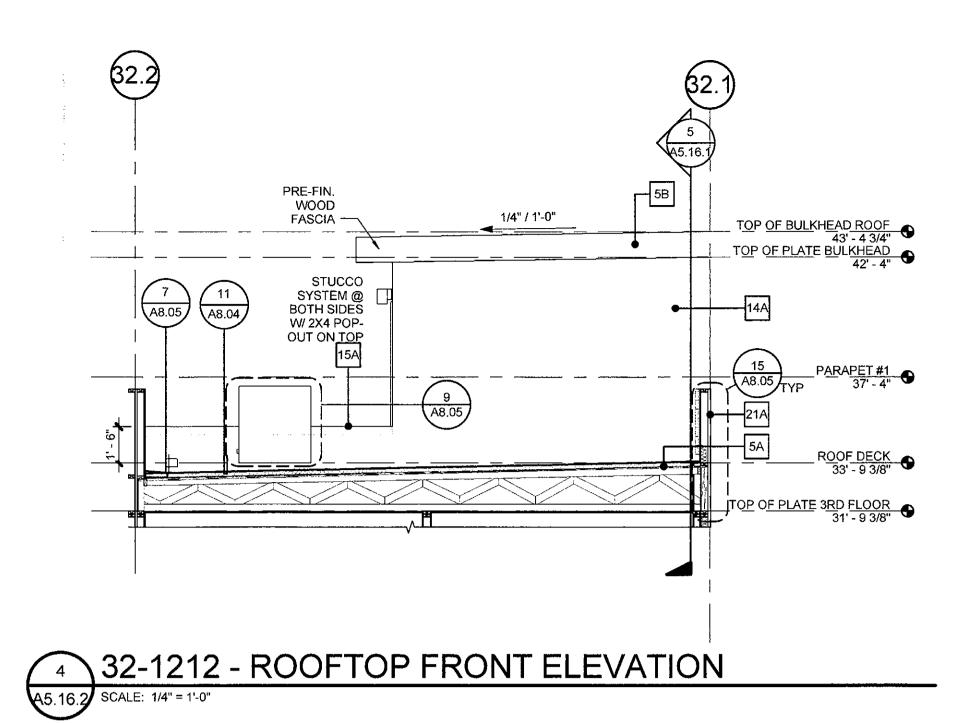
GALLERY - 7107 EARLL DR.




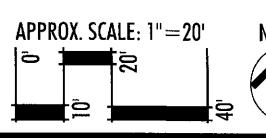

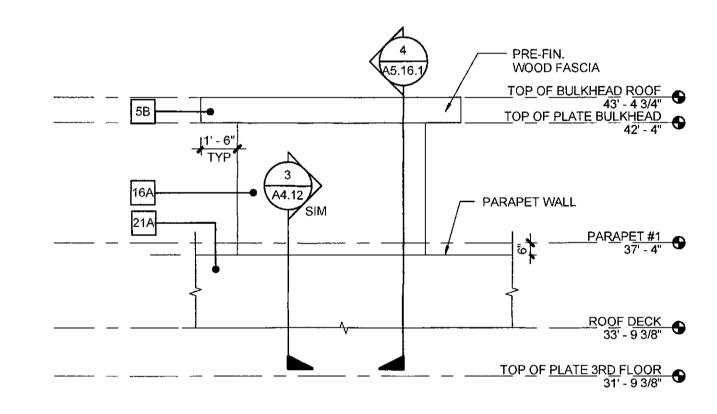


6 32-1212 - ROOFTOP RIGHT SIDE ELEV 45.16.2 SCALE: 1/4" = 1'-0"



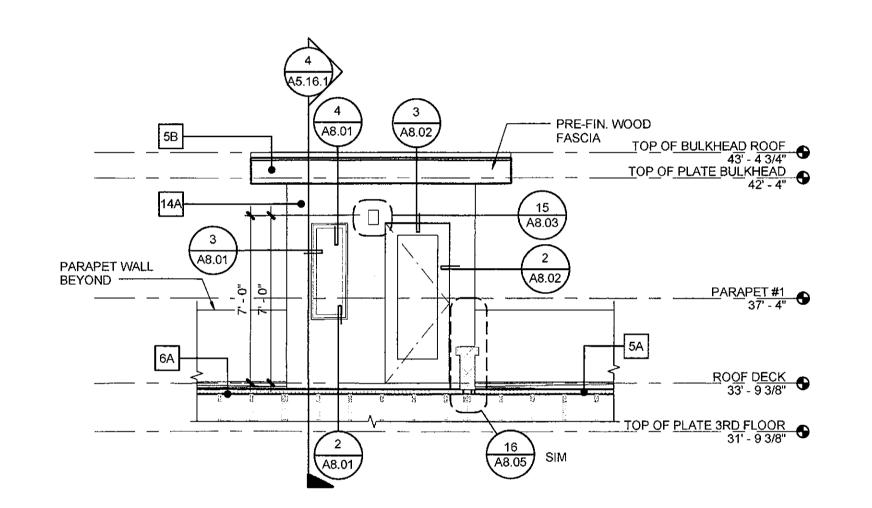

5 32-1212 - ROOFTOP LEFT SIDE ELEV A5.16.2 SCALE: 1/4" = 1'-0"

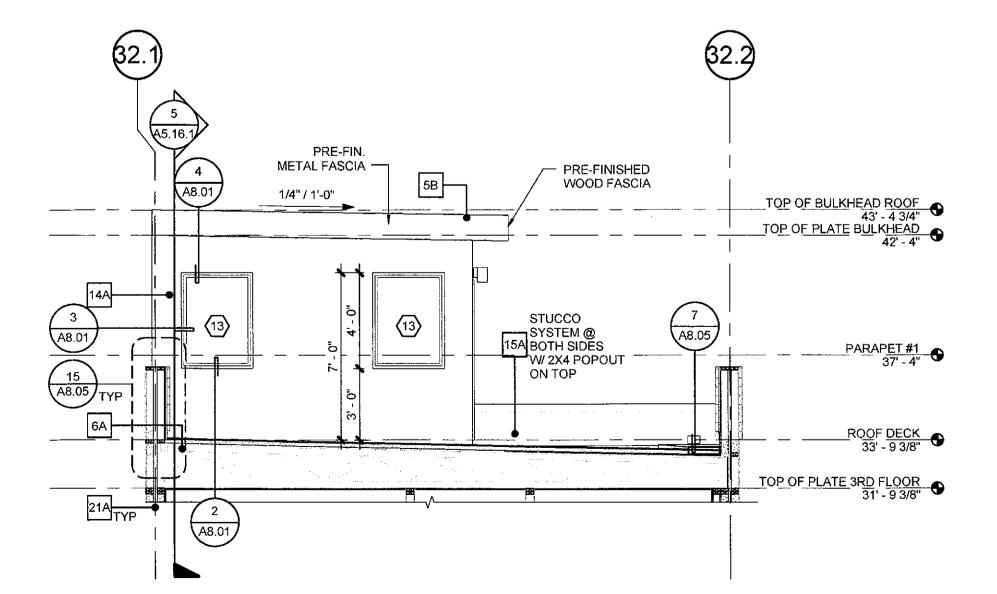

7 32-1212 - ROOFTOP REAR ELEVATION
A5.16.2 SCALE: 1/4" = 1'-0"

ELEVATION NOTES

- 1 SEE BUILDING FLOOR PLANS FOR WINDOW AND DOOR
- 2 SEE THE SHEET A1.11 FOR WINDOW AND DOOR SCHEDULES.
- 3 SIDING TYPE, REVEALS & BUILDING COLORS SHALL RAP AROUND CORNERS INTO RECESSED AREAS UNLESS OTHERWISE NOTED.
- 4 SEE 5/8.01 FOR TYPICAL SEALANT JOINTS.
- 5 SEE 3/8.05 FOR TYPICAL ROOF PENETRATIONS.
- 6 SEE 15/8.03 FOR DETAILS AT ELECTRICAL LIGHTS, COMMUNICATION PANEL AND EQUIPMENT.
- 7 SEE 17, 18 & 19/8.03 FOR SADDLE FLASHING DETAILS AS
- 8 SEE 1 & 16/8.03 FOR PLUMBING, ELECTRICAL AND MECHANICAL PENETRATIONS.
- 9 SEE 17/A8.01 FOR OPENING WEATHER WRAP DETAILS.

ELEVATION LEGEND

AMERIMIX FIBER BASE COAT STUCCO SYSTEM OR APPROVED EQUAL. COLOR: SW 7551 GREEK VILLA

AMERIMIX FIBER BASE COAT STUCCO SYSTEM
OR APPROVED EQUAL. COLOR: SW 7048 URBAN
BRONZE

COLOR: SW 6990 CAVIAR

STONE VENEER FINISH: CORONADO 3" SPLIT LIMESTONE GENOA SANDS

PREMANUFACTURED VERTICAL SUNSHADE

FASCIA COLOR: SW 6990 CAVIAR

ENTRY COLOR: SW 6990 CAVIAR DOOR

GARAGE COLOR: SW 6990 CAVIAR

LIGHT FIXTURE: COLOR: SW 6990 CAVIAR



MINIMUM BUILDING REQUIREMENTS FOR THE EXTERIOR ENVELOPE FOR NOISE LEVEL REDUCTION

MINIMUM BUILDING REQUIREMENTS FOR NOISE LEVEL REDUCTION OF WALLS PARALLEL AND ADJACENT TO THE EASTERN PROPERTY LINE.

1. EXTERIOR WALLS:

A STUD WALLS SHALL BE AT LEAST FOUR INCHES IN

- A. STUD WALLS:

 A. STUD WALLS SHALL BE AT LEAST FOUR INCHES IN NOMINAL DEPTH AND SHALL BE FINISHED ON THE EXTERIOR SIDE WITH STUCCO, SIDING, OR VENEER.

 B. INTERIOR SURFACE OF THE EXTERIOR WALLS
- B. INTERIOR SURFACE OF THE EXTERIOR WALLS
 SHALL BE MINIMUM ½" GYPSUM, INSTALLED ON TI
 STUDS.
 C. SHEATHING PANELS, WHERE APPLICABLE, SHALL
- BE BUTTED TIGHTLY AND COVERED ON THE EXTERIOR WITH OVERLAPPING BUILDING PAPER.

 D. INSULATION MATERIAL AT LEAST 3" THICK SHALL BE INSTALLED THROUGHOUT AND BETWEEN WALL STUDS
- A. WINDOWS SHALL HAVE A SOUND TRANSMISSION CLASS RATING OF STC-30 OR LOWER.

 B. ALL GLAZING SHALL BE DUAL PANED WITH OVERALL THICKNESS OF 3/2"

THICKNESS OF %".

C. ALL OPERABLE WINDOW GLAZING SHALL BE WEATHER-STRIPPED AND AIRTIGHT.



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Gallery Townhome

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20830 N Tatum Blvd Suite 250 Phoenix, AZ 85050



32-1212 Plan Options

2 08/02/16 CITY COMMENTS 1 06/08/16 REVISIONS # Date Description

1 06/08/16 REVISIONS

Date Description

Revisions

Revisions

March 11, 2016

March 11, 2016

Date

PP


Designed By
Author
Drawn By

PP Checked By 17736

Project Number
A5.16.2

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ELEVATION NOTES

- 1 SEE BUILDING FLOOR PLANS FOR WINDOW AND DOOR
- 2 SEE THE SHEET A1.11 FOR WINDOW AND DOOR SCHEDULES.
- 3 SIDING TYPE, REVEALS & BUILDING COLORS SHALL RAP AROUND CORNERS INTO RECESSED AREAS UNLESS OTHERWISE NOTED.
- 4 SEE 5/8.01 FOR TYPICAL SEALANT JOINTS.
- 5 SEE 3/8.05 FOR TYPICAL ROOF PENETRATIONS.
- 6 SEE 15/8.03 FOR DETAILS AT ELECTRICAL LIGHTS, COMMUNICATION PANEL AND EQUIPMENT.
- 7 SEE 17, 18 & 19/8.03 FOR SADDLE FLASHING DETAILS AS
- 8 SEE 1 & 16/8.03 FOR PLUMBING, ELECTRICAL AND MECHANICAL PENETRATIONS.
- 9 SEE 17/A8.01 FOR OPENING WEATHER WRAP DETAILS.

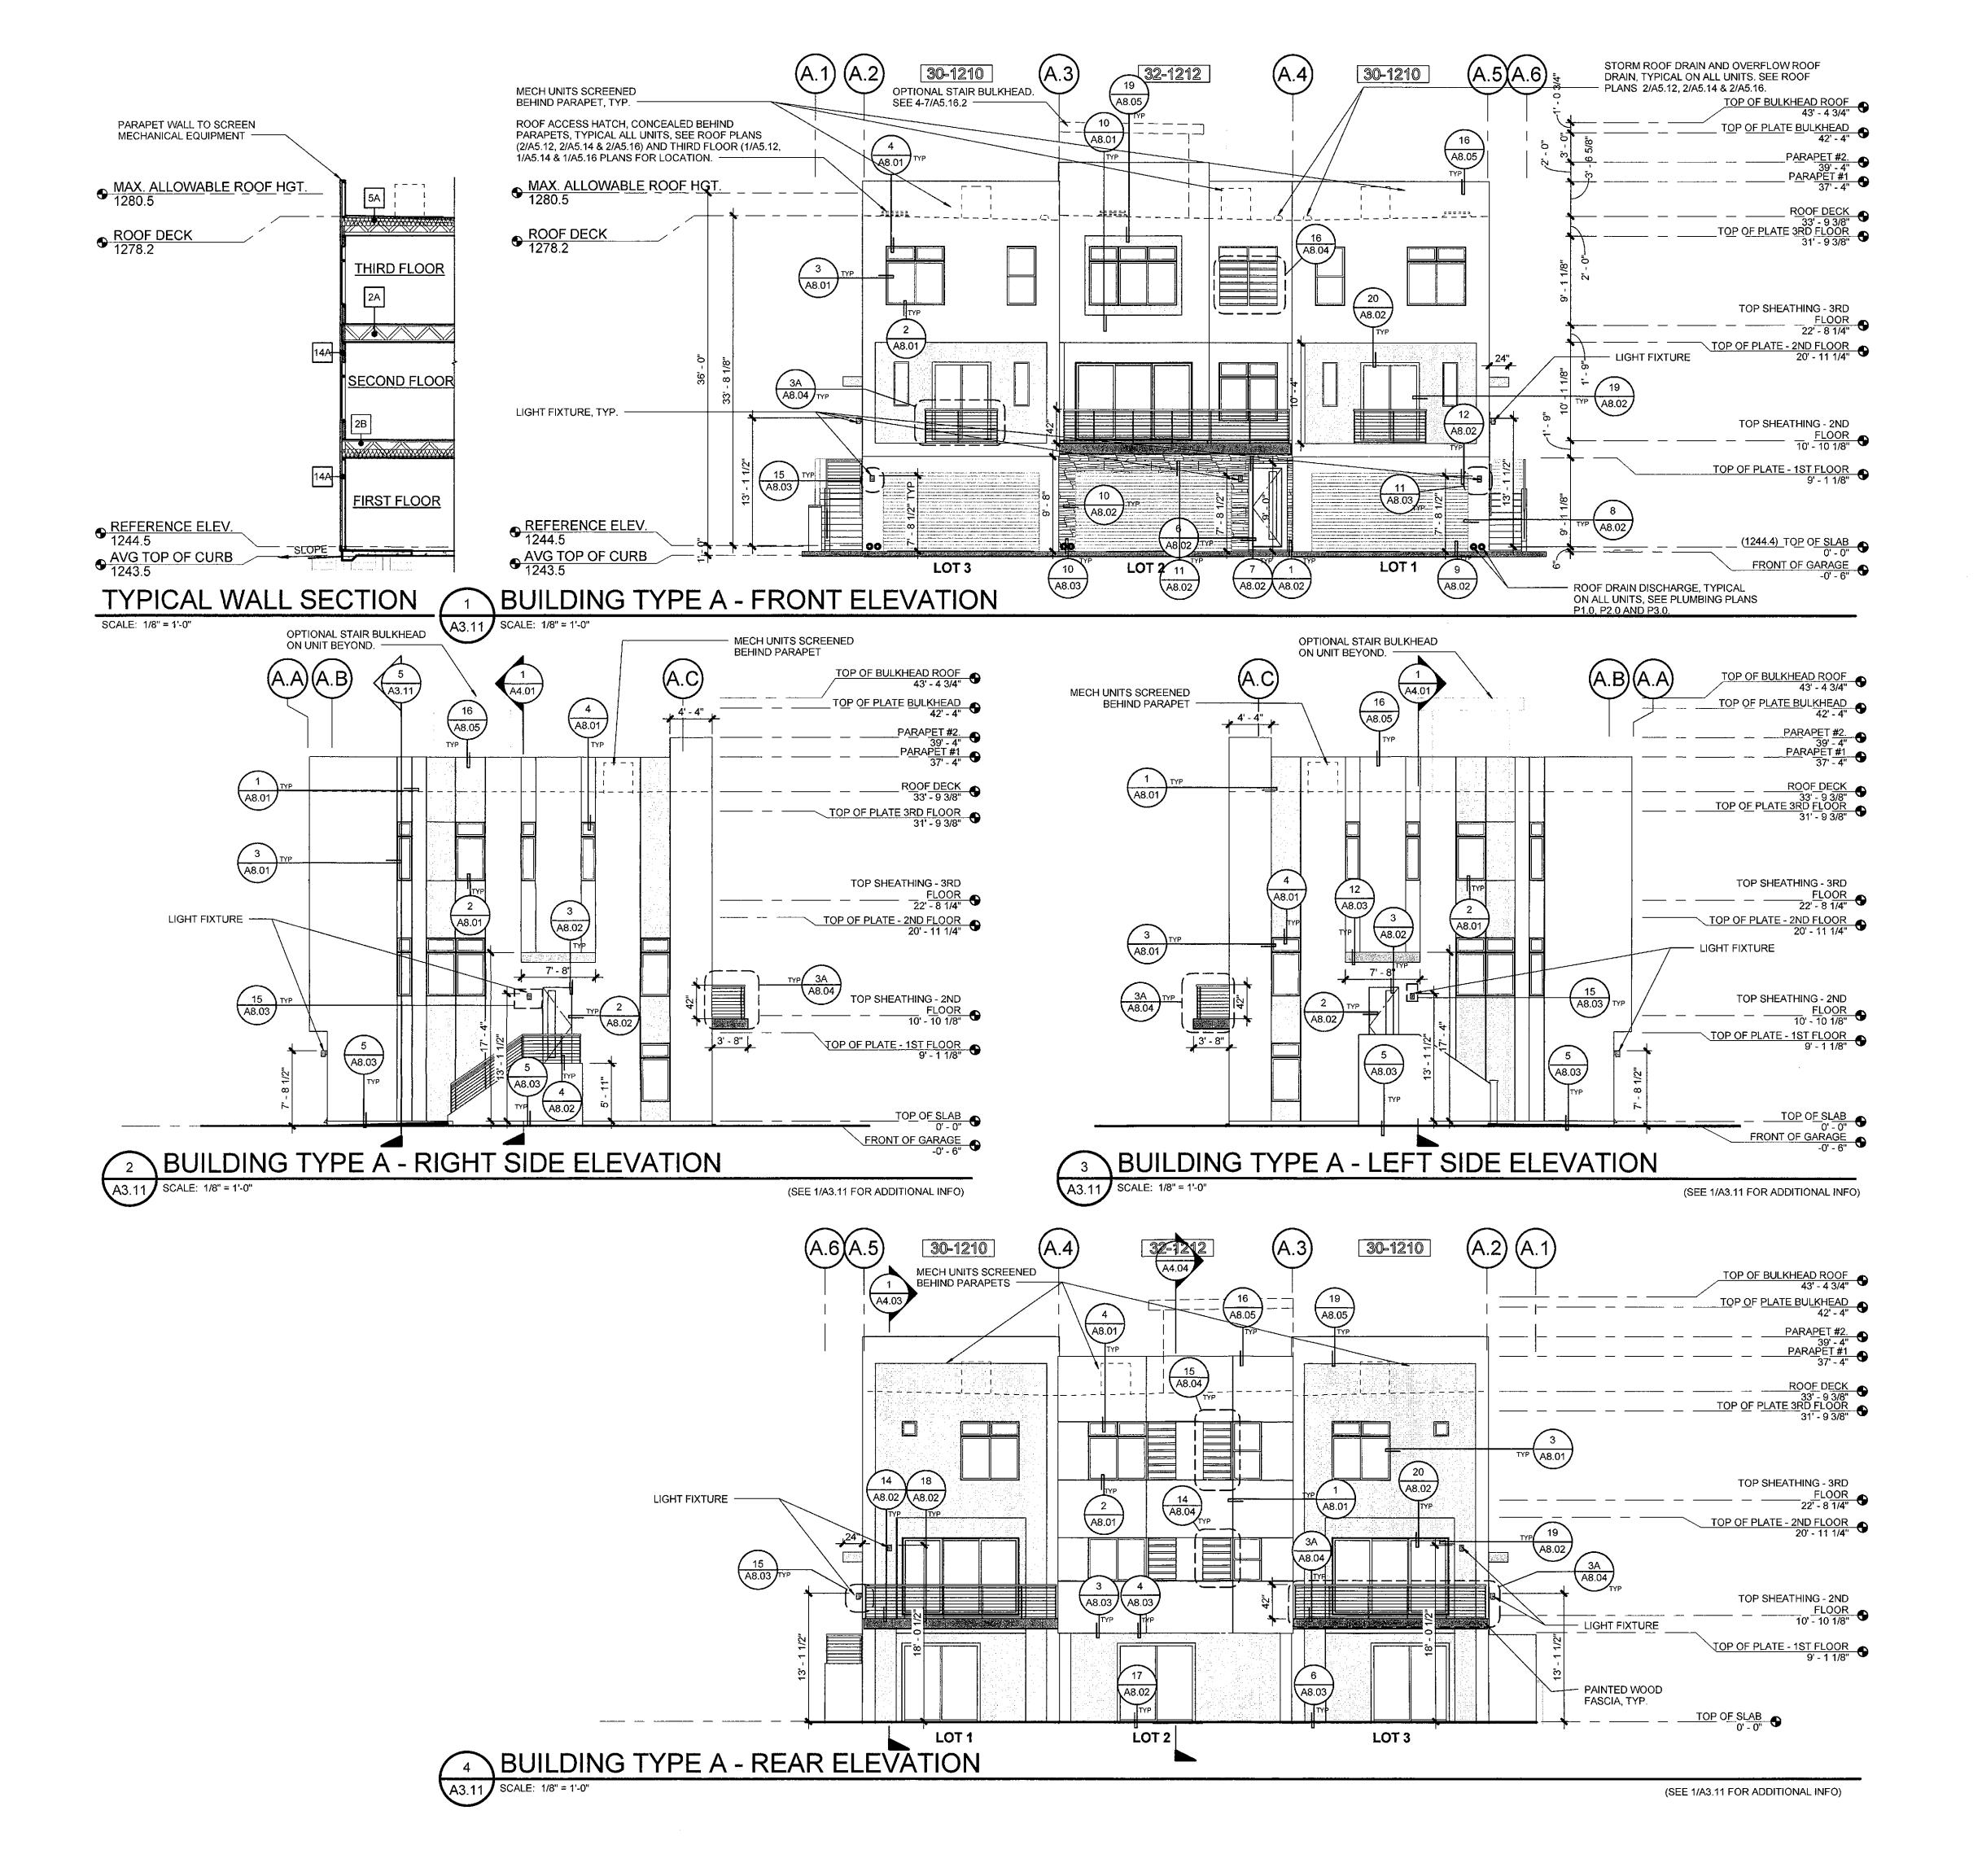ELEVATION LEGEND

AMERIMIX FIBER BASE COAT STUCCO SYSTEM OR APPROVED EQUAL. COLOR: SW 7551 GREEK

AMERIMIX FIBER BASE COAT STUCCO SYSTEM OR APPROVED EQUAL. COLOR: SW 7048 URBAN

STONE VENEER FINISH: CORONADO 3" SPLIT

LIMESTONE GENOA SANDS PREMANUFACTURED

VERTICAL SUNSHADE

COLOR: SW 6990 CAVIAR

FASCIA COLOR: SW 6990 CAVIAR

> COLOR: SW 6990 CAVIAR DOOR

GARAGE COLOR: SW 6990 CAVIAR DOOR

LIGHT FIXTURE: COLOR: SW 6990 CAVIAR



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Exterior **Elevations** Building A, 3-Plex, Gallery Site #1

MINIMUM BUILDING REQUIREMENTS FOR THE EXTERIOR ENVELOPE FOR

NOISE LEVEL REDUCTION MINIMUM BUILDING REQUIREMENTS FOR NOISE LEVEL REDUCTION OF WALLS PARALLEL AND ADJACENT TO THE

- EASTERN PROPERTY LINE. EXTERIOR WALLS:

 A. STUD WALLS SHALL BE AT LEAST FOUR INCHES IN
- NOMINAL DEPTH AND SHALL BE FINISHED ON THE EXTERIOR SIDE WITH STUCCO, SIDING, OR VENEER. B. INTERIOR SURFACE OF THE EXTERIOR WALLS
- SHALL BE MINIMUM 1/2" GYPSUM, INSTALLED ON THE C. SHEATHING PANELS, WHERE APPLICABLE, SHALL
- BE BUTTED TIGHTLY AND COVERED ON THE EXTERIOR WITH OVERLAPPING BUILDING PAPER. D. INSULATION MATERIAL AT LEAST 3" THICK SHALL BE
- INSTALLED THROUGHOUT AND BETWEEN WALL STUDS.
- CLASS RATING OF STC-30 OR LOWER. B. ALL GLAZING SHALL BE DUAL PANED WITH OVERALL
- THICKNESS OF 3/4". C. ALL OPERABLE WINDOW GLAZING SHALL BE

WEATHER-STRIPPED AND AIRTIGHT.

17736 Project Number

Date

Revisions


Designed By

Drawn By

Checked By

Date

If this drawing is less than 24" x 36", it has

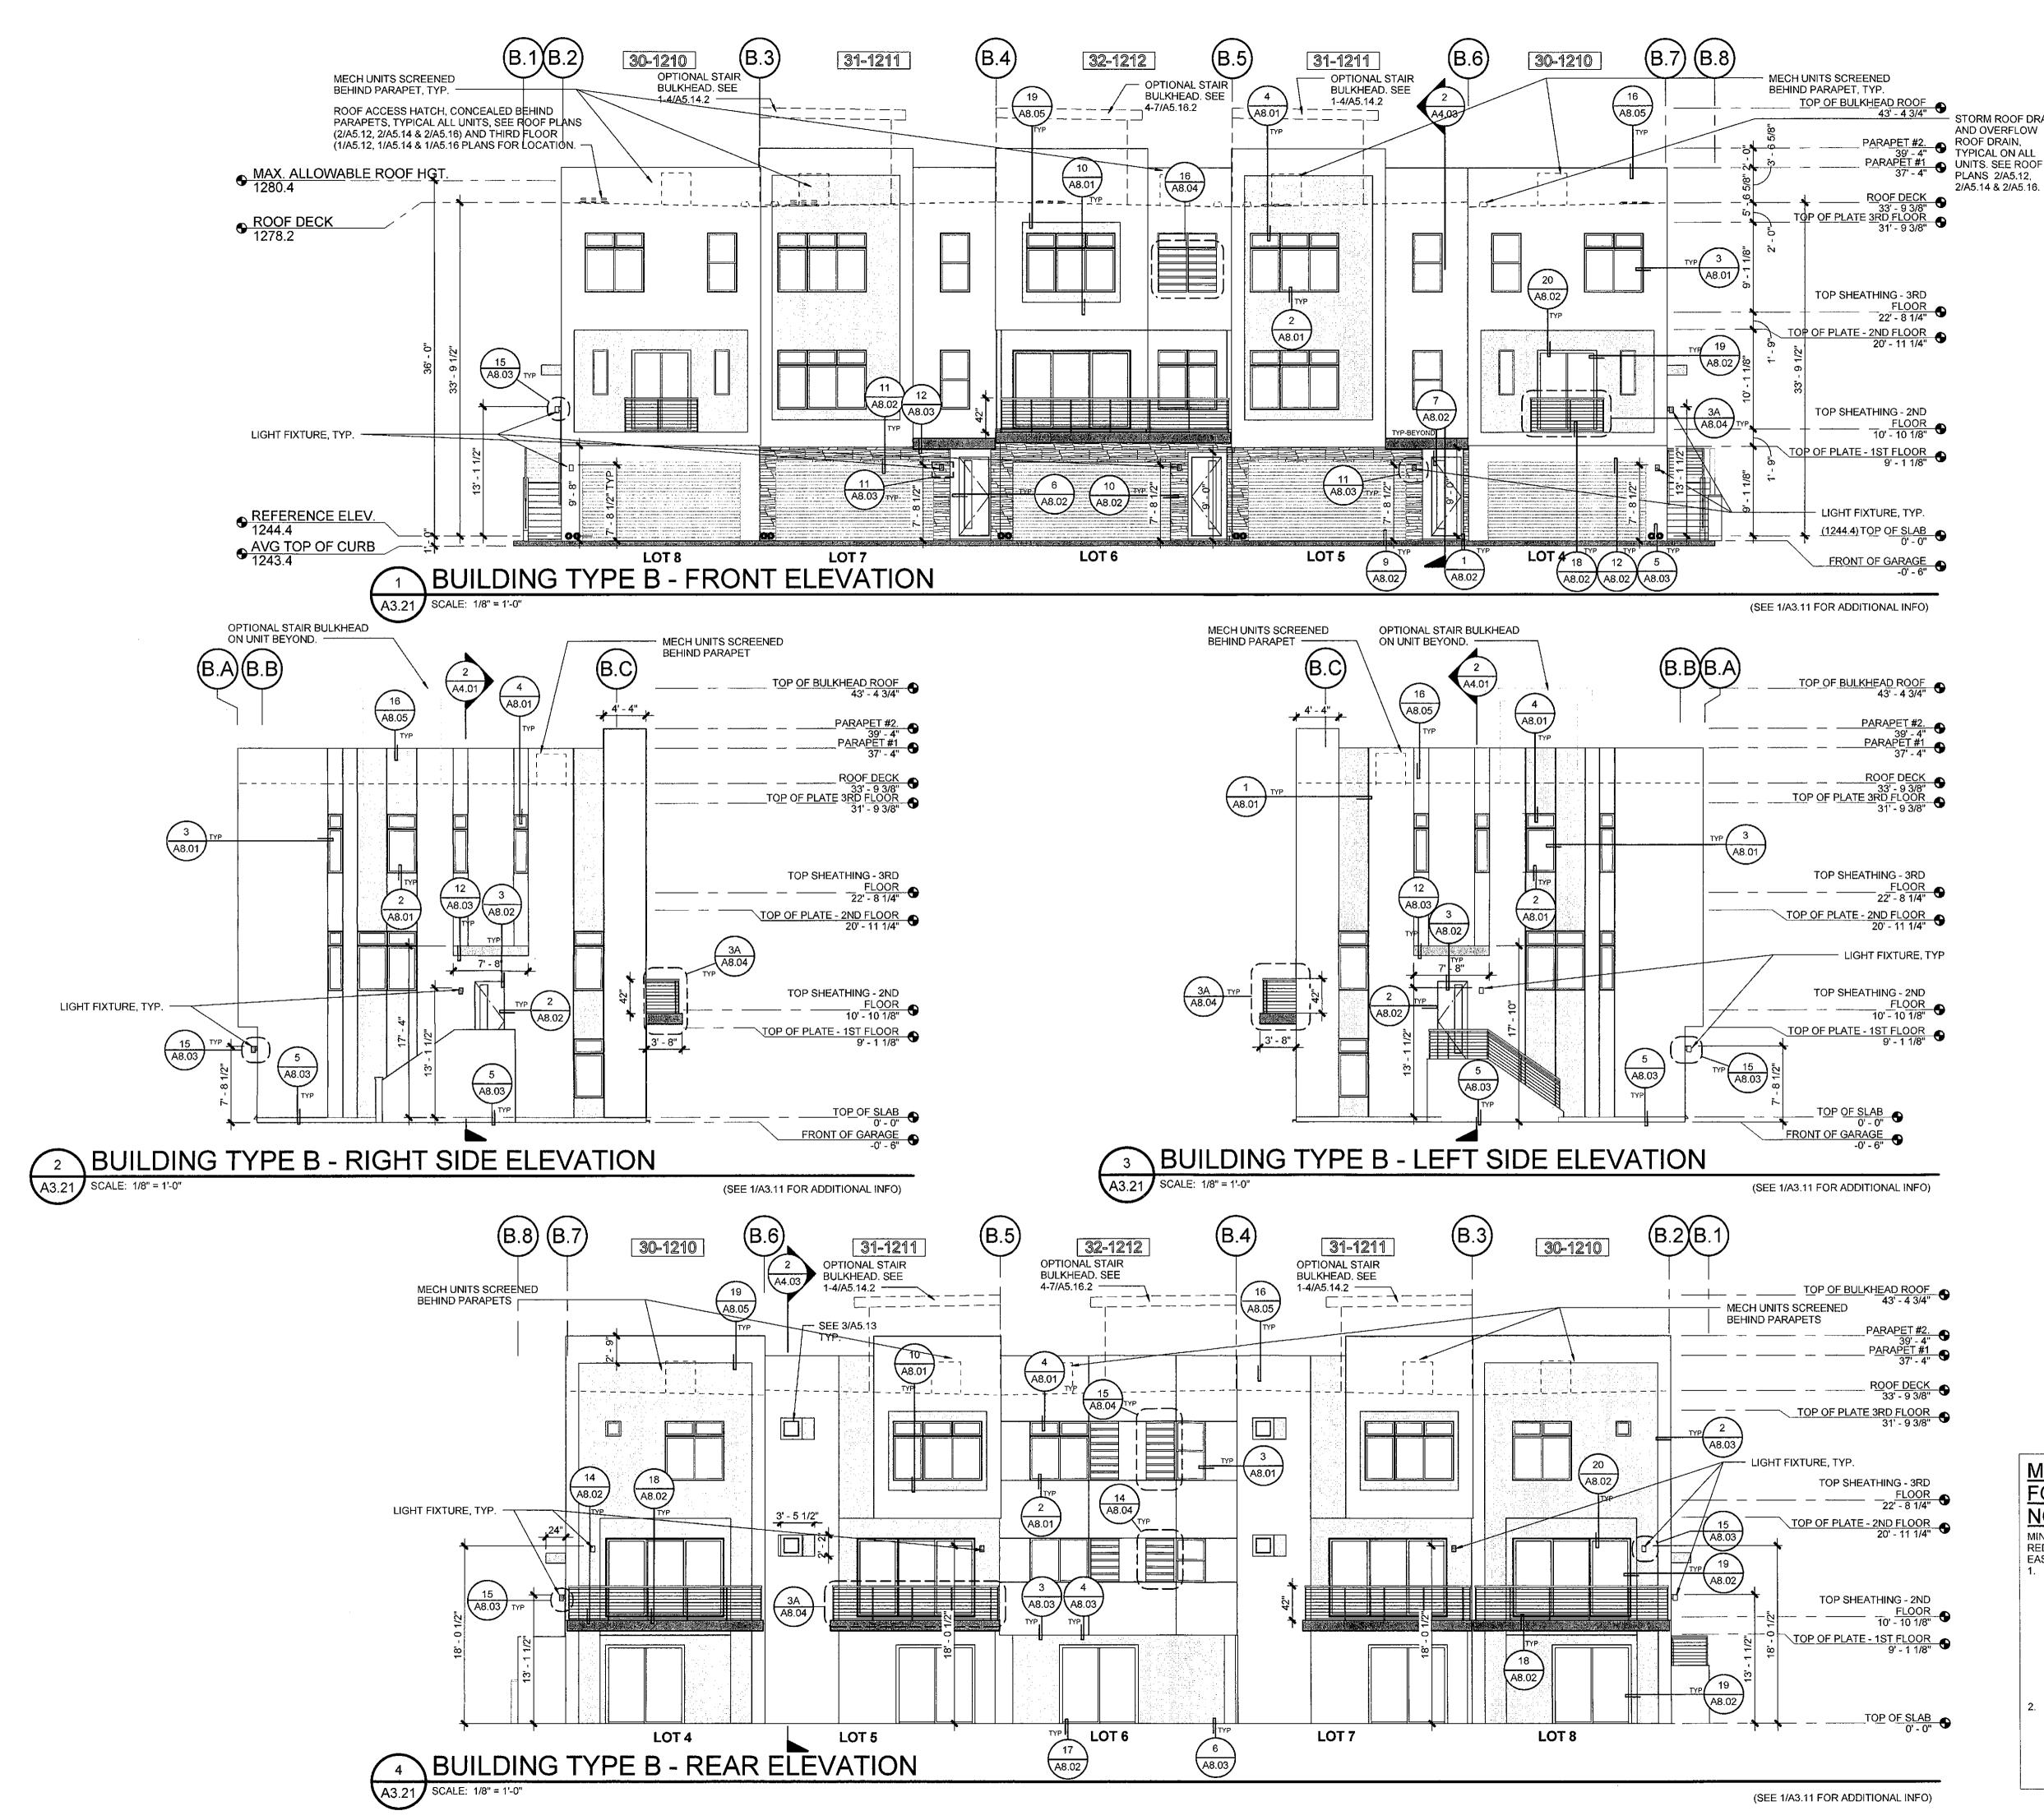


ELEVATION NOTES

- 1 SEE BUILDING FLOOR PLANS FOR WINDOW AND DOOR
- STORM ROOF DRAIN 2 SEE THE SHEET A1.11 FOR WINDOW AND DOOR SCHEDULES.
 - 3 SIDING TYPE, REVEALS & BUILDING COLORS SHALL RAP AROUND CORNERS INTO RECESSED AREAS UNLESS
 - OTHERWISE NOTED.
 - 4 SEE 5/8.01 FOR TYPICAL SEALANT JOINTS.
 - 5 SEE 3/8.05 FOR TYPICAL ROOF PENETRATIONS.
 - 6 SEE 15/8.03 FOR DETAILS AT ELECTRICAL LIGHTS. COMMUNICATION PANEL AND EQUIPMENT.
 - 7 SEE 17, 18 & 19/8.03 FOR SADDLE FLASHING DETAILS AS NEEDED.
 - 8 SEE 1 & 16/8.03 FOR PLUMBING, ELECTRICAL AND MECHANICAL PENETRATIONS.
 - 9 SEE 17/A8.01 FOR OPENING WEATHER WRAP DETAILS.

ELEVATION LEGEND

AMERIMIX FIBER BASE COAT STUCCO SYSTEM OR APPROVED EQUAL. COLOR: SW 7551 GREEK

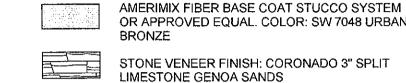

OR APPROVED EQUAL. COLOR: SW 7048 URBAN STONE VENEER FINISH: CORONADO 3" SPLIT



DOOR

VERTICAL SUNSHADE COLOR: SW 6990 CAVIAR

PREMANUFACTURED

FASCIA COLOR: SW 6990 CAVIAR

ENTRY COLOR: SW 6990 CAVIAR DOOR GARAGE COLOR: SW 6990 CAVIAR

LIGHT FIXTURE: COLOR: SW 6990 CAVIAR



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Exterior Elevations Building B, 5-Plex, Gallery Site #2

MINIMUM BUILDING REQUIREMENTS FOR THE EXTERIOR ENVELOPE FOR

NOISE LEVEL REDUCTION

MINIMUM BUILDING REQUIREMENTS FOR NOISE LEVEL REDUCTION OF WALLS PARALLEL AND ADJACENT TO THE EASTERN PROPERTY LINE.

- A. STUD WALLS SHALL BE AT LEAST FOUR INCHES IN NOMINAL DEPTH AND SHALL BE FINISHED ON THE EXTERIOR SIDE WITH STUCCO, SIDING, OR VENEER.
- B. INTERIOR SURFACE OF THE EXTERIOR WALLS SHALL BE MINIMUM 1/2" GYPSUM, INSTALLED ON THE
- C. SHEATHING PANELS, WHERE APPLICABLE, SHALI BE BUTTED TIGHTLY AND COVERED ON THE EXTERIOR WITH OVERLAPPING BUILDING PAPER. D. INSULATION MATERIAL AT LEAST 3" THICK SHALL BE
- INSTALLED THROUGHOUT AND BETWEEN WALL STUDS.
- CLASS RATING OF STC-30 OR LOWER. B. ALL GLAZING SHALL BE DUAL PANED WITH OVERALL
- THICKNESS OF 34". C. ALL OPERABLE WINDOW GLAZING SHALL BE WEATHER-STRIPPED AND AIRTIGHT.

Project Number A. WINDOWS SHALL HAVE A SOUND TRANSMISSION

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Date

Author

17736

LOT 16

31-1211

30-1210

LOT 14

BUILDING TYPE C - REAR ELEVATION

A3.31 SCALE: 1/8" = 1'-0"

LOT 15

32-1212

ELEVATION NOTES

30-1210

32-1212

- 1 SEE BUILDING FLOOR PLANS FOR WINDOW AND DOOR
- 2 SEE THE SHEET A1.11 FOR WINDOW AND DOOR SCHEDULES.
- SIDING TYPE, REVEALS & BUILDING COLORS SHALL RAP AROUND CORNERS INTO RECESSED AREAS UNLESS
- OTHERWISE NOTED.
- SEE 5/8.01 FOR TYPICAL SEALANT JOINTS.
- 5 SEE 3/8.05 FOR TYPICAL ROOF PENETRATIONS.
- 6 SEE 15/8.03 FOR DETAILS AT ELECTRICAL LIGHTS, COMMUNICATION PANEL AND EQUIPMENT.
- 7 SEE 17, 18 & 19/8.03 FOR SADDLE FLASHING DETAILS AS NEEDED.
- 8 SEE 1 & 16/8.03 FOR PLUMBING, ELECTRICAL AND MECHANICAL PENETRATIONS.
- 9 SEE 17/A8.01 FOR OPENING WEATHER WRAP DETAILS.

ELEVATION LEGEND

AMERIMIX FIBER BASE COAT STUCCO SYSTEM OR APPROVED EQUAL. COLOR: SW 7551 GREEK

AMERIMIX FIBER BASE COAT STUCCO SYSTEM OR APPROVED EQUAL. COLOR: SW 7048 URBAN

PREMANUFACTURED

VERTICAL SUNSHADE

STONE VENEER FINISH: CORONADO 3" SPLIT LIMESTONE GENOA SANDS

COLOR: SW 6990 CAVIAR COLOR: SW 6990 CAVIAR FASCIA

> ENTRY COLOR: SW 6990 CAVIAR DOOR

GARAGE COLOR: SW 6990 CAVIAR DOOR

LIGHT FIXTURE: COLOR: SW 6990 CAVIAR

NOMINAL DEPTH AND SHALL BE FINISHED ON THE

EXTERIOR WITH OVERLAPPING BUILDING PAPER

INSTALLED THROUGHOUT AND BETWEEN WALL STUDS.

C. SHEATHING PANELS, WHERE APPLICABLE, SHALL BE BUTTED TIGHTLY AND COVERED ON THE

A. WINDOWS SHALL HAVE A SOUND TRANSMISSION CLASS RATING OF STC-30 OR LOWER.

C. ALL OPERABLE WINDOW GLAZING SHALL BE WEATHER-STRIPPED AND AIRTIGHT.

THICKNESS OF 34".

D. INSULATION MATERIAL AT LEAST 3" THICK SHALL BE

B. ALL GLAZING SHAŁL BE DUAL PANED WITH OVERALL

--- LIGHT FIXTURE, TYP

(SEE 1/A3.11 FOR ADDITIONAL INFO)

A8.02

LOT 18

LOT 17

6 A8.03

(17) (A8.02)

EXTERIOR SIDE WITH STUCCO, SIDING, OR VENEER.



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Exterior Elevations Building C, 5-Plex, Gallery Site #3

MINIMUM BUILDING REQUIREMENTS FOR THE EXTERIOR ENVELOPE FOR

2 08/02/16 CITY COMMENTS 1 06/08/16 REVISIONS # Date Description

Revisions March 11, 2016

Designed By

Author Drawn By

Checked By 17736

Project Number

If this drawing is less than 24" x 36", it has been reduced. Scale accordingly.

ELEVATION NOTES

- 1 SEE BUILDING FLOOR PLANS FOR WINDOW AND DOOR
- 2 SEE THE SHEET A1.11 FOR WINDOW AND DOOR SCHEDULES.
- 3 SIDING TYPE, REVEALS & BUILDING COLORS SHALL RAP AROUND CORNERS INTO RECESSED AREAS UNLESS
- 4 SEE 5/8.01 FOR TYPICAL SEALANT JOINTS.

OTHERWISE NOTED.

5 SEE 3/8.05 FOR TYPICAL ROOF PENETRATIONS.

COMMUNICATION PANEL AND EQUIPMENT.

- 6 SEE 15/8.03 FOR DETAILS AT ELECTRICAL LIGHTS,
- 7 SEE 17, 18 & 19/8.03 FOR SADDLE FLASHING DETAILS AS NEEDED.
- 8 SEE 1 & 16/8.03 FOR PLUMBING, ELECTRICAL AND MECHANICAL PENETRATIONS.
- 9 SEE 17/A8.01 FOR OPENING WEATHER WRAP DETAILS.

ELEVATION LEGEND

AMERIMIX FIBER BASE COAT STUCCO SYSTEM OR APPROVED EQUAL, COLOR: SW 7551 GREEK AMERIMIX FIBER BASE COAT STUCCO SYSTEM

OR APPROVED EQUAL. COLOR: SW 7048 URBAN

STONE VENEER FINISH: CORONADO 3" SPLIT LIMESTONE GENOA SANDS

PREMANUFACTURED VERTICAL SUNSHADE COLOR: SW 6990 CAVIAR

COLOR: SW 6990 CAVIAR FASCIA

DOOR

COLOR: SW 6990 CAVIAR DOOR GARAGE COLOR: SW 6990 CAVIAR

LIGHT FIXTURE: COLOR: SW 6990 CAVIAR



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Exterior Elevations Building D, 5-Plex, Gallery Site #4

MINIMUM BUILDING REQUIREMENTS FOR THE EXTERIOR ENVELOPE FOR

NOISE LEVEL REDUCTION MINIMUM BUILDING REQUIREMENTS FOR NOISE LEVEL REDUCTION OF WALLS PARALLEL AND ADJACENT TO THE

EASTERN PROPERTY LINE.

(SEE 1/A3.11 FOR ADDITIONAL INFO)

- EXTERIOR WALLS:
 A. STUD WALLS SHALL BE AT LEAST FOUR INCHES IN NOMINAL DEPTH AND SHALL BE FINISHED ON THE EXTERIOR SIDE WITH STUCCO, SIDING, OR VENEER. B. INTERIOR SURFACE OF THE EXTERIOR WALLS
- SHALL BE MINIMUM 1/2" GYPSUM, INSTALLED ON THE C. SHEATHING PANELS, WHERE APPLICABLE, SHALL
- BE BUTTED TIGHTLY AND COVERED ON THE EXTERIOR WITH OVERLAPPING BUILDING PAPER D. INSULATION MATERIAL AT LEAST 3" THICK SHALL BE INSTALLED THROUGHOUT AND BETWEEN WALL STUDS.
- CLASS RATING OF STC-30 OR LOWER. B. ALL GLAZING SHALL BE DUAL PANED WITH OVERALL
- THICKNESS OF 3/4". C. ALL OPERABLE WINDOW GLAZING SHALL BE WEATHER-STRIPPED AND AIRTIGHT.

2 08/02/16 CITY COMMENTS 1 06/08/16 REVISIONS Description # Date Revisions

March 11, 2016

Date

Designed By Author Drawn By

Checked By 17736

Project Number

If this drawing is less than 24" x 36", it has been reduced. Scale accordingly.

A3.41 SCALE: 1/8" = 1'-0"

LEGAL DESCRIPTION

PARCEL 1: A PORTION OF THE SOUTHEAST QUARTER OF THE SOUTHEAST QUARTER OF SECTION 27, TOWNSHIP 2 NORTH, RANGE 4 EAST, OF THE GILA AND SALT RIVER BASE AND MERIDIAN, MARICOPA COUNTY, ARIZONA, COMMENCING AT THE NORTHEAST CORNER OF SAID SOUTHEAST QUARTER OF THE SOUTHEAST QUARTER, A CITY OF SCOTTSDALE BRASS CAP HANDHOLE, FROM WHICH THE NORTHWEST CORNER THEREOF A CITY OF SCOTTSDALE BRASS CAP FLUSH, BEARS SOUTH 89 DEGREES 10 MINUTES 30 SECONDS WEST (BASIS OF BEARINGS) ALONG THE MONUMENT LINE OF EARLL DRIVE, A DISTANCE OF 1310.75 FEET; HENCE SOUTH 89 DEGREES 10 MINUTES 30 SECONDS WEST ALONG THE NORTH LINE OF THE SOUTHEAST QUARTER OF THE SOUTHEAST QUARTER OF SAID SECTION 27, A DISTANCE OF 510.07 FEET; THENCE LEAVING SAID NORTH LINE, SOUTH 00 DEGREES 02 MINUTES 06 SECONDS WEST, A DISTANCE OF 20.00 FEET, TO A POINT ON THE SOUTHERLY RIGHT-OF-WAY LINE OF EARLL DRIVE, ALSO BEING THE POINT OF BEGINNING; THENCE CONTINUING SOUTH 00 DEGREES 02 MINUTES 06 SECONDS WEST, ALONG THE WEST LINE OF THE EAST 121.81 FEET OF OLENE PLACE AS RECORDED IN THE BOOK 48 OF MAPS, PAGE 5. MCR. A DISTANCE OF 238.44 FEET TO THE NORTH LINE OF THE SOUTH 80 FEET OF SAID OLENE PLACE; THENCE SOUTH 89 DEGREES 11 MINUTES 08 SECONDS WEST ALONG SAID NORTH LINE, A DISTANCE OF 151.80 FEET; THENCE NORTH 00 DEGREES 02 MINUTES 06 SECONDS EAST LEAVING SAID NORTH LINE, A DISTANCE OF 228.41 FEET TO THE SOUTH RIGHT OF WAY LINE OF EARLL DRIVE: THENCE NORTH 89 DEGREES 10 MINUTES 30 SECONDS EAST ALONG SAID RIGHT-OF-WAY, A DISTANCE 127.63 FEET; THENCE NORTH 00 DEGREES 00 MINUTES 15 SECONDS EAST ALONG SAID RIGHT-OF-WAY, A DISTANCE OF 10.00 FEET; THENCE NORTH 89 DEGREES 10 MINUTES 15 SECONDS EAST ALONG SAID RIGHT-OF-WAY LINE, A DISTANCE OF 24.18 FEET TO THE POINT

PARCEL 2: THE WEST 30.00 FEET OF THE SOUTH 80.00 FEET OF OLENE PLACE, ACCORDING TO THE PLAT OF RECORD IN THE COUNTY RECORDER OF MARICOPA COUNTY, ARIZONA, RECORDED AS BOOK 48 OF MAPS, PAGE 5.

PARCEL 3: THE SOUTH 80.00 FEET OF THE OLENE PLACE, ACCORDING TO THE PLAT OF RECORD IN THE COUNTY RECORDER OF MARICOPA, ARIZONA, RECORDED AS BOOK 48 OF MAPS, PAGE 5, AND THAT PORTION OF MARSHALL AVENUE ABANDONED BY RESOLUTION RECORDED IN INSTRUMENT NO. 84-0493240, RECORDS OF MARICOPA COUNTY, ARIZONA; EXCEPT THE EAST 121.81 FEET OF SAID OLENE PLACE; EXCEPT THE WEST 30.00 FEET OF SAID

SITE PLAN- PLANNING NOTES **COMMERCIAL & MULTI-FAMILY**

1. SIGHT DISTANCE TRIANGLES SHALL BE SHOWN ON FINAL PLANS FOR DRIVEWAYS FROM COMMERCIAL SITES AND ANY INTERSECTIONS. AREA WITHIN THE SAFETY TRIANGLE IS TO BE CLEAR OF LANDSCAPING, SIGNS, OR OTHER VISIBILITY OBSTRUCTIONS WITH A HEIGHT GREATER THAN 1.5 FEET. TREES WITHIN THE SAFETY TRIANGLE SHALL BE SINGLE TRUNK AND HAVE A CANOPY THAT BEGINS AT 8 FEET IN HEIGHT UPON INSTALLATION.

2. ALL HEIGHTS ARE MEASURED FROM NEAREST STREET LINE ELEVATION.

3. TEMPORARY/SECURITY FENCING THAT IS REQUIRED OR IS OPTIONALLY PROVIDED SHALL BE IN ACCORDANCE WITH THE ZONING ORDINANCE AND THE DESIGN STANDARDS AND POLICIES MANUAL.

4. THE TEMPORARY/SECURITY FENCE LOCATION SHALL NOT BE MODIFIED OR THE TEMPORARY/SECURITY FENCE SHALL NOT BE REMOVED WITHOUT THE APPROVAL OF THE PLANNING AND DEVELOPMENT SERVICES' INSPECTION SERVICES DIVISION.

5. ALL RIGHTS-OF-WAY ADJACENT TO THIS PROPERTY SHALL BE LANDSCAPED AND MAINTAINED BY THE PROPERTY OWNER.

6. ALL SIGNS REQUIRE SEPARATE PERMITS AND APPROVALS.

7. A MASTER SIGN PROGRAM SHALL BE SUBJECT TO THE APPROVED OF THE DEVELOPMENT REVIEW BOARD PRIOR TO THE ISSUANCE OF A SIGN PERMIT FOR MULTI-TENANT BUILDINGS.

- 8. NO EXTERIOR VENDING OR DISPLAY SHALL BE ALLOWED.
- 9. FLAGPOLES, IF PROVIDED, SHALL BE ONE PIECE CONICAL TAPERED.
- 10. NO EXTERIOR PUBLIC ADDRESS OR SPEAKER SYSTEM SHALL BE ALLOWED.

11. PATIO UMBRELLAS, IF PROVIDED, SHALL BE SOLID COLORS AND SHALL NOT HAVE ANY ADVERTISING IN THE FORM OF SIGNAGE OR LOGOS.

12. ALL EXTERIOR MECHANICAL, UTILITY AND COMMUNICATION EQUIPMENT SHALL BE SCREENED TO THE HEIGHT OF THE TALLEST UNIT BY PARAPET OR SCREEN WALL THAT MATCHES THE ARCHITECTURAL COLOR AND ARCHITECTURAL FINISH OF THE BUILDING GROUND MOUNTED MECHANICAL, UTILITY AND COMMUNICATION EQUIPMENT SHALL BE SCREENED BY A SCREEN WALL THAT MATCHES THE ARCHITECTURAL COLOR AND ARCHITECTURAL FINISH OF THE BUILDING, WHICH IS A MINIMUM OF 1'-0" HIGHER THAN THE HIGHEST POINT OF TALLEST UNIT. (DETAILS ARE STILL REQUIRED).

13. ALL EQUIPMENT, UTILITIES, OR OTHER APPURTENANCES ATTACHED TO THE BUILDING MASONRY WALL/FENCE PER SHALL BE AN INTEGRAL PART OF THE BUILDING DESIGN IN TERMS OF FORM, COLOR AND

14. NO EXTERIOR VISIBLE LADDERS SHALL BE ALLOWED.

15. ALL POLE-MOUNTED LIGHTING SHALL BE A MAXIMUM OF 20 FEET IN HEIGHT.

16. NO CHAIN LINK FENCING SHALL BE ALLOWED.

17. NO TURF AREAS SHALL BE PROVIDED.

18. NO IRRIGATION SHALL BE PROVIDED TO UNDISTURBED NATURAL AREA OPEN SPACE (NAOS) AREAS.

GENERAL NOTES

- 1. SEE CIVIL AND LANDSCAPE PLANS FOR ADDITIONAL INFORMATION.
- 2. ALL SIGNAGE TO BE SUBMITTED UNDER SEPARATE PERMIT.

RANGE MUST BE WITHIN 48" AND 28" AFF.

- 3. SEE ELECTRICAL AND PLUMBING DRAWINGS FOR UTILITY METER LOCATIONS.
- 4. SEE ELECTRICAL SITE LIGHTING PLANS FOR FIXTURE LAYOUT, CUT SHEETS AND PHOTOMETRICS.
- 5. BUILDING ADDRESS TO BE PROVIDED BY CITY. FINAL SITE PLAN WITH ADDRESS NOTED TO BE SUBMITTED TO CITY.
- 6. MAILBOXES MUST COMPLY WITH ADA REQUIREMENTS. CUSTOMER COMPARTMENT REACH
- MAILBOX SUPPLIER MUST VERIFY WITH US POSTAL SERVICE THAT MAILBOXES COMPLY WITH USPS REQUIREMENTS.

FIRE DEPARTMENT GENERAL NOTES

- 1. PREMISES IDENTIFICATION TO BE LEGIBLE FROM STREET OR DRIVE.
- 2. FIRE LANES AND EMERGENCY ACCESS SHALL BE PROVIDED AND MARKED IN COMPLIANCE WITH CITY ORDINANCE AND INTERNATIONAL FIRE CODE REQUIREMENTS.
- PROVIDE ALL WEATHER ACCESS ROADS (MINIMUM 16' IN WIDTH) TO ALL BUILDINGS AND HYDRANTS FROM PUBLIC WAY DURING CONSTRUCTION.
- 4. PROVIDE A KNOX ACCESS SYSTEM WITH KEY SWITCH AND PREEMPTION DEVICE OVERRIDE FOR AUTOMATIC GATES.
- 5. A FIRE SPRINKLER SYSTEM SHALL BE INSTALLED AND COMPLY WITH CURRENTLY ADOPTED NFPA STANDARDS.
- 6. FIRELINES, SPRINKLERS AND STANDPIPE SYSTEMS SHALL BE FLUSHED AND PRESSURE TESTED PER NFPA STANDARDS AND SCOTTSDALE REVISED CODES.

PROJECT DATA

130-17-001, 002, 003B, 004A, 004B, 004C, 005B, 007C, 008A & 009A PARCEL 1 + PARCEL 2 + PARCEL 3 7107 E. EARLL DRIVE, SCOTTSDALE AZ 85251

PROPOSED # OF LOTS: 18 GROSS ACRES

PARCELS:

ZONING:

ADDRESS:

53,054 SQ FT (1.2 ACRES) **NET ACRES:** 47,916 SQ FT (1.1 ACRES) ON-SITE IMPERVIOUS (BUILDINGS): 15.155 SF (.35 ACRES) ON-SITE IMPERVIOUS (ROADS, WALKS) 37,899 SF (.87 ACRES)

REQUIRED <u>PROVIDED</u> VEHICLE PARKING: 2 SPACES/UNIT 2 SPACES/UNIT WITHIN GARAGE

(ALL OTHER PARKING TO BE OFFSITE) BICYCLE PARKING: 2 SPACES 1 RACK (36 VEHICLE SPACES < 40 = 2 BICYCLE SPACES)

(2 VEHICLE SPACES/UNIT @ 18 UNITS = 36 SPACES WITHIN GARAGE)

REQUIRED PROVIDED FRONTAGE OPEN SPACE 3040 SF (152 LF X 20 FT) 5,750 SF

10,296 SF (22% OF NET)

PRIVATE OPEN SPACE +/- 3,200 SF +/- 4,419 SF OCCUPANCY CLASSIFICATION: AUTOMATIC FIRE EXTINGUISHING SYSTEM: SPRINKLER SYSTEM PER NFPA 13D

BUILDING HEIGHT: NUMBER OF STORIES:

BUILDING DATA: GROSS FLOOR AREA: 43,486 SQ FT

COMMON OPEN SPACE

1 TOTAL BUILDING BUILDING 1 TYPE A 1 TOTAL BUILDING BUILDING 3 TYPE C NUMBER OF TOWNHOMES 3 NUMBER OF TOWNHOMES 5 CONSTRUCTION TYPE CONSTRUCTION TYPE NUMBER OF FLOORS NUMBER OF FLOORS 12,161 SF BUILDING AREA 7 001 SE BUILDING AREA **BUILDING HEIGHT*** 33' - 8 1/8" BUILDING HEIGHT* 33' - 9 1/2" BUILDING 2 TYPE B 1 TOTAL BUILDING BUILDING 4 TYPE D 1 TOTAL BUILDING NUMBER OF TOWNHOMES 5 NUMBER OF TOWNHOMES 5 CONSTRUCTION TYPE CONSTRUCTION TYPE NUMBER OF FLOORS NUMBER OF FLOORS BUILDING AREA 12,163 SF BUILDING AREA 12,161 SF BUILDING HEIGHT* **BUILDING HEIGHT*** 33' - 9 1/2" 33' - 9 1/2"

*BUILDING HEIGHT IS THE DISTANCE FROM A POINT OF REFERENCE 12" ABOVE THE AVERAGE ELEVATON OF THE CURB ADJACENT TO THE PROPERTY TO THE TOP OF THE ROOF DECK. ROOFTOP EQUIPMENT IS SCREENED BY A PARAPET ON TOP OF THE ROOF THAT

HAS BEEN DESIGNED TO BE INTEGRAL WITH THE BUILDING DESIGN. SEE


BUILDING ELEVATION SHEETS 3.11, 3.21, 3.31 & 3.41.

LEGEND

VEHICULAR PATH PEDESTRIAN PATH -----

15,763 (ALL NON-PRIVATE O/S)

VICINITY MAP

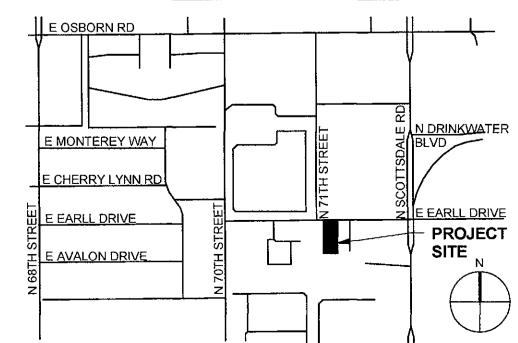

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Architectural Site Plan

2 08/02/16 CITY COMMENTS 1 06/08/16 REVISIONS Description

Date Revisions March 11, 2016

Date Designed By

Author Drawn By

Checked By

Copyright 2015 © If this drawing is less than 24" x 36", it has

been reduced. Scale accordingly,

ARCHITECTURAL SITE PLAN