
Full Size 8.5 x 11 11 x 17 (site plan, landscape, elevations)

ALTA/NSPS LAND TITLE SURVEY

0F

7676 E PINNACLE PEAK ROAD SCOTTSDALE, ARIZONA

BEING
THE WEST HALF OF THE SOUTHWEST QUARTER OF
THE SOUTHEAST QUARTER OF SECTION 11,
TOWNSHIP 4 NORTH, RANGE 4 EAST,
OF THE GILA AND SALT RIVER BASE AND MERIDIAN,
MARICOPA COUNTY, ARIZONA.

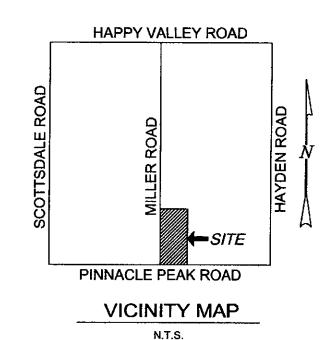

PARCEL DESCRIPTION

THE WEST HALF OF THE SOUTHWEST QUARTER OF THE SOUTHEAST QUARTER OF SECTION 11, TOWNSHIP 4 NORTH, RANGE 4 EAST OF THE GILA AND SALT RIVER BASE AND MERIDIAN, MARICOPA COUNTY, ARIZONA.

GENERAL NOTES

- 1. ALL TITLE INFORMATION IS BASED ON A COMMITMENT FOR TITLE INSURANCE PREPARED BY FIRST AMERICAN TITLE INSURANCE COMPANY, ORDER NO. NCS-850508-PHX1, WITH AN EFFECTIVE DATE OF MAY 11, 2017.
- 2. A.R.S. 32-151 STATES THAT THE USE OF THE WORD "CERTIFY" OR "CERTIFICATION" BY A PERSON OR FIRM THAT IS REGISTERED OR CERTIFIED BY THE BOARD IS AN EXPRESSION OF PROFESSIONAL OPINION REGARDING THE FACTS OR FINDINGS THAT ARE SUBJECT TO THE CERTIFICATION AND DOES NOT CONSTITUTE A WARRANTY OR GUARANTEE.
- 3. SURVEY FIELD WORK WAS COMPLETED ON JUNE 2, 2017.
- 4. THIS SURVEYOR HAS MADE NO INVESTIGATION OR INDEPENDENT SEARCH FOR EASEMENTS OF RECORD, ENCUMBRANCES, RESTRICTIVE COVENANTS, OWNERSHIP TITLE EVIDENCE OR ANY OTHER FACTS THAT AN ACCURATE AND CURRENT TITLE SEARCH MAY DISCLOSE.

NOTES: (Table "A" Items")

- 1. SET A 1/2" REBAR W/CAP "AWLS 45377" AT PROPERTY CORNERS AS SHOWN HEREON UNLESS OTHERWISE NOTED.
- 2. GROSS AREA IS 855,802.3 SQUARE FEET OR 19.647 ACRES, MORE OR LESS. NET AREA IS 749,876.2 SQUARE FEET OR 17.215 ACRES, MORE OR LESS.
- 3. ADJOINER INFORMATION IS PER MARICOPA COUNTY ASSESSOR WEBSITE.
- 4. AT THE TIME OF THIS SURVEY, THERE WAS NO EVIDENCE OF RECENT EARTH MOVING WORK, BUILDING CONSTRUCTION, OR BUILDING ADDITIONS OBSERVED INTHE PROCESS OF CONDUCTING THE FIELDWORK.
- 5. AT THE TIME OF THIS SURVEY, THERE WAS NO EVIDENCE OF CHANGES IN STREET RIGHT OF WAY LINES, OR EVIDENCE OF RECENT STREET OR SIDEWALK CONSTRUCTION OR REPAIRS.

SCHEDULE "B" ITEMS

- Taxes for the full year of 2017.
 (The first half is due October 1, 2017 and is delinquent November 1, 2017. The second half is due March 1, 2018 and is delinquent May 1, 2018.)
- 2.) Reservations or Exceptions in Patents, or in Acts authorizing the issuance thereof.
- (3.) A plat recorded in Book 6, Page 4 of Road Maps, purporting to show a county roadway.
- 4. A plat recorded in Book 15, Page 85 of Road Maps, purporting to show a county roadway.
- 5. An easement for roadway and incidental purposes in the document recorded as Docket 5331, Pages 267, 268 and 269.
- An easement for roadway and incidental purposes in the document recorded as Docket 5282, Page 28.
- The Terms, Provisions and Easement(s) contained in the document entitled "Right of Way Contract" recorded December 07, 1964 as Docket 5331, Page 270.
- 8.) Affidavit of Underground Facility Location recorded January 7, 1986 in Instrument No. 86-026906 of Official Records
- 9. An easement for roadway and incidental purposes in the document recorded as 92-014593 of Official Records.

The effect of Abandonment recorded in Instrument No. 95-760855 of Official Records.

- An easement for vehicular non-access and incidental purposes in the document recorded as 92-374788 of Official Records.
- All matters as set forth in Adobe / Miller Improvement District, recorded September 14, 1992 as 92-0513172 of Official Records.
- An easement for road, public utility and incidental purposes in the document recorded as 97-418352 of Official Records.
- An easement for road, public utility and incidental purposes in the document recorded as 97-418353 of Official Records.
- An easement for 1 foot vehicular non-access and incidental purposes in the document recorded as 97-418354 of Official Records.
- An easement for water line and incidental purposes in the document recorded as 97-418355 of Official Records.
- An easement for natural area including restored desert and incidental purposes in the document recorded as 97-418356 of Official Records.
 - A partial release of easement recorded October 31, 2006 as 2006-1439249 of Official Records.
- An easement for public utilities and emergency and service vehicle access and incidental purposes in the document recorded as 97-537413 of Official Records.
- An easement for sidewalk and incidental purposes in the document recorded as 97-537414 of Official Records.
- An easement for electric lines and appurtenant facilities and incidental purposes in the document recorded as 97-707329 of Official Records.
- Survey prepared by Gilbertson Associates, Inc., dated May 01, 1998 revised October 8, 1998, under Job No. 63202, shows the following:
- a.) Discrepancy of the non-vehicular access easement and driveway along the west portion of said property.
- Any facts, rights, interests or claims that may exist or arise by reason of the following matters disclosed by an ALTA/NSPS survey made by _____ on ____, designated Job Number ____:
- The rights of parties in possession by reason of any unrecorded lease or leases or month to month tenancies affecting any portion of the within described property.
 - NOTE: This matter will be more fully set forth or deleted upon compliance with the applicable requirement(s) set forth herein.
- (23.) Water rights, claims or title to water, whether or not shown by the public records.
- PLOTTABLE SCHEDULE "B" ITEM, SHOWN ON THIS SURVEY
- SCHEDULE "B" ITEM CANNOT BE PLOTTED; ITEM AFFECTS SUBJECT PROPERTY.

BASIS OF BEARING

THE BASIS OF BEARING AND ALL MONUMENTATION SHOWN HEREON IS BASED ON THE SOUITH LINE OF THE SOUTHEAST QUARTER OF SECTION 11, TOWNSHIP 4 NORTH, RANGE 4 EAST, USING A BEARING OF NORTH 89 DEGREES 51 MINUTES 11 SECONDS WEST, AS SHOWN ON AN UNRECORDED ALTA/ACSM LAND TITLE SURVEY PREPARED BY GILBERTSON & ASSOCIATES DATED AUGUST 13, 2004.

BENCHMARK

BENCHMARK IS A BRASS CAP IN HANDHOLE LOCATED AT THE INTERSECTION OF PINNACLE PEAK ROAD AND MILLER ROAD.

ELEVATION=1878.317' NAVD 88 (CITY OF SCOTTSDALE DATUM)

CERTIFICATION

To: PFCCB PINNACLE PEAK LLC, AN ARIZONA LIMITED LIABILITY COMPANY CITY OF SCOTTSDALE FIRST AMERICAN TITLE INSURANCE COMPANY

THIS IS TO CERTIFY THAT THIS MAP OR PLAT AND THE SURVEY ON WHICH IT IS BASED WERE MADE IN ACCORDANCE WITH THE 2016 MINIMUM STANDARD DETAIL REQUIREMENTS FOR ALTA/NSPS LAND TITLE SURVEYS, JOINTLY ESTABLISHED AND ADOPTED BY ALTA AND NSPS, AND INCLUDES ITEMS 1, 8, 9, 11, 13, 16 AND 17 OF TABLE A THEREOF. THE FIELDWORK WAS COMPLETED ON JUNE 2, 2017.



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ALTA/NSPS LAND TITLE SURVEY
SECTION 11
TOWNSHIP 4 NORTH, RANGE 4 EAST

TOWNSHIP 4 NORTH, RANGE 4 EAST OF THE G.S.R.B. & M. MARICOPA COUNTY, ARIZONA

AW LAND SURVEYING, u.c.


(480) 244-7630


DRAWN BY: CHECKED BY: DATE: 06/06/17 JOH


JOB NO.: 17-051 SHEET NO. 1 OF

08/18/2017

(480) 243-4287

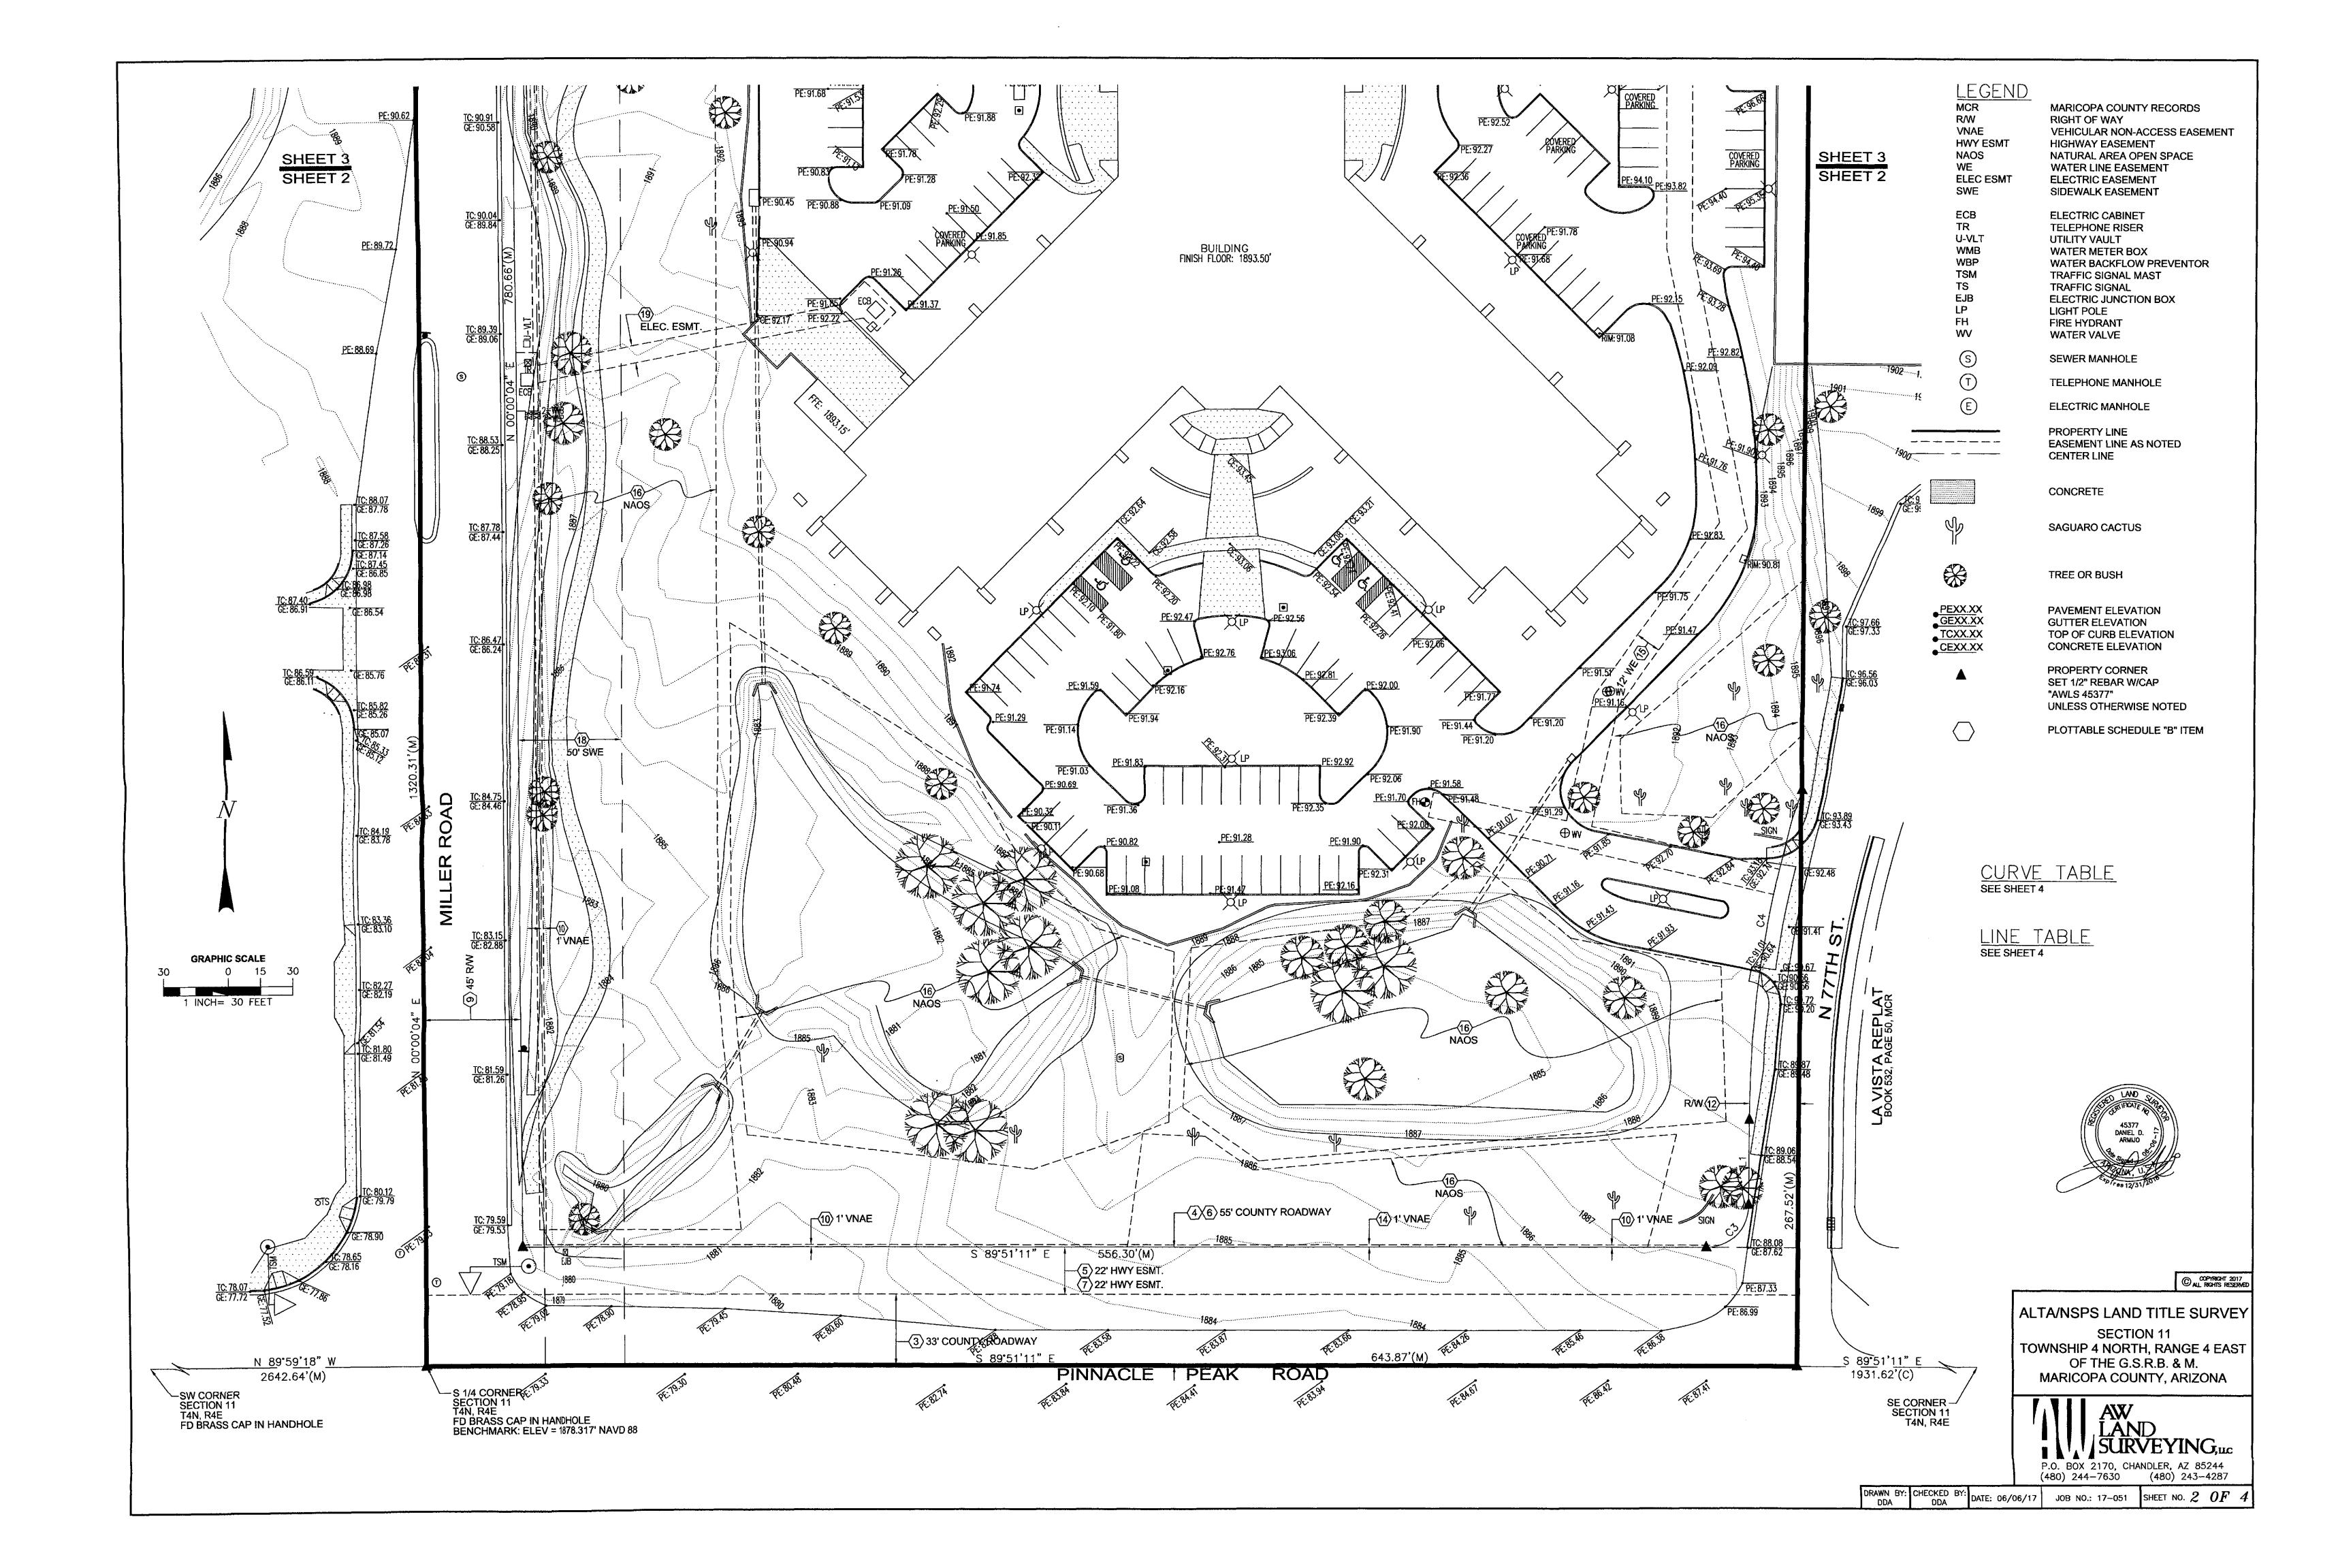

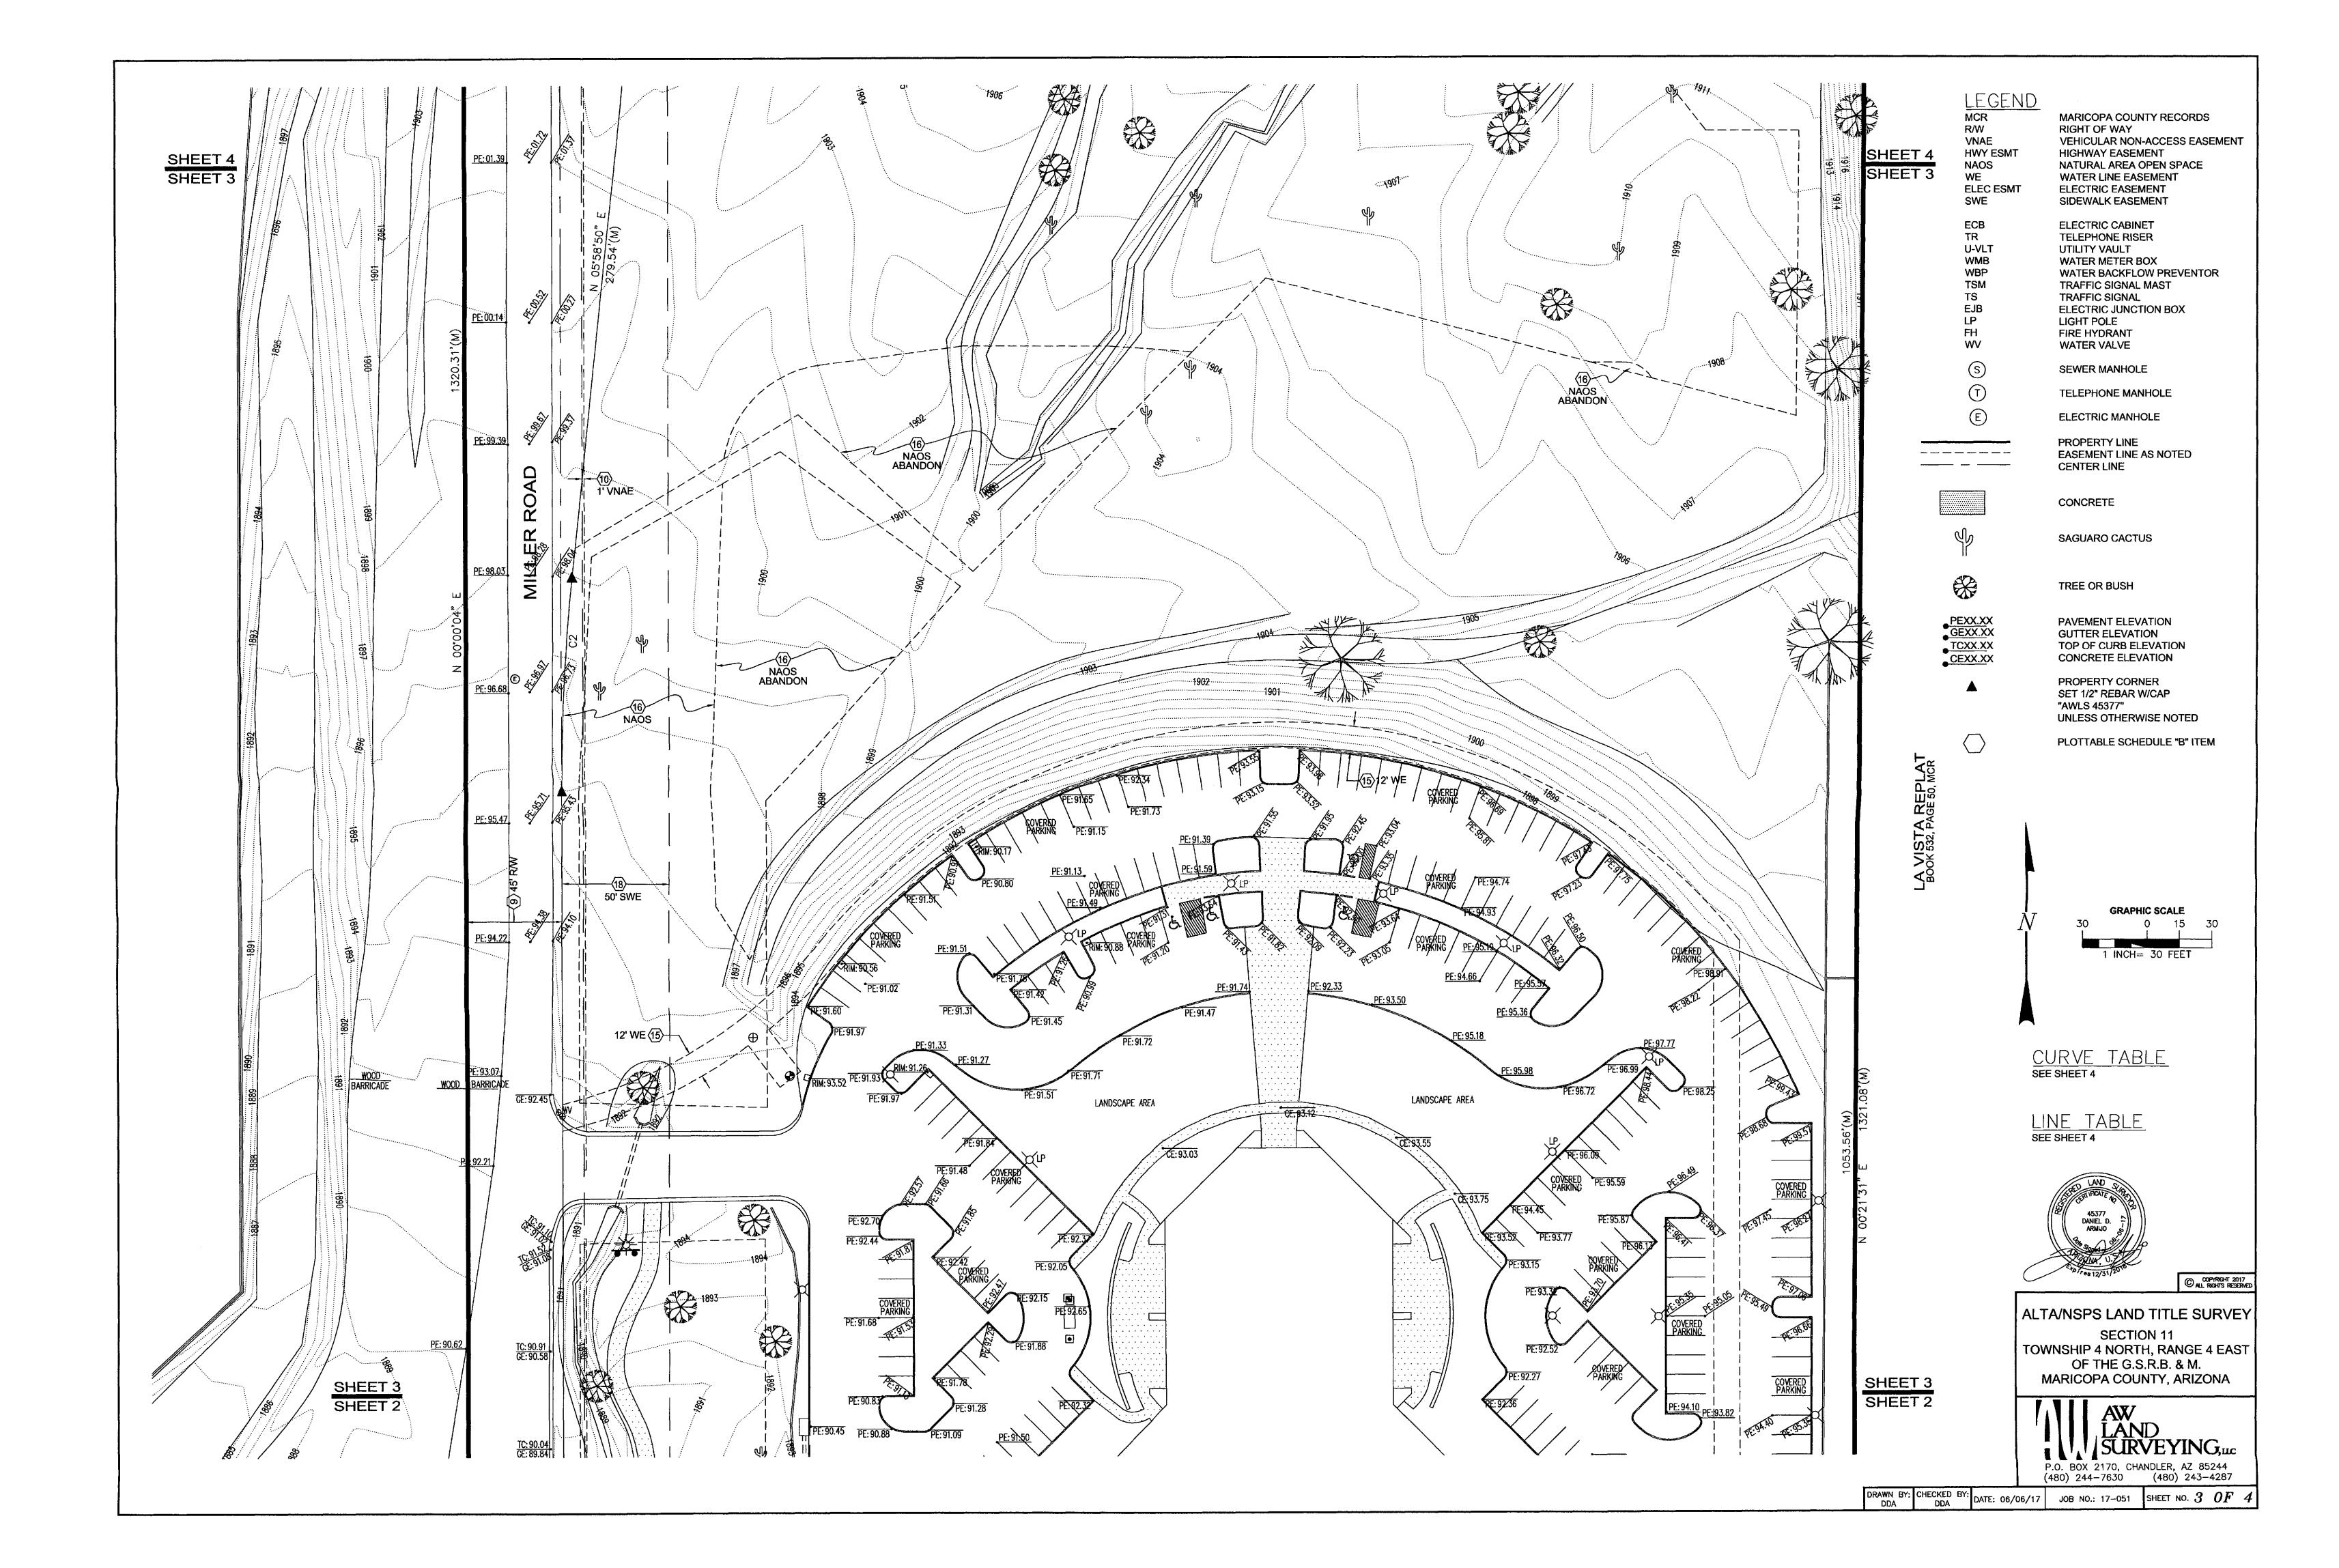

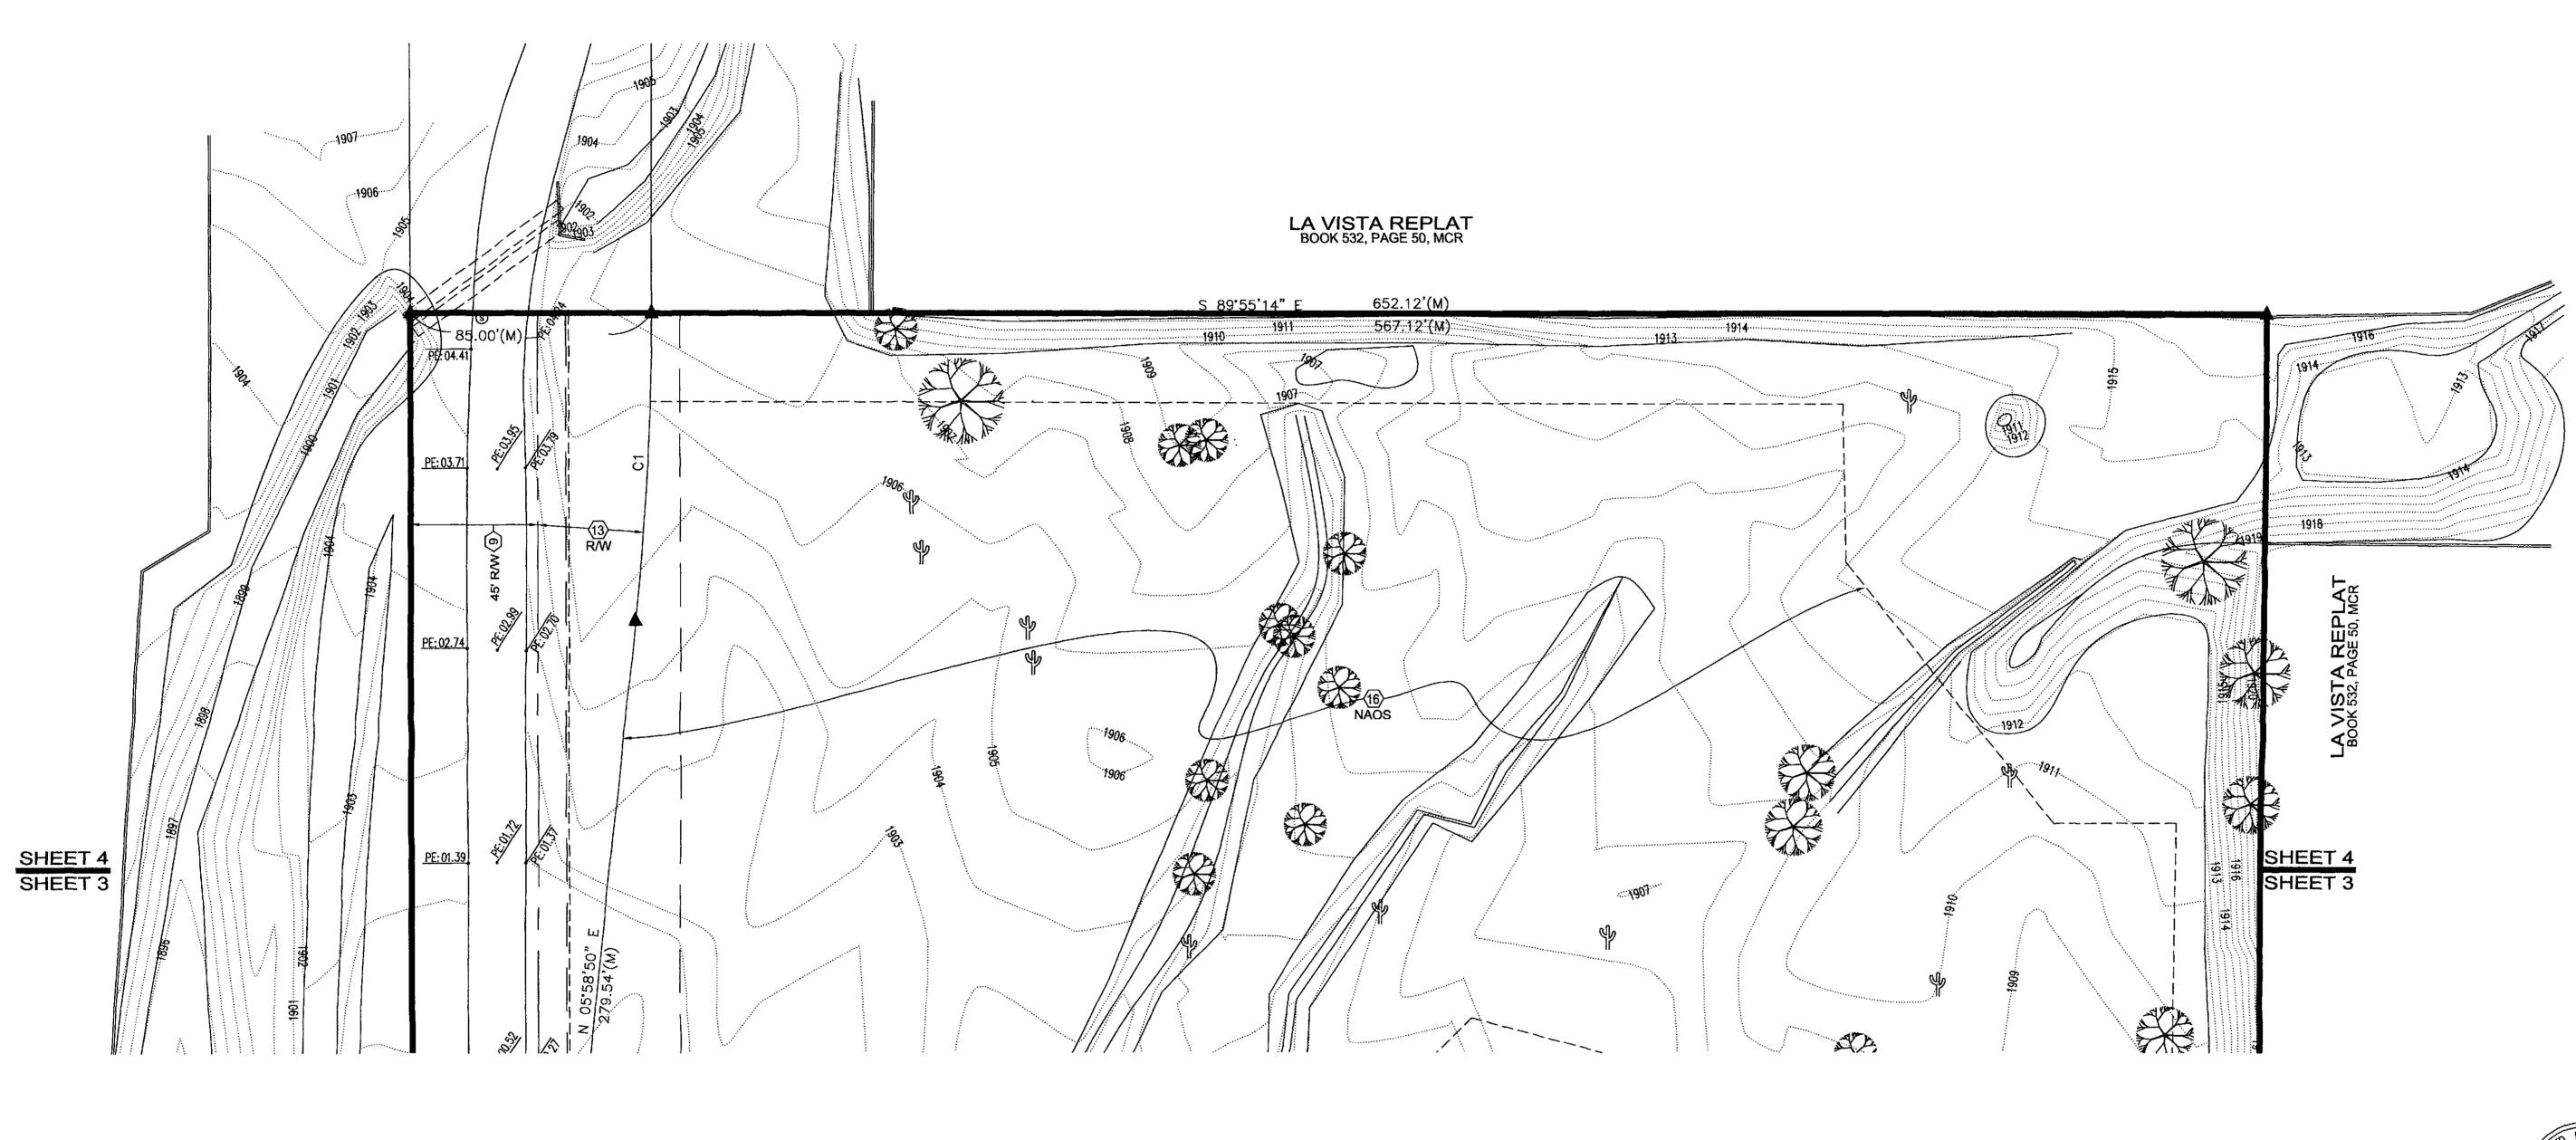



ELEC ESMT SWE

ECB TR U-VLT WMB WBP TSM TS EJB LP FH WV

ELECTRIC MANHOLE

MARICOPA COUNTY RECORDS

NATURAL AREA OPEN SPACE

WATER BACKFLOW PREVENTOR

VEHICULAR NON-ACCESS EASEMENT

RIGHT OF WAY

HIGHWAY EASEMENT

ELECTRIC EASEMENT SIDEWALK EASEMENT

ELECTRIC CABINET TELEPHONE RISER

WATER METER BOX

TRAFFIC SIGNAL MAST

ELECTRIC JUNCTION BOX

UTILITY VAULT

TRAFFIC SIGNAL

LIGHT POLE

FIRE HYDRANT

WATER VALVE

SEWER MANHOLE

TELEPHONE MANHOLE

WATER LINE EASEMENT

_____ _____



PEXX.XX GEXX.XX TCXX.XX CEXX.XX

PROPERTY LINE EASEMENT LINE AS NOTED CENTER LINE

CONCRETE

SAGUARO CACTUS


TREE OR BUSH

PAVEMENT ELEVATION **GUTTER ELEVATION**

TOP OF CURB ELEVATION CONCRETE ELEVATION PROPERTY CORNER SET 1/2" REBAR W/CAP "AWLS 45377" UNLESS OTHERWISE NOTED

PLOTTABLE SCHEDULE "B" ITEM

CURVE	ARC LENGTH	RADIUS	DELTA ANGLE	CHORD BEARING	CHORD LENGTH
C1	107.63'	1045.00	5'54'03"	N 03°01'48" E	107.58'
C2	99.38'	955.00'	5.57,45,	N 02*59'57" E	99.34'
C3	31.34'	20.00'	89'47'09"	N 45°15'15" E	28.23'
C4	155.61'	523.00'	17'02'50"	N 08'53'05" E	155.03'

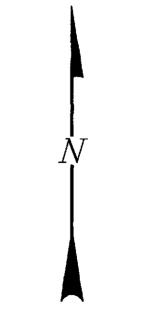

GRAPHIC SCALE


1 INCH= 30 FEET



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ALTA/NSPS LAND TITLE SURVEY SECTION 11

TOWNSHIP 4 NORTH, RANGE 4 EAST OF THE G.S.R.B. & M. MARICOPA COUNTY, ARIZONA

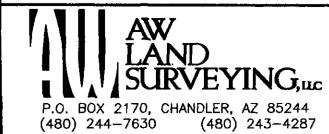

DRAWN BY: CHECKED BY: DDA DDA DATE: 06/06/17 ig| JOB NO.: 17-051 ig| SHEET NO. $m{4}$ $m{OF}$ $m{4}$



ZONE A: NATURAL VEGETATION

ZONE B: ENHANCED PLANTING

from onsite may be used in this zone.


areas are located on lot adjacent to building envelopes.

ZONE D: MAINTAINED LANDSCAPING

current natural state

used in this zone.

ZONE C: NATIVE PLANTING

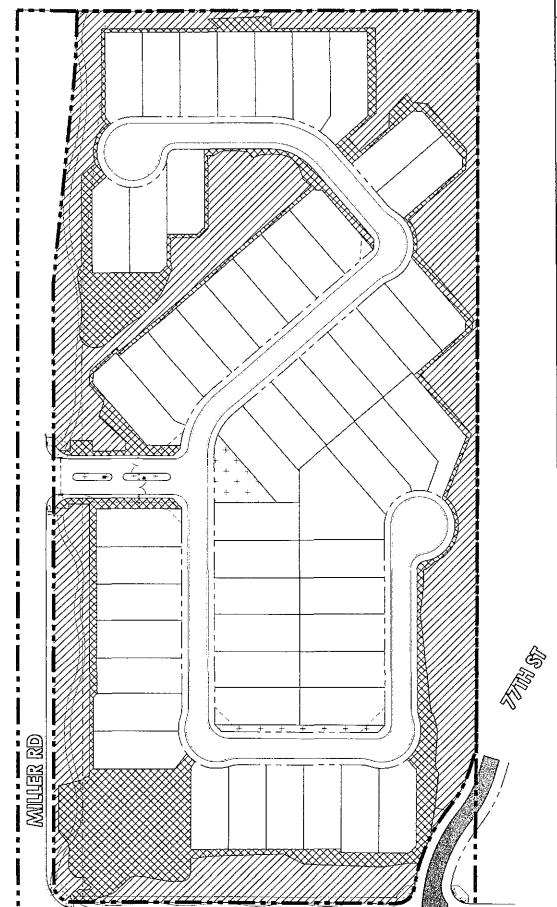

PINNACUE PEAK RD

The identified areas are intended to depict the undisturbed portion of the property which will remain in the

Concentrated at the project entry and throughout the project's common areas, this zone will be irrigated and

naturally occurring vegetation, but will be planted more densely. Salvaged plant material from onsite may be

The identified areas will be revegetated to visually mitigate the disturbance caused by construction. The plant selection and density will be designed to appear similar to the Natural Vegetation Zone. Salvaged plant material

The identified areas are privately owned and maintained. These landscaped

*NOTE: Limits of planting areas and material as depicted on this exhibit are conceptual and may be subject to change

planted with nursery grown landscape plant material. Plant selections will be designed to complement the

PLANT PALETTE

ZONE A: NATURAL VEGETATION

No disturbance will occur in this zone. Existing landscaping shall remain natural state.

ZONE B: ENHANCED PLANTING

This area adheres to the "Desert Appropriate Plant" list found in the Scottsdale Indigenous/Desert Appropriate Plant for ESL. Plantings may include, but are not limited

GROUNDCOVER

Ageratum carymbosum Desert Ageratum

Pelisiphonia brachysiphon Rock Trumpet

Dalea greggii Trailing Indigo Bush

ANNUALS / PERENNIALS / VINES Abronia villosa Sand Verbena

Amsinckia intermedia Fiddleneck

Cucurbita digitata Coyote Gourd

GRASSES

Baileya multiradiata Desert Marigold

Dyssodia pentachaeta Dogweed/Golden

Aristida purpurea Purple Threeawn

Hilaria belangeri Curly Mesquite

Bouteloua aristidoides Needle Grama

Bouteloua curtipendula Sideoats Grama Erioneuron pulchellum Fluffgrass

Stachys coccinea Texas Betony Tagetes palmeri Mt. Lemmon Marigold

Zinnia acerosa Desert Zinnia

TREES

Acacia berlandieri Guajillo Ceiba aesculifolia Silk Cotton Tree Cercidium sonorae Sonoran Palo Verde Condalia globosa Globosa Blue Wood Jatropha cinerea Leafy Limberbush SUCCULENTS/CACTI

Agave colorata Mescal Ceniza Chrysactina Mexicana Domianita Daisy

Dasylirion longissima Toothless Sotol Echinocactus grusonii Golden Barrel Cactus SHRUBS/BUSHES

Dasylirion acrotriche Green Desert Spoon

Acacia cultiformis Knife Acacia Aloysia lycioides White Bush Aloysia wrightii Wright's Bee Bush

Anisacanthus andersonii Magdelena Palm Canyon

Honeysuckle

ZONE C: NATIVE PLANTING

This area adheres to the "Indigenous Plants" list found in the Scottsdale Indigenous/Deser Appropriate Plant for ESL. Plantings may include, but are not limited to: TREES

Acacia constrida Berberis haematocarpa Canotia holacantha Celtis pallida Cercidium (Parkinsonia) floridum Chilopsis linearis SUCCULENTS / CACTI Agave palmeri

Carnegiea gigantea Dasylirion wheeleri Echinocereus engelmannii cactus Ferocactus cylindraceus Barrel SHRUBS / BUSHES Ambrosia ambrosioides

Canyon Ragweed Ambrosia deltoidea Triangl-leaf Bursage Ambrosia dumosa White Bursage Anisacanthus therberi Desert Honeysuckle

ZONE D: MAINTAINED LANDSCAPING

This area adheres to the "Recommended Plant for Enclosed Areas" list found in the Scottsdale Indigenous/Desert Appropriate Plant for ESL. Plantings may include, but are not limited to:

TREES Acacia aneura Mulga Acaciawillardina Palo Blanco Bauhiniia lunarioides Chihuahuan Orchid Tree Atriplex semibaccata Australian Saltbush

Callistemon rigidus Stiff Bottlebrush Cercidum (Parkinsonia) Praecox Palo Brea SUCCULENTS/CACTI/FOCAL PLANTS Agave Americana Century Plant

Aloe vera Aloe Vera Brahia armata Mexican Blue Palm Creus peruvianus Peruvian Apple Cactus Hesperaloe parvillara Red Yucca

SHRUBS/BUSHS/VINES Acacia craspedocarpa Waxleaf Acacia Antigonon leptopus Coral Vine Atriplex nummularia Chamisa

Bauhinia lunarioides Chihuahuan Orchid Shrub Caesalpinia gilliesii Yellow Bird-of-Paradise

GROUNDCOVER

Acacia redolens Prostrate Acacia Astericus Mediterranean Beach Daisy Baccharis pilularis Chaparral Broom Bulbine frutescens Bulbine

ALL LIGHTING TO ADHERE TO SECTION 7.600 - OUTDOOR LIGHTING OF THE SCOTTSDALE ZONING ORDINANCE, AS WELL AS SPECIFICATIONS OUTLINED FOR ESL AREAS.

- LANDSCAPE NOTES:


 1. All disturbed areas are to have 'desert floor' decomposed granite. match color and size of surrounding areas.
- All berms are to have maximum 4:1 side slopes.
- 3, Boulders are to be surface select site boulders, 1/3 buried in soil, typ.
- Fifty percent of proposed trees shall be mature, as defined in article iii, definitions, of the zoning ordinance. Indicate both the compliant caliper and industry standards box size for that caliper in the plant palette.
- All species shall be selected solely from the arizona dept. of water resources low water use / drought tolerant plant list.
- No shrub or groundcover within sight visibility triangle shall exceed 2'-0" in height at maturity, typ.
- Plants proposed in drainage basins shall be in conformance with design standards and policies manual section 2-1.903 native plants in detention basins and drainage channels. 8. All landscaped areas shall adhere to Zoning Ordinance Sections 10.100, 10.200, 10.401, 10.402, 10.501, 10.502.
- SALVAGE & REVEGETATION TECHNIQUES:
- RE-VEGETATED PORTIONS OF THE SITE, A HYDROSEED MIX WILL BE USED TO ALLOW QUICK, EFFICIENT RE-GROWTH OF PLANT MATERIAL WITHIN DISTURBED LANDSCAPE AREAS.
- ALL RE-VEGETATED NAOS AREAS SHALL BE WATERED FOR THREE YEARS MAXIMUM.
- 3. CONTAINER-GROWN PLANT MATERIAL SHALL BE IRRIGATED WITH DRIP IRRIGATION.
- THE SELECTION, PLACEMENT AND ALIGNMENT (ROTATION) OF ALL ON-SITE NURSERY SALVAGE TREES SHALL BE APPROVED BY OWNER, OR THE LANDSCAPE ARCHITECT, PRIOR TO DIGGING AND PLANTING.

PINNACLE PEAK & MILLER







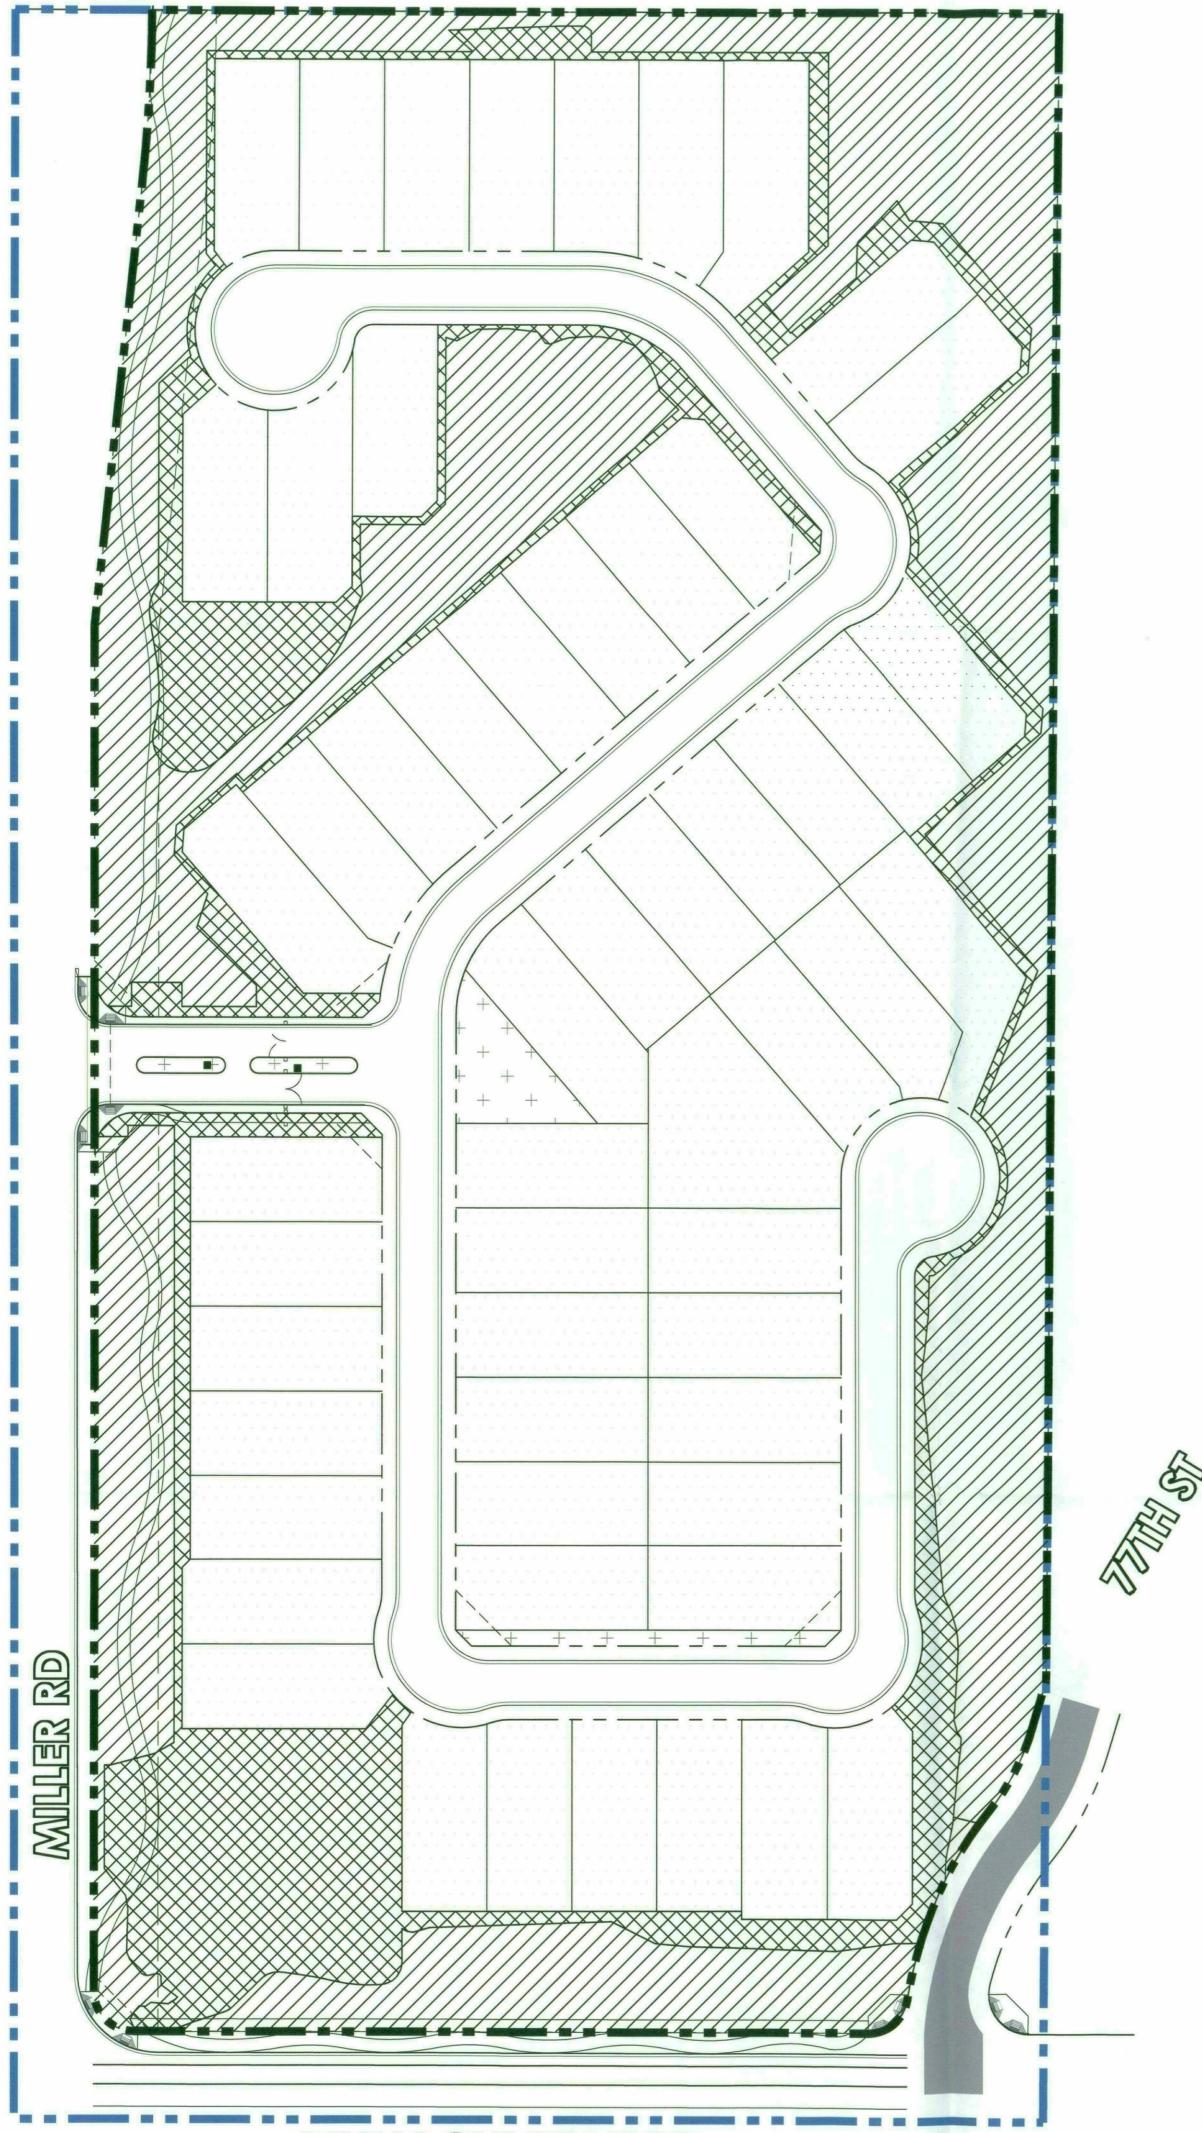

PLANT PALETTE

ZONE A: NATURAL VEGETATION

No disturbance will occur in this zone. Existing landscaping shall remain natural state.

ZONE B: ENHANCED PLANTING

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Hesperaloe parviflora Red Yucca SHRUBS/BUSHS/VINES Acacia craspedocarpa Waxleaf Acacia

Antigonon leptopus Coral Vine Atriplex nummularia Chamisa

Bulbine frutescens Bulbine

GROUNDCOVER

Acacia redolens Prostrate Acacia

Astericus Mediterranean Beach Daisy

Baccharis pilularis Chaparral Broom

LIGHTING **ALL LIGHTING TO ADHERE TO SECTION** 7.600 - OUTDOOR LIGHTING OF THE SCOTTSDALE ZONING ORDINANCE, AS **WELL AS SPECIFICATIONS OUTLINED** FOR ESL AREAS.


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Bauhinia lunarioides Chihuahuan Orchid Shrub

Caesalpinia gilliesii Yellow Bird-of-Paradise

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land planning • development entitlements • landscape architecture

120 south ash avenue • tempe, arizona 85281 • 480.994.0994

ZONE B: ENHANCED PLANTING

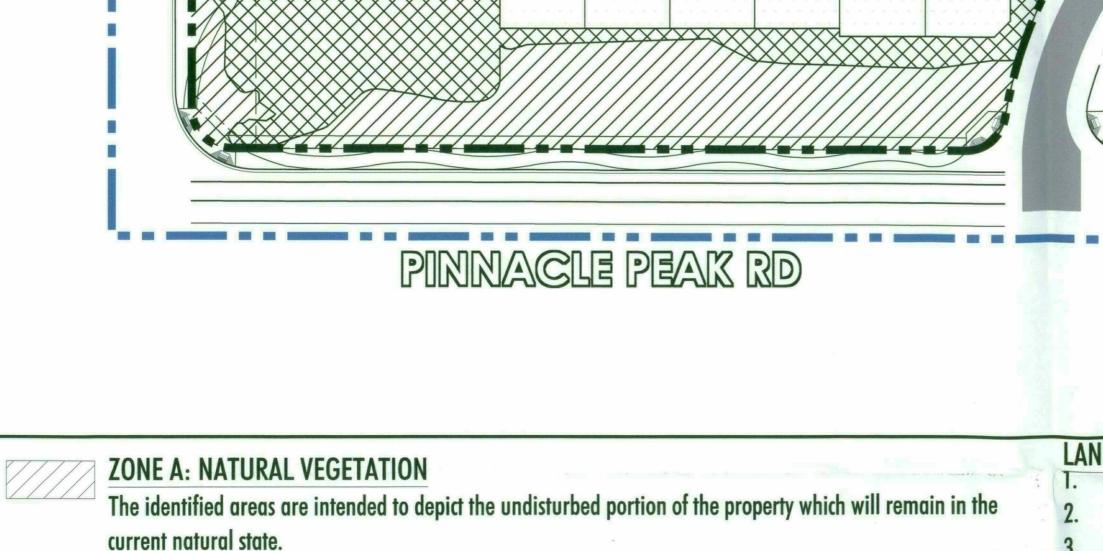ZONE C: NATIVE PLANTING

from onsite may be used in this zone.

ZONE D: MAINTAINED LANDSCAPING


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NOTE: Limits of planting areas and material as depicted on this exhibit are conceptual and may be subject to change

used in this zone.

PINNACLE PEAK & MILLER




DRAWN BY: ac 1731

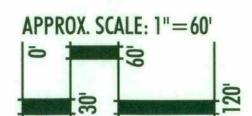08/18/2017






PINNACLE PEAK & MILLER

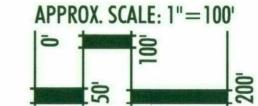







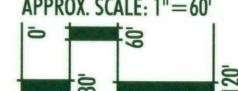

08/18/2017





CURRENT NAOS ON THE SITE REPRESENTS DEDICATIONS AND RELEASE OF EASEMENTS FROM 1992 TO 2005. ORIGINAL DEDICATIONS WERE COMMITTED UNDER A COMBONATION OF 100% AND 50% NAOS CREDIT CONDITIONS.



PROPOSED NAOS AREA DEDICATION - 4.8 ACRES

PROS

-CONTINUOUS AREA

-INCLUSIVE OF WASH CORRIDOR

-UPDATED TO CURRENT NAOS **STANDARDS**

-TRACT DEDICATIONS - CONCENTRATED ALONG PERIMETER

-ACCOMMODATES 77TH ST. REALIGNMENT

- HOA TO MAINTAIN

-PROVIDES REVEG. IN PREVIOUSLY DISTURBED AREAS




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PINNACLE PEAK & MILLER

APPROX. SCALE: NTS

NAOS COMPARISON

11-ZN-2017



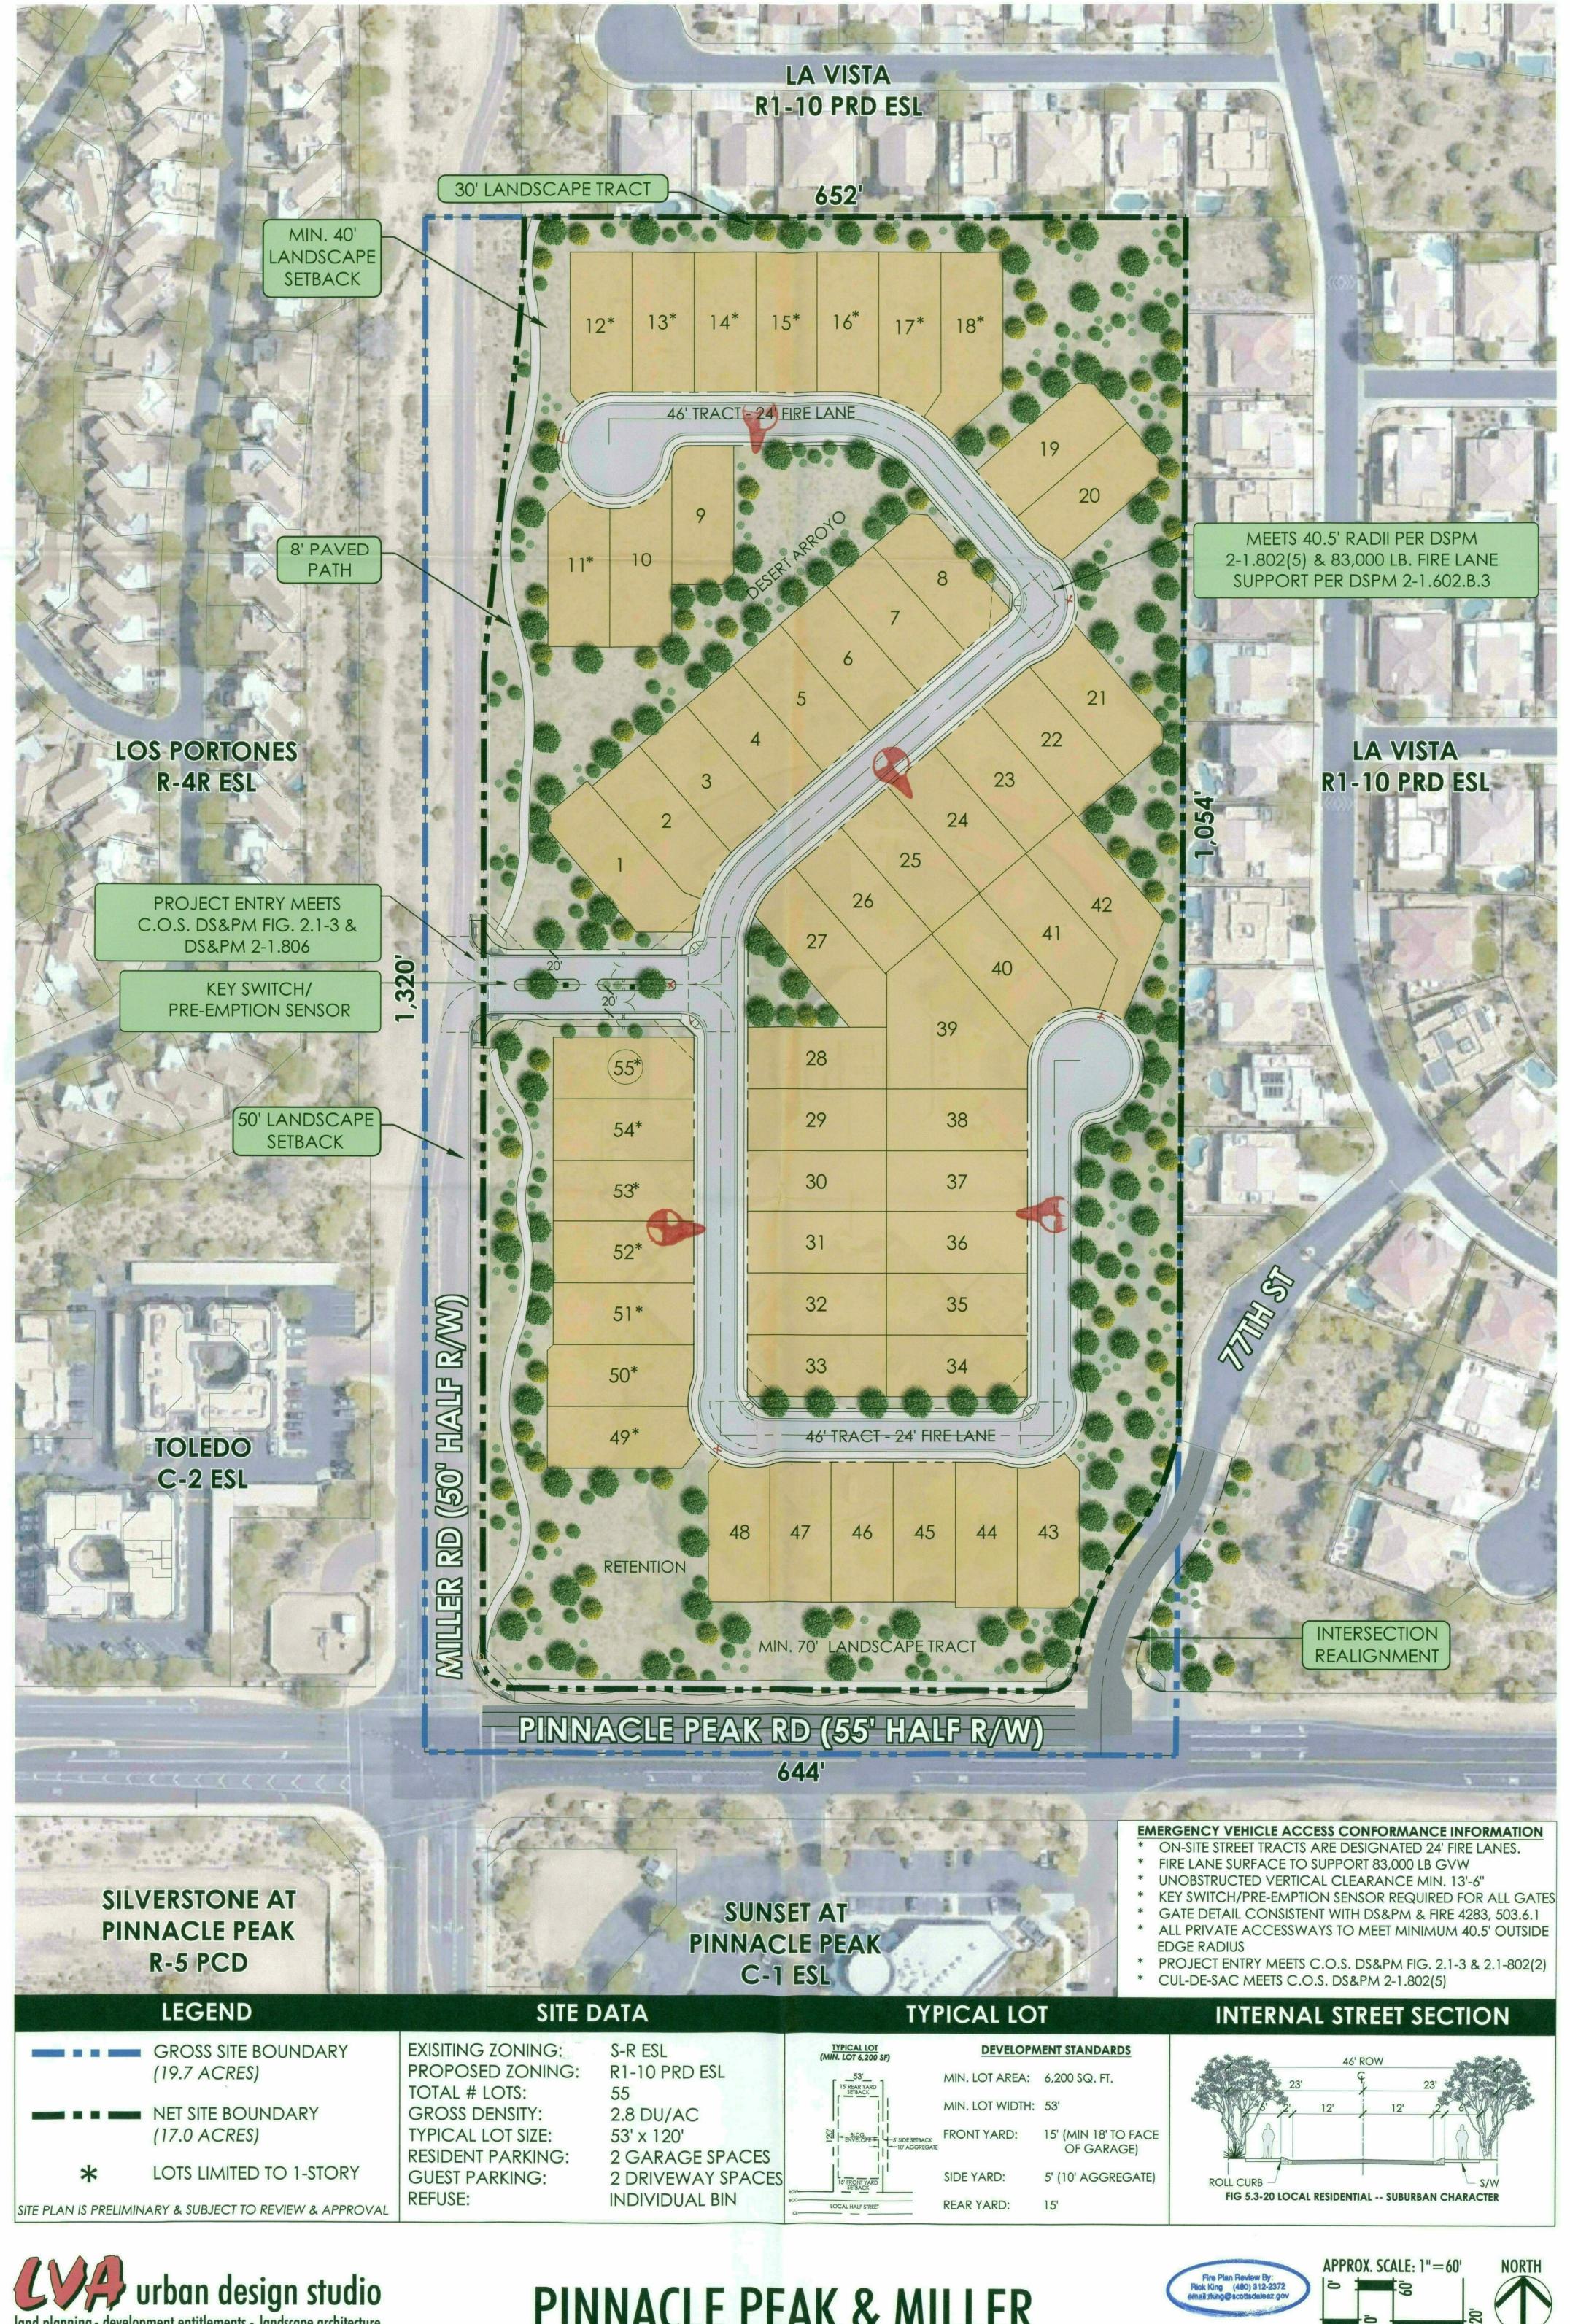

PINNACLE PEAK & MILLER






CONCEPTUAL SITE PLAN

8/15/17

11-ZN-2017 08/18/2017



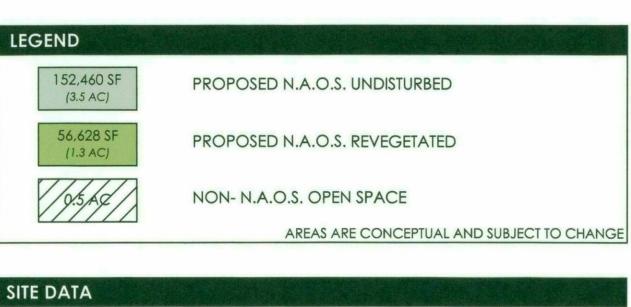

9.4 ACRES
7.0 ACRES

		1CUATIONS APPROVAL 27-0418356) & ROE (114		
NAOS ANALYSIS PER ZONING CASI SLOPE CATEGORY	E (57-ZN-91 #2) ACRES	HILISIDE EACTOR	DEO NAC	
2% - 5%	17.2	HILLSIDE FACTOR 25%	4.3 AC	
NAOS REQUIREMENT PER ZONING O REQUIRED NAOS:	4.3 AC	25% OF NET		
REQUIRED UNDISTURBED:	MIN. 3.0 AC	70% OF TOTAL NAO	70% OF TOTAL NAOS REQUIREMENT	
KEGUIKED UNDISTURBED.	MAX. 1.3 AC	30% OF TOTAL NAO	30% OF TOTAL NAOS REQUIREMENT	
REQUIRED REVEGETATION:	114 011 110 110			
REQUIRED REVEGETATION:	5.7 AC	33% OF NET	.3 AC EXCESS OF REQUIREMENT	
REQUIRED REVEGETATION:			QUIREMENT	
REQUIRED REVEGETATION: PROVIDED NAOS:	5.7 AC		The state of the s	

REQUIRED N.A.O.S FOR SITE P	ER SLOPE ANAL	YSIS (57-ZN-91 #2)
TOTAL N.A.O.S. REQUIRED:	4.3 AC	25% OF NET
REQUIRED UNDISTURBED:	3.0 AC	70% OF TOTAL
REQUIRED REVEGETATION:	1.3 AC	30% OF TOTAL


N.A.O.S. PROVIDED		
TOTAL N.A.O.S. PROVIDED:	4.8 AC	28% OF NET SITE AREA
PROVIDED UNDISTURBED:	3.0 AC	70% OF TOTAL
PROVIDED REVEGETION:	1.3 AC	30% OF TOTAL
PROVIDED SURPLUS:	0.5 AC	12% EXCESS SURPLUS TO BE UNDISTURBED NAOS
NON N.A.O.S. OPEN SPACE PROVIDED = 0).5 AC	

PROPOSED N.A.O.S. CONFORMS TO STANDARDS SET FORTH IN SECTION 6.1011; INCLUDING 30' WIDTH, 20' ALONG ROADWAYS, & 4,000 SQUARE FEET OF AREA.




PINNACLE PEAK & MILLER

N.A.O.S.

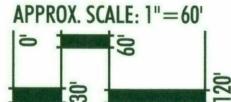


1731 DRAWN BY: AC

3-GP-2017 08/18/2017

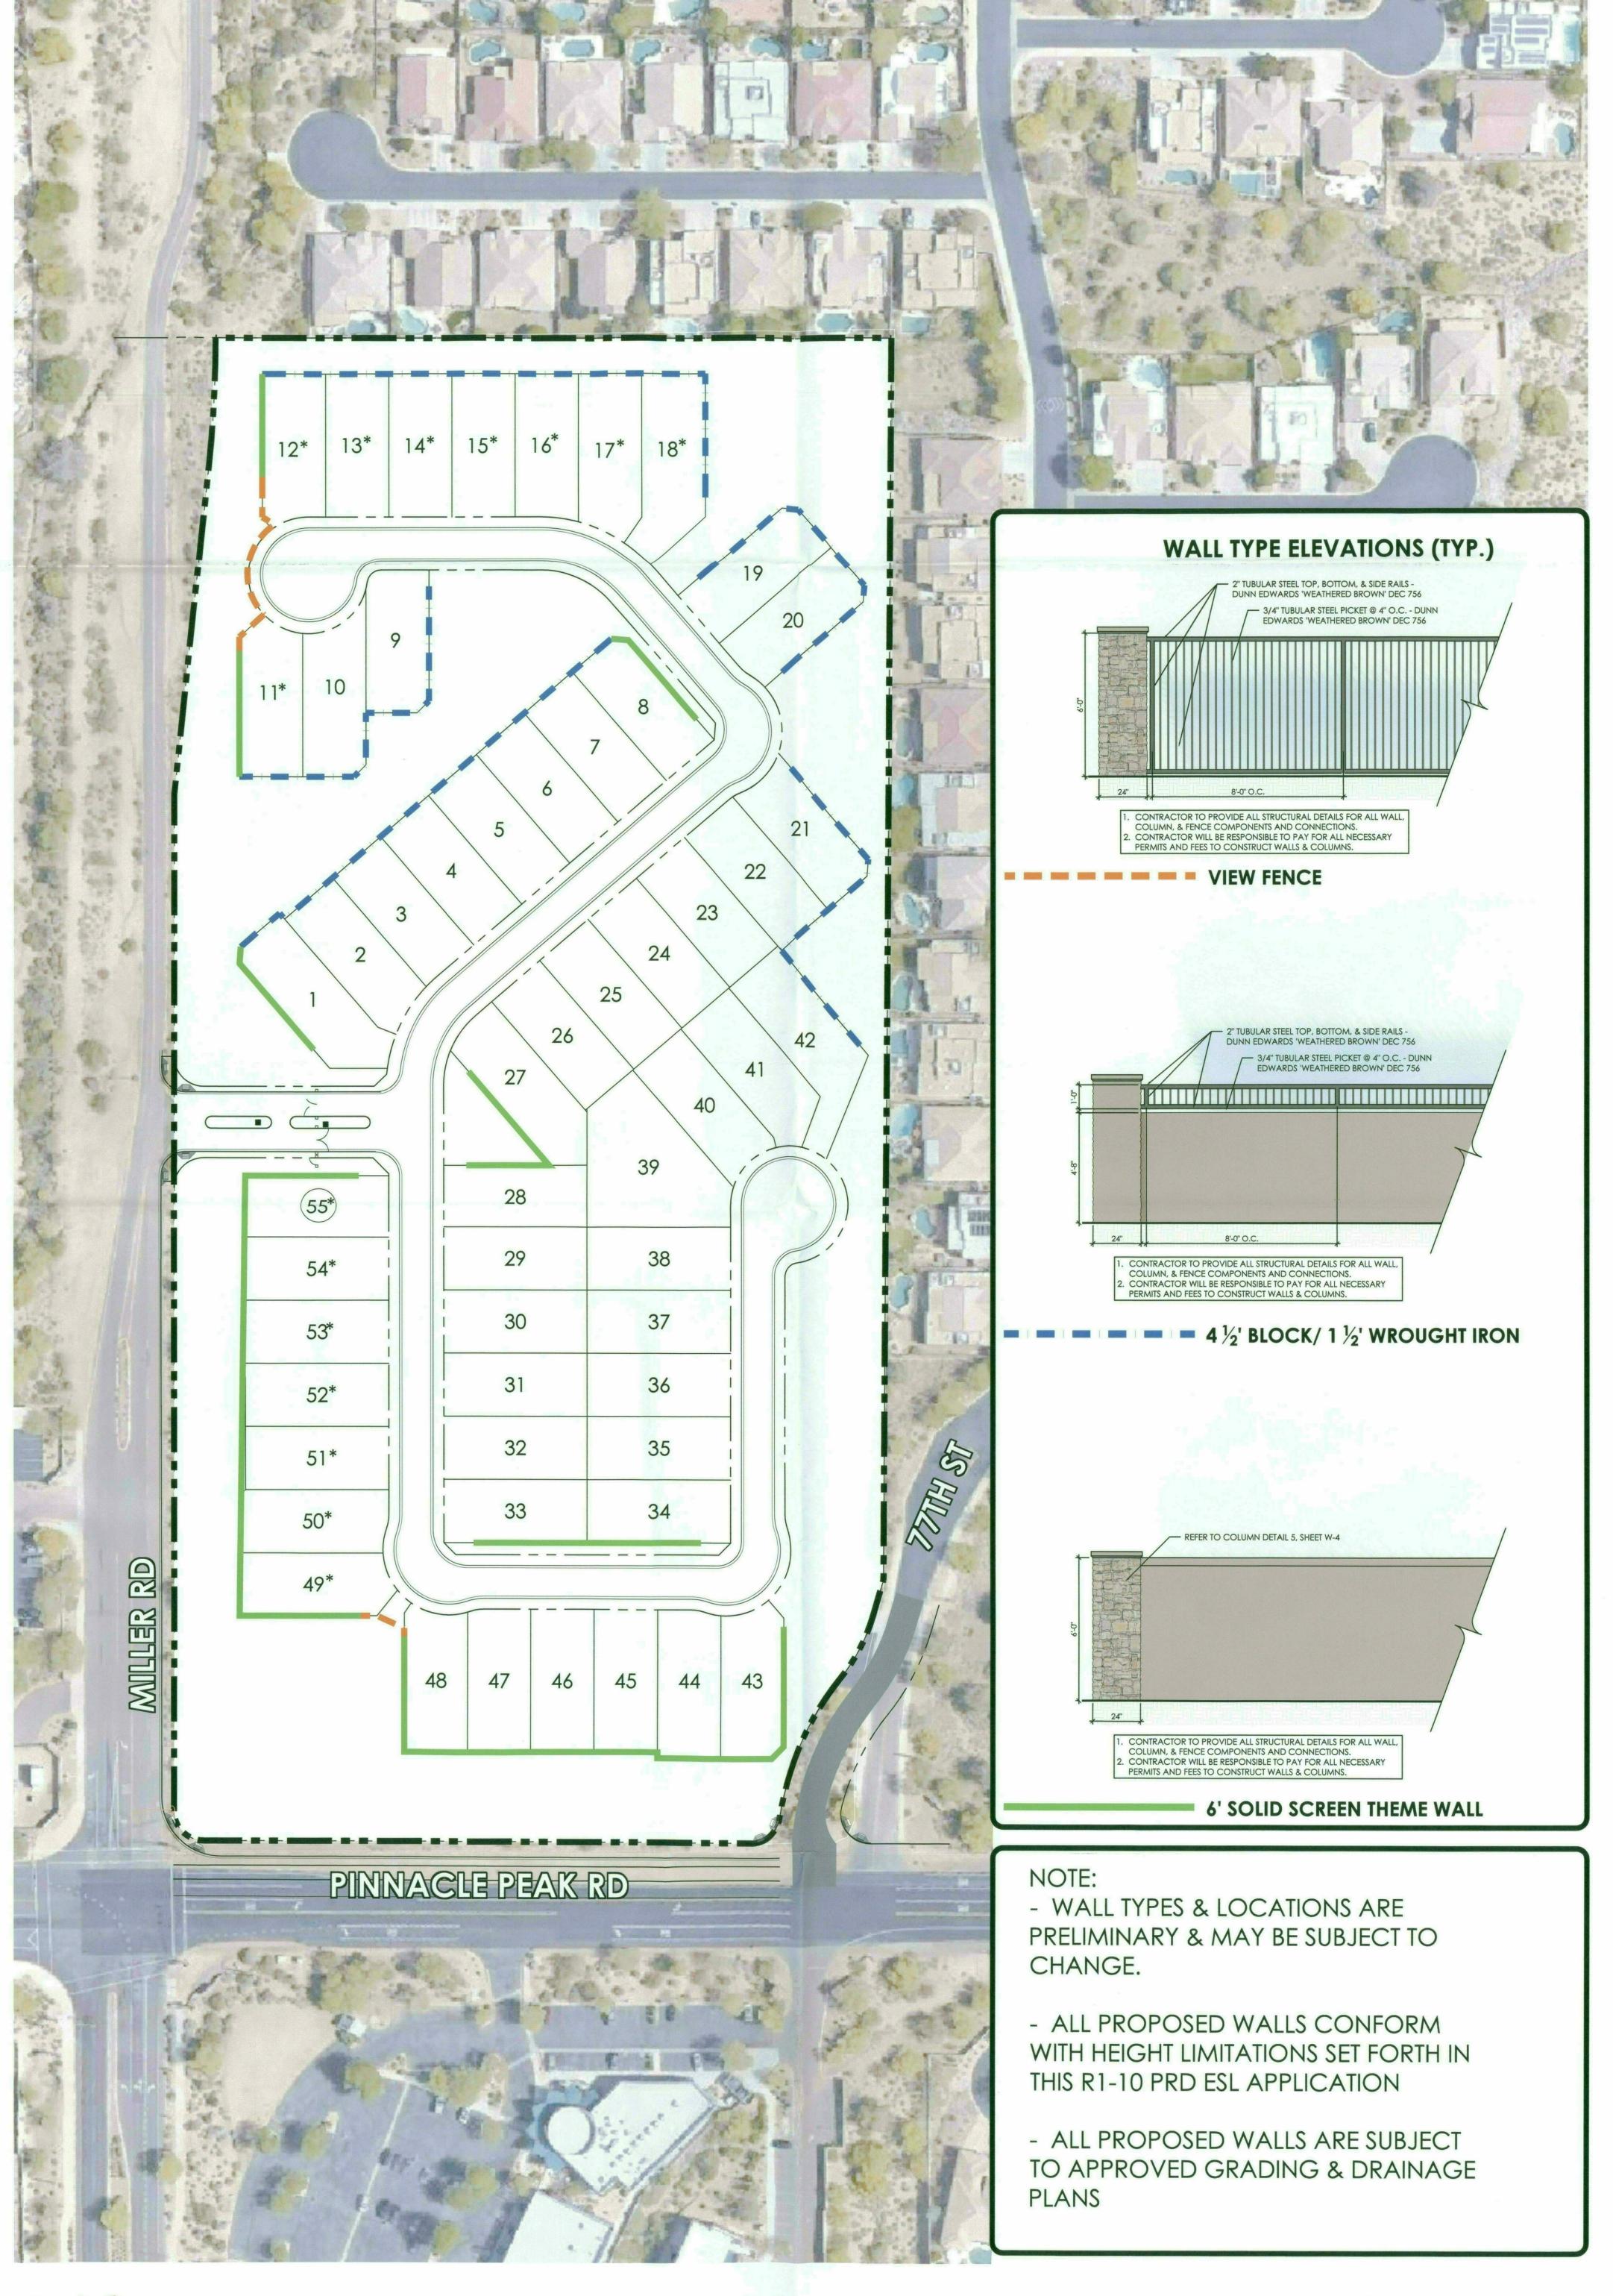




PINNACLE PEAK & MILLER

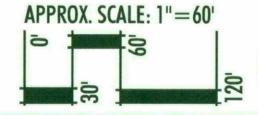


1731

3-GP-2017 08/18/2017

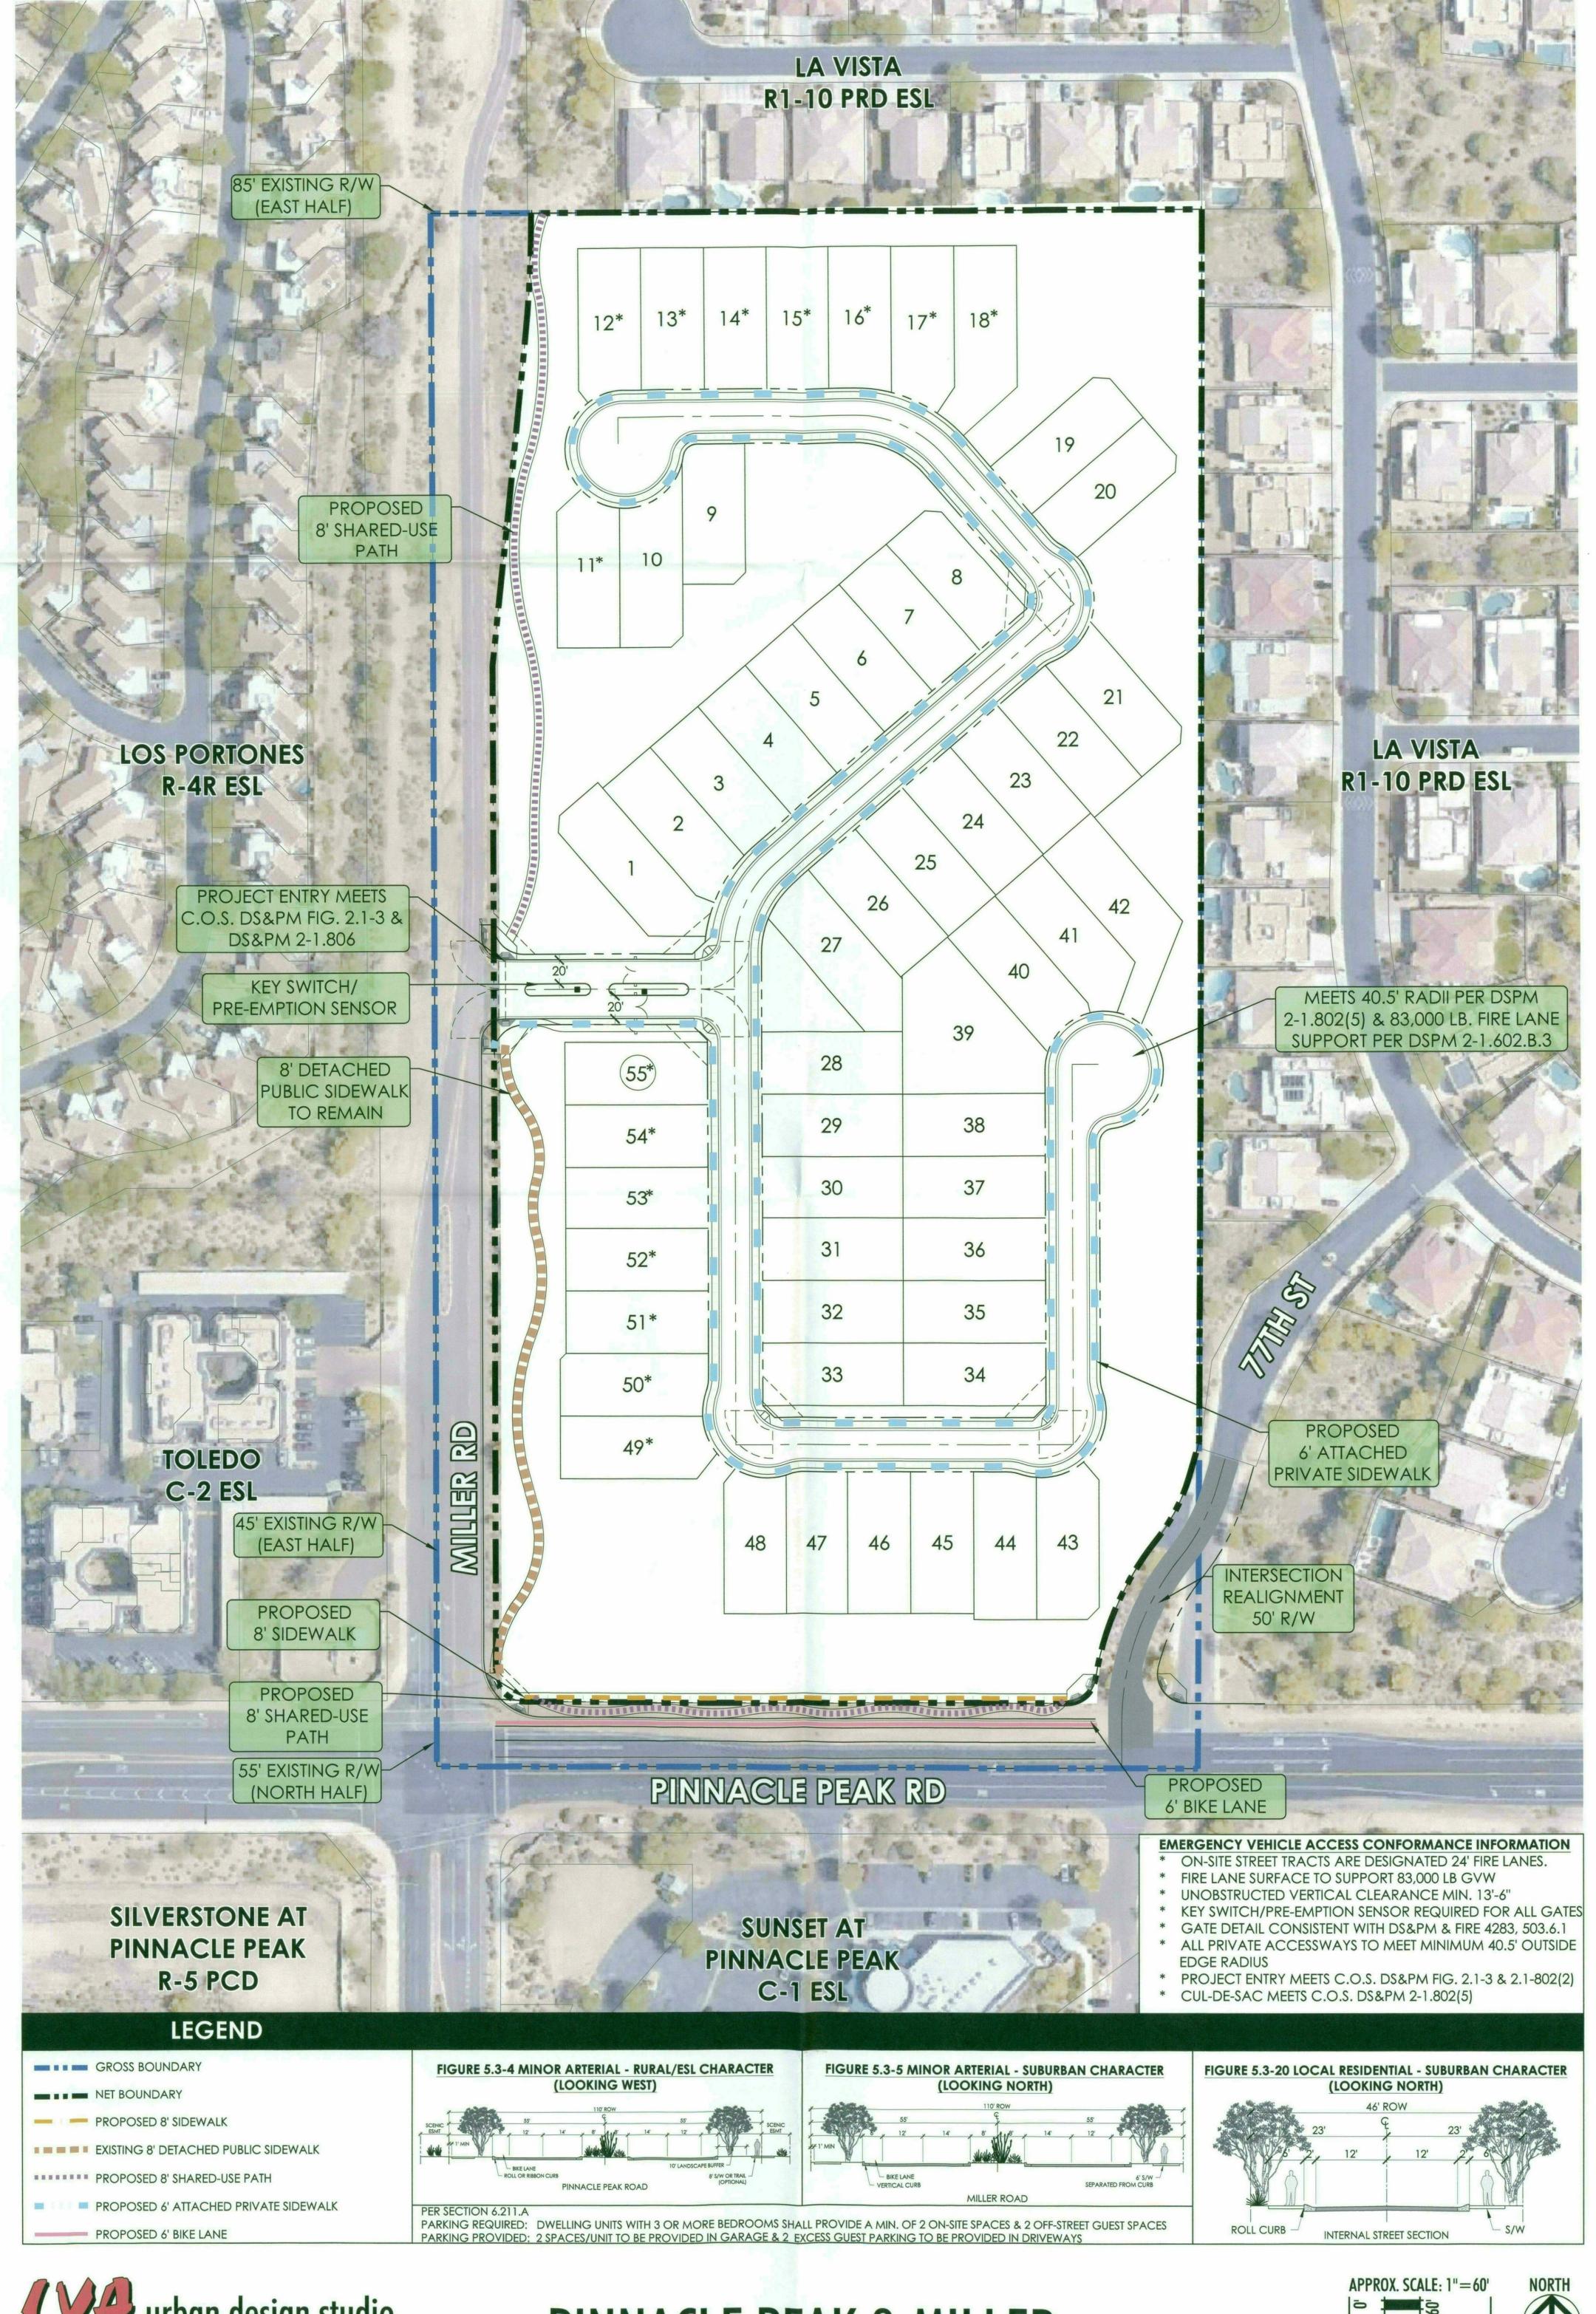




PINNACLE PEAK & MILLER

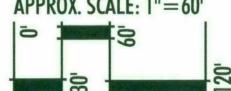

11-ZN-2017 08/18/2017

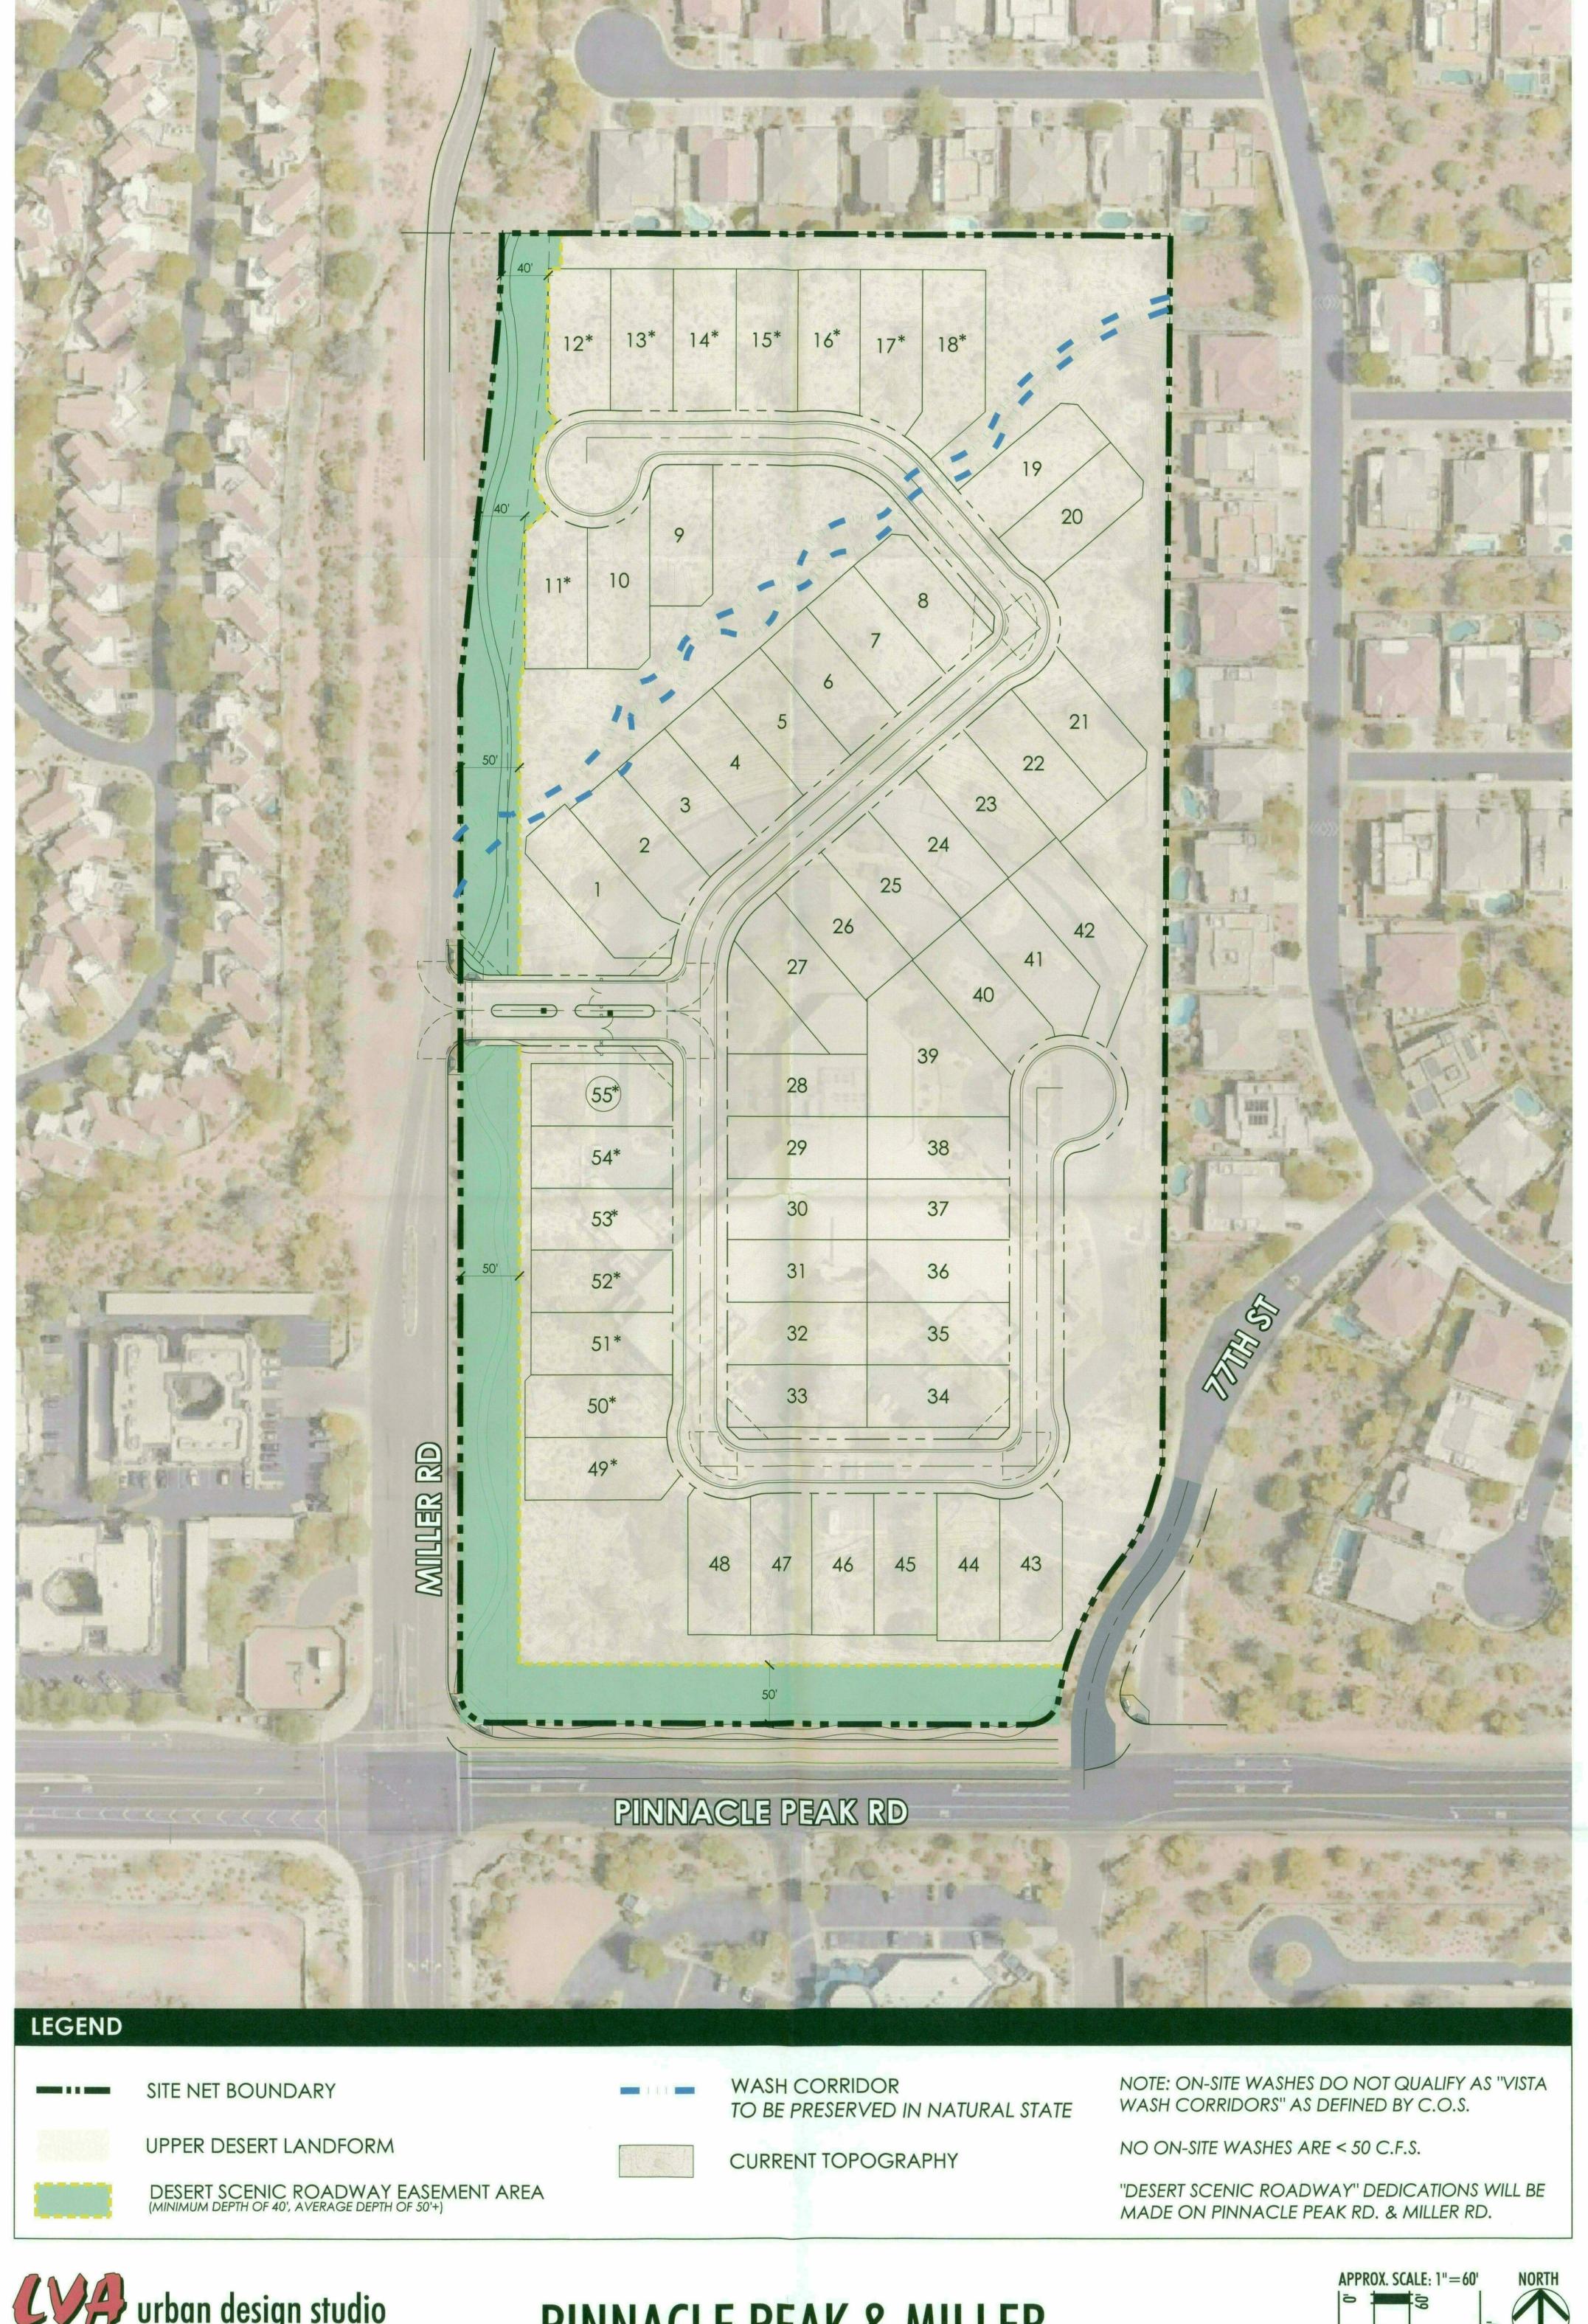



PINNACLE PEAK & MILLER

