

SITE NAME: PHO_ZUZU-VALLEYHO_2 SC (SMALL CELL)



SITE PHOTO

LEASEE:

ZONING:

ARLA VOLUME:

JURISDICTION:

BUILDING CODES:

APN:

VERIZON WIRELESS

TEMPE, ARIZONA, 85283

CITY OF SCOTTSDALE

126 W. GEMINI DR.

DO

R.O.W.

47.0 CU. FT.

2012 I.B.C.

2011 N.E.C.

2012 I.M.C.

2012 I.F.C.

STIPULATIONS - CASE # 44-DR-2016

1. EXCEPT AS REQUIRED BY THE SCOTTSDALE REVISED CODE, THE DESIGN STANDARDS AND POLICIES MANUAL (DPSM), AND OTHER STIPULATIONS HEREIN, THE SITE DESIGN AND CONSTRUCTION SHALL SUBSTANTIALLY CONFORM TO THE FOLLOWING DOCUMENTS:

a. ARCHITECTURAL ELEMENTS, INCLUDING DIMENSIONS, MATERIALS, FORM, COLOR, AND TEXTURE SHALL BE CONSTRUCTED TO BE CONSISTENT WITH THE BUILDING ELEVATIONS SUBMITTED BY YOUNG DESIGN CORP. AND VERIZON WIRELESS, WITH A CITY STAFF DATE OF 11/14/2016.

b. THE LOCATION AND CONFIGURATION OF THE SITE IMPROVEMENTS SHALL BE CONSISTENT WITH THE SITE PLAN SUBMITTED BY YOUNG DESIGN CORP. AND VERIZON WIRELESS, WITH A CITY STAFF DATE OF 11/14/2016.

ARCHITECTURAL DESIGN: DRB STIPULATIONS

2. THE ANTENNAS, CABLES, RADIOS AND OTHER EQUIPMENT SHALL BE LOCATED ON THE INSIDE OF THE REPLACEMENT SIGN POLE, AND SHALL NOT BE VISIBLE.

3. COLORS OF REPLACEMENT POLE SHALL BE SIMILAR TO THE OLD TOWN SCOTTSDALE SIGN AT THE NORTHEAST CORNER OF MAIN STREET AND SCOTTSDALE ROAD.

4. ELECTRIC METER SHALL BE PLACED BETWEEN THE TWO NEW POLES, AND BE PAINTED TO MATCH THE POLES.

DRB STIPULATIONS

5. WITH THE FINAL PLANS SUBMITTAL, THE DEVELOPER SHALL SUBMIT A COMPLETED ANTENNA SITE RIGHT-OF-WAY LICENCE AGREEMENT (ARLA) DOCUMENT THAT HAS BEEN APPROVED BY THE CITY'S TELECOMMUNICATIONS POLICY COORDINATOR.

6. PRIOR TO CONSTRUCTION, THE APPLICANT SHALL OBTAIN PERMISSION TO WORK IN THE RIGHT-OF WAY (ENCROACHMENT PERMIT) FROM THE CITY OF SCOTTSDALE. SUBMITTAL FOR THIS PERMIT SHALL INCLUDE A BARRICADE AND TRAFFIC CONTROL

7. PRIOR TO CONSTRUCTION, SCHEDULE A PRE-CONSTRUCTION MEETING WITH INSPECTION SERVICES BY CALLING 480-312-5750.

8. PRIOR TO OR DURING THE ISSUANCE OF PERMITS, THE APPLICANT SHALL PAY THE FIRST YEAR RENT FOR THE ANTENNA SITE RIGHT-OF-WAY LICENSE AGREEMENT (ARLA) TO THE ONE STOP SHOP.

SHEET INDEX

CONSTRUCTION WILL NOT BE ALLOWED BETWEEN NOV. 20,2017 THROUGH MARCH 31, 2018.

GENERAL NOTES FOR PUBLIC WORKS CONSTRUCTION

ALL CONSTRUCTION IN THE PUBLIC RIGHTS-OF-WAY OR IN EASEMENTS GRANTED FOR PUBLIC USE MUST CONFORM TO THE • A-1.2 BORE ROUTE PLAN LATEST MARICOPA ASSOCIATION OF GOVERNMENTS (MAG) UNIFORMED STANDARD SPECIFICATIONS AND UNIFORM STANDARD • A-2 DETAILS FOR PUBLIC WORKS CONSTRUCTION AS AMENDED BY THE . A-3 LATEST VERSION OF THE CITY OF SCOTTSDALE STANDARD SPECIFICATIONS AND SUPPLEMENTAL STANDARD DETAILS. IF THERE IS CONFLICT, THE CITY'S SUPPLEMENTAL STANDARD DETAILS WILL GOVERN.

THE CITY ONLY APPROVES THE SCOPE, NOT THE DETAIL, OF ENGINEERING DESIGNS; THEREFORE, IF CONSTRUCTION QUANTITIES ARE SHOWN ON THESE PLANS, THEY ARE NOT VERIFIED BY THE CITY.

3. THE APPROVAL OF PLANS IS VALID FOR SIX (6) MONTHS. IF AN ENFORCEMENT PERMIT FOR CONSTRUCTION HAS NOT BEEN ISSUED WITHIN SIX MONTHS, THE PLANS MUST BE RESUBMITTED TO THE CITY FOR REAPPROVAL

4. A PUBLIC WORKS INSPECTOR WILL INSPECT ALL WORKS WITHIN THE CITY OF SCOTTSDALE RIGHTS-OF-WAY AND IN EASEMENTS. NOTIFY INSPECTION SERVICES 24 HOURS PRIOR TO BEGINNING CONSTRUCTION BY CALLING 480-312-5750. WHENEVER EXCAVATION IS NECESSARY, CALL THE BLUE STAKE

CENTER, 602-263-1100, TWO WORKING DAYS BEFORE EXCAVATION PF2.0 POLE DETAIL & FOUNDATION DETAIL(S) BEGINS. THE CENTER WILL SEE THAT THE LOCATION OF THE UNDERGROUND UTILITY LINES IS INDENTIFIED FOR THE PROJECT CALL "COLLECT" IF NECESSARY.

ENCROACHMENT PERMITS ARE REQUIRED FOR ALL WORK IN PUBLIC RIGHTS-OF-WAY AND EASEMENTS GRANTED FOR PUBLIC PURPOSES. AN ENCROACHMENT PERMIT WILL BE ISSUED BY THE PF4.2 POLE EQUIPMENT BASE DETAILS CITY ONLY AFTER THE REGISTRANT HAS PAID A BASE FEE PLUS A FEE FOR INSPECTION SERVICES. COPIES OF ALL PERMITS MUST BE PF4.3 POLE EQUIPMENT BASE DETAILS RETAINED ONSITE AND BE AVAILABLE FOR INSPECTION AT ALL TIMES. FAILURE TO PRODUCE THE REQUIRED PERMITS WILL RESULT IN IMMEDIATE SUSPENSION OF ALL WORK UNTIL THE

PROPER PERMIT DOCUMENTATION IS OBTAINED. ALL EXCAVATION AND GRADING THAT IS NOT IN THE PUBLIC RIGHTS-OF-WAY OR NOT IN EASEMENTS GRANTED FOR PUBLIC USE ● PF8.0 FRP SIGN DETAILS & METAL TOPPER MUST CONFORM TO CHAPTER 70, EXCAVATION AND GRADING, OF THE LATEST EDITION OF THE UNIFORM BUILDING CODE PREPARED BY THE INTERNATIONAL CONFERENCE OF BUILDING OFFICIALS. A PERMIT FOR THIS GRADING MUST BE SECURED FROM THE CITY FOR A FEE ESTABLISHED BY THE UNIFORM BUILDING CODE.

CONSTRUCTION NOTES

REFER TO CITY OF SCOTTSDALE WATER SEPARATION DETAIL 2372 REFER TO CITY OF SCOTTSDALE SEWER SEPARATION DETAIL 2401 REFER TO CITY OF SCOTTSDALE PAVEMENT REPLACEMENT DETAIL

4. REFER TO CITY OF SCOTTSDALE TRENCH BACKFILL DETAIL 2201

T-1 PROJECT INFORMATION AND DATA

GENERAL INFORMATION SURVEY OVERALL SITE PLAN

● A-1.1 SITE PLAN

ENLARGED SITE PLAN EXISTING NORTH ELEVATION

 A-4 NEW NORTH ELEVATION EXISTING EAST ELEVATION

NEW EAST ELEVATION GENERAL NOTES/LEGEND/SHEET INDEX

ENLARGED POWER PLAN GROUNDING PLAN/ONE-LINE/CALCS

● E-2 SITE POWER PLAN

GROUNDING DETAILS PF1.0 PRODUCT INFORMATION & NOTES

PF1.1 PRODUCT INFORMATION & NOTES

PF4.0 POLE DETAILS

PF4.1 POLE EQUIPMENT BASE DETAILS

● PF5.0 POLE DETAILS & ANCHOR BOLT TEMPLATE

 PF6.0 CANISTER DETAILS PF7.0 FRP DETAILS

PROJECT DATA

VERIZON WIRELESS 126 W. GEMINI DR. TEMPE, ARIZONA, 85283 **CONTACT: DIEGO TORRES** PHONE: (602) 819-2949

PROPERTY OWNER

CITY OF SCOTTSDALE 7447 E. INDIAN SCHOOL ROAD SCOTTSDALE, ARIZONA, 85251 **CONTACT: KEITH NIEDERER** PHONE: (480) 312-2953

SITE ACQUISITION

SMARTLINK, L.L.C. 605 W. KNOX ROAD, STE 210 TEMPE, AZ, 85284 CONTACT: MARCK SAWYER PHONE: (480) 550-2088

ARCHITECT

YOUNG DESIGN CORP. 10245 E. VIA LINDA, SUITE 211 SCOTTSDALE, ARIZONA, 85258 CONTACT: BRIAN CUNNINGHAM PHONE: (480) 451-9609 FAX: (480) 451-9608

SURVEYOR

RLF CONSULTING 1214 N. STADEM DR. TEMPE, AZ, 85281 CONTACT: RYAN FIDLER PHONE: (480) 445-9189

PROJECT DESCRIPTION


THE PROJECT CONSISTS OF THE INSTALLATION OF (2) ANTENNAS MOUNTED INSIDE A NEW ROTATED REPLACEMENT SIGN POST. FACILITY IS UNMANNED AND IS NOT DESIGNED FOR HUMAN HABITATION.

SITE COORDINATES

33° 29' 35.036" N LATITUDE: LONGITUDE: 111° 55' 34.582" W GROUND ELEVATION: 1257.6' A.M.S.L.

SITE DIRECTIONS

FROM VERIZON OFFICE IN TEMPE, ARIZONA: DEPART W. GEMINI DR TOWARD S. MAPLE AVE. TURN RIGHT ONTO S. MAPLE AVE. TURN LEFT ONTO W. GUADALUPE RD. ROAD NAME CHANGES TO E. GUADALUPE RD. TURN LEFT ONTO S. RURAL RD. TAKE RAMP RIGHT FOR US-60 EAST TOWARD MESA / GLOBE. AT EXIT 176B, TAKE RAMP RIGHT AND FOLLOW SIGNS FOR AZ-101 LOOP NORTH. AT EXIT 48, TAKE RAMP RIGHT AND FOLLOW SIGNS FOR THOMAS RD. TURN LEFT ONTO E. THOMAS RD. TURN RIGHT ONTO N. SCOTTSDALE RD. TURN LEFT ONTO E. MAIN ST. ARRIVE AT E. MAIN ST ON THE LEFT. THE VERIZON ANTENNAS ARE ON THE TRAFFIC SIGNAL POLE LOCATED ON THE SW CORNER OF E. MAIN ST & N. SCOTTSDALE RD.

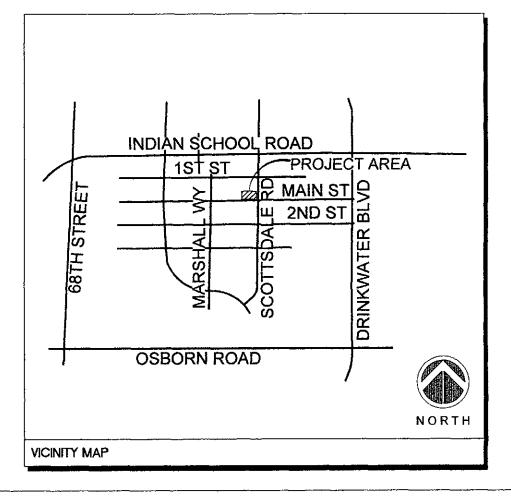

verizon

126 W. GEMINI DR. TEMPE, AZ 85283

FINTERNAL REVIEW-


CONSTRUCTION SIGNATURE

RF SIGNATURE

FACILITIES SIGNATURE

10245 E. Via Linda, Scottsdale, AZ 85258 ph: 480 451 9609 fax: 480 451 9608

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10/10/2017 SUBMITTAL

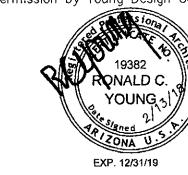- ARCHITECTS JOB NO. -YDC-6199

PROJECT INFORMATION -

PHO_ZUZU-VALLEYHO_2_SC

SCOTTSDALE RD & MAIN ST SCOTTSDALE, AZ 85251

TITLE SHEET

-JURISDICTION APPROVAL

SHEET TITLE -

SHEET NUMBER

SURVEYOR NOTES

1. A TITLE REPORT WAS NOT PROVIDED AT THE TIME OF THE SURVEY.


- 2. SURVEYOR HAS NOT PERFORMED A SEARCH OF PUBLIC RECORDS TO DETERMINE ANY DEFECT IN TITLE.
- 3. THE BOUNDARY SHOWN HEREON IS PLOTTED FROM RECORD INFORMATION AND DOES NOT CONSTITUTE A BOUNDARY SURVEY OF THE PROPERTY.
- 4. SURVEYOR DOES NOT GUARANTEE THAT ALL UTILITIES ARE SHOWN OR THEIR LOCATIONS. IT IS THE RESPONSIBILITY OF THE CONTRACTOR AND DEVELOPER TO CONTACT BLUE STAKE AND ANY OTHER INVOLVED AGENCIES TO LOCATE ALL UTILITIES PRIOR TO CONSTRUCTION. REMOVAL, RELOCATION AND/ OR REPLACEMENT IS THE RESPONSIBILITY OF THE CONTRACTOR.

(IN FEET) 1 inch = 10 ft.


PROJECT META DATA

- ELEVATIONS SHOWN HEREON ARE REPRESENTED IN NORTH AMERICAN VERTICAL DATUM OF 1988 (NAVD88) ESTABLISHED FROM GPS DERIVED ELLIPSOID HEIGHTS, APPLYING GEOID 09 SEPARATIONS CONSTRAINING TO NGS CORS STATIONS PROVIDED IN THE "ONLINE POSITIONING USER SERVICE" (OPUS) SOLUTION FOR THIS SPECIFIC SITE.
- 2. BEARINGS SHOWED HEREON ARE BASED UPON U.S. STATE PLANE NAD83 COORDINATE SYSTEM ARIZONA STATE PLANE COORDINATE ZONE CENTRAL, DETERMINED BY GPS OBSERVATIONS.
- 3. FIELD WORK FOR THIS PROJECT WAS PERFORMED ON 03/03/16.

LESSOR'S LEGAL DESCRIPTION CITY OF SCOTTSDALE RIGHT-OF-WAY

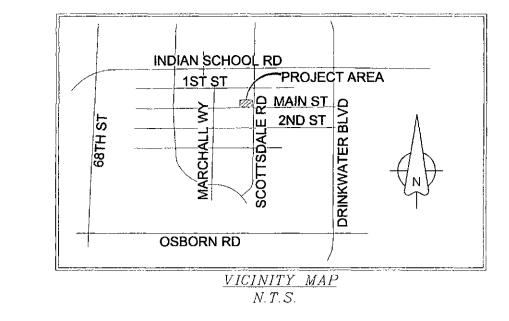


LEGEND

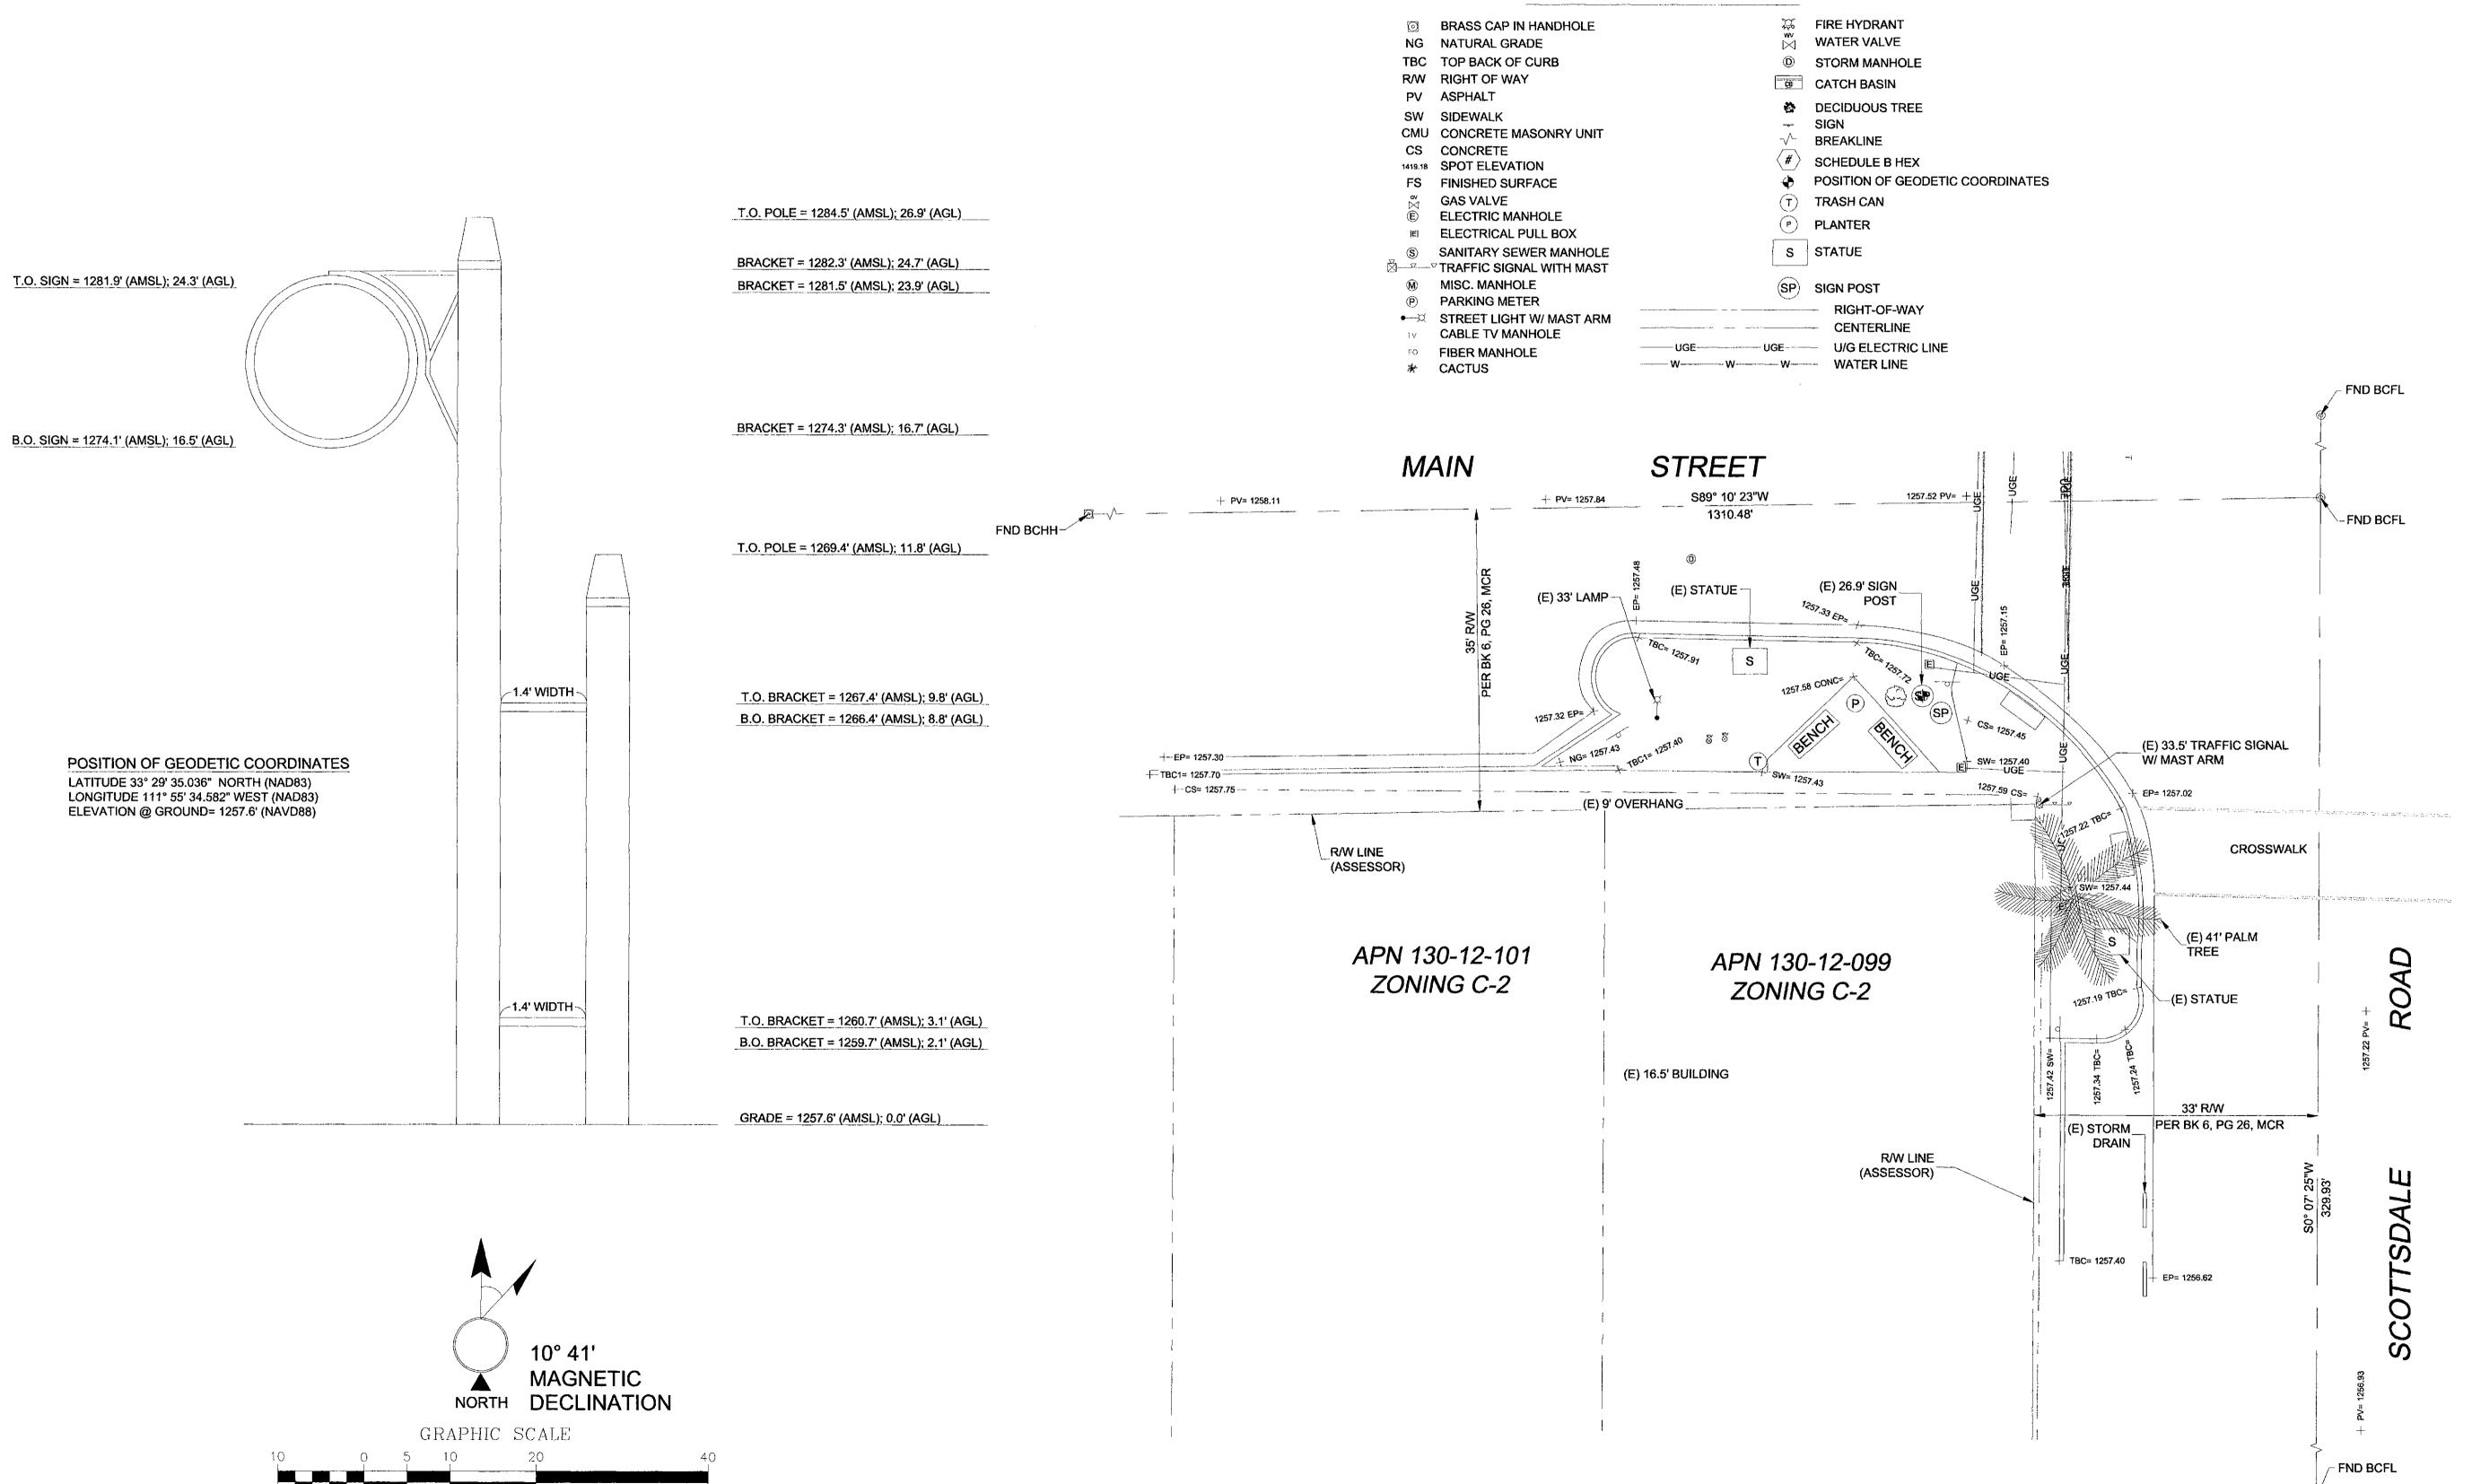

verizon

126 W. GEMINI DR. TEMPE, AZ 85283

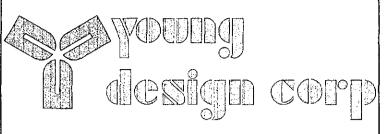

architecture / project management 10245 E. Via Linda, Scottsdale, AZ 85258 ph: 480 451 9609 fax: 480 451 9608 e mail: corp@ydcoffice.com

FIELD BY: JMM

DRAWN BY: JTJ

DRAWN BY: JTJ

CHECKED BY: RLF

REVISIONS

1 03/14/16 PRELIMINARY
NO. DATE DESCRIPTION

CONSULTING LAND SURVEY • MAPPING SOLUTIONS

LAND SURVEY • MAPPING SOLUTIONS
1214 N. STADEM DR. • TEMPE AZ 85281
WWW.RLFCONSULTING.COM • 480-445-0189



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PROJECT No. **09006767**

09006767

PHO_ZUZU-VALLEYHO_2_SC

SITE ADDRESS:

SCOTTSDALE RD & MAIN ST SCOTTSDALE, AZ 85251


SHEET TITLE:

SURVEY DETAIL

SHEET NO.

EET NO. REVISION:

LS-1

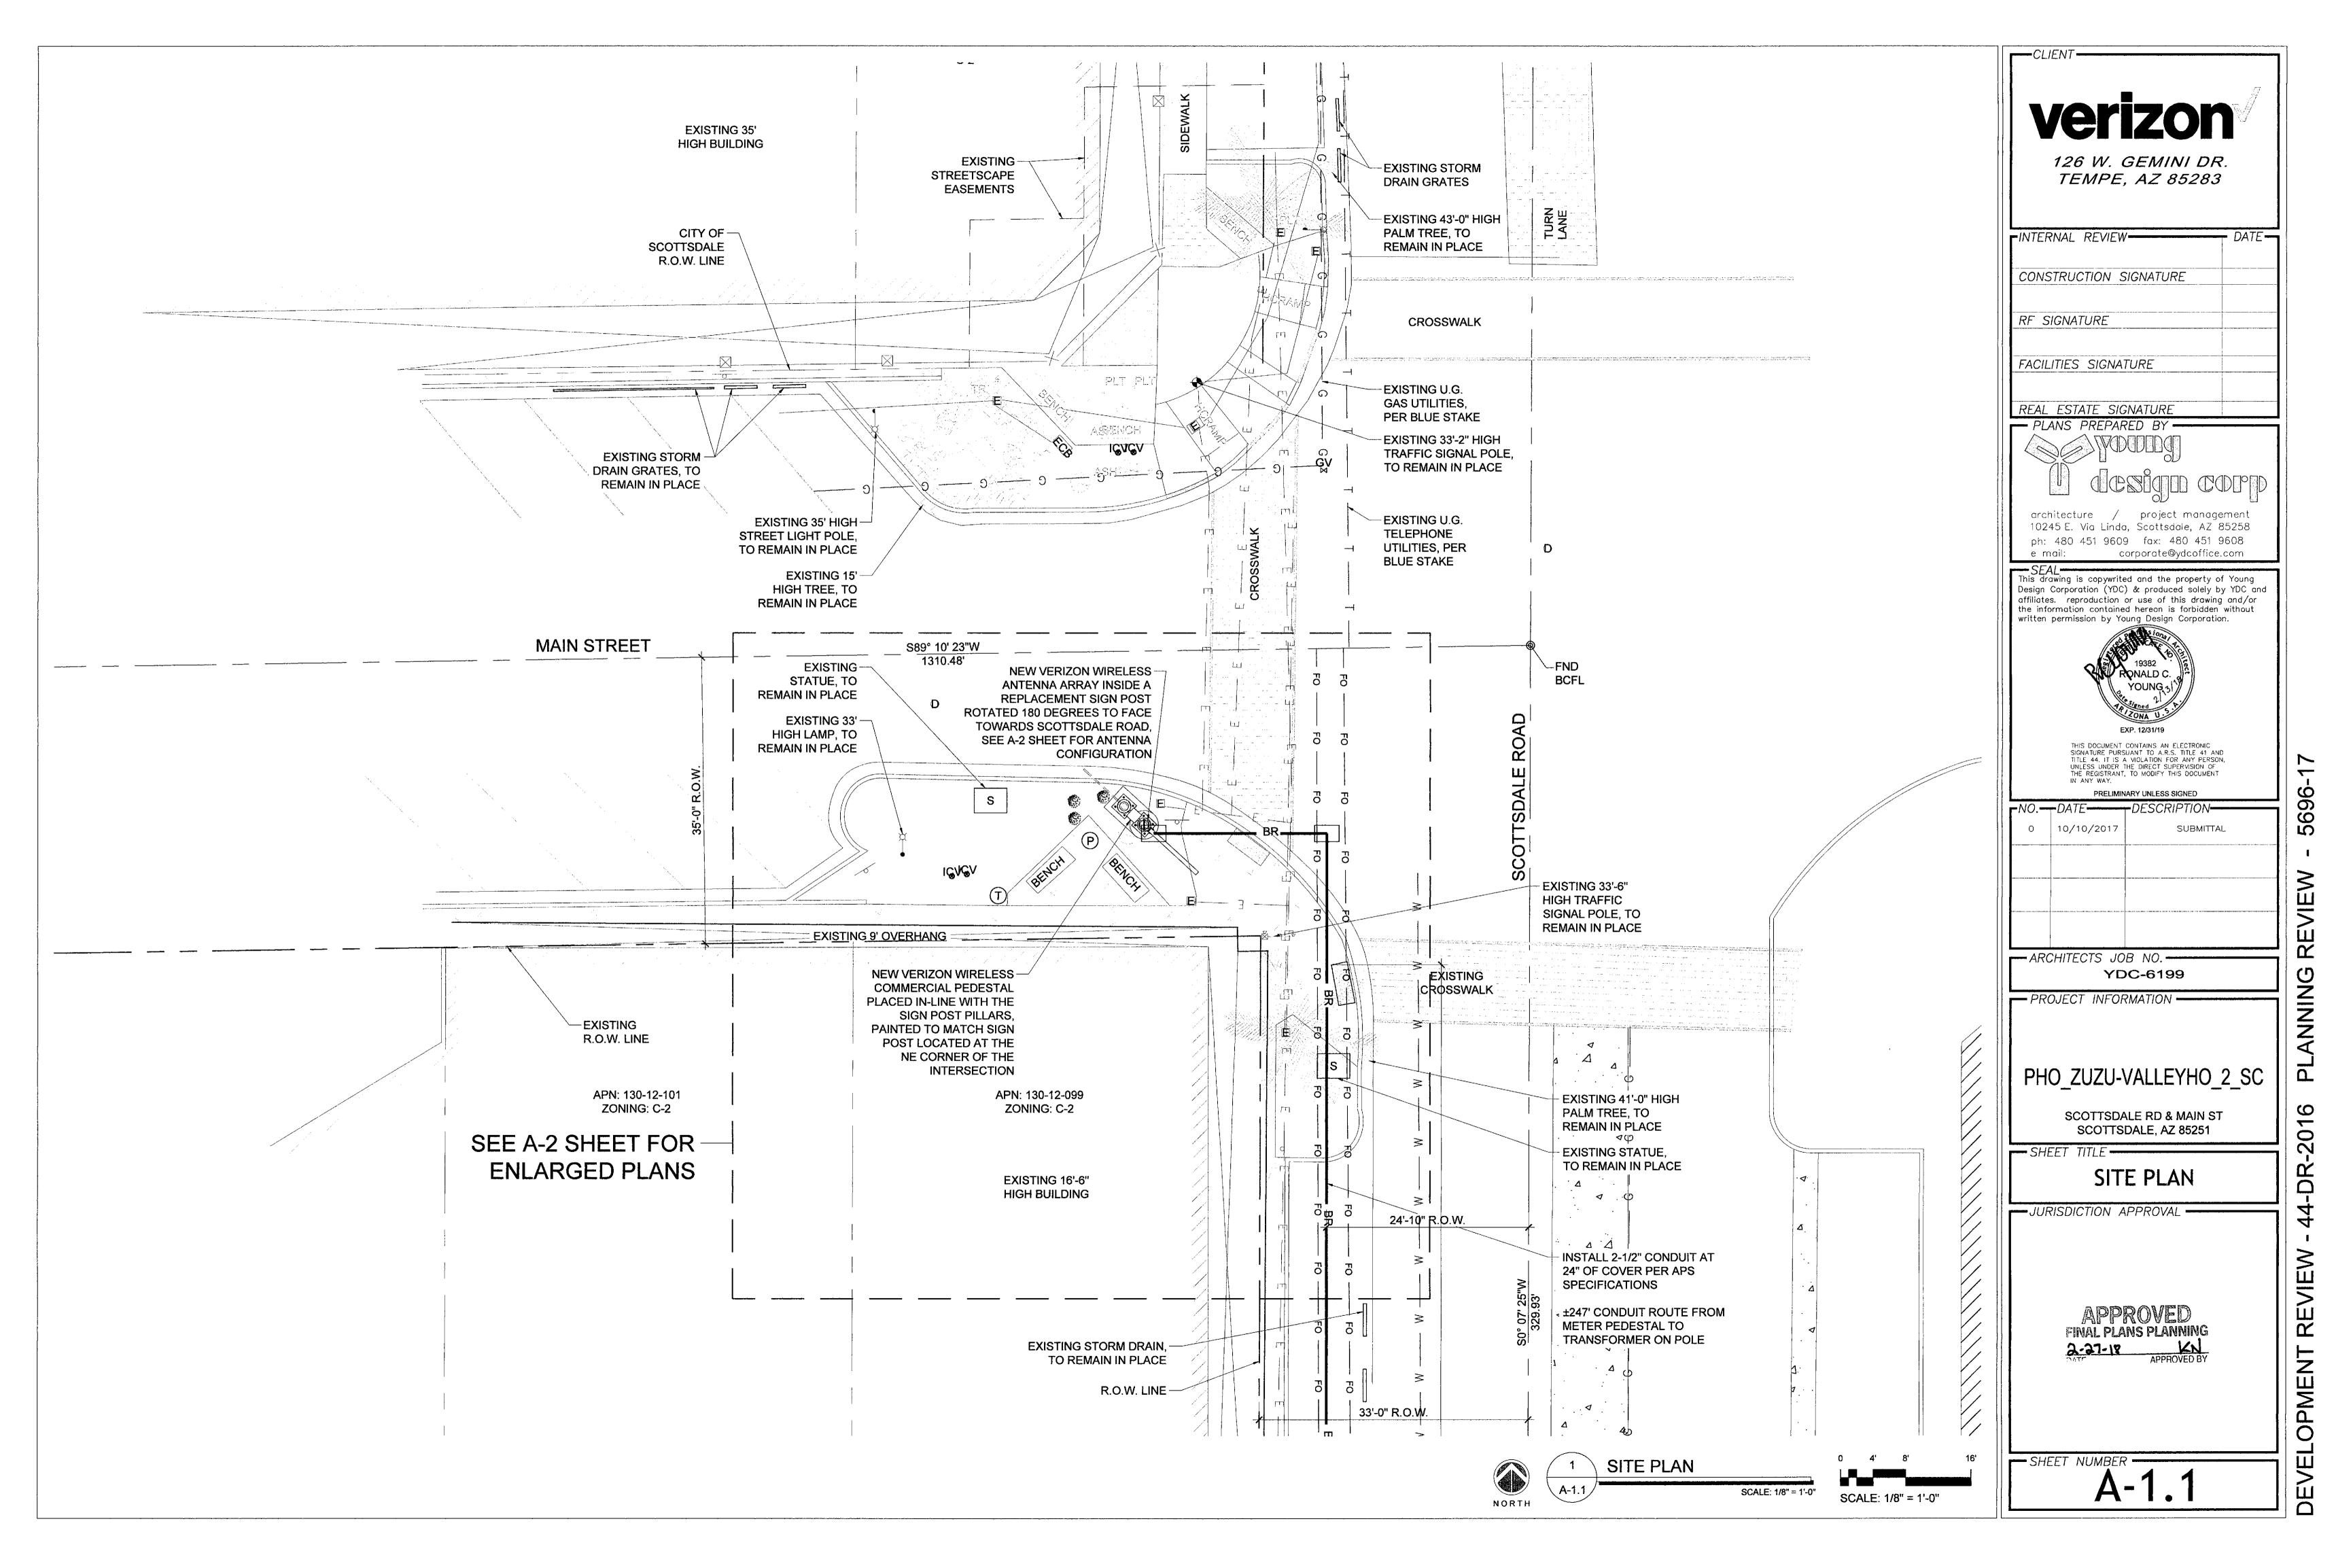




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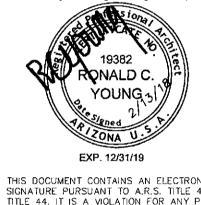
INTERNAL REVIEW	- DATE-
CONSTRUCTION SIGNATURE	
RF SIGNATURE	
FACILITIES SIGNATURE	



REAL ESTATE SIGNATURE
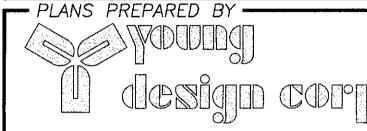
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REVIEW

PLANNING

44-DR-2016

DEVELOPMENT REVIEW

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}	0	10/10/2017	SUBMITTAL
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-ARCHITECTS JOB NO. YDC-6199

- PROJECT INFORMATION

PHO_ZUZU-VALLEYHO_2_SC

SCOTTSDALE RD & MAIN ST SCOTTSDALE, AZ 85251


BORE ROUTE PLAN

JURISDICTION APPROVAL

SHEET NUMBER A-1.2

SCALE: 1" = 10'-0"

SCALE: 1" = 10'-0"

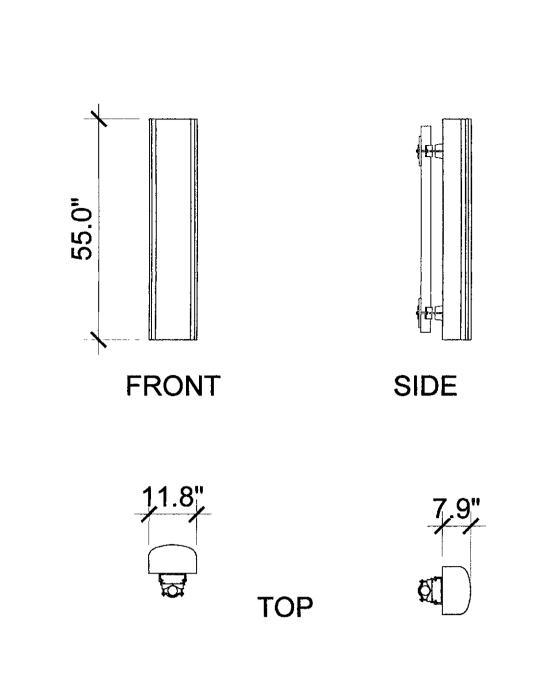


ANTENNA DETAIL

	COAXIAL CABLE TABLE				
SECTOR	AZIMUTH	LENGTH	QTY.	SIZE	TYPE
ALPHA	90°	± 22'-0"	4	1/2"	T.B.D.
BETA	270°	± 22'-0"	4	1/2"	T.B.D.


NOTE:
ALL AZIMUTHS SHOWN ARE RELATIVE TO TRUE NORTH, **UNLESS NOTED OTHERWISE**

*IT SHALL BE THE CONTRACTORS RESPONSIBILITY TO VERIFY AZIMUTHS DEPICTED HEREIN WITH RF DEPARTMENT PRIOR TO INSTALLING ANTENNAS.

COAX CABLE INFORMATION

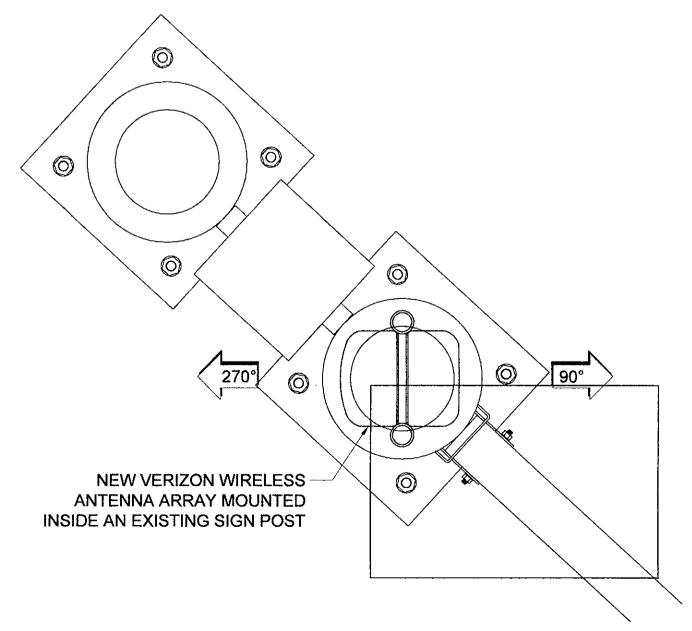

ANTENNA CONFIGURATION

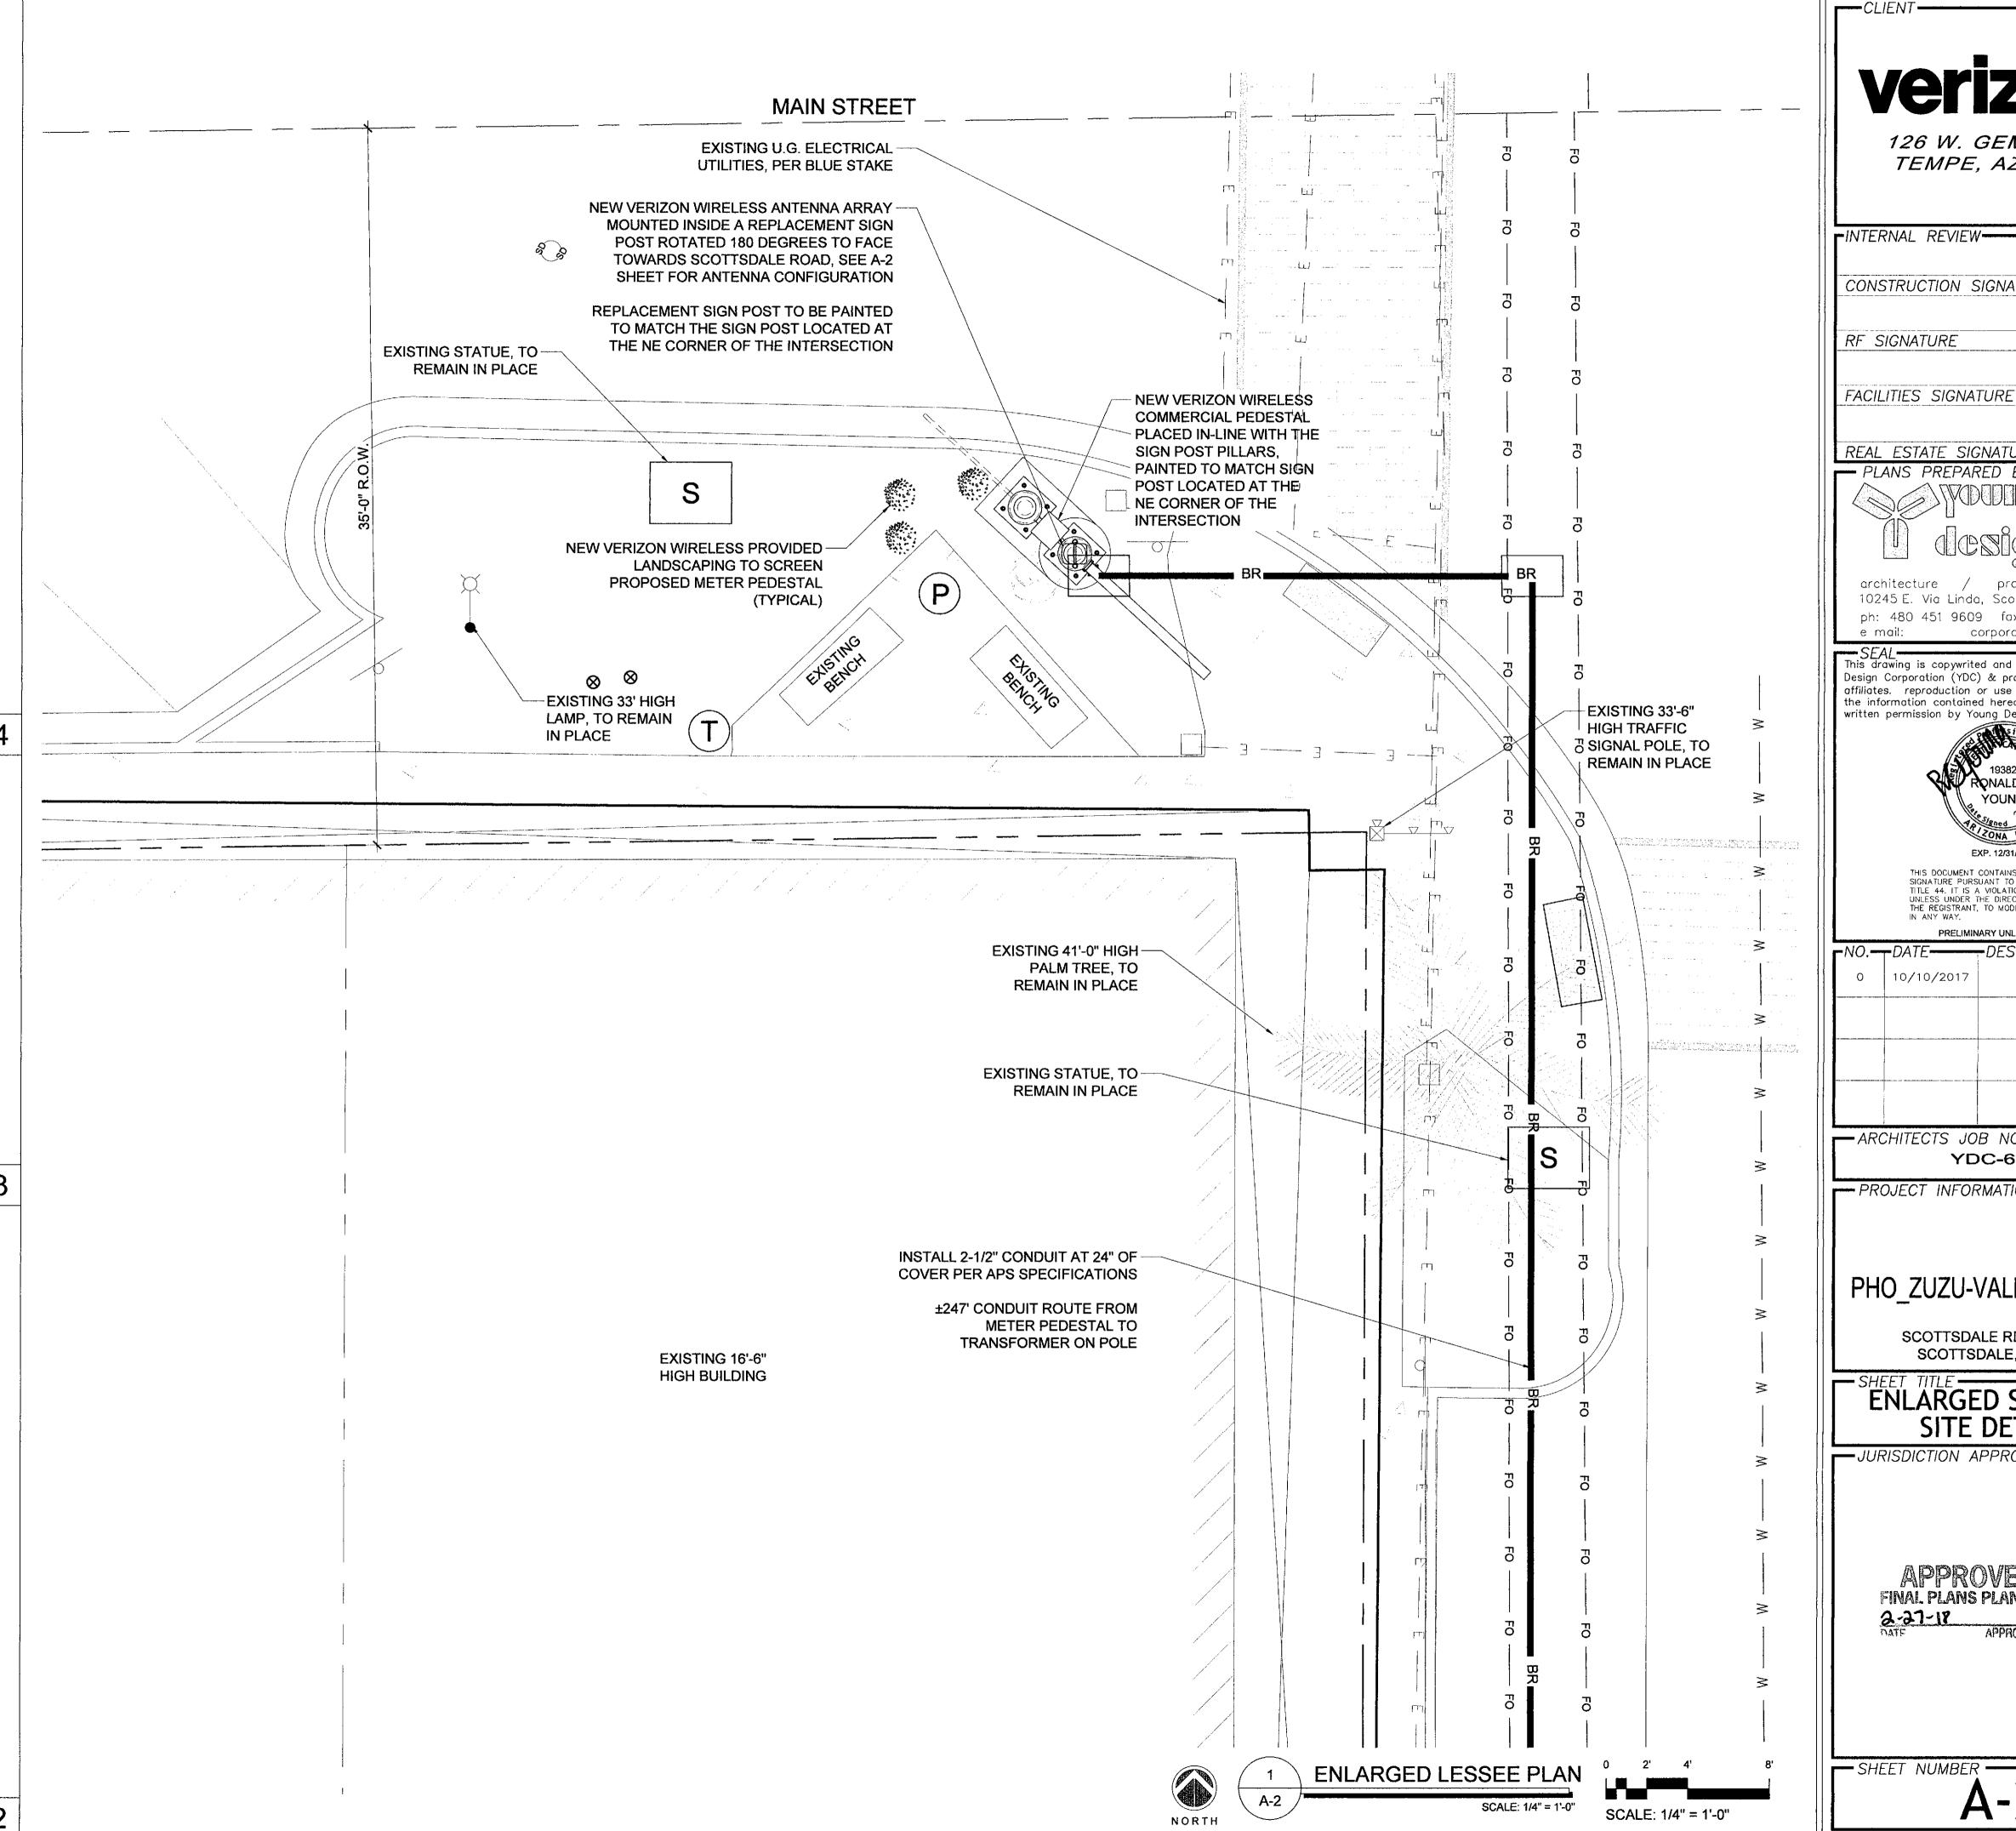



126 W. GEMINI DR. TEMPE, AZ 85283


CONSTRUCTION	SIGNATURE	
		ļ
RF SIGNATURE		

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- PLANS PREPARED BY -

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PRELIMINARY UNLESS SIGNED ■NO. — DATE — DESCRIPTI 0 10/10/2017 SUBMITTAL

- ARCHITECTS JOB NO. -YDC-6199

--- PROJECT INFORMATION

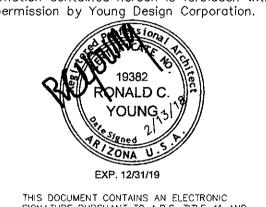PHO_ZUZU-VALLEYHO_2_SC

SCOTTSDALE RD & MAIN ST SCOTTSDALE, AZ 85251


ENLARGED SITE PLAN SITE DETAILS


JURISDICTION APPROVAL

FINAL PLANS PLANNING

SHEET NUMBER

01

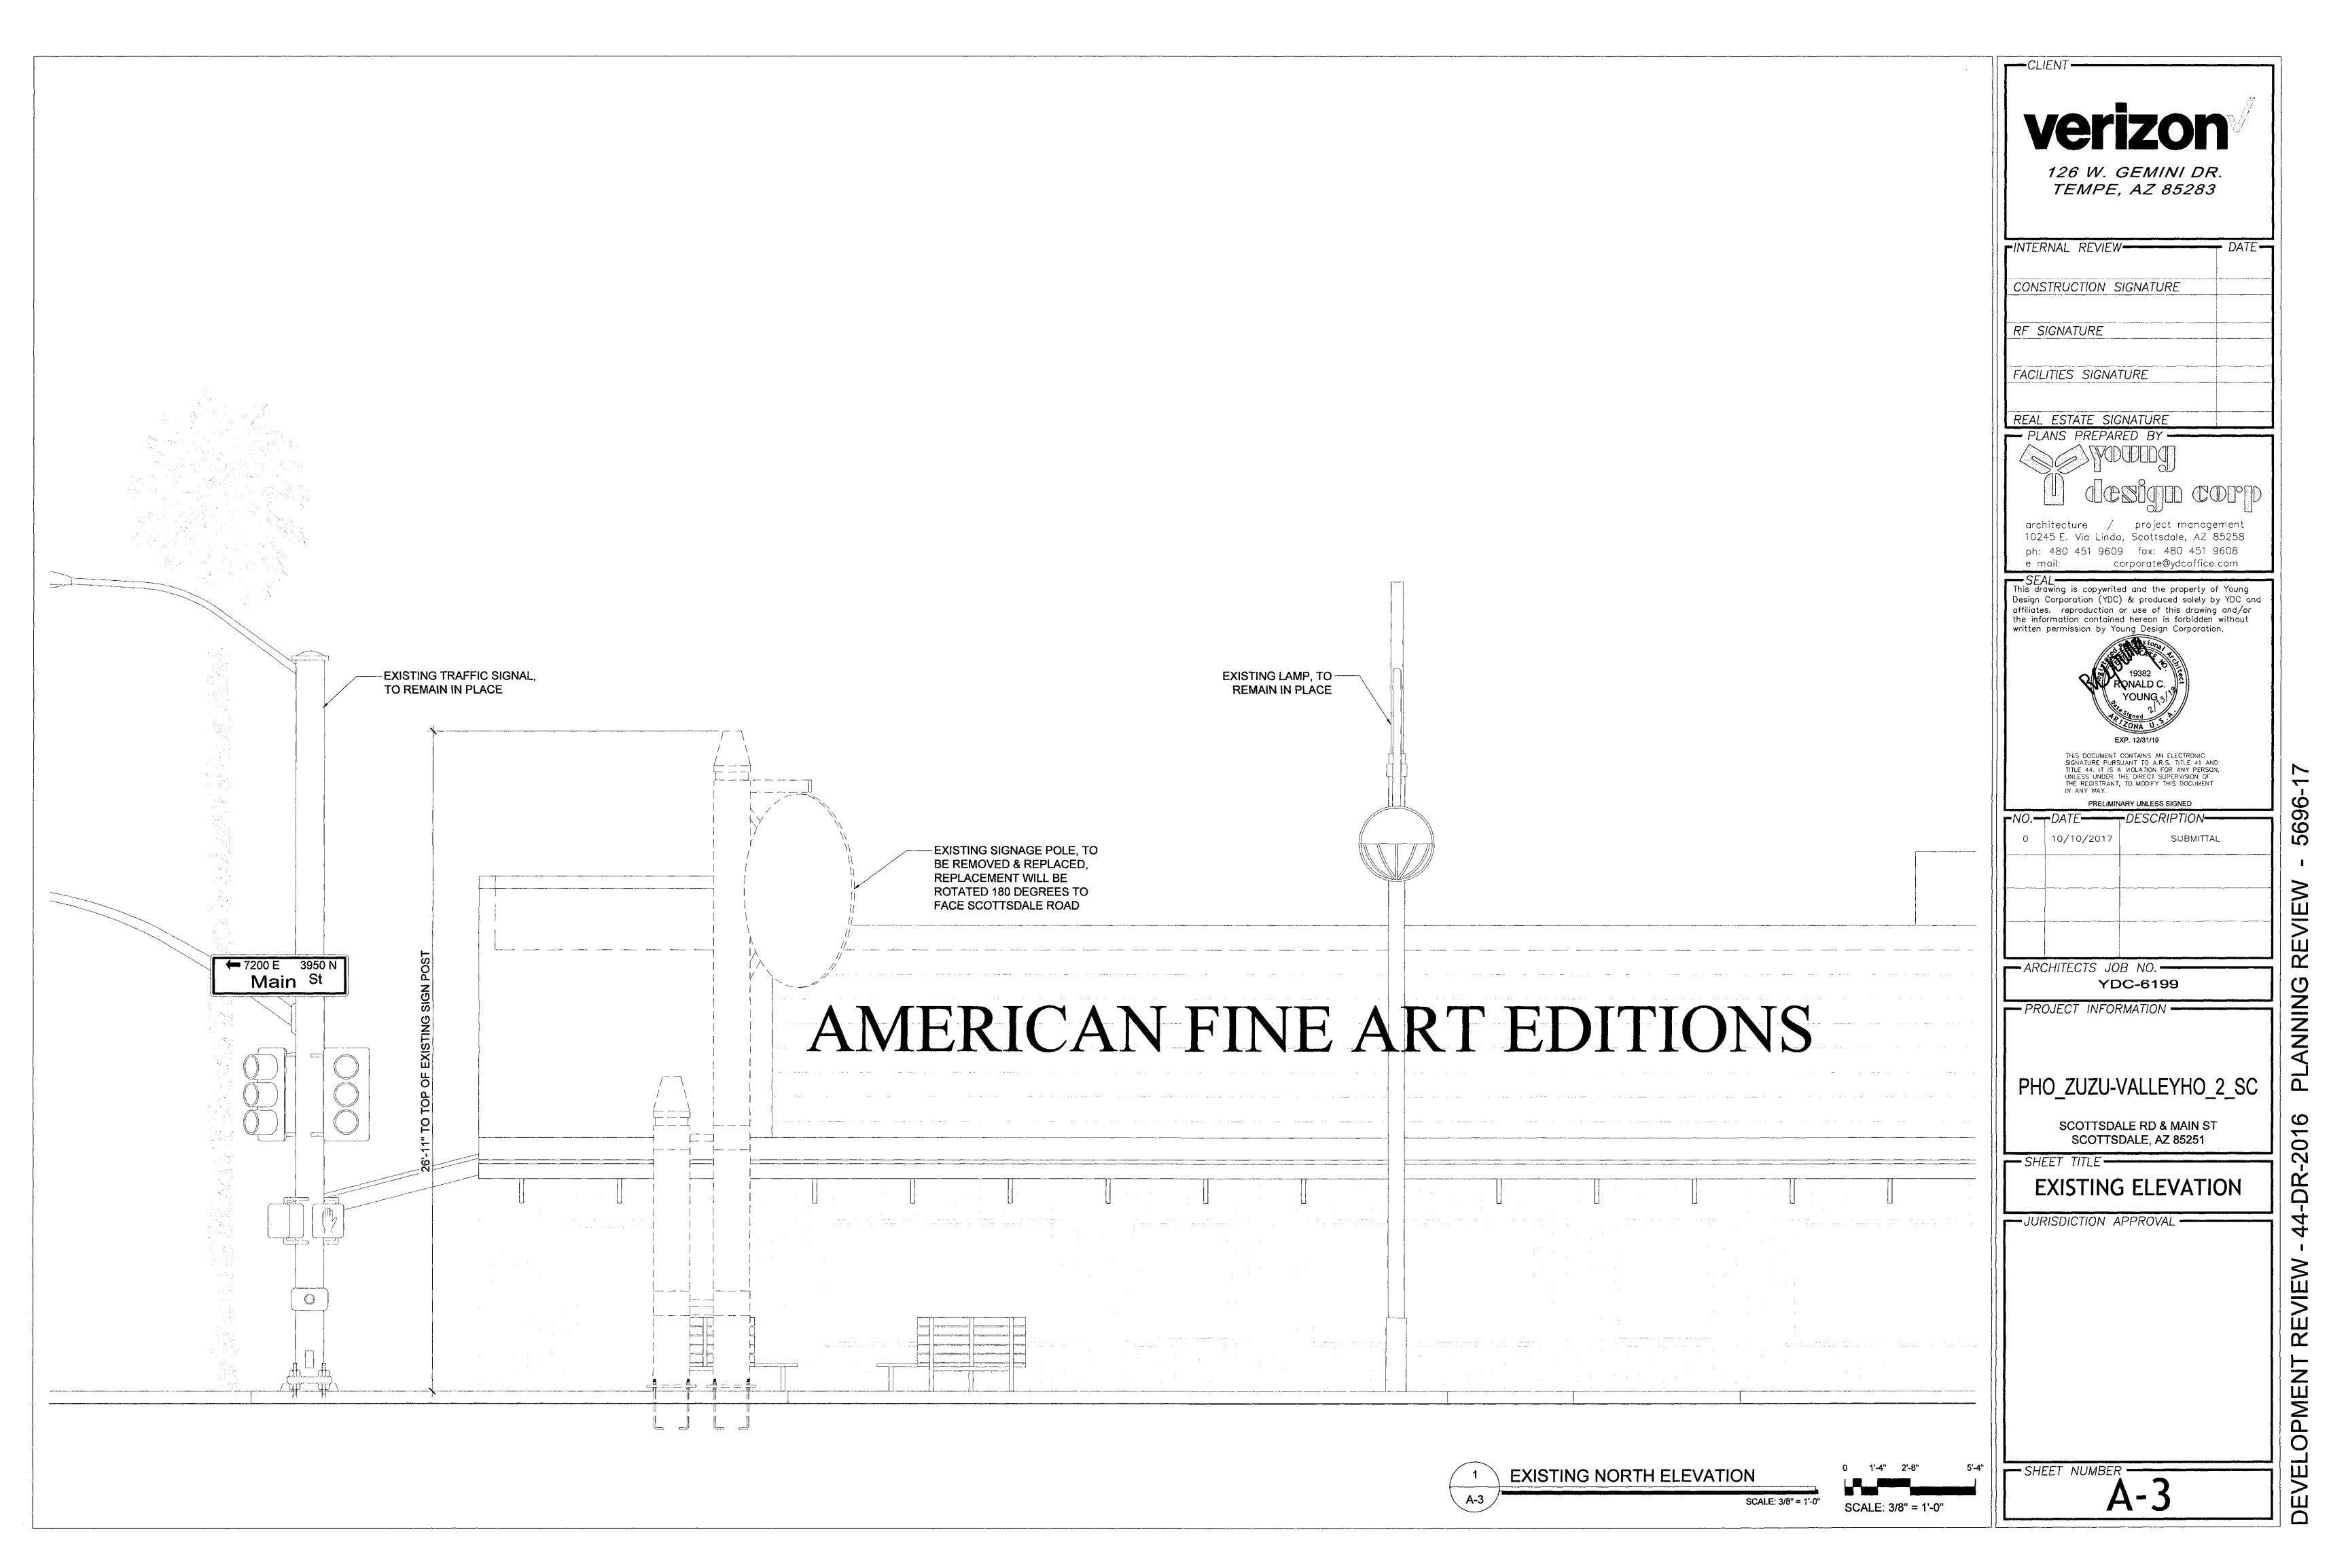

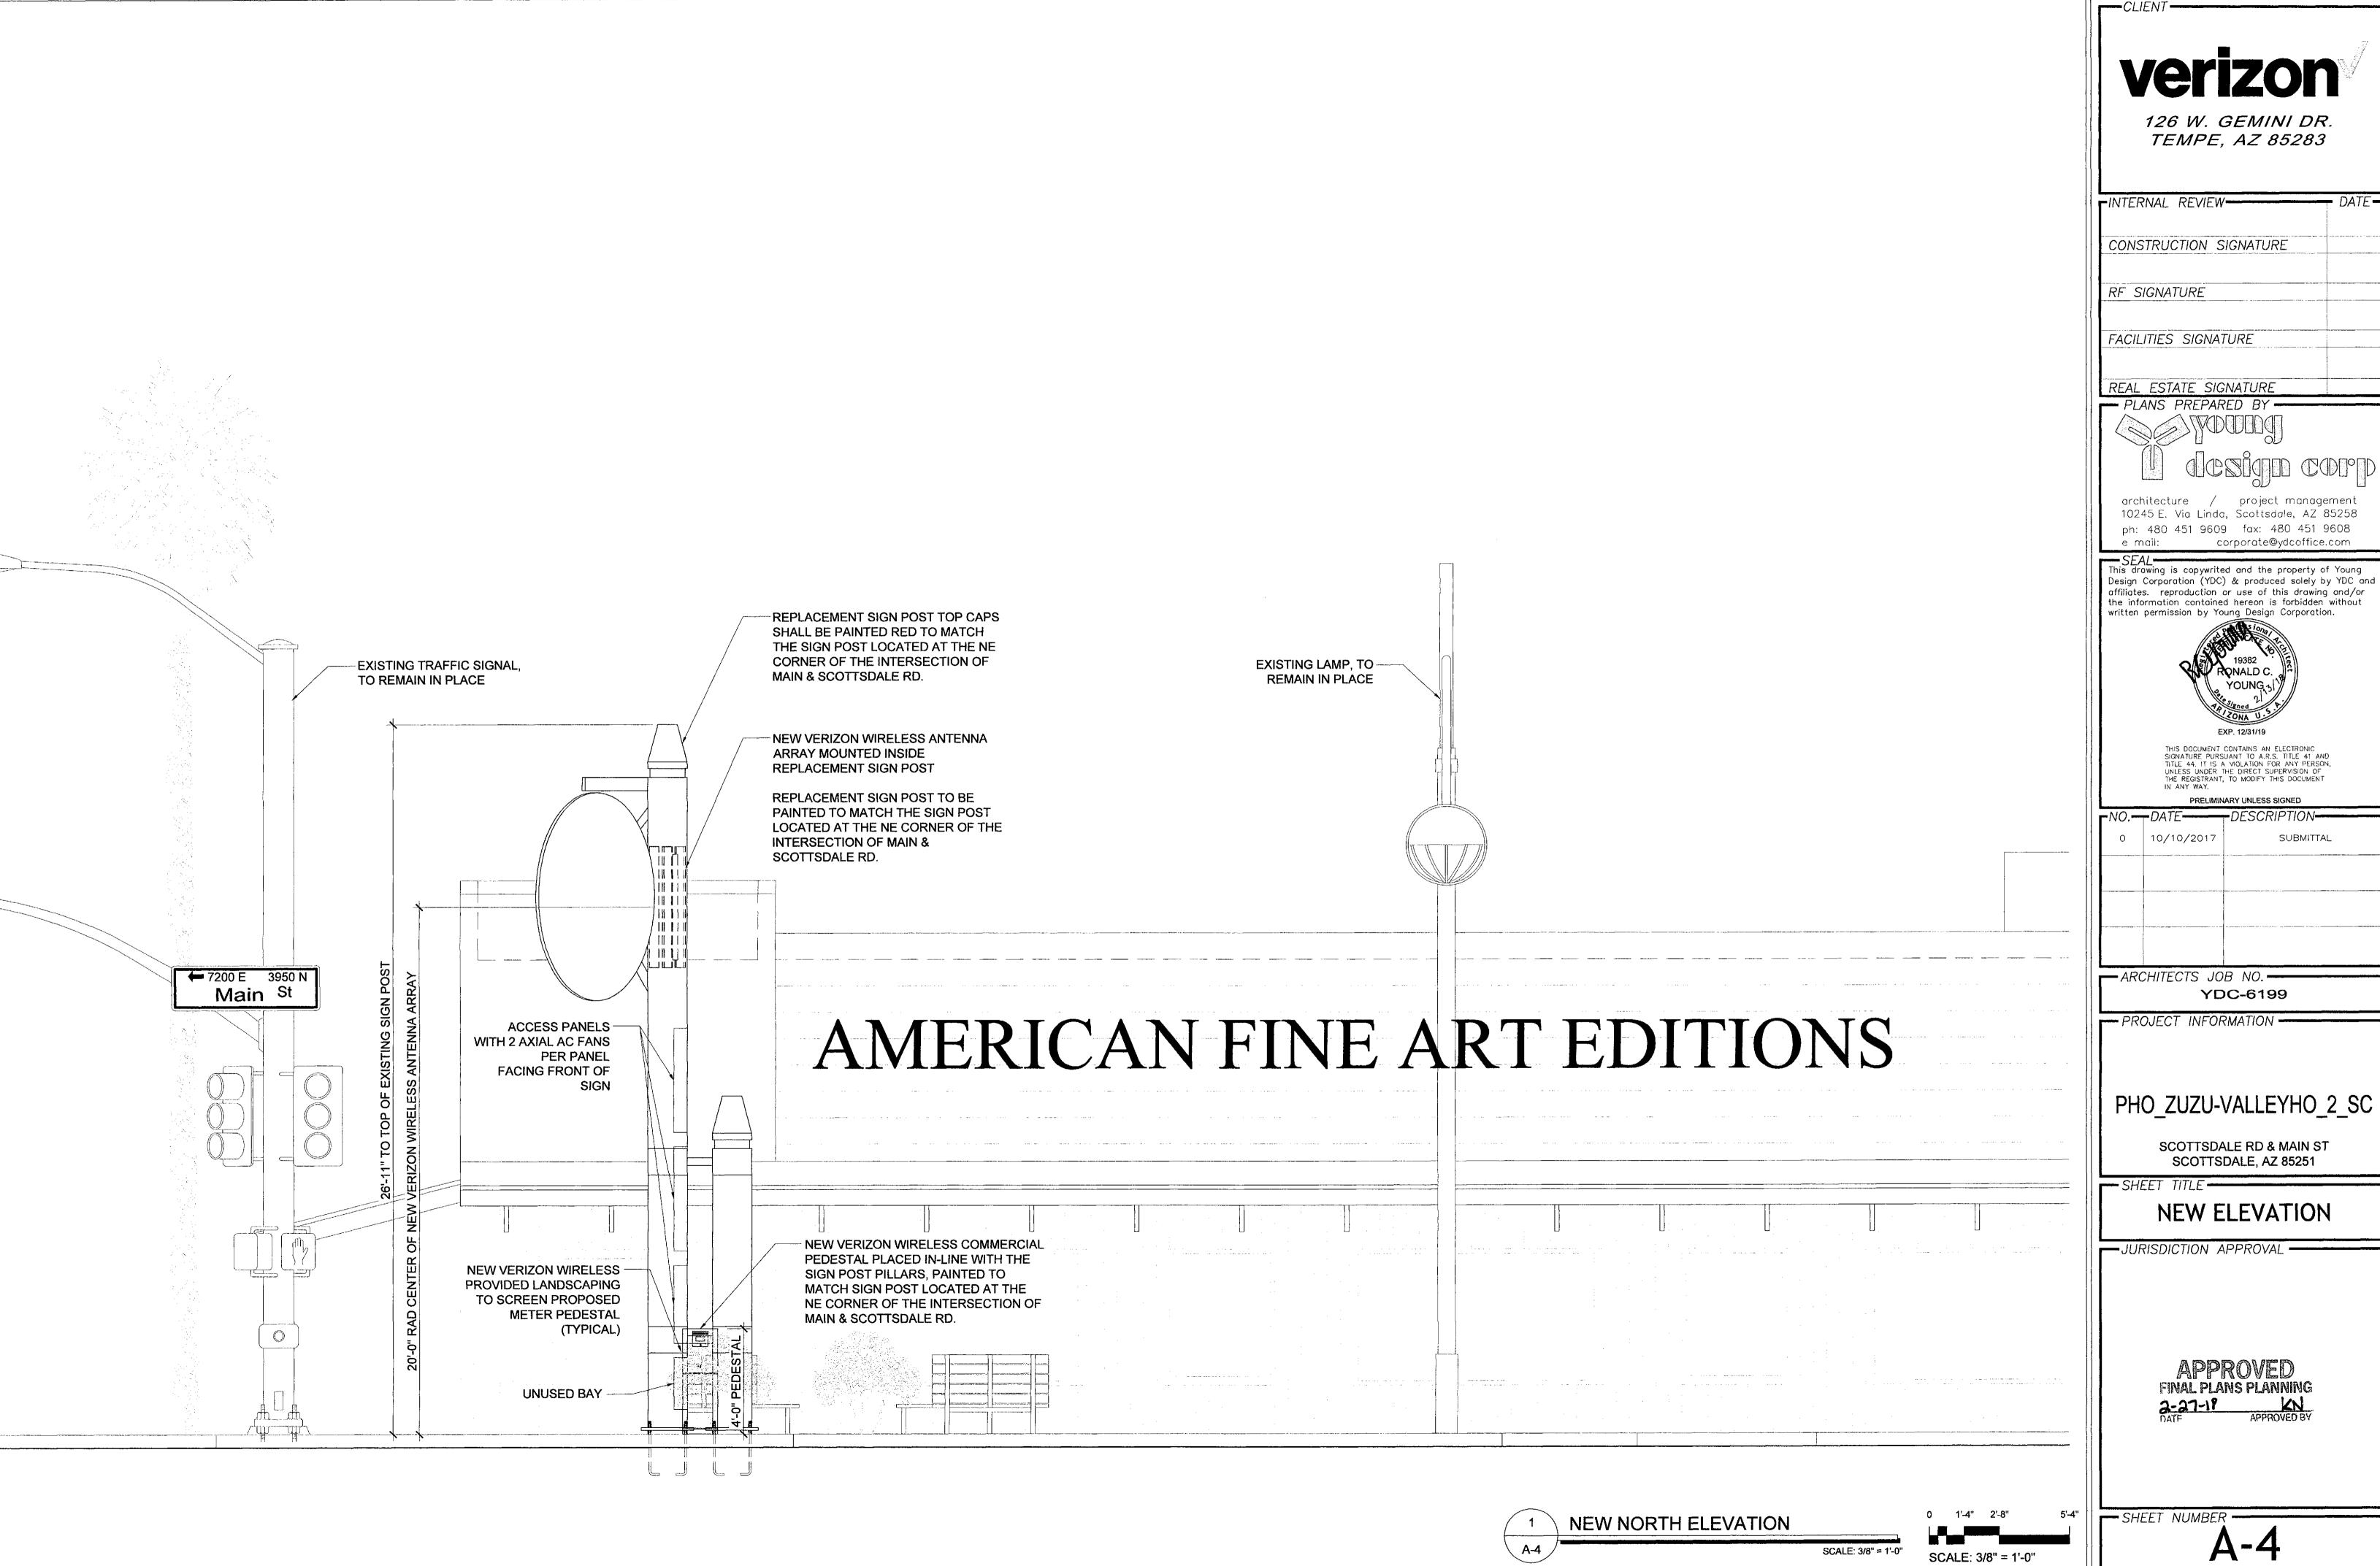

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DR

INTERNAL REVIEW CONSTRUCTION SIGNATURE RF SIGNATURE REAL ESTATE SIGNATURE PLANS PREPARED BY Crehitecture project management 10245 E. Via Linda, Scottsdole, AZ 85258 ph. 480 451 9608 for 480 451 9608 e moil: Corporate@ydcoffice.com SEAL This drawing is copywrited and the property of Young Design Corporation (YDC) & produced solely by YDC offliates. reproduction or use of this drawing and/ot the information contained hereon is forbidden without written permission by Young Design Corporation. PREJIMINARY UNLESS SIGNED NO.—DATE—DESCRIPTION— O 10/10/2017 SUBMITTAL PHODY TINFORMATION PHO ZUZU-VALLEYHO 2 S SCOTTSDALE RD & MAIN ST SCOTTSDALE RD & MAIN ST SCOTTSDALE, AZ 85251 SHEET TITLE EXISTING ELEVATION JURISDICTION APPROVAL	Veri	zon
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10245 E. Via Linda, Scottsdale, AZ 85258 ph: 480 451 9609 fax: 480 451 9608 e mail: corporate@ydcoffice.com SEAL This drawing is copywrited and the property of Young Design Corporation (YDC) & produced solely by YDC affiliates. reproduction or use of this drawing and/c the information contained hereon is forbidden without written permission by Young Design Corporation. PRONALD C. YOUNG 5 19382 PRONALD C. THE TOWN 5 19382 PRONALD C. T		sign cdn°
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ANNING

A-5


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architecture / project management 10245 E. Via Linda, Scottsdale, AZ 85258 ph: 480 451 9609 fax: 480 451 9608 e mail: corporate@ydcoffice.com

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REVIEW

ANNING

44-DR-2016

DEVELOPMENT REVIEW

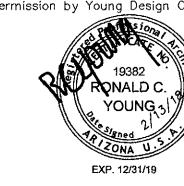	_NO.—	-DATE	-DESCRIPTION
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-- ARCHITECTS JOB NO. -

YDC-6199 - PROJECT INFORMATION

PHO_ZUZU-VALLEYHO_2_SC

SCOTTSDALE RD & MAIN ST SCOTTSDALE, AZ 85251

SHEET TITLE -**NEW ELEVATION**

JURISDICTION APPROVAL

APPROVED FINAL PLANS PLANNING

SHEET NUMBER -**A-6**

PROJECT INFORMATION

October 20, 2017

ISE Job No. 10704 By: AG Customer: Larson Camouflage

VZW PHO ZUZU-VALLEYHO 2 SC

27'-2" Mono Pole With FRP sign

Location: Scottsdale Rd & Main St Scottsdale, AZ 85251

DESIGN CRITERION:

2015 IBC, 115 MPH Ultimate Wind Speed, Reducible per 1609.1.1 EIA/TIA-222-G (2009) 90 MPH Design Wind Speed (3-Sec Gust) EXP C, Topo Class I, Tower Class II

POLE SPECIFICATIONS

Round Section Shape N/A IN/FT PipeTaper API 5LX GR 42 Pole Material A36 Base Plate 1.25" x 44, F1554-36 Anchor Bolts

Diameter Section 18.000 5.833 2.5"X2.5" 2.5"X2.5" (2)HSS Mast 0.050 0.3125 17.000 0.807 18.000 18.000 Pole 1 (Tall) 0.250 Pole 2 (Short) 10.688 0.507 18.000 18.000 0.250 Base Plate 0.115 1.250 24" SQUARE w/ 18.125" ID

EARTHQUAKE DESIGN DATA

IMPORTANCE FACTOR (1): 1 OCCUPANCY CATEGORY: 1

 $S_s = 0.184$ $S_{DS} = 0.196$ $S_1 = 0.060$ $S_{D1} = 0.096$

SEISMIC DESIGN CATEGORY:

SITE CLASS: SEISMIC RESPONSE COEFFICIENT: 0.131 DESIGN BASE SHEAR:

ANALYSIS PROCEDURE USED EQUIVALENT LATERAL FORCE PROCEDURE

DESIGN LOADS (Unfactored Base Wind Reactions)

RESPONSE MODIFICATION FACTOR (R): 1.50

41.959 Ft-Kips Moment = Shear = 2.234 Kips 1.915 Kips Axial

DEFLECTIONS

90 MPH Wind Lateral (in.) Sway (°) Lateral (in.) Sway (°) 3.109 1.925 .772

APPURTENANCES

_Elevation (π.)	(Qty)	Description
22'-8"	(1)	FRP SIGN & Stand-off Mount
20'-6"	(2)	Antenna 11.8"x7.9"x55"
17'-7" to 23'-5"	(1)	18"Ø Canister

Verizon*

PHO_ZUZU-VALLEYHO_2_SC (SMALL CELL)

SCOTTSDALE RD & MAIN ST., Scottsdale, AZ 85251

GENERAL NOTES:

- 1. ALL STEEL SHALL MEET THE REQUIREMENTS OF THE "STANDARD SPECIFICATIONS FOR STRUCTURAL STEEL" ASTM A36, UNLESS OTHERWISE NOTED ON THE STRUCTURAL PLANS OR BELOW.
- 2. ALL ROUND STEEL PIPE SHALL MEET THE REQUIREMENTS OF ASTM A53 TYPE E OR S GRADE B (35 KSI YIELD POINT MATERIAL) OR ASTM A501 (36 KSI YIELD POINT
- 3. ALL TUBE STEEL (SQUARE OR RECTANGULAR) SHALL MEET THE REQUIREMENTS OF ASTM A500 GRADE B (46 KSI YIELD POINT MATERIAL),
- 4. ALL POLYGON FORMED STEEL SHAFTS SHALL MEET THE REQUIREMENTS OF ASTM A572 GRADE 65 (65 KSI YIELD POINT MATERIAL).
- 5. ALL WELDED CONNECTIONS SHALL CONFORM TO THE LATEST VERSION OF THE AMERICAN WELDING SOCIETY AWS 01.1 CODE. ALL WELD ELECTRODES OR WIRE SHALL AT A MINIMUM CONFORM TO E70 ELECTRODES (70 KSI YIELD).
- 6. ALL STEEL SHAPES AND PLATES SHALL BE HOT-DIPPED GALVANIZED ACCORDING TO ASTM A123. ALL STEEL NUTS AND BOLTS AND ASSOCIATED HARDWARE SHALL BE HOT-DIPPED ACCORDING TO ASTM A153.
- WIND TESTING OF PINE TREE BRANCHES HAS BEEN COMPLETED BY THE SUPPLIER OF THE BRANCHES, LARSON CAMOUFLAGE. LARSON CAMOUFLAGE HAS VERIFIED THE STRENGTH OF THE BRANCHES THROUGH FULL SCALE WIND TESTING. THE WIND AREA USED IN THE CALCULATIONS IS BASED ON THE WIND TEST DATA. THE CALCULATION ACCOUNT FOR PINE TREE BRANCHES ATTACHED AT THE TOP OF THE MONOPOLE. ISE INC. HAS REVIEWED AND APPROVED THE WIND TEST METHODS.
- 8. THE MAIN MONOPOLE STRUCTURE SHALL BE FABRICATED BY A JURISDICTION CERTIFIED FABRICATOR OF CONVENTIONAL STEEL STRUCTURES.
- 9. SPECIAL INSPECTION SHALL BE PERFORMED ACCORDING TO SECTION 1704 OF THE 2015 IBC REFER TO TABLE "SUMMARY OF SPECIAL INSPECTION" ON THIS SHEET.
- 10. IT IS THE CONTRACTORS SOLE RESPONSIBILITY TO NOTIFY THE SPECIAL INSPECTOR OR INSPECTION AGENCY (OR THE INSPECTING GEOTECHNICAL ENGINEER) AT LEAST ONE WORKING DAY PRIOR TO PERFORMING ANY WORK THAT REQUIRES SPECIAL INSPECTION. PER THE 2015 IBC ANY WORK THAT REQUIRES SPECIAL INSPECTION THAT IS INSTALLED OR COVERED WITHOUT THE APPROVAL OF THE SPECIAL INSPECTION IS SUBJECT TO REMOVAL.
- 11. THE LIST OF SPECIAL INSPECTIONS IS IN ADDITION TO INSPECTIONS REQUIRED BY SECTION 110 OF THE 2015 IBC. SPECIAL INSPECTION IS NOT A SUBSTITUTION FOR INSPECTION BY A CITY INSPECTOR.
- 12. THE SPECIAL INSPECTOR SHALL BE APPROVED BY THE LOCAL JURISDICTION TO PERFORM THE TYPES OF INSPECTION REQUIRED.
- 13. CONTINUOUS INSPECTION IS ALWAYS REQUIRED DURING THE PERFORMANCE OF THE WORK UNLESS OTHERWISE SPECIFIED.
- 14. ANY SUPPORT SERVICE PERFORMED BY THE ENGINEER OF RECORD DURING CONSTRUCTION SHALL BE DISTINGUISHED FROM CONTINUOUS AND DETAILED INSPECTION SERVICES, WHICH ARE FURNISHED BY OTHERS. THESE SUPPORT SERVICES PERFORMED BY THE ENGINEER OF RECORD ARE ONLY FOR THE PURPOSE OF ASSISTING IN THE QUALITY CONTROL AND IN ACHIEVING CONFORMANCE WITH THE CONTRACT DOCUMENTS. THIS SUPPORT DOES NOT GUARANTEE THE CONTRACTOR'S PERFORMANCE AND SHALL NOT BE CONSTRUED AS SUPERVISION OF CONSTRUCTION.
- 15. THE ANTENNA MOUNT SHALL BE FABRICATED BY LARSON CAMOUFLAGE, LLC. OR AN APPROVED FABRICATOR OF CONVENTIONAL STEEL STRUCTURES.

FOUNDATION NOTES:

- THE GEOTECHNICAL ENGINEER (OR THE APPROPRIATE INSPECTOR) SHALL INSPECT THE EXCAVATION PRIOR TO PLACING REINFORCING STEEL OR FORMS THE GEOTECHNICAL ENGINEER (OR INSPECTOR) SHALL PROVIDE A NOTICE OF INSPECTION FOR THE BUILDING INSPECTOR FOR REVIEW AND RECORDS PURPOSE.
- THE CONTRACTOR SHALL DETERMINE THE MEANS AND METHODS TO SUPPORT THE EXCAVATION DURING CONSTRUCTION. REFER TO THE GEOTECHNICAL REPORT FOR RECOMMENDATIONS.
- 3. THE CONTRACTOR SHALL READ THE GEOTECHNICAL REPORT AND SHALL CONSULT THE GEOTECHNICAL ENGINEER AS NECESSARY PRIOR TO CONSTRUCTION.
- 4. FOUNDATION DESIGN PER GEOTECHNICAL REPORT IBC 2012 Per Table 1806.2, Material Class 5 Allowable Soil Bearing Pressure 1500 psf.
- 5. ALL FOUNDATION CONCRETE SHALL HAVE A MINIMUM COMPRESSIVE STRENGTH F'c= 4000 PSI AT 28 DAYS. CONCRETE MIX SHALL BE DESIGNED BY AN APPROVED LABORATORY. CONCRETE SHALL HAVE A MAXIMUM WATER/CEMENT RATIO OF 0.45. ALL CONCRETE CONSTRUCTION SHALL BE IN ACCORDANCE WITH ACI 318. "THE BUILDING CODE REQUIREMENTS FOR REINFORCED CONCRETE", LATEST EDITION. CEMENT SHALL BE TYPE I/II, CONFORMING TO ASTM C-150. ALL AGGREGATE USED IN THE CONCRETE SHALL CONFORM TO ASTM C-33. MAXIMUM AGGREGATE SIZE TO BE 1 1/2". SLUMP 4" - 6".
- CAISSON FOUNDATION INSTALLATION SHALL BE IN ACCORDANCE WITH ACI 336. "STANDARD SPECIFICATIONS FOR THE CONSTRUCTION OF DRILLED PIERS", LATEST EDITION. MAT/PIER FOUNDATION INSTALLATION SHALL BE IN ACCORDANCE WITH ACI 318 LATEST EDITION. CONCRETE CYLINDERS SHALL BE MADE AND TESTED. A MINIMUM OF ONE (1) SET SHALL BE TAKEN FROM CONCRETE IN FOUNDATION. EACH SET SHALL CONSIST OF FOUR (4) CYLINDERS. ONE SHALL BE TESTED AT (7) DAYS, TWO SHALL BE TESTED AT TWENTY EIGHT (28) DAYS AND THE LAST CYLINDER SHALL BE A HOLD. ALL CYLINDERS SHALL BE TAKEN, PREPARED AND TESTED BY A TESTING LAB IN ACCORDANCE WITH ASTM STANDARDS C172, C31 AND C39.
- ALL REINFORCING STEEL SHALL CONFORM TO ASTM A615. VERTICAL BARS SHALL BE GRADE 60, AND TIES OR STIRRUPS SHALL BE A MINIMUM OF GRADE 40. THE PLACEMENT OF ALL REINFORCEMENT SHALL CONFORM TO ACI 315. "MANUAL OF STANDARD PRACTICE FOR DETAILING REINFORCED CONCRETE STRUCTURES", LATEST EDITION, UNLESS OTHERWISE DETAILED ON THIS
- 8. ESTIMATED CONCRETE VOLUME =

PIER: 3.5 CY MAT: 1.0 CY

- 9. THE FOUNDATION HAS BEEN DESIGNED TO RESIST THE FOLLOWING FACTORED LOADS:
- MOMENT = 67.273 FT-KIPS, SHEAR = 3.575 KIPS, AXIAL = 2.298 KIPS
- 10. SPECIAL INSPECTION REQUIRED PER TABLE "SUMMARY OF SPECIAL INSPECTION"

ERECTION NOTES:

- 1. ALL ANTENNA COAXIAL CABLES SHALL BE RUN INSIDE THE MONOPOLE SHAFT.
- 2. THE CONTRACTOR SHALL INSTALL THE ANTENNA AND MOUNT AS REQUIRED BY THE OWNER.

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PF4.2

PF4.3

PF5.0

PF6.0

PF7.0

ALL ANCHOR BOLT NUTS SHALL BE TIGHTENED TO AISC SNUG TIGHT REQUIREMENTS. THE SNUG TIGHT CONDITION IS DEFINED AS THE TIGHTNESS THAT EXISTS WHEN ALL PLIES IN A JOINT ARE IN FIRM CONTACT. THIS MAY BE ATTAINED BY A FEW IMPACTS OF AN IMPACT WRENCH OR THE FULL EFFORT OF A MAN USING AN ORDINARY SPUD

SHEET INDEX

PRODUCT INFORMATION & NOTES

PRODUCT INFORMATION & NOTES

POLE DETAIL & FOUNDATION DETAIL(S

DETAILS

POLE DETAILS

POLE EQUIPMENT BASE DETAILS

POLE EQUIPMENT BASE DETAILS

POLE EQUIPMENT BASE DETAILS

POLE DETAILS AND

ANCHOR BOLT TEMPLATE

CANISTER DETAILS

FRP DETAILS

FRP SIGN DETAILS & METAL TOPPER

- 4. ALL GALVANIZED SURFACES THAT ARE DAMAGED BY ABRASIONS, CUTS, DRILLING OR FIELD WELDING DURING SHIPPING OR ERECTION SHALL BE TOUCHED UP WITH TWO COATS OF A COLD GALVANIZING COMPOUND MEETING THE REQUIREMENTS OF ASTM A780.
- 5. THE ANCHOR BOLT TEMPLATES AND BASE PLATE WILL TYPICALLY HAVE AN AZIMUTH WELDED OR A NOTCH INDICATING THE CORRECT ORIENTATION OF THE ANCHOR BOLTS. THIS IS NECESSARY TO PROPERLY ORIENT THE MONOPOLE EXIT PORTS.
- SLIP JOINT IS A FRICTION CONNECTION THAT WILL TRANSFER DESIGN FORCES WHEN THE SPECIFIED OVERLAP IS ACHIEVED. ASSEMBLY CONTRACTOR SHALL BE EXPERIENCED AND FAMILIAR WITH TAPERED POLE ASSEMBLY. CONTRACTOR SHALL CONSPICUOUSLY MARK THE LOWER POLE SECTION FOR THE MAXIMUM, DESIGN, AND MINIMUM OVERLAP DISTANCES. CONTRACTOR SHALL SLIDE SECTIONS TOGETHER AND APPLY FORCES THROUGH JACKING OR END RAM TO ACHIEVE THE DESIGN OVERLAP.
- 7. ALL SLIP SPLICES SHALL BE JACKED TO WITHIN THE SLIP SPLICE DESIGN CRITERIA AS SHOWN ON THESE DRAWINGS. IF THE DESIGN SPLICE CANNOT BE ATTAINED ISE INC. SHALL BE CONTACTED.
- 8. ALL A36 THREADED ROD AND U-BOLTS SHALL BE TIGHTENED TO AISC SNUG REQUIREMENTS. THE SNUG TIGHT CONDITION IS DEFINED AS THE TIGHTNESS THAT EXIST WHEN ALL PLIES IN A JOINT ARE IN FIRM CONTACT. THIS MAY BE ATTAINED BY A FEW IMPACTS OF AN IMPACT WRENCH OR THE FULL EFFORT OF A MAN USING AN ORDINARY SPUD WRENCH. A36 NUTS AND BOLTS TIGHTENING DO NOT REQUIRE SPECIAL INSPECTION.
- 9. ANTENNA MOUNT SHALL NOT BE USED AS A CLIMBING DEVICE. WORKERS SHALL ALWAYS TIE OFF TO A SPECIFIED CLIMBING POINT.

SUMMARY OF SPECIAL INSPECTIONS

NO.	DESCRIPTION OF TYPE OF INSPECTION REQUIRED, LOCATION, REMARKS, ETC	CONTINUOUS / PERIODIC
1).	FOUNDATION CONSTRUCTION:	
Α.	- GEOTECHNICAL ENGINEER OF RECORD MAY SERVE AS THE SPECIAL INSPECTOR FOR THE FOUNDATION CONSTRUCTION.	
В.	- SHALL VERIFY THE DIAMETER, DEPTH AND QUALITY OF EXCAVATION PRIOR TO THE CONCRETE PLACEMENT.	PERIODIC
C.	- SHALL VERIFY THE ON SITE SOILS ARE AS DETERMINED IN THE SOILS REPORT.	PERIODIC
2).	CAST IN PLACE CONCRETE (FOUNDATION):	
A.	- REINFORCING CAGE SHALL BE INSPECTED TO ENSURE THAT THE PROPER GEOMETRY, SIZE, LENGTH, QUAINTLY AND GRADE MATERIAL ARE USED.	PERIODIC
₿.	- ALL CONCRETE SHALL BE AS SPECIFIED BY ACI-318, LATEST EDITION TO ENSURE THE COMPRESSIVE STRENGTH IS ATTAINED AS DESCRIBED IN THE FOUNDATION NOTES.	
C.	- CONTINUOUS INSPECTION IS REQUIRED DURING THE CONCRETE PLACEMENT.	CONTINUOUS
3).	ANCHOR BOLTS INSTALLED IN CONCRETE:	
	- PLACEMENT SHALL BE ORIENTED ON PROPER BOLT CIRCLE AS SHOWN ON THE STRUCTURAL PLANS, WITH TOP AND BOTTOM TEMPLATES INSTALLED.	PERIODIC
	- SHALL BE PLUMB.	PERIODIC
	- SHALL HAVE A MINIMUM EMBEDMENT OF 6'-0" INTO FOUNDATION (12" MAXIMUM PROJECTION).	PERIODIC
	- SHALL BE TIGHTENED TO SNUG TIGHT CONDITION PER AISC STEEL MANUAL OF STEEL CONSTRUCTION.	PERIODIC

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L'ARSON° CAMOUFLAGE

Tucson, AZ 85713 (520) 294-3900 www.larsoncamo.com

LARSON JOB #: S16091



ISE Incorporated Structural Engineers

P.O. BOX 50039 Phoenix, Arizona 8507 PHONE: 602-403-8614 www.ise-inc.biz

ISE JOB #: 10704

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PROGRESS LOG 10/20/17 Code Update 09/18/17 Client Changes 01.31.17 Client Comments 11.28.26 Client Comments 11.23.26 Added Milbanks Pedestal 6/22/16 | Vent Cover Change **PROGRESS**

SHEET NUMBER

DRAWING DATE

October 20, 2017

FIBERGLASS REINFORCED PLASTIC (FRP) SHAPES:

- 1. ALL FRP SHAPES AND PLATE SHALL CONFORM TO STRONGWELL EXTREN 500/525 SERIES.
- 2. APPLY RESIN ADHESIVE TO ALL FRP MATING SURFACES PRIOR TO BOLTING.
- 3. STRONGWELL FIBREBOLTS AND NUTS OR EQUAL.
- 4. ALL CUT EDGES AND HOLES SHALL BE SEALED WITH A RESIN COMPATIBLE WITH THE RESIN MATRIX USED IN THE STRUCTURAL SHAPE.
- 5. THE FABRICATOR AND CONTRACTOR SHALL EXERCISE PRECAUTIONS NECESSARY TO PROTECT THE FIBERGLASS PULTRUDED STRUCTURAL SHAPES FROM ABUSE TO PREVENT BREAKAGE, NICKS, GOUGES, ETC. DURING FABRICATION, HANDLING, AND INSTALLATION.
- 6. STRUCTURAL SHAPES SHALL BE FABRICATED AND ASSEMBLED AS INDICATED ON THE DESIGN DRAWINGS.
- 7. FIBERBOLTS BOLTS AND NUTS SHALL BE TIGHTENED TO AND LOCKED WITH EPOXY AS FOLLOWS:

½" DIAMETER NUTS 8 FT-LBS TORQUE

5" DIAMETER NUTS 16 FT-LBS TORQUE

3/2" DIAMETER NUTS 24 FT-LBS TORQUE

FIBERGLASS PANEL NOTES:

FABRICATE PANELS TO FIT PER DIMENSIONS SHOWN IN PLAN. PANELS TO BE MINIMUM 1/4" THICKNESS.

- 1. PANELS ARE TO BE FABRICATED IN A CONTIGUOUS LAYUP PER PLANS USING RF TRANSPARENT
- 2. ARCHITECT SHALL SPECIFY ANY REQUIRED FINISHES OR TREATMENTS TO ACHIEVE DESIRED APPEARANCE
- 3. FABRICATOR SHALL USE A GLASS-RESIN RATIO OF 35% ± 3%: REINFORCEMENT BY WEIGHT.
 4. EACH SKIN SHALL BE FABRICATED WITH GENERAL PURPOSE RESIN OR POLYESTER VINYL RESIN WHERE REQUIRED FOR FIRE TREATMENT, CHOPPED STRAND MAT.
- 5 CORNER FLANGES MAY BE FASTENED WITH %"Ø NON-METALLIC THREADED ROD AND NUTS:
 STRONGWELL FIBREBOLT STUDS AND NUTS OR EQUIVALENT. A TORQUE WRENCH MUST BE USED TO
- TIGHTEN FASTENERS TO A MAXIMUM 16 FT-LBS.

 6. FRP PANELS AND SHAPES SHALL BE COATED WITH A FLAT GEL-COAT FINISH TO PROVIDE ULTRAVILOET
- 7. ALL CUT AND DRILLED EDGES SHALL BE COATED WITH RESIN.
- 8. FABRICATOR AND INSTALLER SHALL TEST FIT ALL PANELS PRIOR TO FINAL ASSEMBLY/INSTALLATION TO ASSURE SQUARENESS AND CORNER FITS.

STRUCTURAL STEEL:

- 1. ALL STRUCTURAL STEEL CODE CHECKS BASED ON THE AISC, 14TH EDITION PER THE ASCE 7 STANDARD
- 2. ALL STEEL PIPE TO BE PER API 5LX GR 42.
- 3. ALL STEEL (HSS) TO BE PER ASTM A500 GR. B (46 KSI), U.N.O
- 4. ALL OTHER STRUCTURAL STEEL SHAPES & PLATES SHALL BE PER ASTM A36 (36 KSI), U.N.O.
- 5. ALL BOLTS FOR STEEL-TO-STEEL CONNECTIONS SHALL BE ASTM A325N, U.N.O.
- 6. ALL BOLTED CONNECTIONS SHALL BE TIGHTENED TO "SNUG TIGHT" CONDITION AS DEFINED BY AISC.
- 7. ALL WELDING SHALL BE PERFORMED BY CERTIFIED WELDERS IN ACCORDANCE WITH THE LATEST EDITION OF THE AMERICAN WELDING SOCIETY (AWS) D1.1
- 8. ALL STEEL SURFACES SHALL BE GALVANIZED IN ACCORDANCE WITH THE ASTM A123 AND ASTM A153 STANDARDS, U.N.O.

CONNECTION PROCEDURE NOTES:

ADHESIVE: WELD-ON 45 OR 3M 540

PER MANUFACTURES SPECIFICATIONS & RECOMMENDATIONS

STRONGWELL

CONNECTIONS

PROCEDURE FOR MAKING STRUCTURAL EPOXY JOINTS

Materials Used

Strongwell epoxy adhesive base
Strongwell epoxy adhesive hardener
Small wax coated paper cup for mixing
Clean wooden or FRP stick for mixing
120 grit sandpaper
Clamps for holding epoxy joints during cure
Clean cloth

Surface Preparation

- 1) Sand mating surfaces with 120 grit sandpaper until the surface gloss has been removed. The surfacing veil must be ground off to expose the glass reinforcement. Sand blasting equipment can also be used.
- 2) Remove all dust with a clean cloth; air blasting equipment may also be used. Avoid recontamination of the surface from handling.

Mixing of Epoxy

Mix equal volume portions of the base and hardener in a small wax coated paper cup with a clean stick until a uniform gray color is attained and all marbled appearance is gone.

NOTE: Other adhesive systems compatible with fiberglass can be utilized and the manufacturer's mixing instructions for these systems should be followed.

Application and Cure

- 1) Apply the mixed epoxy uniformly to all surfaces to be joined. A thin application is often more beneficial than a thick application.
- 2) Avoid introducing moisture into the joint.
- 3) Join the surfaces to be bonded. The pot life at 77°F for a 3 oz. mixture of equal volumes of base and hardener is 2.5 hours.
- 4) Secure the joint with clamps (or rivets or bolts) and allow 24 hours for a full cure. The assembly can often be handled with reasonable care in less than 8 hours. The structure should not be required to support its design load until at least 48 hours (at 70°F) after bonding. Lower temperatures require a longer cure.
- 5) After securing the joint, wipe away excess epoxy.

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LARSON° CAMOUFLAGE

1501 South Euclid Avenue Tucson, AZ 85713 (520) 294~3900 www.larsoncamo.com

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P.O. BOX 50039 Phoenix, Arizona 85076 PHONE: 602-403-8614 www.ise-inc.biz

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PHO_ZUZU-VALLEYHO_2_SC (SMALL CELL) PRODUCT INFORMATION & NOTES

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DRAWING DATE
October 20, 2017

