

Pre-Applications

Pre-Application Narrative

Pre-Application Cash Transmittal



ARTESIA MIXED-USE RESIDENTIAL

PLANNING AREA PA-1 & PA-3 MAIN ENTRY DRIVE

ARTESIA DEVELOPMENT PARTNERS LLC

SCOTTSDALE, ARIZONA

CONSULTANTS:

ARTESIA DEVELOPMENT PARTNERS LLC 8800E. RAINTREE DRIVE, STE. 300 SCOTTSDALE, AZ 85260 FRED HERMANN 480.515.8105 TROY HILL 480.515.8164 ANGELA WILLARD 480.515.8191

ARCHITECT/PLANNER BUCILLA GROUP ARCHITECTURE, INC. 19782 MACARTHUR BLVD, STE 270, IRVINE, CA. 92612
GREG BUCILLA 949.851.9080
ROWENA BRUAL 949.851.9080 CIVIL ENGINEER KIMLEY HORN 7740 N. 16TH STREET, STE. 300 PHOENIX, AZ 85020 MIKE DELMARTER 602.906.1374 TOBIN KOPP

<u>SURVEY</u> **HUBBARD ENGINEERING** 1201 S. ALMA SCHOOL RD, STE 12000 MESA, AZ 85210 ADRIAN BURCHAM 480.398.3810

SOIL ENGINEER **PROTEX** 85282-4558 602.272.7891 CINDY LANGDELL

STRUCTURAL & SHORING ENGINEER PK ASSOCIATES 7434 E. MCDONALD DRIVE SCOTTSDALE, AZ 85250 STEVE SLONAKER 480.922.4854 VI DUONG 480.922.4854

MEP ENGINEER NP ENGINEERING / ELECTRICAL 4115 N. 15TH AVENUE

PHOENIX, AZ 85015 RICHARD PANOPIO NANTE GANA 602.265.1559-212 MEP ENGINEER NP MECHANICAL - MECH'L/ PLUMBING 1717 W. NORTHERN AVENUE, STE. 116 PHOENIX, AZ 85021 SERVANDO PEREZ 602.249.6311–22 GUS KOUTIA 602.249.6311–18

480.557.6670

LANDSCAPE ARCHITECT OTAK 51 W. THIRD STREET, STE. 201 TEMPER, AZ 85281 MARK SWARTZ

CHAD HAYASHI

COLOR & MATERIAL SUMMARY

| | ARCHITECTURAL STYLE 2/26/2018 | SOUTHWEST CONTEMPORARY |
|-----|---|--|
| 1 | Building - Wall Building - Wall Niche | 16/20 & Smooth Stucoo (specific locations) SW - Shoji White 7042 16 / 20 Stucco Finish SW - Beach House 7518 (Beige) |
| 2 | Parapet Fascia - Residential Veranda Parapet Fascia - Community Facility | 10"x10" - Foam Profile SW - Shoji White 7042 18"x18" - Foam Profile SW - Shoji White 7042 |
| 3 | Dbl Corbels with trim board behind Rafter Tail with trim board behind | 10"w x 9"d - Foam Profile SW - French Roast 6069 6"w x 6"d - Foam Profile SW - French Roast 6069 |
| 4 | Stone - Building Wall Stone - Building Wall | Coquina Limestone - sand finish Goleta Limestone - sand finish 12"x24" veneer with 2" stone cap 12"x24" veneer with 2" stone cap |
| 5 | Stone - Garden Walls with stone cap Stone - Porte Cochere with stone cap | Coquina Limestone - sand finsh Goleta Limestone - sand finish 12"x24" veneer with 2" stone cap 12"x24" veneer with 2" stone cap |
| 6 | Window / Door - Residential Window / Door - Community Facility | Metal Frame - Bronze Metal Frame - Bronze |
| 7 | Glazing - Door and Window | Solarban - Low E LSG / low solar gain with EWC criteria Residential - U Factor 0.42 / SHGC 0.23 sliding door Community Facility - U Factor 0.42 / SHGC 0.23 sliding door |
| 8 | Railing - Glazing and Mesh Panels Veranda - Deck Edge | 1. Glazing / Mesh Panels 48" - 60" Module SW - French Roast 6069 2. Metal Panels 48" - 60" Module SW - French Roast 6069 |
| 9 | Porte Cochere Accent Grille | Steel column & surrounding frame SW - French Roast 6069 Metal frame panel SW - French Roast 6069 |
| 10 | Building Lighting | 1. Entry / Exits / Verandas LED Pancake Box lighting 2. Bldg Tower Elements LED strip lighting 3. Porte Cochere / Pool OS Areas LED strip lighting |
| 11) | Roof - Flat | Raised Paver Rooftop Tile Tech Pavers - Coral Design GAF - Cool Roof |
| 12) | Roof - Flat Tile | Boral - Saxony 900 Slate / Stone Mountain Dark |

BUILDING FINISHES Mesh Panel Raling & Deck Edge Corbel Beam & Rafter Tails Mesh Accent Panels



SHEET INDEX

SP-10.0

MAIN ENTRY CONCEPTUAL IMAVERY (VIEW 1)

SP-10.3A MAIN ENTRY CONCEPTUAL IMAVERY (VIEW 1A)

SP-10.4 MAIN ENTRY CONCEPTUAL IMAVERY (VIEW 2)

SP-10.5 MAIN ENTRY CONCEPTUAL IMAVERY (VIEW 3)

SP-10.8.1 GATE 1 CONCEPTUAL IMAGERY (VIEW 4)

SP-10.9.1 GATE 2 CONCEPTUAL IMAGERY (VIEW 5)

ENTRY MONUMENTATION &

PROJECT SCULPTURE PLAN & ELEVATION

DRIVE AISLE/MEDIAN SHADE DEVICE

SP-10.8 GATE 1 ENLARGED PLAN

SP-10.9 GATE 2 ENLARGED PLAN

ARCHITECT: MAIN ENTRY DRIVE CS-1.0 COVER SHEET SP-1.0 MASTER PLAN/CONTEXT AERIAL (PA-1 & PA-3) SP-1.0A MASTER PLAN/ AERIAL OVERVIEW MAIN ENTRY DRIVE PLAN MAIN ENTRY EXISTING IMAGES SP-10.2 MAIN ENTRY EXISTING IMAGES

Architecture Planning Interior design HISTORIC PRESERVATION LEED VALUE ENGINEERING 19782 Mac Arthur Blvd., Suite 270, Irvine, Ca 92612

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Project:

ARTESIA 7171 N. SCOTTSDALE ROAD SCOTTSDALE, ARIZONA

ARTESIA DEVELOPMENT PARTNERS, LLC SCOTTSDALE, ÁRIZONA

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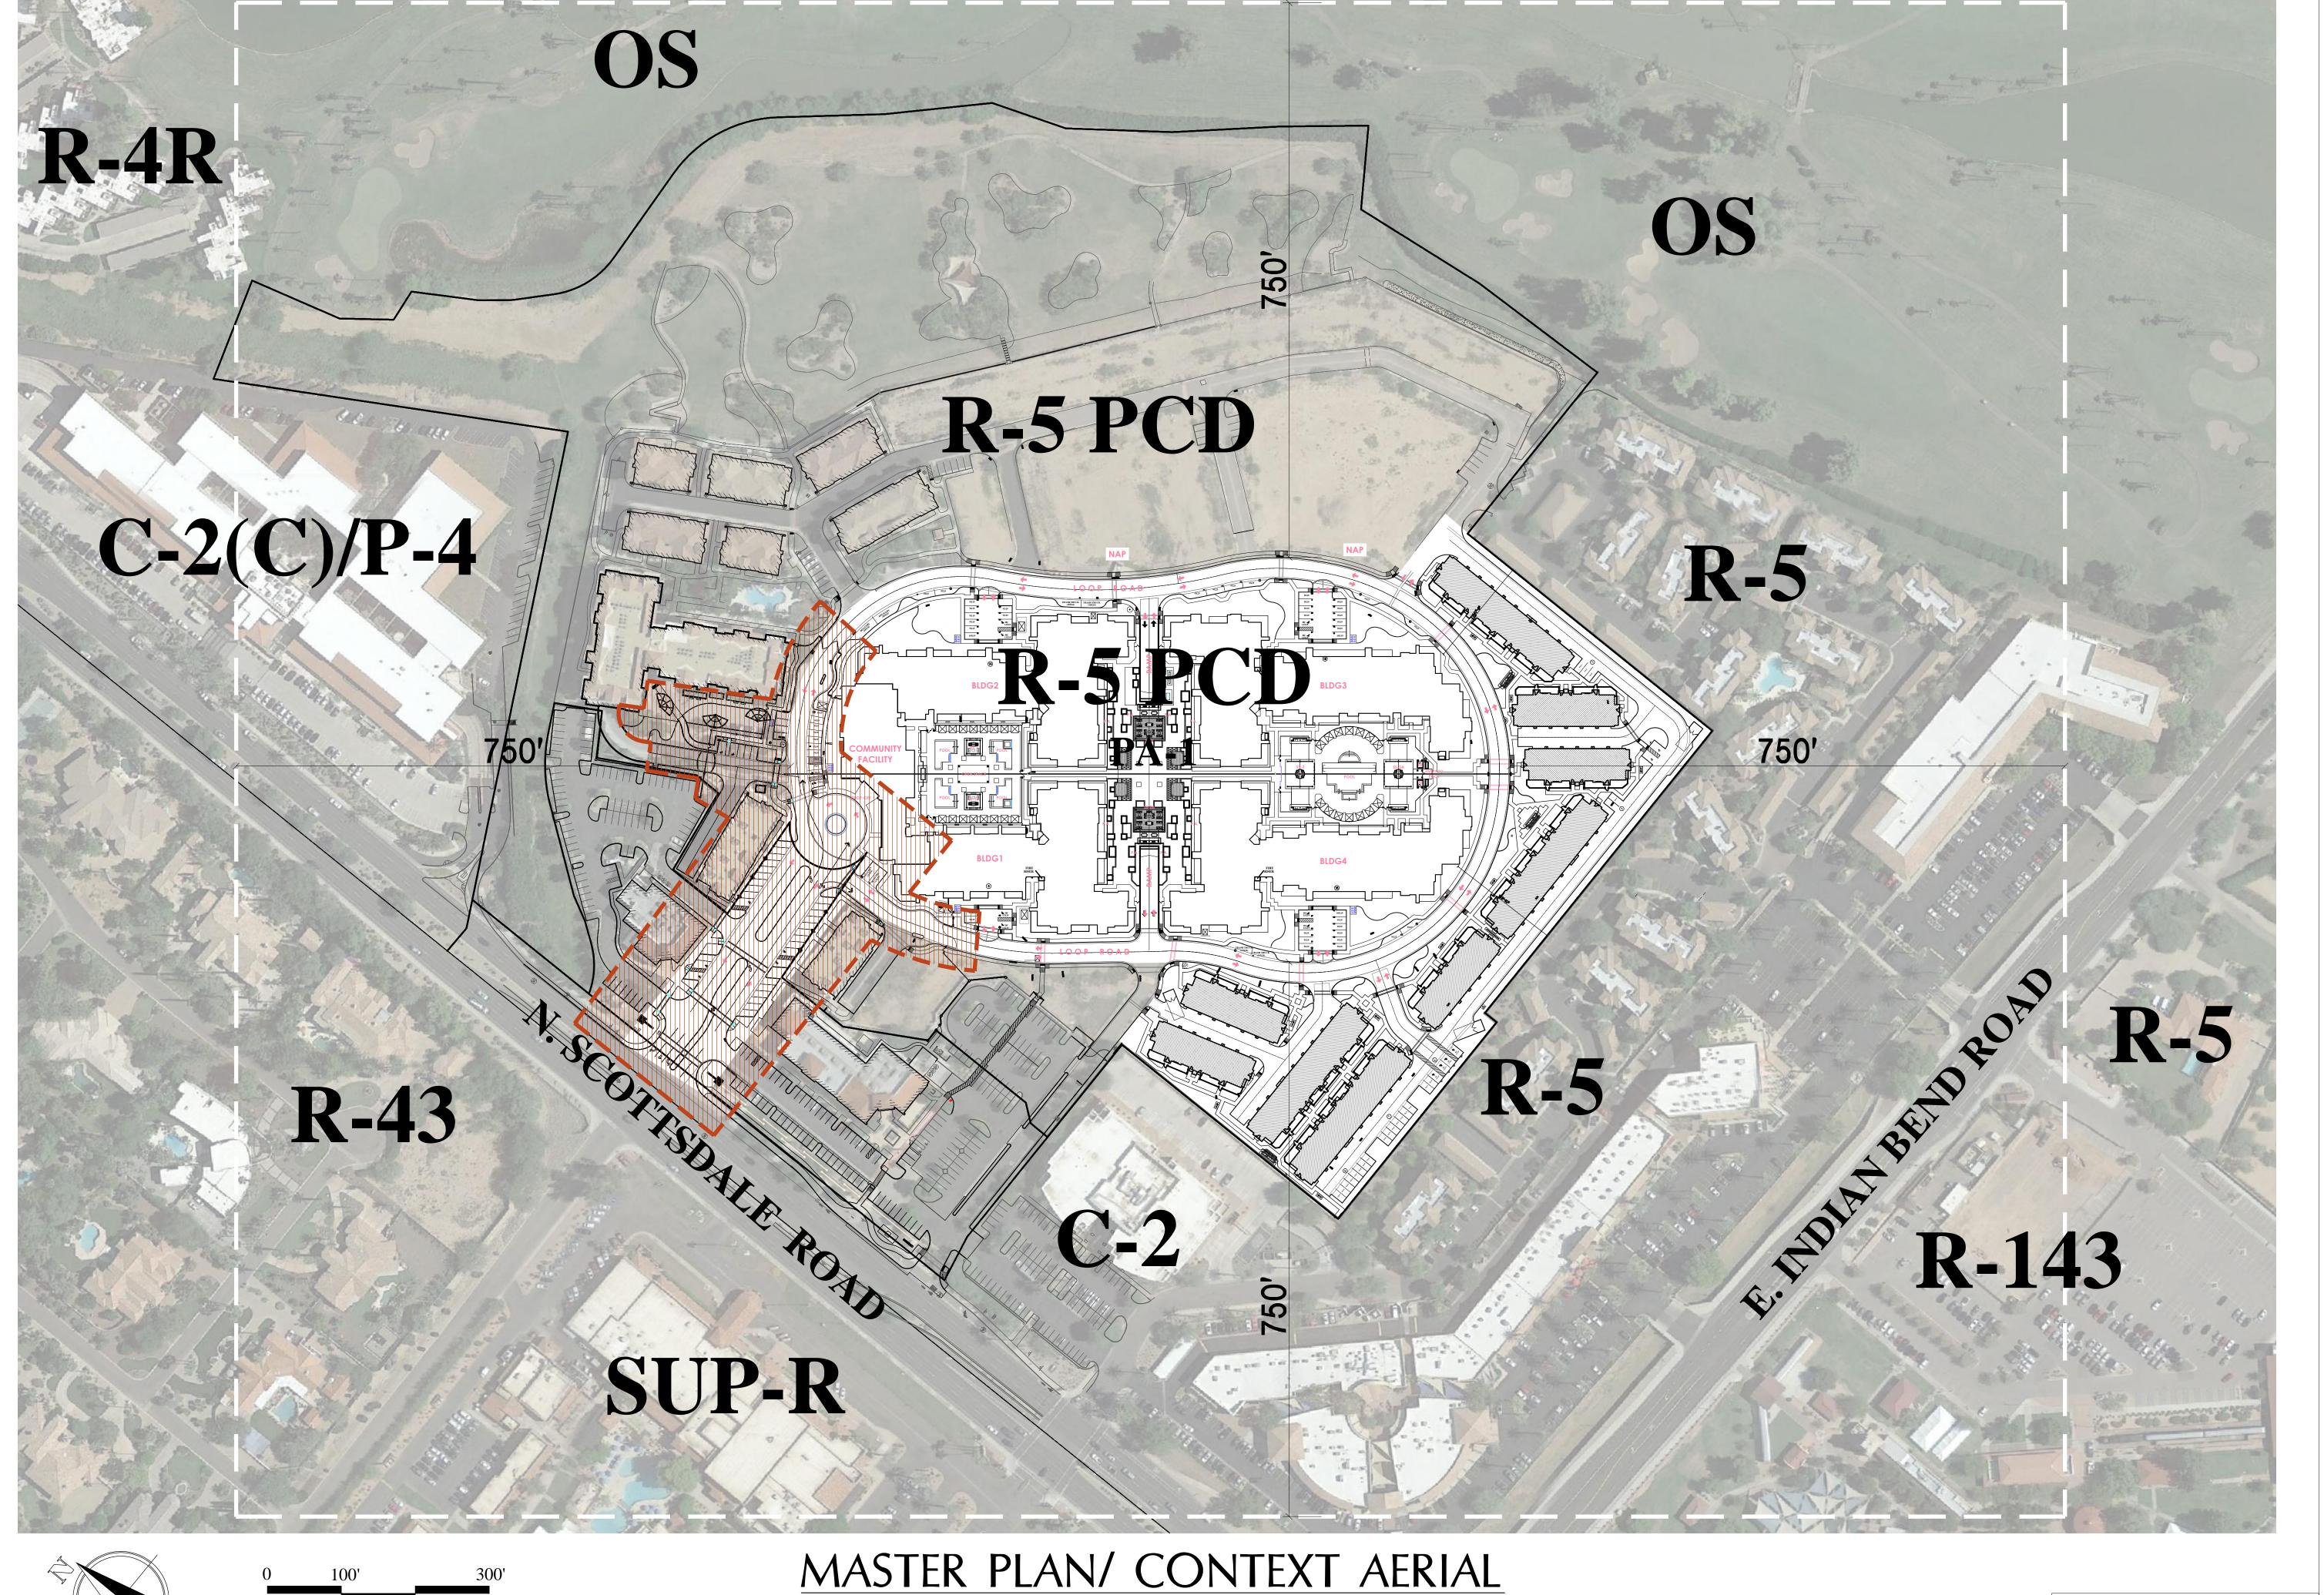
MAIN ENTRY DRIVE **ENTRY DRIVE**

Sheet No.:

CS-1.0

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SCALE: 1'' = 100'-0''



PA-1 & PA-3

ARCHITECT:



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Sheet Title

MASTER PLAN
CONTEXT AERIAL
PA-1 & PA-3

Sheet No

PROJECT ADDRESS:

7171 N. SCOTTSDALE ROAD

SCOTTSDALE, ARIZONA

SP-1.0

2018, BUCILLA GROUP ARCHITECTURE IN



PA-1 & PA-3
AERIAL OVERVIEW

PROJECT ADDRESS:
7171 N. SCOTTSDALE ROAD
SCOTTSDALE, ARIZONA

ARCHITECT:



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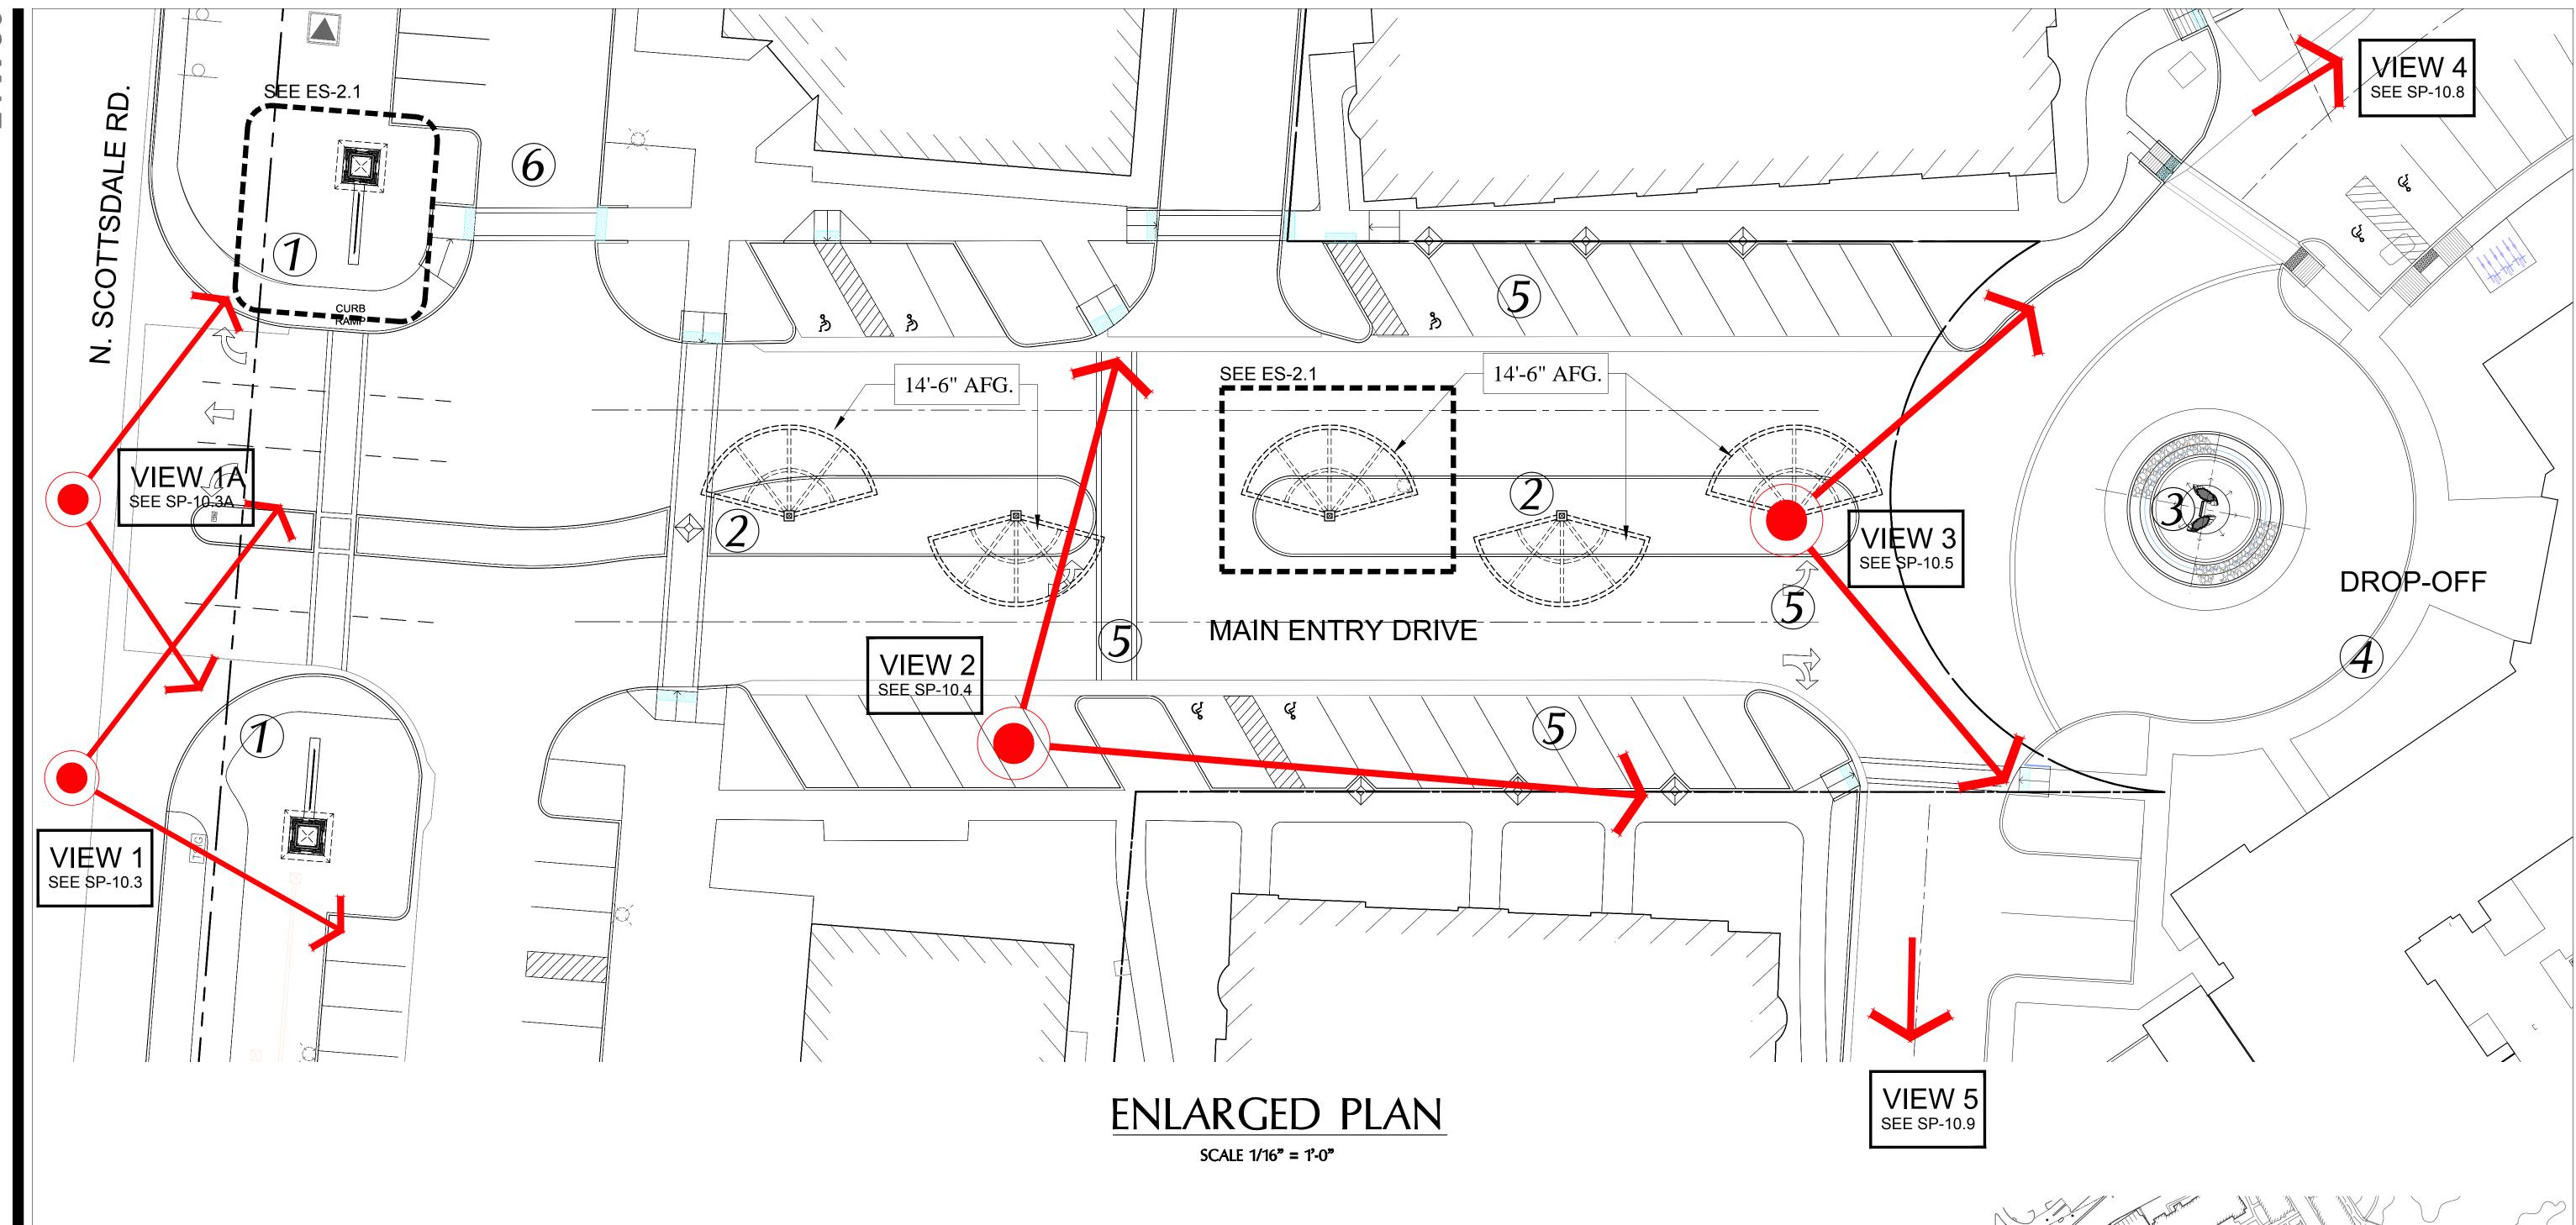
Sheet Title:

PA-1 & PA-3 AERIAL OVERVIEW

Sheet No

SP-1.0A

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1 Project Entry

Project Signage / Monumentation each side of drive

Materials

Patina metal frame with stone below and simulated Banner of metal wire mesh with Artesia Signage.

(2) Center island median

Enhanced with cadence of Retail / Project

Signage / Monumentation

Materials

Use patina metal frames (14'-6" AFG) with

stone below and Artesia Banner above.

(3) Water Feature

Re-purpose / re-locate Artesia Water sculpture with 'ring of rainwater' dropping onto curved stone below.

Materials

Use existing sculpture routed with water supply and circular bronze 6" frame tubing for rainwater drip.

4) Porte Cochere

Metal porte cochere with muliple bays at 14'-6" high at Center panel / glazed panel at 16'-0" high above entry drop off

Materials

Use bldg stone veneer of 24" sq columns wrapping patina steel posts & cantilevered

patina steel frame.

(5) Median, Parking and Striping

Adjust median, parking spaces, crosswalks and traffic pattern

as indicated.


<u>Update</u>


Review retail cross walk locations to be at center of retail activity, and at end of retail drive moving toward Community Facility.

6 Parking Area

Adjust parking and drive aisle area at Northwest retail near North Scottsdale Road

MAIN ENTRY DRIVE

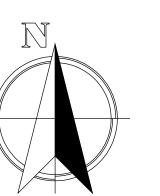

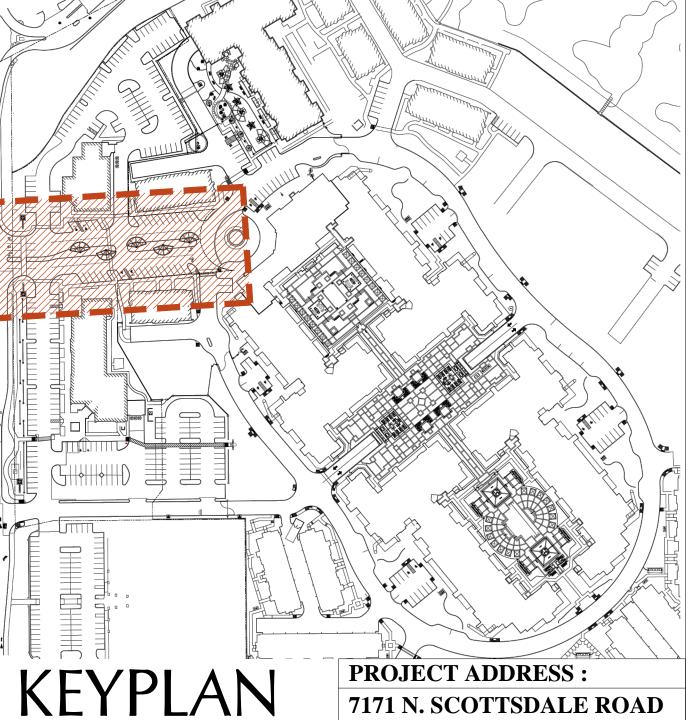

SCOTTSDALE, ARIZONA

ARCHITECT:

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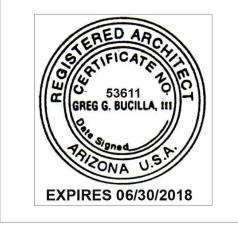
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ARTESIA
7171 N. SCOTTSDALE ROAD
SCOTTSDALE, ARIZONA

ner:

ARTESIA DEVELOPMENT PARTNERS, LLC SCOTTSDALE, ARIZONA

NO. DATE DESCRIPTION

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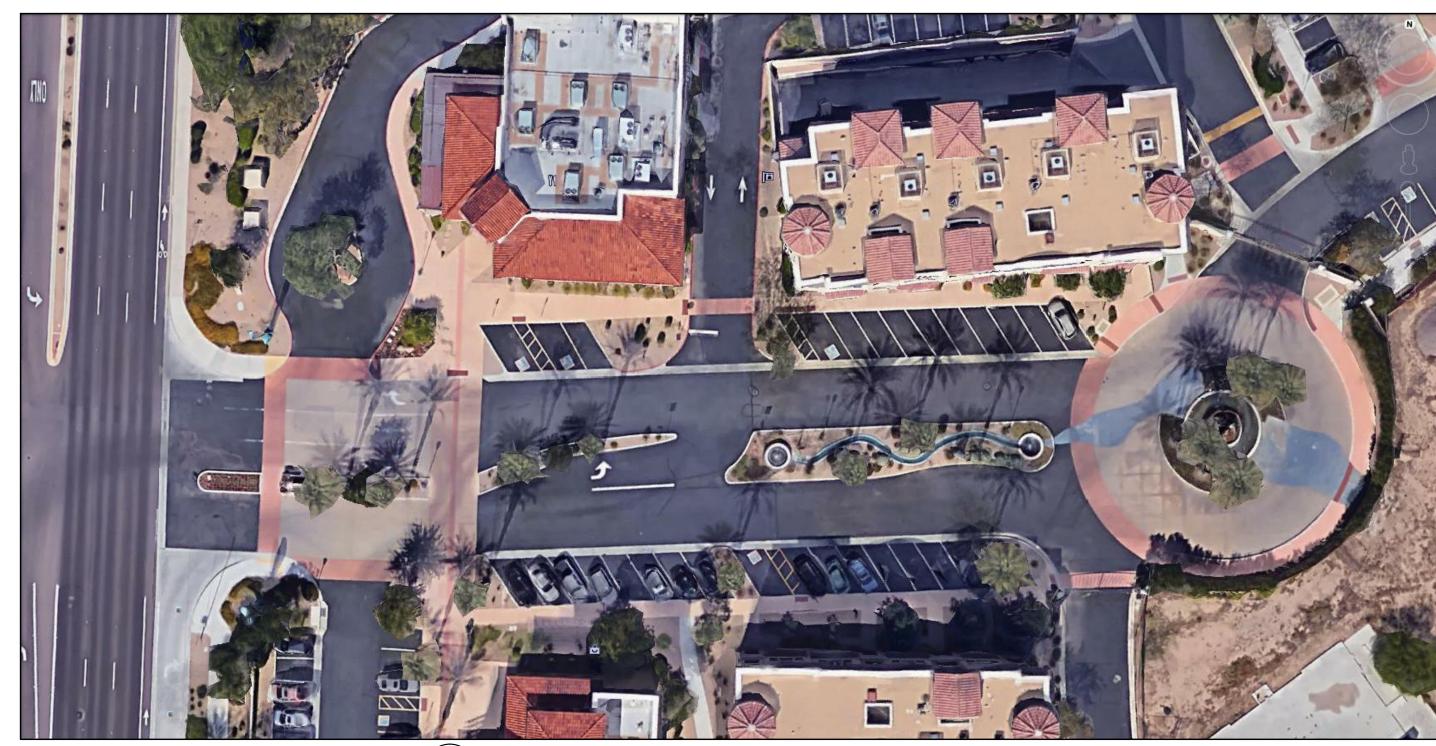
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MAIN ENTRY DR. ENLARGED PLAN

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EXISTING PLAN VIEW




EXISTING EAST BIRD'S EYE VIEW (ROUNDABOUT)





EXISTING NORTH BIRD'S EYE VIEW (ROUNDABOUT)

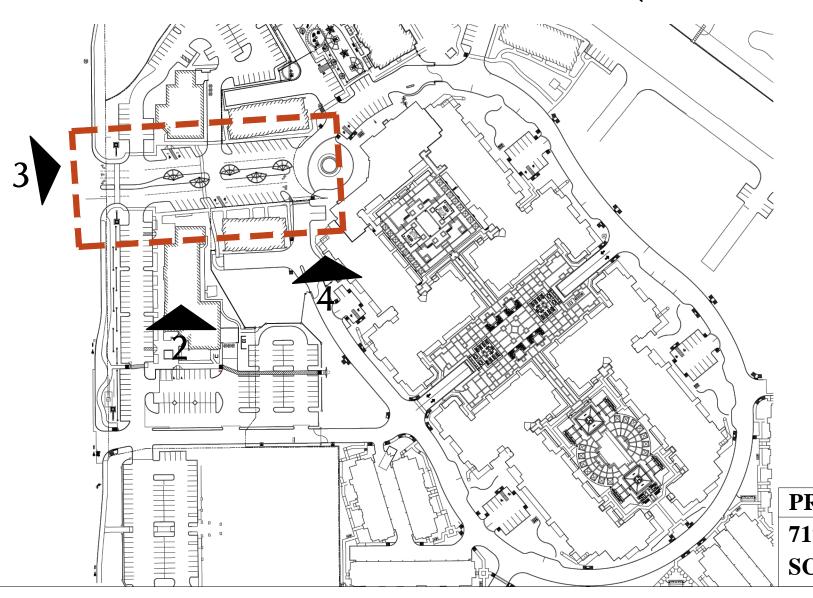

MAIN ENTRY DRIVE

PROJECT ADDRESS: 7171 N. SCOTTSDALE ROAD SCOTTSDALE, ARIZONA

SP-10.1

BD SUBM. DATE:

PLOT DATE:

BGA No. 15029

MAIN ENTRY DR. EXISTING IMAGES

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7171 N. SCOTTSDALE ROAD SCOTTSDALE, ARIZONA

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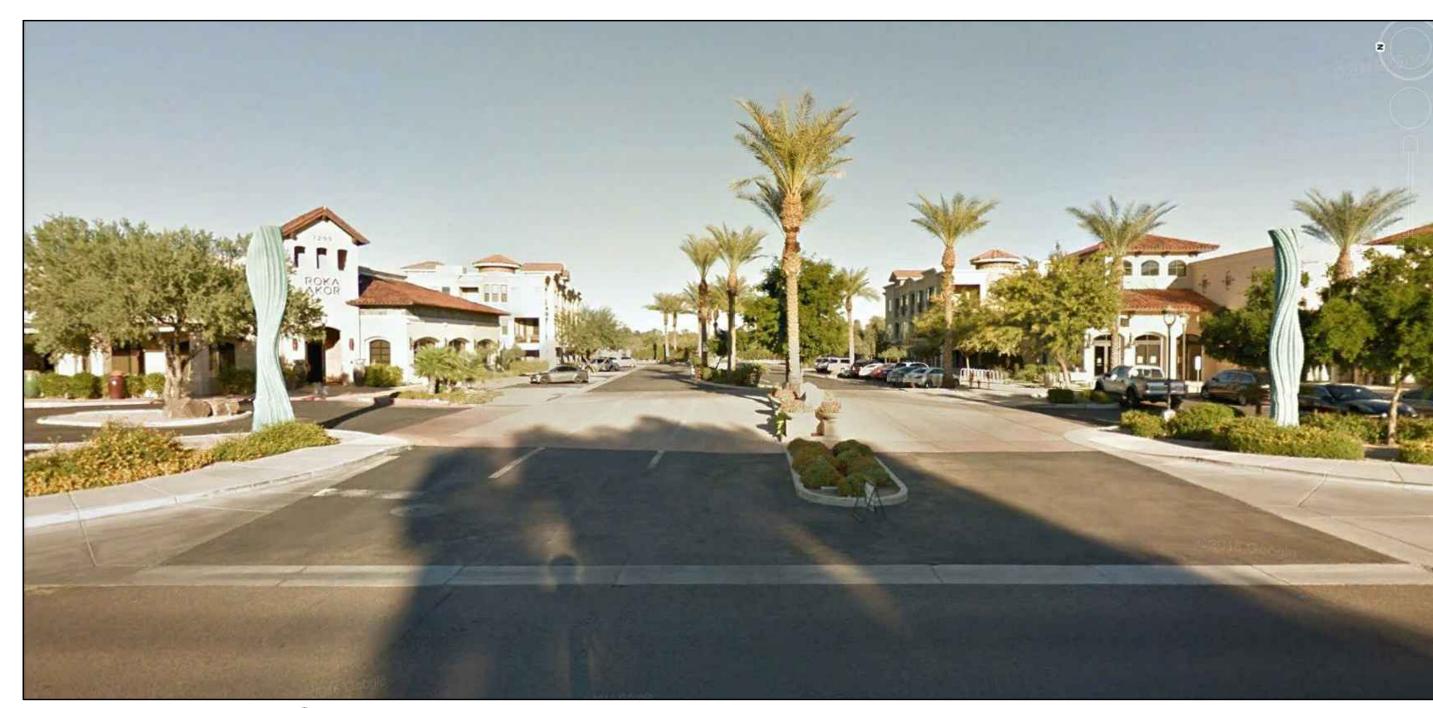
EXISTING NORTH BIRD'S EYE VIEW




EXISTING EAST BIRD'S EYE VIEW (ENTRY)




6 EXISTING NORTHEAST STREET VIEW (ENTRY)



EXISTING EAST STREET VIEW (ENTRY)

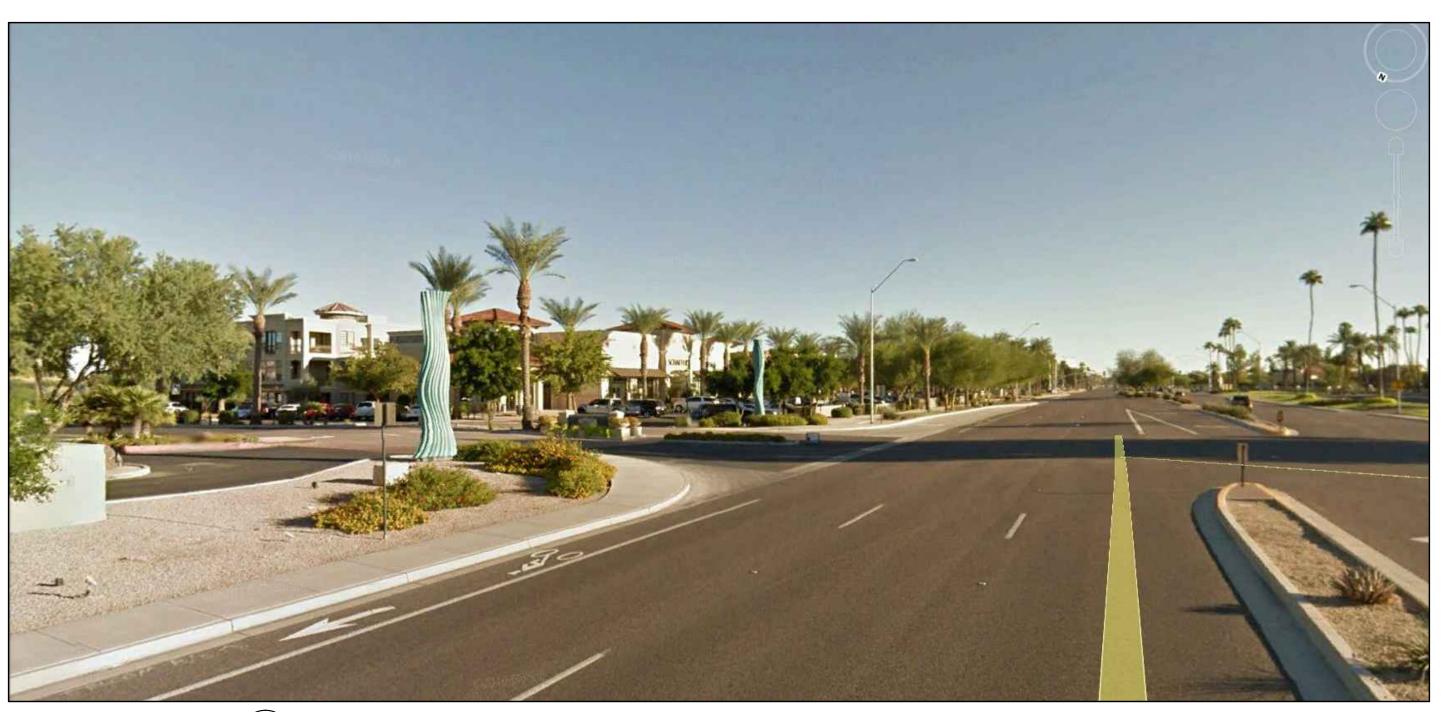

EXISTING SOUTHEAST STREET VIEW (ENTRY)

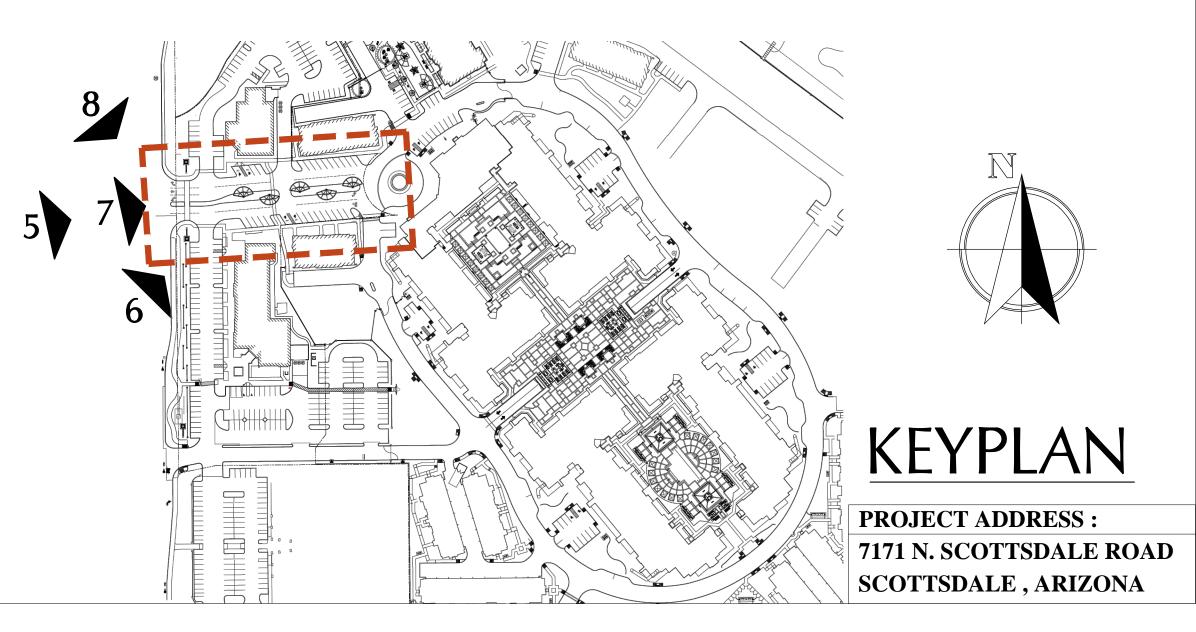

ARCHITECT:



Architecture Planning Interior design Historic preservation Leed Value engineering

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Project

ARTESIA
7171 N. SCOTTSDALE ROAD
SCOTTSDALE, ARIZONA

ARTESIA DEVELOPMENT PARTNERS, LLC SCOTTSDALE, ARIZONA

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MAIN ENTRY DR. EXISTING IMAGES

Sheet No.:

SP-10.2

MAIN ENTRY DRIVE



VIEW 1A
FROM NORTH SCOTTSDALE ROAD

MAIN ENTRY DRIVE

PROJECT ADDRESS:
7171 N. SCOTTSDALE ROAD
SCOTTSDALE, ARIZONA

ARCHITECT:



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Historic preservation Leed Value engineering

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Sheet Title :

MAIN ENTRY DR. CONCEPTUAL IMAGERY VIEW 1

Sheet No

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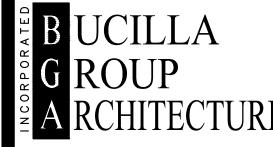


VIEW 1 FROM NORTH SCOTTSDALE ROAD

MAIN ENTRY DRIVE

PROJECT ADDRESS: 7171 N. SCOTTSDALE ROAD SCOTTSDALE, ARIZONA

ARCHITECT:



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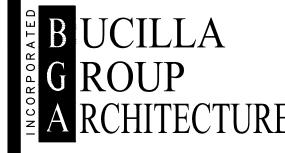
VIEW 2

BETWEEN EXISTING BUILDINGS
W/ REVISED & ENHANCED MEDIAN

MAIN ENTRY DRIVE

PROJECT ADDRESS:
7171 N. SCOTTSDALE ROAD
SCOTTSDALE, ARIZONA

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MAIN ENTRY DR. CONCEPTUAL IMAGERY VIEW 2

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SP-10.4

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VIEW 3
LOOKING TOWARD ENTRY
INTO COMMUNITY FACILITY

MAIN ENTRY DRIVE

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MAIN ENTRY DR. CONCEPTUAL IMAGES VIEW 3

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BGA No. 15029

MAIN ENTRY DR GATE 1 ENLARGED PLAN

SCOTTSDALE, ARIZONA

SP-10.8




VIEW 4
ENTRY GATE 1 AT LOOP ROAD

MAIN ENTRY DRIVE

PROJECT ADDRESS:
7171 N. SCOTTSDALE ROAD
SCOTTSDALE, ARIZONA

ARCHITE

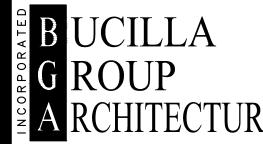

ARCHITECTURE PLANNING INTERIOR DESIGN
HISTORIC PRESERVATION LEED VALUE ENGINEERING

19782 Mac Arthur Blvd., Suite 270, Irvine, Ca 92612
TEL 949. 851. 9080 FAX 949.623.0084

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STAMP



ATTEST TO ARCHITECTURAL ONLY

Project:

ARTESIA
7171 N. SCOTTSDALE ROAD
SCOTTSDALE, ARIZONA

Owner:

ARTESIA DEVELOPMENT PARTNERS, LLC SCOTTSDALE, ARIZONA

| NO. | DATE | DESCRIPTION | |
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Project Numbe

BGA No. 15029

Sheet Title :

MAIN ENTRY DR GATE 1 CONCEPTUAL IMAGES

Sheet No

SP-10-8.1

© 2018, BUCILLA GROUP ARCHITECTURE INC

ARCHITECT:



Architecture Planning Interior design Historic preservation Leed Value engineering 19782 Mac Arthur Blvd., Suite 270, Irvine, Ca 92612 TEL 949. 851. 9080 FAX 949.623.0084 BUCILLA GROUP ARCHITECTURE, INC. hereby expressly reserves its common law copywright and other property rights in these plans. These plans are not to be copied, reproduced or changed in any form or manner whatsoever, nor are they to be assigned to any third party without first obtaining the express written permission and consent of BUCILLA GROUP ARCHITECTURE, INC.

STAMP



ATTEST TO ARCHITECTURAL ONLY

Project:

ARTESIA 7171 N. SCOTTSDALE ROAD SCOTTSDALE, ARIZONA

ARTESIA DEVELOPMENT PARTNERS, LLC SCOTTSDALE, ARIZONA

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BGA No. 15029

MAIN ENTRY DR GATE 2 ENLARGED PLAN

SP-10.9



VIEW 5
ENTRY GATE 2 AT LOOP ROAD

MAIN ENTRY DRIVE

PROJECT ADDRESS:
7171 N. SCOTTSDALE ROAD
SCOTTSDALE, ARIZONA

ARCHITECT:

BUCILLA

B UCILLA ROUP A RCHITECTUR

ARCHITECTURE PLANNING INTERIOR DESIGN
HISTORIC PRESERVATION LEED VALUE ENGINEERING

19782 Mac Arthur Blvd., Suite 270, Irvine, Ca 92612
TEL 949. 851. 9080 FAX 949.623.0084

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STAMP



ATTEST TO ARCHITECTURAL ONLY

Project :

ARTESIA
7171 N. SCOTTSDALE ROAD
SCOTTSDALE, ARIZONA

wner:

ARTESIA DEVELOPMENT PARTNERS, LLC SCOTTSDALE, ARIZONA

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Project Number

BGA No. 15029

Sheet Title


MAIN ENTRY DR GATE 2 CONCEPTUAL IMAGES

Sheet No

SP-10.9.1

© 2018, BUCILLA GROUP ARCHITECTURE INC.




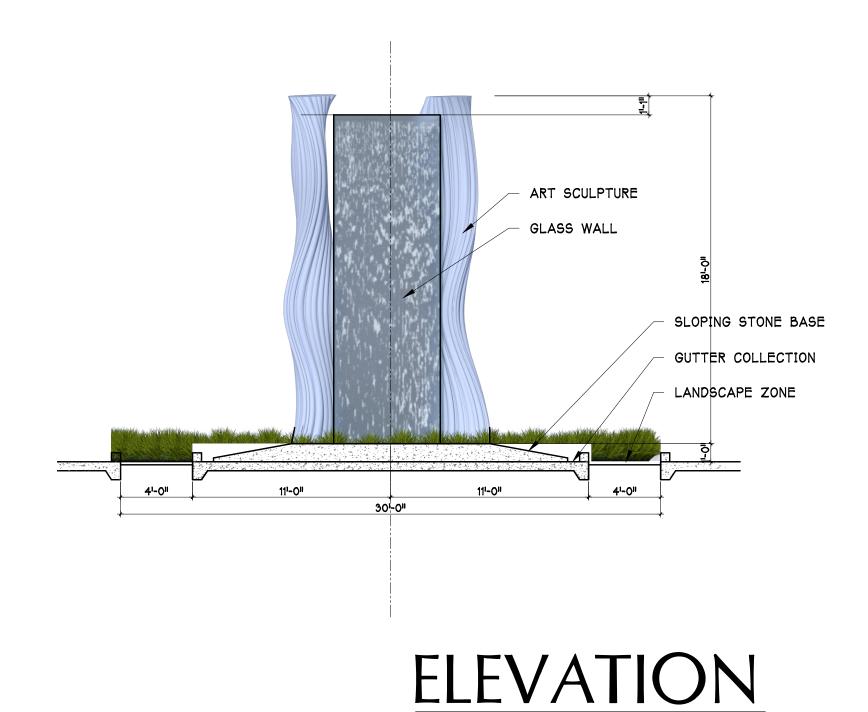


METAL SUPPORT ART SCULPTURE FROSTED GLASS EDGE FROSTED GLASS WALL 2" X 3" METAL FRAME WATER PUMPED FROM SIDE SUPPORT TUBE

31-011



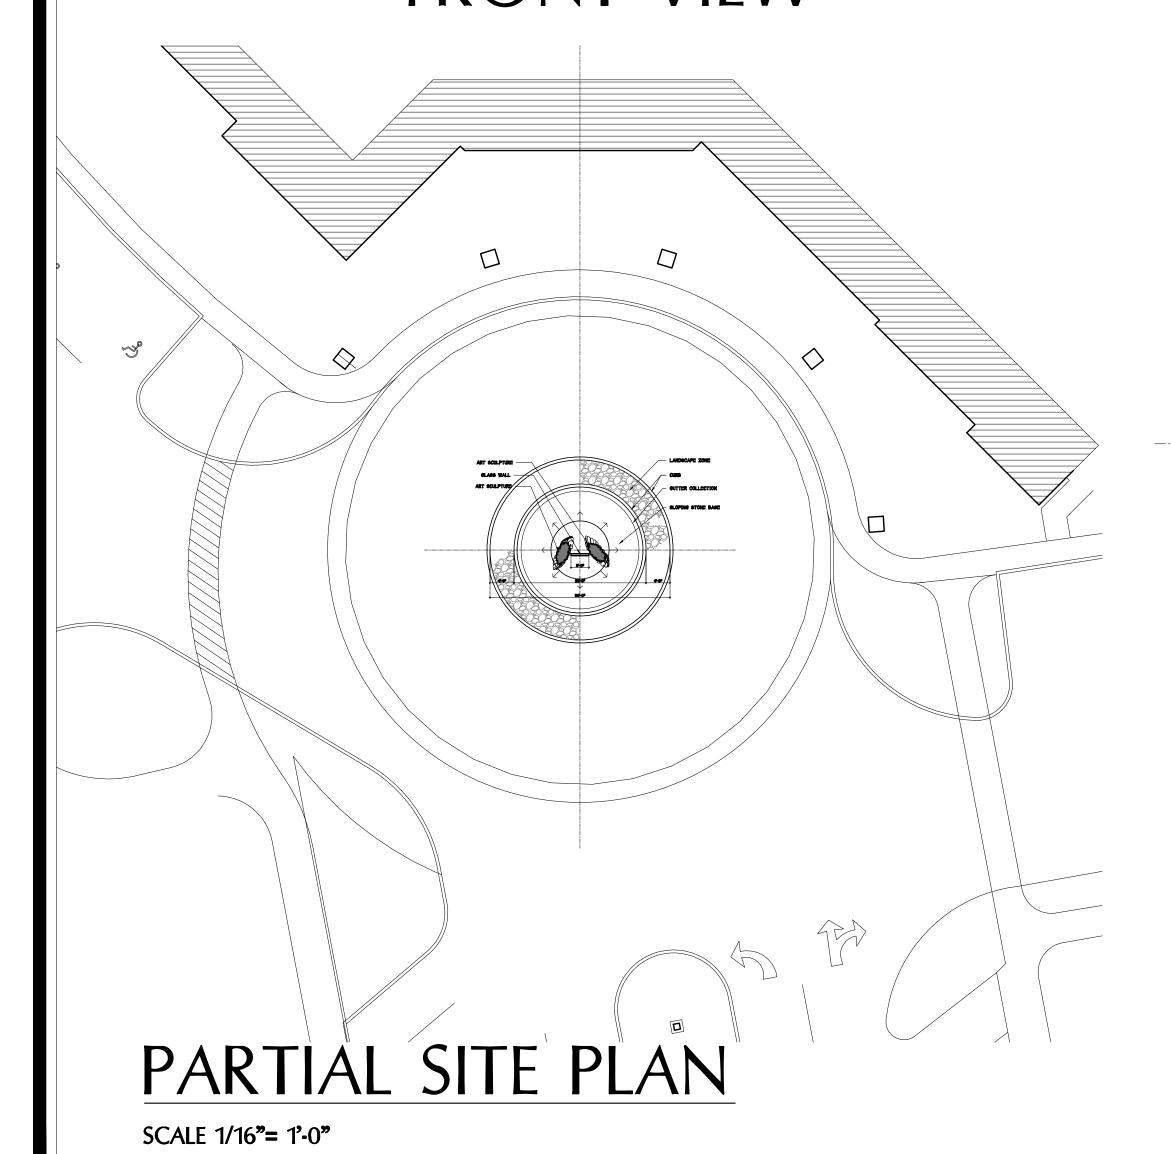

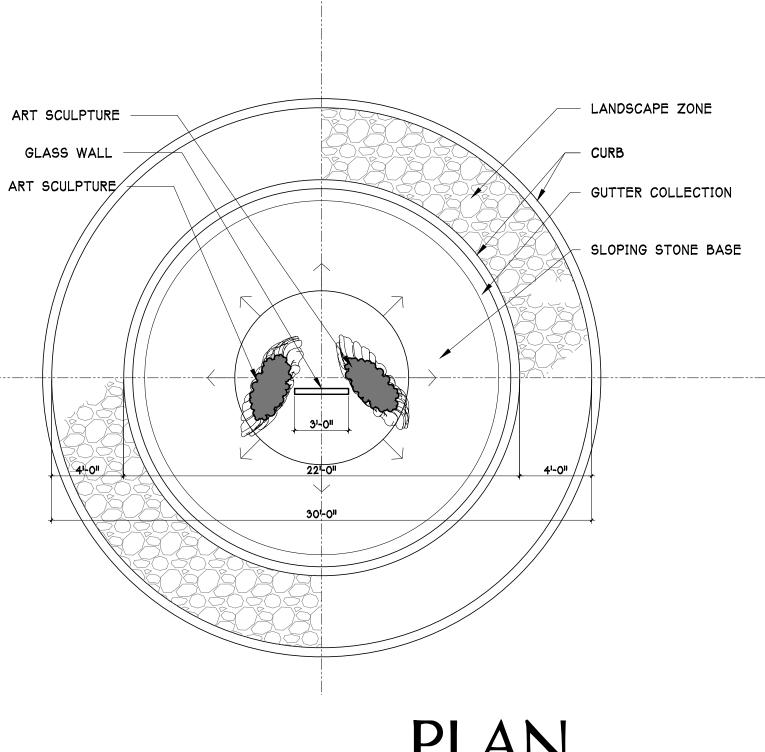

SCALE 3/16"= 1'-0"

PLAN

SCALE 3/16"= 1'-0"

MAIN ENTRY DRIVE
ART SCULPTURE

ARCHITECT:

- WATER THROUGH AT TOP



ARCHITECTURE PLANNING INTERIOR DESIGN
HISTORIC PRESERVATION LEED VALUE ENGINEERING

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STAMP



ATTEST TO ARCHITECTURAL ONLY

Project:

ARTESIA
7171 N. SCOTTSDALE ROAD
SCOTTSDALE, ARIZONA

Owner:

ARTESIA DEVELOPMENT PARTNERS, LLC SCOTTSDALE, ARIZONA

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Project Number :

BGA No. 15029

Sheet Title :

FROSTED GLASS EDGE

FROSTED GLASS WALL ON BOTH SIDES


WATER LINE

SECONDARY ENTRY PLAN

Sheet No.


ES-2.0

© 2018, BUCILLA GROUP ARCHITECTURE INC. DO NOT SCALE THE DRAWINGS

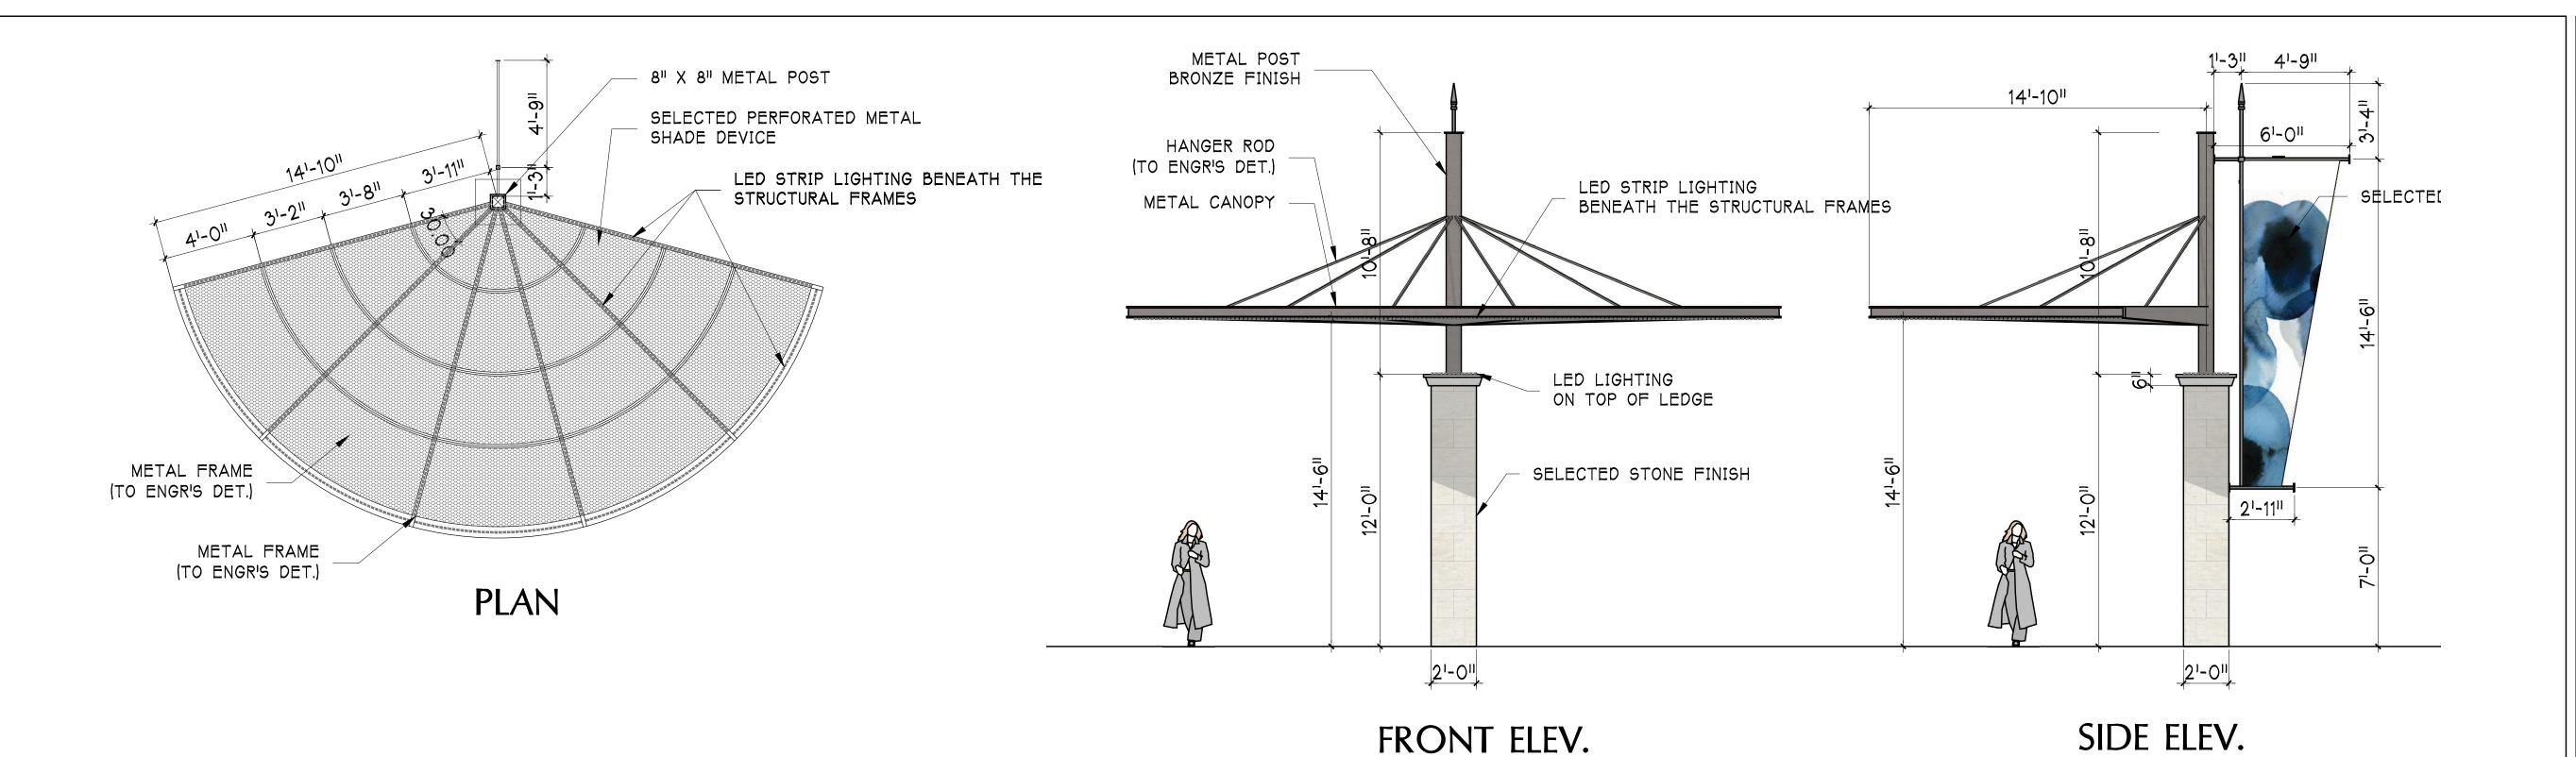

DRIVE AISLE/MEDIAN SHADE DEVICE

SCALE 1/4"= 1'-0"

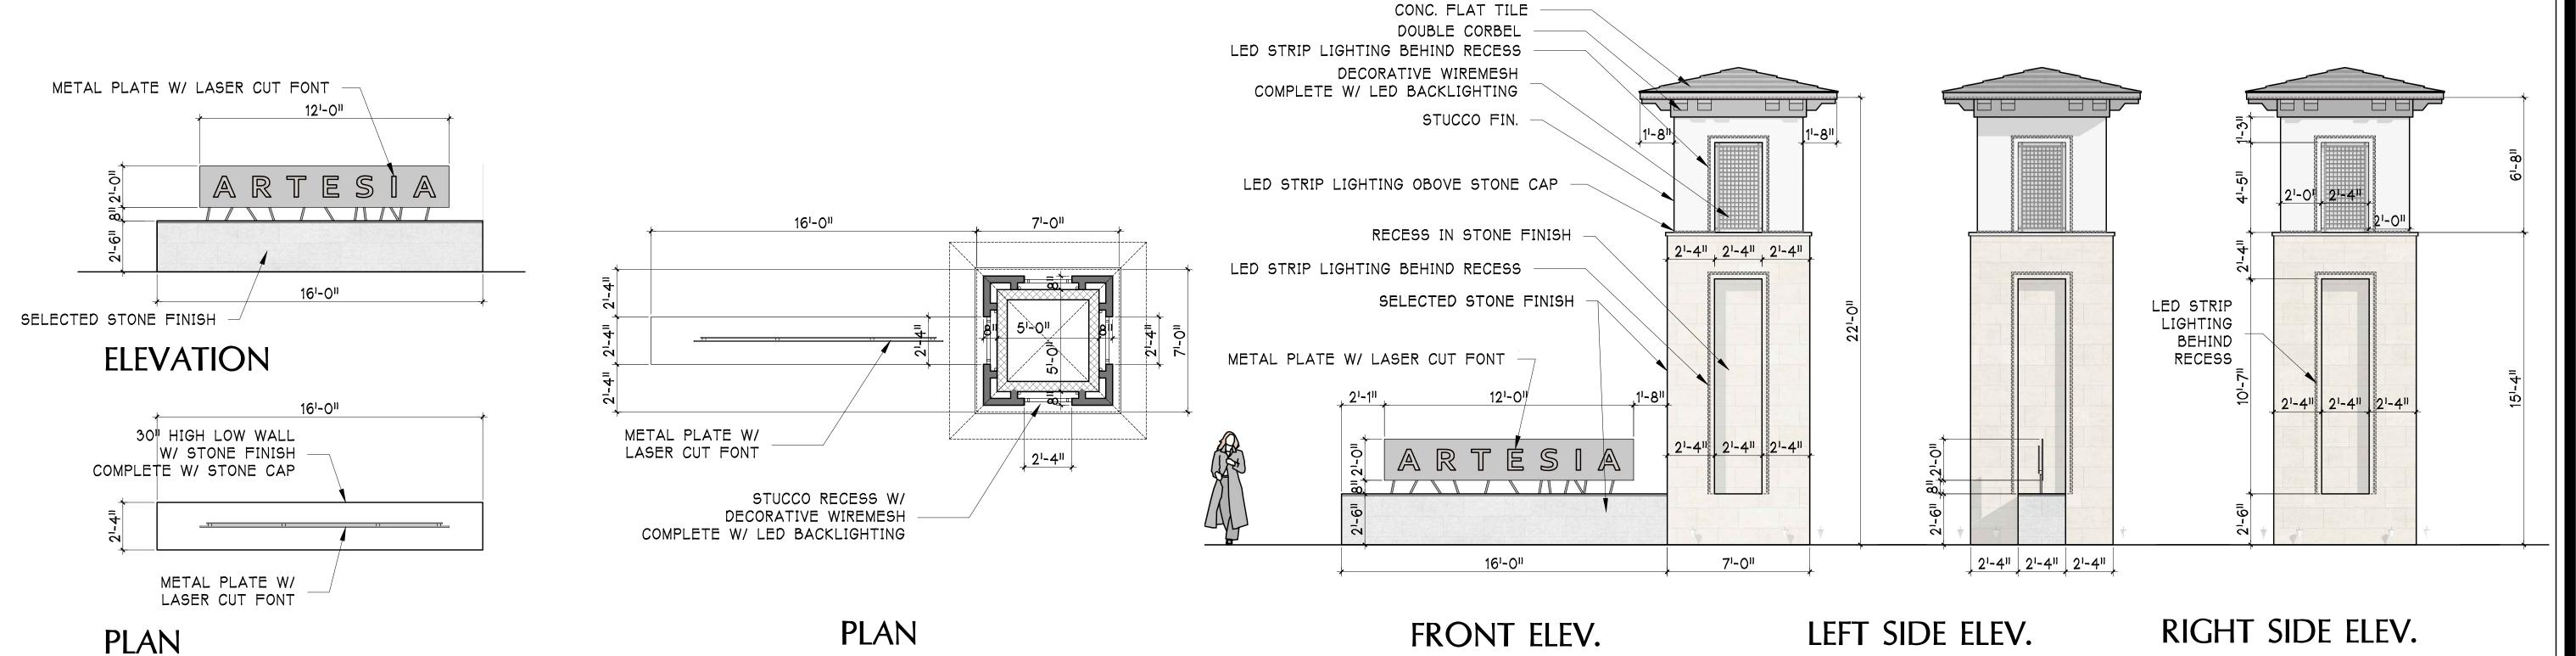

ENTRY SIGNAGE @ SECONDARY ENTRY SCALE 1/4"= 1'-0"

ENTRY MONUMENTATION @ MAIN ENTRY SCALE 1/4"= 1'-0"

MAIN ENTRY DRIVE

ARCHITECT:

ARCHITECTURE PLANNING INTERIOR DESIGN HISTORIC PRESERVATION LEED VALUE ENGINEERING TEL 949. 851. 9080 FAX 949.623.0084 BUCILLA GROUP ARCHITECTURE, INC. hereby expressly reserves its common law copywright and other property rights in these plans. These plans are not to be copied, reproduced or changed in any form or manner whatsoever, nor are they to be assigned to any third party without first obtaining the express written permission and consent of BUCILLA GROUP ARCHITECTURE, INC.

STAMP



ATTEST TO ARCHITECTURAL ONLY

Project

ARTESIA 7171 N. SCOTTSDALE ROAD SCOTTSDALE, ARIZONA

ARTESIA DEVELOPMENT PARTNERS, LLC SCOTTSDALE, ARIZONA

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BGA No. 15029

ENTRY MONUMENTATION AND SHADE DEVICE

ES-2.1

FINISHED FLOOR ELEVATION

NO CONFLICT SIGNATURE BLOCK

NAME OF COMPANY

REPRESENTATIVE

N/A

N/A

I, MICHAEL L. DELMARTER, P.E., AS THE ENGINEER OF RECORD FOR THIS DEVELOPMENT,

HEREBY CERTIFY THAT ALL UTILITY COMPANIES LISTED ABOVE HAVE BEEN PROVIDED FINAL

IMPROVEMENT PLANS FOR REVIEW, AND THAT ALL CONFLICTS IDENTIFIED BY THE UTILITIES

HAVE BEEN RESOLVED. IN ADDITION, "NO CONFLICT" FORMS HAVE BEEN OBTAINED FROM

FLOOD INSURANCE RATE MAP (FIRM) INFORMATION

NOV 4, 2015 | X, SHADED ZONE


OF FIRM

EACH UTILITY COMPANY AND ARE INCLUDED IN THIS SUBMITTAL.

IMPROVEMENT PLANS ARTESIA MAIN ENTRY

SCOTTSDALE, AZ

A PORTION OF THE SOUTHWEST QUARTER OF SECTION 2, T-2-N, R-4-E, OF THE GILA AND SALT RIVER BASE AND MERIDIAN, MARICOPA COUNTY, ARIZONA

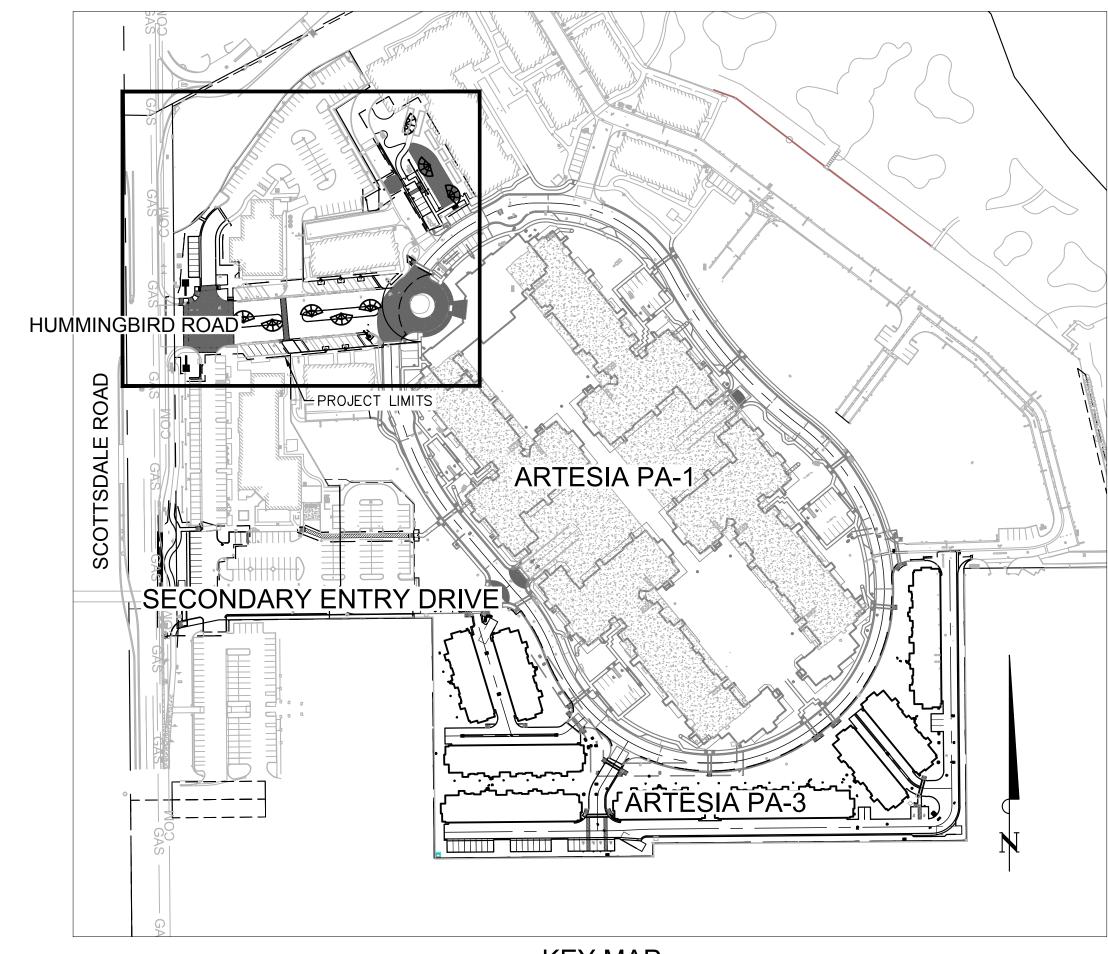

KEY MAP 1"=150'

SHEET INDEX:

C-7

DATE

SIGNED

N/A

N/A

DATE

SENT

N/A

N/A

TELEPHONE

NUMBER

N/A

N/A

SHERYL RENDON | (602) 493-4473 | 9/21/17 | 11/28/17

JAMES THOMPSON (623) 328-3554 | 9/21/17 | 10/23/17

ZACH STEVENSON | (480) 730-3855 | 9/21/17 | 9/27/17

JAMES THOMPSON | (623) 328-3554 | 9/21/17 | 10/23/17

04/19/18

BASE FLOOD ELEVATION

(IN AO ZONE, USE DEPTH)

NONE, < 1'

DATE

| SHEET NO. | DESCRIPTION |
|-----------|-------------------------|
| SHELT NO. | DESCRIPTION |
| C-1 | COVER SHEET |
| C-2 | GENERAL NOTES SHEET |
| C-3 | DEMOLITION PLAN |
| C-4 | HORIZONTAL CONTROL PLAN |
| C-5 | GRADING & DRAINAGE PLAN |
| C-6 | UTILITY PLAN |

CITY OF SCOTTSDALE GENERAL NOTES

CONSTRUCTION DETAILS

| 1 | ALL CONSTRUCTION IN THE PUBLIC RIGHTS-OF-WAY OR IN EASEMENTS GRANTED I |
|----|---|
| •• | PUBLIC USE MUST CONFORM TO THE LATEST MARICOPA ASSOCIATION OF GOVERNM |
| | (MAG) UNIFORM STANDARD SPECIFICATIONS AND UNIFORM STANDARD DETAILS FOR |
| | PUBLIC WORKS CONSTRUCTION AS AMENDED BY THE LATEST VERSION OF THE CITY |
| | SCOTTSDALE SUPPLEMENTAL STANDARD SPECIFICATIONS AND SUPPLEMENTAL STANI |
| | DETAILS. IF THERE IS A CONFLICT, THE CITY'S SUPPLEMENTAL STANDARD DETAILS |

- 2. THE CITY ONLY APPROVES THE SCOPE, NOT THE DETAIL, OF ENGINEERING DESIGNS; THEREFORE, IF CONSTRUCTION QUANTITIES ARE SHOWN ON THESE PLANS, THEY ARE NOT VERIFIED BY THE CITY.
- 3. THE APPROVAL OF PLANS IS VALID FOR SIX (6) MONTHS. IF AN ENCROACHMENT PERMIT FOR THE CONSTRUCTION HAS NOT BEEN ISSUED WITHIN SIX MONTHS, THE PLANS MUST BE RESUBMITTED TO THE CITY FOR REAPPROVAL
- 4. A PUBLIC WORKS INSPECTOR WILL INSPECT ALL WORKS WITHIN THE CITY OF SCOTTSDALE RIGHTS-OF-WAY AND IN EASEMENTS. NOTIFY INSPECTION SERVICES 24 HOURS PRIOR TO BEGINNING CONSTRUCTION BY CALLING 480-312-5750.
- 5. WHENEVER EXCAVATION IS NECESSARY, CALL THE BLUE STAKE CENTER, 602-263-1100, TWO WORKING DAYS BEFORE EXCAVATION BEGINS. THE CENTER WILL SEE THAT THE LOCATION OF THE UNDERGROUND UTILITY LINES IS
- IDENTIFIED FOR THE PROJECT. CALL COLLECT IF NECESSARY. 6. ENCROACHMENT PERMITS ARE REQUIRED FOR ALL WORK IN PUBLIC RIGHTS-OF-WAY AND EASEMENTS GRANTED FOR PUBLIC PURPOSES. AN ENCROACHMENT PERMIT WILL BE ISSUED BY THE CITY ONLY AFTER THE REGISTRANT HAS PAID A BASE FEE PLUS A FEE FOR INSPECTION SERVICES. COPIES OF ALL PERMITS MUST BE RETAINED ON-SITE AND BE AVAILABLE FOR INSPECTION AT ALL TIMES. FAILURE TO PRODUCE THE REQUIRED PERMITS WILL RESULT IN IMMEDIATE SUSPENSION OF ALL WORK UNTIL THE PROPER
- PERMIT DOCUMENTATION IS OBTAINED 7. ALL EXCAVATION AND GRADING THAT IS NOT IN THE PUBLIC RIGHTS-OF-WAY OR NOT IN EASEMENTS GRANTED FOR PUBLIC USE MUST CONFORM TO CHAPTER 70, EXCAVATION AND GRADING, OF THE LATEST EDITION OF THE UNIFORM BUILDING CODE PREPARED BY THE INTERNATIONAL CONFERENCE OF BUILDING OFFICIALS. A PERMIT FOR THIS GRADING MUST BE SECURED FROM THE CITY FOR A FEE ESTABLISHED BY THE UNIFORM BUILDING CODE.

ENGINEER'S STATEMENT

THE ENGINEER OF RECORD ON THESE PLANS HAS RECEIVED A COPY OF THE APPROVED STIPULATIONS FOR THIS PROJECT AND HAS DESIGNED THESE PLANS IN CONFORMANCE WITH THE APPROVED STIPULATIONS.

REGISTERED CIVIL ENGINEER DATE

ENGINEER'S CERTIFICATION


THE LOWEST FLOOR ELEVATION(S) AND/OR FLOODPROOFING ELEVATION(S) ON THIS PLAN ARE SUFFICIENTLY HIGH TO PROVIDE PROTECTION FROM FLOODING CAUSED BY A 100-YEAR STORM, AND ARE IN ACCORDANCE WITH SCOTTSDALE REVISED CODE, CHAPTER 37- FLOODPLAIN & STORMWATER REGULATION.

DATE REGISTERED CIVIL ENGINEER

"AS-BUILT CERTIFICATION"

I HEREBY CERTIFY THAT THE "RECORD DRAWING" MEASUREMENTS AS SHOWN HEREON WERE MADE UNDER MY SUPERVISION OR AS NOTED, AND ARE CORRECT TO THE BEST OF MY KNOWLEDGE AND BELIEF.

REGISTERED LAND SURVEYOR REGISTRATION NUMBER

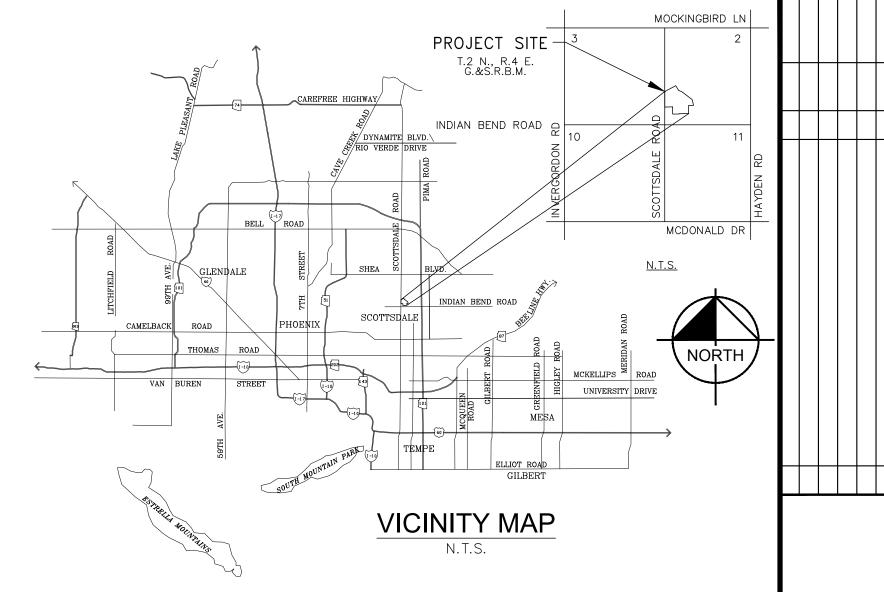

ENGINEER

KIMLEY-HORN & ASSOCIATES 7740 N 16TH STREET, SUITE 300 PHOENIX, AZ 85020 PHONE: (602) 944-5500 FAX: (602) 944-7423 CONTACT: MICHAEL L. DELMARTER, P.E.

ARCHITECTS

BUCILLA GROUP ARCHITECTURE, INC CONTACT: GREG G. BUCILLA 19782 MAC ARTHUR BLVD., SUITE 270 IRVINE, CA 92612 PHONE: (949) 851 9080

OWNER/DEVELOPER

MERITAGE HOMES 8800 E. RAINTREE DRIVE, SUITE 300 SCOTTSDALE, AZ 85260 CONTACT: TROY HILL E-MAIL: TROY.HILL@MERITAGEHOMES.COM PHONE: (480) 515-8164 FAX: (480) 375-2941

SURVEYOR

HUBBARD ENGINEERING 1201 S. ALMA SCHOOL RD. SUITE 300 MESA, AZ 85210 PH: (480) 398-3313 FAX: (480) 892-7051 CONTACT: ADRIAN BURCHAM

BENCHMARK

CITY OF SCOTTSDALE BRASS CAP IN HANDHOLE AT THE INTERSCTION OF SCOTTSDALE RD. AND LINCOLN DR. ELEV. = 1302.435 (NAVD 88)

I HEREBY CERTIFY THAT ALL ELEVATIONS REPRESENTED ON THIS PLAN ARE BASED ON THE ELEVATION DATUM FOR THE CITY OF SCOTTSDALE BENCHMARK AS PROVIDED ABOVE.

04/19/18 DATE

BASIS OF BEARING

REGISTERED CIVIL ENGINEER

THE BEARING N.0°30'40"W. ON THE MONUMENT LINE OF SCOTTSDALE ROAD AS SHOWN ON PLAT RECORDED IN BOOK 226, PAGE 38, M.C.R.

COX COMMUNICATIONS

UTILITIES

WATER & SEWER CITY OF SCOTTSDALE **ELECTRIC** TELEPHONE COX COMMUNICATIONS SOUTHWEST GAS CO. CABLE T.V.

ZONING

CURRENT ZONING: APN: 174-23-603 CLASSIFICATION: R-5 GROSS: 38.71 ACRES (1,686,208 SF)

| | CIVIL APPRO | DVAL | |
|------------|-----------------------|----------|---------|
| | REVIEW AND RECOMMENDE | D APPRO | VAL BY: |
| PAVING | | TRAFFIC | |
| G & D | | PLANNING | |
| W & S | | FIRE | |
| RET. WALLS | | | |
| | | • | |

ENGINEERING COORDINATION MANAGER (OR DESIGNEE)

602-263-1100

(OUTSIDE MARICOPA COUNTY)

DATE

MICHAEL L. DEL MARTER

191166007

of **11**

UTILITY

WATER

SEWER

GAS

LF₈₈

UTILITY

COMPANY

CITY OF SCOTTSDALE

CITY OF SCOTTSDALE

SOUTHWEST GAS

COX COMMUNICATIONS

ELECTRIC | ARIZONA PUBLIC SERVICE |

TELEPHONE COX COMMUNICATIONS

ENGINEER'S CERTIFICATION

COMMUNITY | PANEL # | SUFFIX

10/16/2013

NUMBER PANEL DÄTE

045012

PROJECT NO.

SHEE.

OVER

THENCE NORTH 89°29'20" EAST 1565.45 FEET TO THE TRUE POINT OF BEGINNING; THENCE ALONG A CURVE TO THE RIGHT WHOSE RADIUS IS 180.00 FEET THROUGH A CENTRAL ANGLE OF 53°00' COMMENCING AT THE SOUTHWEST CORNER OF SAID SOUTHWEST QUARTER; THENCE NORTH 00°30'40" WEST ALONG THE WEST LINE OF SAID SOUTHWEST QUARTER, A DISTANCE OF 580.00 FEFT:

THAT PORTION OF THE SOUTHWEST QUARTER OF SECTION 2, TOWNSHIP 2 NORTH, RANGE 4 EAST OF THE GILA AND SALT SALT RIVER BASE AND MERIDIAN, MARICOPA COUNTY, ARIZONA DESCRIBED AS FOLLOWS:

BEGINNING AT THE SOUTHWEST CORNER OF THE NORTH HALF OF THE SOUTHWEST QUARTER OF THE NORTHWEST QUARTER OF THE SOUTHWEST QUARTER OF SAID SECTION 2; THENCE ALONG THE SOUTHERLY LINE OF SAID NORTH HALF, SOUTH 89°03'25" EAST 40.01 FEET; THENCE IN A DIRECT LINE WITH THE NORTHEAST CORNER OF SAID NORTH HALF, NORTH 62°10'22" EAST 28.14 FEET TO A POINT ON A LINE PARALLEL WITH AND DISTANT EASTERLY 65.00 FEET AS MEASURED AT RIGHT ANGLES TO THE WESTERLY LINE OF SAID SECTION 2, SAID POINT BEING REFERRED TO AS "POINT A" FOR THE PURPOSE OF THIS DESCRIPTION; THENCE CONTINUING ALONG SAID DIRECT LINE NORTH 62°10'22" EAST 657.46 FEET TO THE NORTHEAST CORNER OF SAID NORTH HALF; THENCE SOUTH 30°58'31" EAST 292.85 FEET; THENCE SOUTH 70°09'50" EAST 167.65 FEET; THENCE SOUTH 52°41'30" EAST 427.67 FEET; THENCE SOUTH 37°20'16" WEST 583.38 FEET; THENCE SOUTH 89°29'20" WEST 934.69 FEET TO A POINT ON THE WESTERLY LINE OF SAID SOUTHWEST QUARTER OF SECTION 2 DISTANT SOUTHERLY 720.00 FEET TO THE POINT OF BEGINNING; THENCE ALONG SAID WESTERLY LINE NORTH 00°30'40" WEST 720.00 FEET TO THE POINT OF BEGINNING.

EXCEPT ALL GROUNDWATERS UNDERLYING SAID PROPERTY AS RESERVED IN DEED RECORDED IN DOCKET 10454, PAGE 1224, RECORDS OF MARICOPA COUNTY, ARIZONA.

PARCEL NO. 2

THAT PORTION OF THE SOUTHWEST QUARTER OF SECTION 2, TOWNSHIP 2 NORTH, RANGE 4 EAST OF THE GILA AND SALT RIVER BASE AND MERIDIAN, MARICOPA COUNTY, ARIZONA, MORE PARTICULARLY DESCRIBED AS FOLLOWS:

BEGINNING AT THE SOUTHWEST CORNER OF SAID SECTION 2: THENCE NORTH 00°30'40" WEST ALONG THE WEST ALONG THE WEST LINE OF SAID SECTION 2 A DISTANCE OF 930.66 FEET; THENCE NORTH 89°29'20" EAST 934.69 FEET TO THE TRUE POINT OF BEGINNING; THENCE CONTINUING NORTH 89°29'20" EAST 630.76 FEET; THENCE NORTH 13°08'50" WEST 308.81 FEET; THENCE NORTH 52°41'30" WEST 259.83 FEET; THENCE SOUTH 37°20'16" WEST 583.38 FEET TO THE TRUE POINT OF BEGINNING;

EXCEPT ALL GROUNDWATERS UNDERLYING SAID PROPERTY AS RESERVED IN DEED RECORDED IN DOCKET 10454, PAGE 1224, RECORDS OF MARICOPA COUNTY, ARIZONA.

PARCEL NO. 3

THE PORTION OF THE SOUTHWEST QUARTER OF SECTION 2, TOWNSHIP 2 NORTH, RANGE 4 EAST OF THE GILA AND SALT RIVER BASE AND MERIDIAN, MARICOPA COUNTY, ARIZONA, DESCRIBED AS FOLLOWS:

COMMENCING AT THE SOUTHWEST CORNER OF SAID SECTION 2; THENCE NORTH 00°30'40" WEST ALONG THE WEST LINE OF SAID SECTION 2, A DISTANCE OF 930.66 FEET; THENCE NORTH 13°08'50" WEST 308.81 FEET; THENCE NORTH 52°41'30" WEST 687.50 FEET; THENCE NORTH 70°09'50" WEST 167.65 FEET; THENCE NORTH 30°58'31" WEST 292.85 FEET; THENCE NORTH 30°54'33" WEST 484.63 FEET; THENCE NORTH 72°01'30" EAST 142.86 FEET; THENCE SOUTH 15°53'16" EAST 128.96 FEET; THENCE SOUTH 38°09'39" EAST 73.14 FEET; THENCE NORTH 83°05'20" EAST 45.00 FEET; THENCE SOUTH 32°02'32" EAST 92.52 FEET; THENCE SOUTH 40°01'01" EAST 45.00 FEET; THENCE SOUTH 47°16'09" EAST 55.94 FEET; THENCE ALONG A CURVE TO THE LEFT WHOSE RADIUS IS 120.00 FEET THROUGH A CENTRAL ANGLE OF 46°47'53", AN ARC DISTANCE OF 98.01 FEET; THENCE NORTH 85°55'58" EAST 139.80 FEET; 51", AN ARC DISTANCE OF 166.55 FEET; THENCE SOUTH 41°03'11" EAST 143.00 FEET; THENCE SOUTH 45°18'02" EAST 147.02 FEET; THENCE SOUTH 20°21'05" EAST 105.24 FEET; THENCE SOUTH 37°20'14" EAST 143.85 FEET; THENCE SOUTH 42°21'54" EAST 147.10 FEET; THENCE SOUTH 39°55'17" EAST 118.68 FEET; THENCE SOUTH 55°40'57" WEST 113.76 FEET; THENCE SOUTH 7°21'31" EAST 188.79 FEET; THENCE SOUTH 21'8'53" EAST 199.96 FEET; THENCE SOUTH 89°29'20" WEST 19.46 FEET TO THE TRUE POINT OF BEGINNING.

EXCEPT ALL GROUNDWATERS UNDERLYING SAID PROPERTY AS RESERVED IN DEED RECORDED IN DOCKET 12015, PAGE 544, RECORDS OF MARICOPA COUNTY, ARIZONA.

PARCEL NO. 4

BEING A PORTION OF THE SOUTHWEST QUARTER OF SECTION 2, TOWNSHIP 2 NORTH, RANGE 4 EAST OF THE GILA AND SALT RIVER BASE AND MERIDIAN, MARICOPA COUNTY, ARIZONA, MORE PARTICULARLY DESCRIBED AS FOLLOWS:

COMMENCING AT THE SOUTHWEST CORNER OF SAID SECTION 2; THENCE NORTH 00°30'40" WEST, AN ASSUMED BEARING ALONG THE WEST LINE OF SAID SOUTHWEST QUARTER OF SECTION 2, FOR A DISTANCE OF 930.66 FEET; THENCE NORTH 89°29'20" EAST FOR A DISTANCE OF 65.00 FEET TO THE TRUE POINT OF BEGINNING; THENCE CONTINUING NORTH 89°29'20" EAST FOR A DISTANCE OF 1240.14 FEET; THENCE SOUTH 00°30'40" EAST FOR A DISTANCE OF 425.00 FEET; THENCE SOUTH 89°29'20" WEST FOR A DISTANCE OF 776.00 FEET; THENCE NORTH 45°30'40" WEST FOR A DISTANCE OF 314.14 FEET; THENCE SOUTH 78°10'54" WEST FOR A DISTANCE OF 76.48 FEET; THENCE NORTH 00°30'40" WEST PARALLEL TO AND 65.00 FEET EAST OF THE SAID WEST LINE OF SECTION 2, FOR A DISTANCE OF 85.00 FEET TO THE TRUE POINT OF

EXCEPT ALL GROUNDWATERS UNDERLYING SAID PROPERTY AS RESERVED IN DEED RECORDED IN DOCKET 12632, PAGE 1438, RECORDS OF MARICOPA COUNTY, ARIZONA.

PARCEL NO. 5

EASEMENT RIGHTS AS SET FORTH IN INSTRUMENT RECORDED OCTOBER 14, 1987 IN 87-632657, OF OFFICIAL RECORDS (EXHIBIT "F") AND CORRECTED IN INSTRUMENT RECORDED APRIL 4, 1989 IN 89-153090, OF OFFICIAL RECORDS, OVER THE FOLLOWING DESCRIBED PROPERTY: THAT PART OF THE SOUTHWEST QUARTER OF SECTION 2, TOWNSHIP 2 NORTH, RANGE 4 EAST OF THE GILA AND SALT RIVER BASE AND MERIDIAN, MARICOPA COUNTY, ARIZONA, BEING MORE PARTICULARLY DESCRIBED AS FOLLOWS:

THENCE NORTH 89°29'20" EAST, A DISTANCE OF 65.00 FEET TO A POINT ON THE EAST LINE OF THE WEST 65.00 FEET OF SAID SOUTHWEST QUARTER AND THE POINT OF BEGINNING; THENCE CONTINUING NORTH 89°29'20" EAST, DISTANCE OF 145.68 FEET; THENCE SOUTH 00°30'40" EAST, A DISTANCE OF 28.00 FEET; THENCE SOUTH 89°29'20" WEST, A DISTANCE OF 145.68 FEET TO A POINT ON THE EAST LINE OF THE WEST 65.00 FEET OF SAID SOUTHWEST QUARTER; THENCE NORTH 00°30'40" WEST ALONG SAID EAST LINE A DISTANCE OF 28.00 FEET TO THE POINT OF BEGINNING.

PARCEL NO. 6

EASEMENT RIGHTS AS SET FORTH IN INSTRUMENT RECORDED OCTOBER 14, 1987 IN 87-632657, OF OFFICIAL RECORDS (EXHIBIT "G") AND CORRECTED IN INSTRUMENT RECORDED APRIL 4, 1989 IN 89-153090, OF OFFICIAL RECORDS, OVER THE FOLLOWING DESCRIBED PROPERTY:

THAT PART OF THE SOUTHWEST QUARTER OF SECTION 2, TOWNSHIP 2 NORTH, RANGE 4 EAST OF THE GILA AND SALT RIVER BASE AND MERIDIAN, MARICOPA COUNTY, ARIZONA, BEING MORE PARTICULARLY DESCRIBED AS FOLLOWS:

COMMENCING AT THE SOUTHWEST CORNER OF SAID SOUTHWEST QUARTER; THENCE NORTH 00°30'40" WEST ALONG THE WEST LINE OF SAID SOUTHWEST QUARTER, A DISTANCE OF 580.00 FEET; THENCE NORTH 89°29'20" EAST A DISTANCE OF 65.00 FEET TO A POINT ON THE EAST LINE OF THE WEST 65.00 FEET OF SAID SOUTHWEST QUARTER AND THE POINT OF BEGINNING; THENCE NORTH 00°30'40" WEST ALONG SAID EAST LINE, A DISTANCE 28.00 FEET; THENCE NORTH 89°29'20" EAST, A DISTANCE OF 145.68 FEET; THENCE SOUTH 00°30'40" EAST, A DISTANCE OF 145.68 FEET TO THE POINT OF BEGINNING.

PARCEL NO.

EASEMENT RIGHTS AS SET FORTH IN INSTRUMENT RECORDED OCTOBER 14, 1987 IN 87-632658, OF OFFICIAL RECORDS (EXHIBIT "D") OVER THE FOLLOWING DESCRIBED PROPERTY:

THAT PART OF THE SOUTHWEST QUARTER OF SECTION 2, TOWNSHIP 2 NORTH, RANGE 4 EAST OF THE GILA AND SALT RIVER BASE AND MERIDIAN, MARICOPA COUNTY, ARIZONA, BEING MORE PARTICULARLY DESCRIBED AS FOLLOWS:

COMMENCING AT THE SOUTHWEST CORNER OF SAID SOUTHWEST QUARTER; THENCE NORTH 00°30'40" WEST ALONG THE WEST LINE OF SAID SOUTHWEST QUARTER, A DISTANCE OF 580.00 FEET; THENCE NORTH 89°29'20" EAST, A DISTANCE OF 174.49 FEET TO THE POINT OF BEGINNING; THENCE NORTH 05°23'03" EAST, A DISTANCE OF 282.15 FEET; THENCE NORTH 89°29'20" EAST, A DISTANCE OF 36.19 FEET; THENCE SOUTH 89°29'20" WEST, A DISTANCE OF 36.19 FEET TO THE POINT OF BEGINNING.

LEGAL DESCRIPTION (CONT.)

PARCEL NO. 8B

THAT PORTION OF THE SOUTHWEST QUARTER OF SECTION 2, TOWNSHIP 2 NORTH, RANGE 4 EAST OF THE GILA AND SALT RIVER BASE AND MERIDIAN, MARICOPA COUNTY, ARIZONA, DESCRIBED AS FOLLOWS:

COMMENCING AT THE SOUTHWEST CORNER OF SAID SECTION 2; THENCE NORTH 00°30'40" WEST, ALONG THE WEST LINE OF SAID SECTION 2, A DISTANCE OF 930.66 FEET; THENCE NORTH 89°29'20" EAST, A DISTANCE OF 65.00 FEET, TO A POINT ON THE EAST RIGHT OF WAY OF SCOTTSDALE ROAD;

THENCE SOUTH 00°30'40" EAST, ALONG SAID RIGHT OF WAY, A DISTANCE OF 85.00 FEET; THENCE NORTH 78°10'45" EAST, A DISTANCE OF 76.48 FEET; THENCE NORTH 89°29'20" EAST, A DISTANCE OF 333.64 FEET, TO THE POINT OF BEGINNING; THENCE CONTINUING NORTH 89°29'20" EAST, A DISTANCE OF 40.50 FEET; THENCE SOUTH 00°30'40" EAST, A DISTANCE OF 21.21 FEET; THENCE NORTH 89°29'20" EAST, A DISTANCE OF 286.05 FEET; THENCE SOUTH 00°30'40" EAST, A DISTANCE OF 20.20 FEET; THENCE SOUTH 89°29'20" WEST, A DISTANCE OF 341.55 FEET; THENCE NORTH 00°30'40" WEST, A DISTANCE OF 375.20 FEET, TO THE TRUE POINT OF BEGINNING.

TOGETHER WITH EASEMENT OF ENJOYMENT OF ASSOCIATION LAND CONTAINED IN DECLARATION OF COVENANTS, CONDITIONS, ASSESSMENTS, CHARGES, SERVITUDES, LIENS, RESERVATIONS, AND EASEMENTS FOR MCCORMICK RANCH RECORDED DECEMBER 29, 1971 IN DOCKET 9148, PAGE 706.

TOGETHER WITH DRIVEWAY EASEMENT ABUTTING PARCEL 4 FOR THE BENEFIT OF PARCEL 4 AND FOR THE FURTHER BENEFIT OF PARCELS 1, 2 AND 3 RECORDED IN 87-632658.

TOGETHER WITH DECLARATION CREATING RECORDED OCTOBER 14, 1987 IN 87-632657 AND AFFIDAVIT OF CORRECTION RECORDED IN 89-153090. (IDENTIFIED AS PARCEL 5 AND BENEFITING PARCEL 6 AND FOR THE FURTHER BENEFIT OF PARCELS 7, 4, 1, 2 AND 3)

ENGINEERS NOTES

- 1. A REASONABLE ATTEMPT HAS BEEN MADE TO SHOW THE LOCATIONS OF ALL UNDERGROUND OBSTRUCTIONS AND UTILITY LINES IN THE WORK AREA, HOWEVER, THE CONTRACTOR SHALL BE RESPONSIBLE FOR ANY DAMAGE TO OBSTRUCTIONS AND UTILITY LINES ENCOUNTERED DURING CONSTRUCTION AND SHALL DETERMINE THE EXACT LOCATION OF UTILITIES AND MAKE THE ENGINEER AWARE, IN ADVANCE OF CONSTRUCTION.
- 2. ALL CONCRETE EXPOSED AT GROUND SURFACE SHALL BE INTEGRALLY COLORED TO BLEND WITH THE SURROUNDING DESERT. CONTRACTOR TO SUBMIT COLOR CHARTS TO OWNER FOR APPROVAL PRIOR TO ANY COLORED CONCRETE CONSTRUCTION. NO CONCRETE SHALL BE USED IN DEDICATED N.A.O.S. AREAS.
- 3. REFER TO THE GEOTECHNICAL EVALUATION PREPARED FOR THIS PROJECT, FOR PAVING DESIGNS, SPECIFICATIONS SUB-GRADE PREPARATION AND GEOTECHNICAL RECOMMENDATIONS.
- 4. AREAS WITHIN THE SIGHT DISTANCE TRIANGLE ARE TO BE CLEAR OF LANDSCAPING, SIGNS, OR OTHER VISIBLE OBSTRUCTIONS BETWEEN 2 FEET AND 7 FEET IN HEIGHT AND 6 INCHES MAXIMUM WIDTH OR DIAMETER. TREES WITHIN THE SITE DISTANCE TRIANGLE SHALL HAVE A CANOPY THAT BEGINS AT 7' IN HEIGHT.
- 5. SIGNS REQUIRE SEPARATE APPROVALS AND PERMITS.
- 6. ALL GRADED LAND AND AREAS DISTURBED BY ROAD AND UTILITY CONSTRUCTION WILL BE REVEGETATED BY THE DEVELOPER USING NATIVE PLANT SPECIES IN APPROXIMATELY THE SAME DENSITY AS NATURAL DESERT. IRRIGATION WILL BE EITHER HAND—WATERING OR BY AN AUTOMATIC DRIP SYSTEM.

WATER NOTES:

- 1. WATER METERS, WATER LINE BLOW-OFFS, MAIN LINE VALVES, AND FIRE HYDRANTS SHALL NOT BE CONSTRUCTED IN DRIVEWAYS, SIDEWALKS, WASHES, OR RETENTION AREAS.
- 2. PACK JOINT METER STOPS OR CORP. STOPS SHALL BE USED
- 3. WATER LINES SHALL BE DISINFECTED IN STRICT CONFORMANCE WITH MAG STANDARD SPECIFICATION #611.9. MAG #611.9 IS HEREWITH AMENDED AS FOLLOWS: "DRY POWDERED CALCIUM—HYPOCHLORITE COMPOUNDS SHALL NOT BE PLACED WITHIN PIPELINES DURING CONSTRUCTION."
- 4. NOTIFY THE CITY'S FIELD ENGINEERING REPRESENTATIVE AT 391-5750 WHEN READY TO HAVE SAMPLES TAKEN TO DETERMINE WHETHER DISINFECTION HAS BEEN ADEQUATE. SAMPLES ARE COLLECTED BY THE WATER AND WASTEWATER OPERATIONS DIVISION ON MONDAYS AND WEDNESDAYS ONLY.
- 5. WATER SERVICE LINE CONNECTIONS SHALL BE INSTALLED IN ACCORDANCE WITH THE CITY OF SCOTTSDALE STANDARD DETAIL #2330.
- 6. TRENCHING, BACKFILLING, AND COMPACTING SHALL BE IN ACCORDANCE WITH THE UNIFORM STANDARD SPECIFICATIONS FOR PUBLIC WORKS CONSTRUCTION, MARICOPA ASSOCIATION OF GOVERNMENTS (MAG), SECTION 601 (LATEST REVISION). ALL BACKFILL WITHIN THE PUBLIC RIGHT—OF—WAY SHALL BE TYPE 1 UNLESS OTHERWISE NOTED. COMPACTION TESTING WILL BE AS REQUIRED BY THE CITY'S FIELD ENGINEERING MANAGER OR HIS/HER AUTHORIZED REPRESENTATIVE.
- 7. FOR ALL DUCTILE IRON PIPE INSTALLATIONS, SOIL CORROSIVITY TESTS SHALL BE CONDUCTED EVERY 1,000 FEET ALONG THE PROPOSED PIPELINE ROUTE. TESTING PROCEDURES SHALL BE CONDUCTED AND REPORTED IN ACCORDANCE WITH THE
- 8. THE INSIDE OF ALL GATE VALVES AND BUTTERFLY VALVES SHALL BE EPOXY COATED PER MAG SPECIFICATIONS FOR GATE

AMERICAN DUCTILE IRON PIPE RESEARCH ASSOCIATION. REPORTS SHALL BE FILED WITH THE CITY.

- VALVES.

 9. GATE VALVES SHALL BE PROVIDED WITH LOW—ZINC
- STEMS.

 10. ELECTRONIC LOCATORS SHALL BE A SELF—LEVELING TYPE, SHALL OPERATE AT A FREQUENCY OF 145.7Khz, AND SHALL BE CAPABLE OF DETECTION TO A DEPTH OF 4 FEET.
- 11. ALL JOINT RESTRAINT FITTINGS FOR VALVES, FIRE HYDRANTS, TEES, CROSSES, CORP. STOPS, VERTICAL REALIGNMENTS, AND BENDS TO INCORPORATE "MEG—A—LUG" JOINT RESTRAINT OR C.O.S. APPROVED EQUIVALENT. SEE JOINT RESTRAINT TABLE ON THIS SHEET.
- 12. DUCTILE IRON PIPE SHALL BE POLYETHYLENE WRAPPED.
- 13. IN ACCORDANCE WITH AAC R18-4-119, ALL MATERIALS ADDED AFTER JANUARY 1, 1993 WHICH MAY COME IN CONTACT WITH DRINKING WATER SHALL CONFORM TO NATIONAL SANITATION FOUNDATION STANDARDS 60 AND 61.

SEWER NOTES

1. ALL SANITARY SEWER LINES SHALL BE CONSTRUCTED TO TRUE LINE AND GRADE, 0.05 FEET PER M.A.G. SPECIFICATION 615.2. THE CITY WILL REQUIRE ALL SANITARY SEWER LINES OUTSIDE OF THE 0.05 FEET TOLERANCE FROM DESIGN GRADE TO BE REMOVED AND REPLACED. THE CONTRACTOR SHALL TAKE PRECAUTIONARY MEASURES WHICH MAY INCLUDE SURVEYING OF LINES PRIOR TO BACKFILLING AND SETTING OF MANHOLES, AS NECESSARY, TO VERIFY COMPLIANCE.

TABLE OF QUANTITIES ON-SITE

| ON SITE PAVING QUANT | TITIES | |
|---------------------------|--------|----|
| 2.5" AC/8" ABC | 262 | SY |
| 3" AC/8" ABC | 1,637 | SY |
| CONCRETE VALLEY GUTTER | 117 | LF |
| 6" VERTICAL CURB & GUTTER | 210 | LF |
| 6" VERTICAL CURB | 1,231 | LF |
| SIDEWALK RAMPS | 5 | EA |
| 4" SIDEWALK | 2,004 | SF |
| 6' SCREEN WALL | 49 | LF |
| DECORATIVE PAVEMENT | 4,901 | SF |
| DECORATIVE PAVERS | 7,866 | SF |

| ON SITE DEMOLITION QUA | NTITIES | |
|---------------------------------------|---------|----|
| ASPHALT PAVEMENT | 2,229 | SY |
| DECORATIVE CONCRETE 7" PCCP ON 6" ABC | 1,050 | SY |
| 6" VERTICAL CURB | 1,010 | LF |
| 4" CONCRETE SIDEWALK | 277 | SY |
| 6' SCREEN WALL | 51 | LF |
| 6" CURB AND GUTTER | 618 | LF |
| | | |

EARTHWORK QUANTITIES

THE QUANTITIES LISTED BELOW ARE FOR PERMIT PURPOSES ONLY. THE CONTRACTOR SHALL MAKE HIS OWN DETERMINATION OF THE QUANTITIES INVOLVED AND BASE HIS BID ON HIS OWN ESTIMATE.

RAW CUT = 34 CY RAW FILL = 51 CY

THE QUANTITIES SHOWN HEREON ARE AN ESTIMATE ONLY. THE CONTRACTOR SHALL BE RESPONSIBLE FOR VERIFYING ALL QUANTITIES BEFORE BIDDING.

KIMEY-HORN AND ASSOCIATES, INC.
740 North 16th Street, Suite 300
hoenix, Arizona 85020 (602) 944-5500

SCALE (V): NONE
SESIGNED BY: TGK
SRAWN BY: TGK
CHECKED BY: MLD

ENERAL NOTES

30886
MICHAEL L.
DELMARTER

ARIZONAUSA

Exp. Date 12/31/18

PROJECT NO.
191166007

CALL TWO WORKING DAYS


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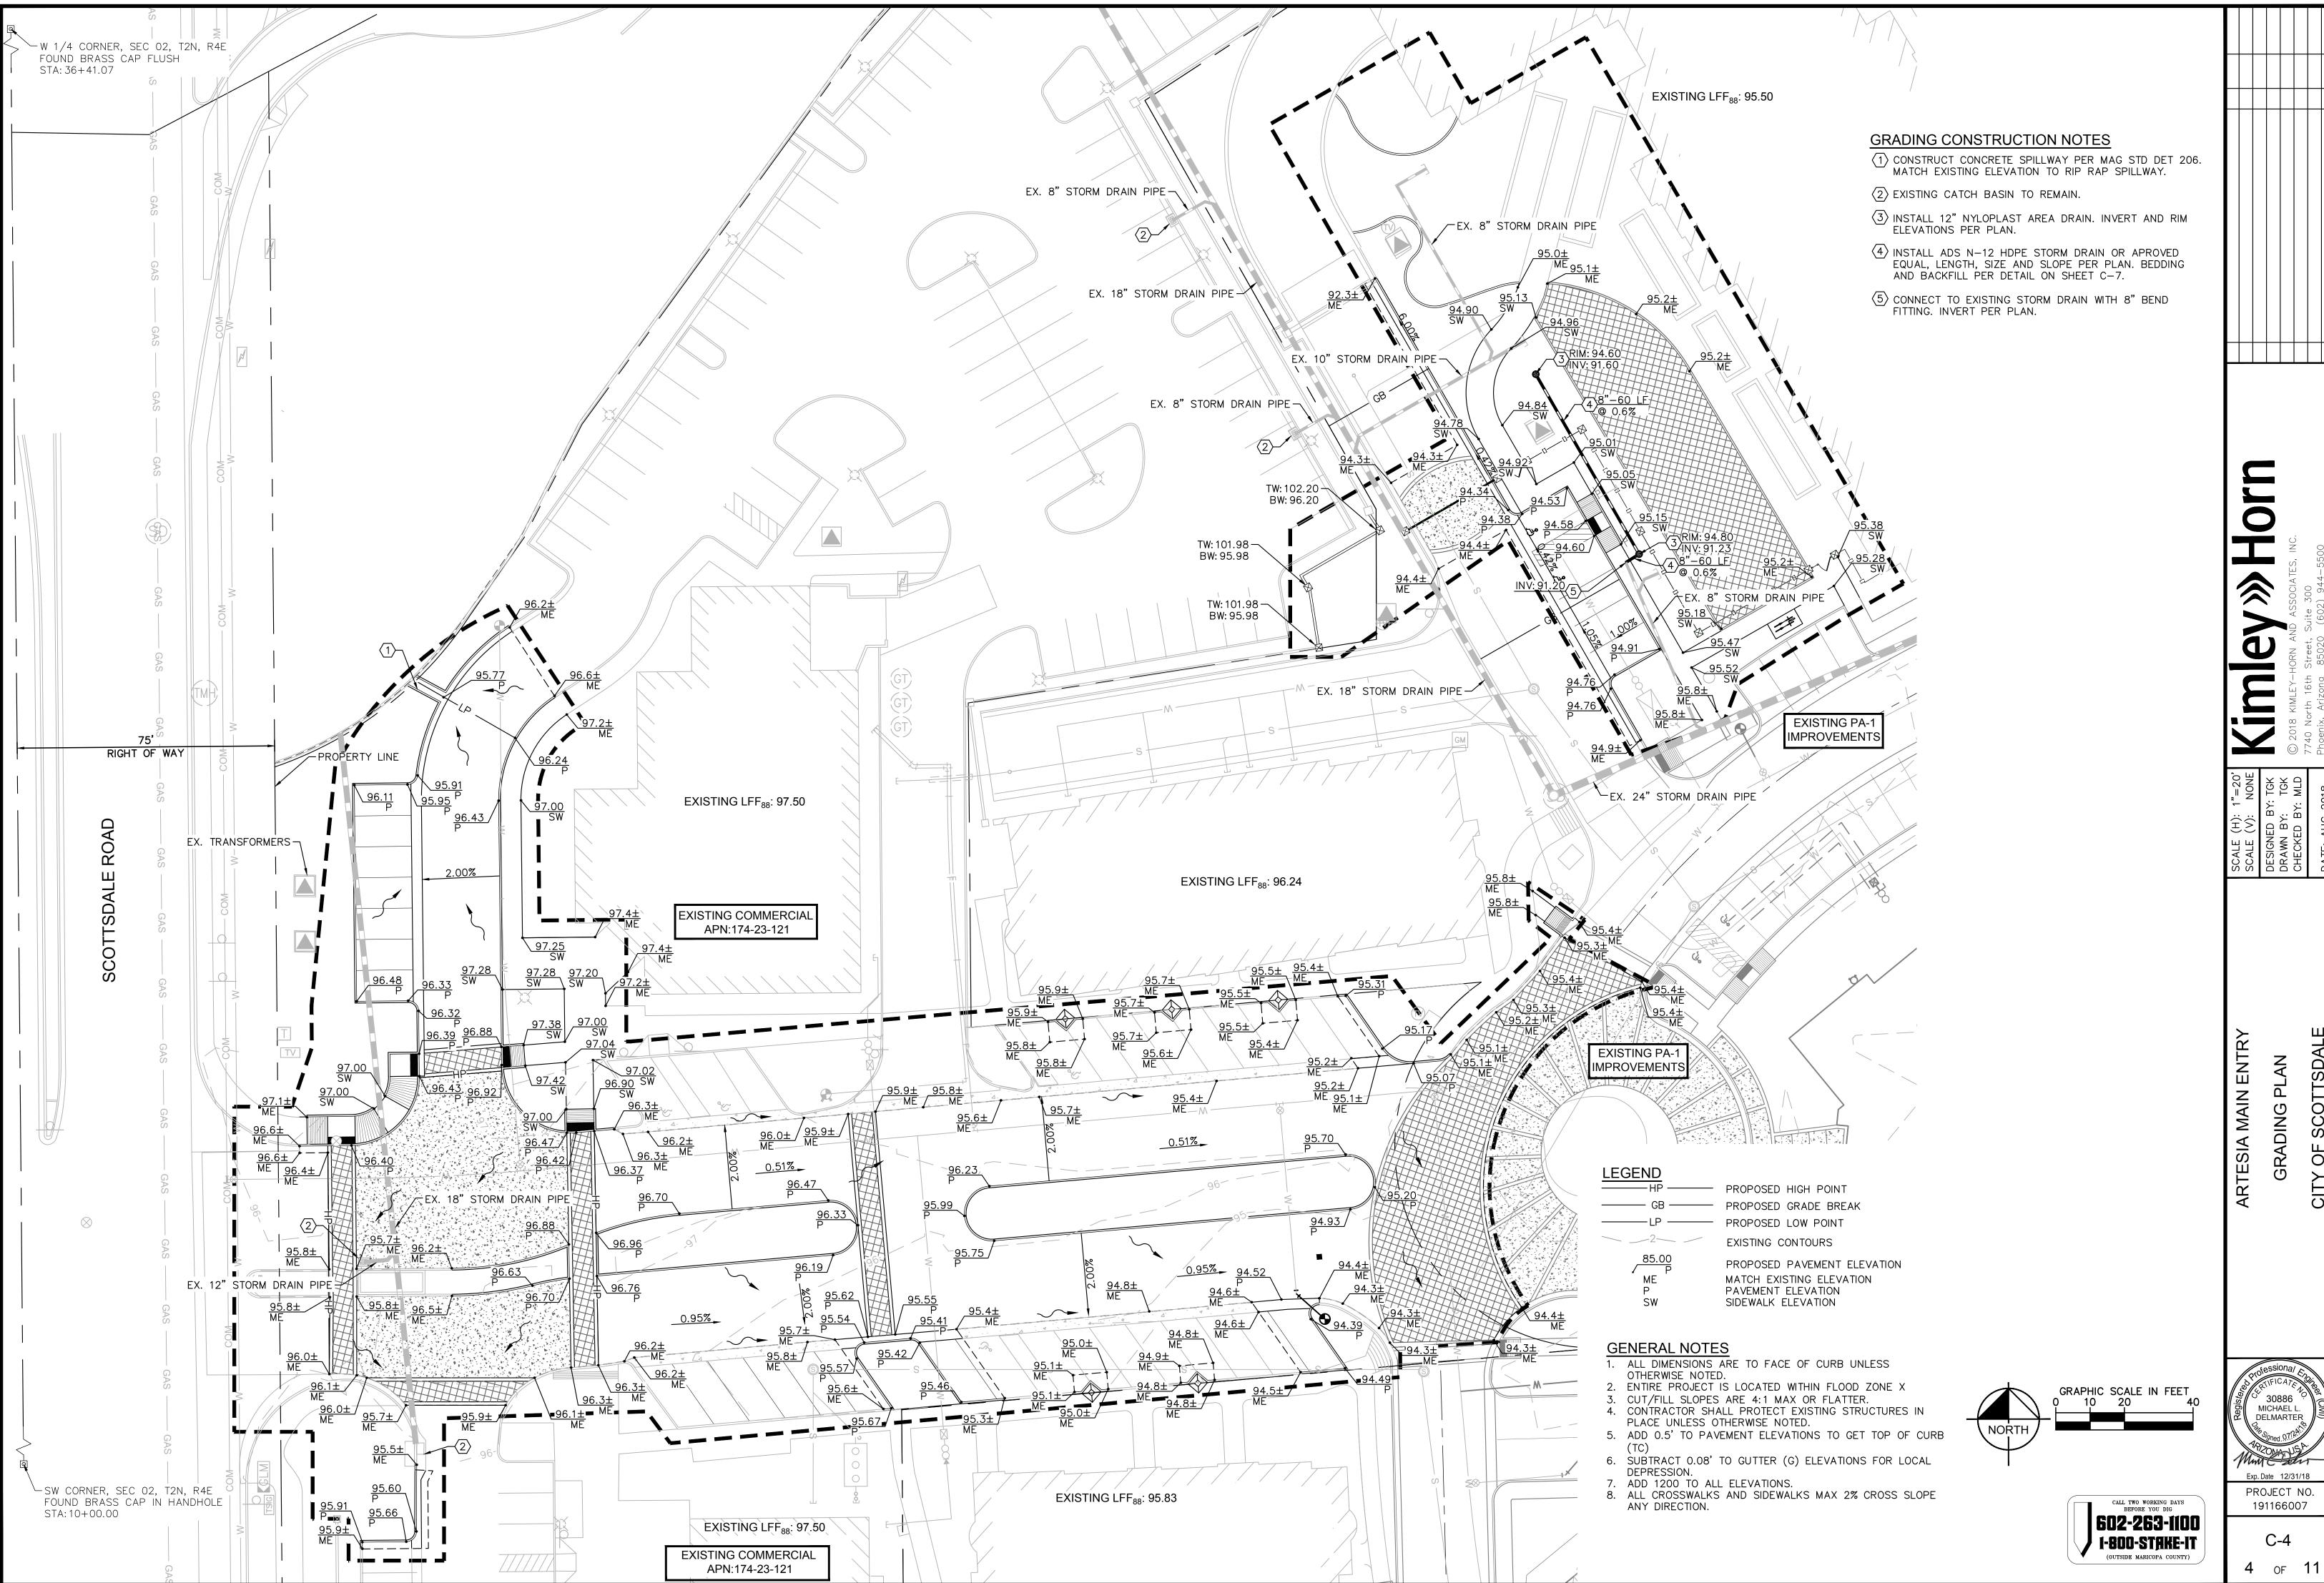
| 602-263-1100

(OUTSIDE MARICOPA COUNTY)

C-2


2 of 11



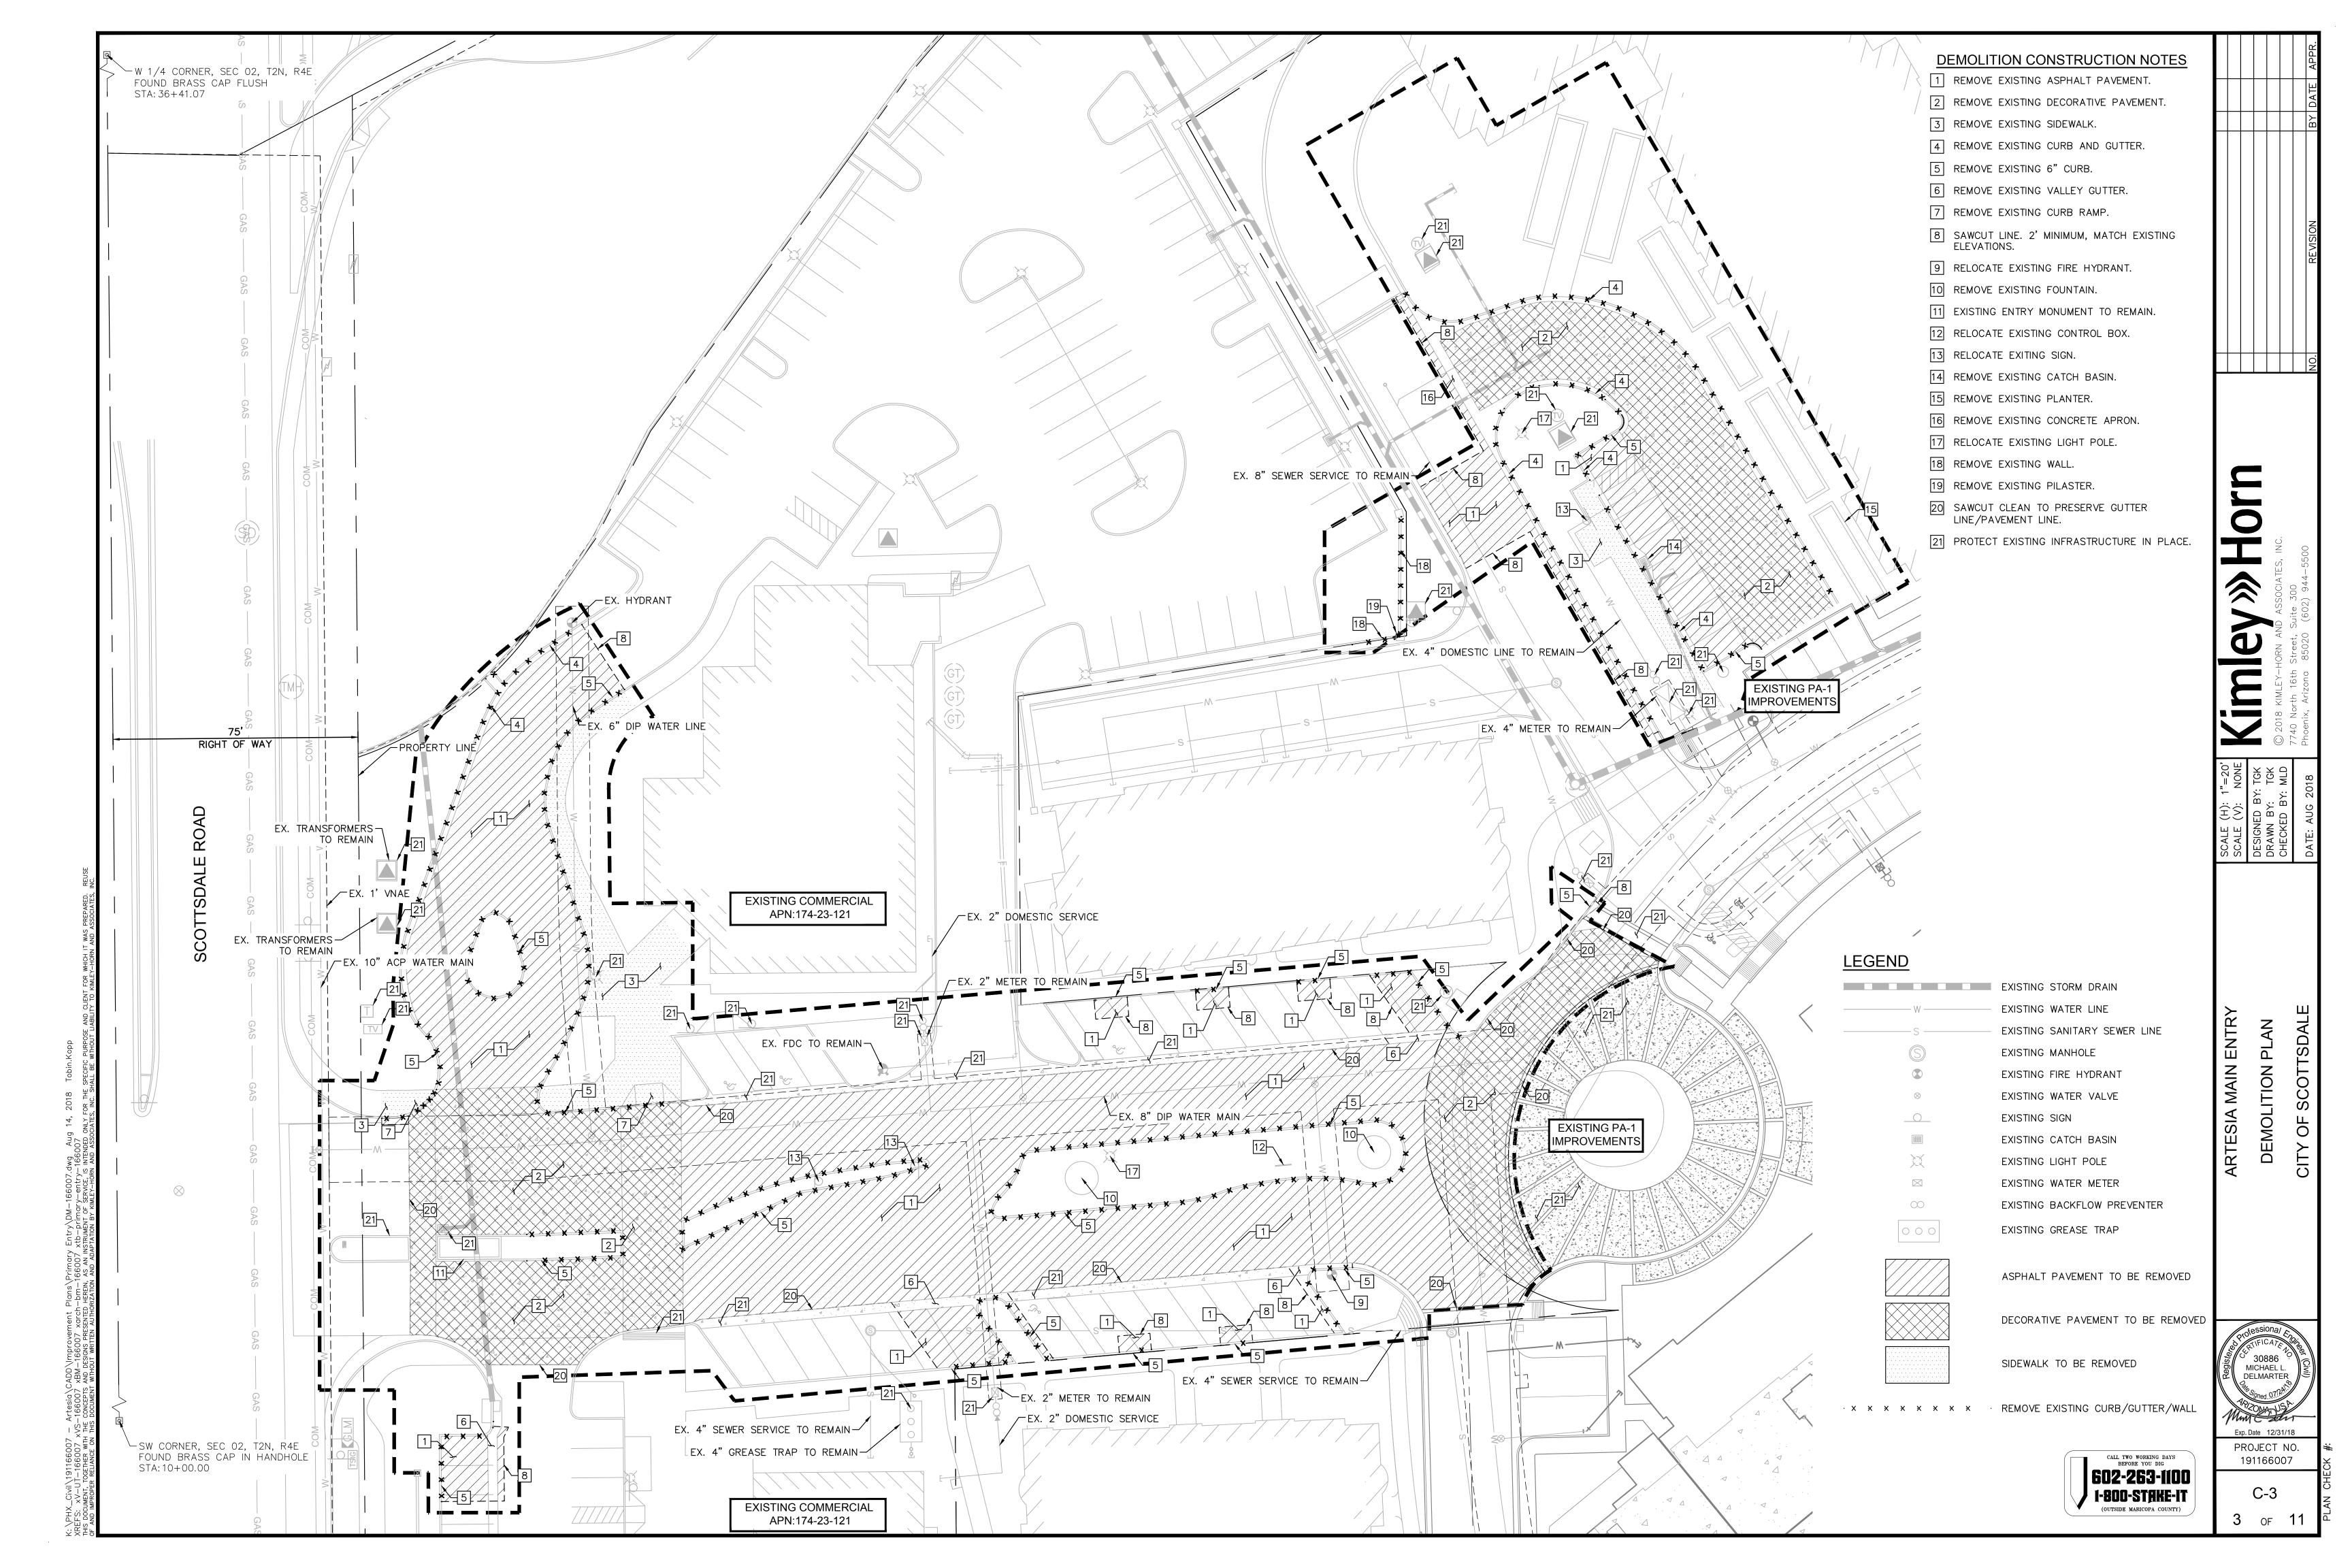

GRADING PI

PROJECT NO. 191166007

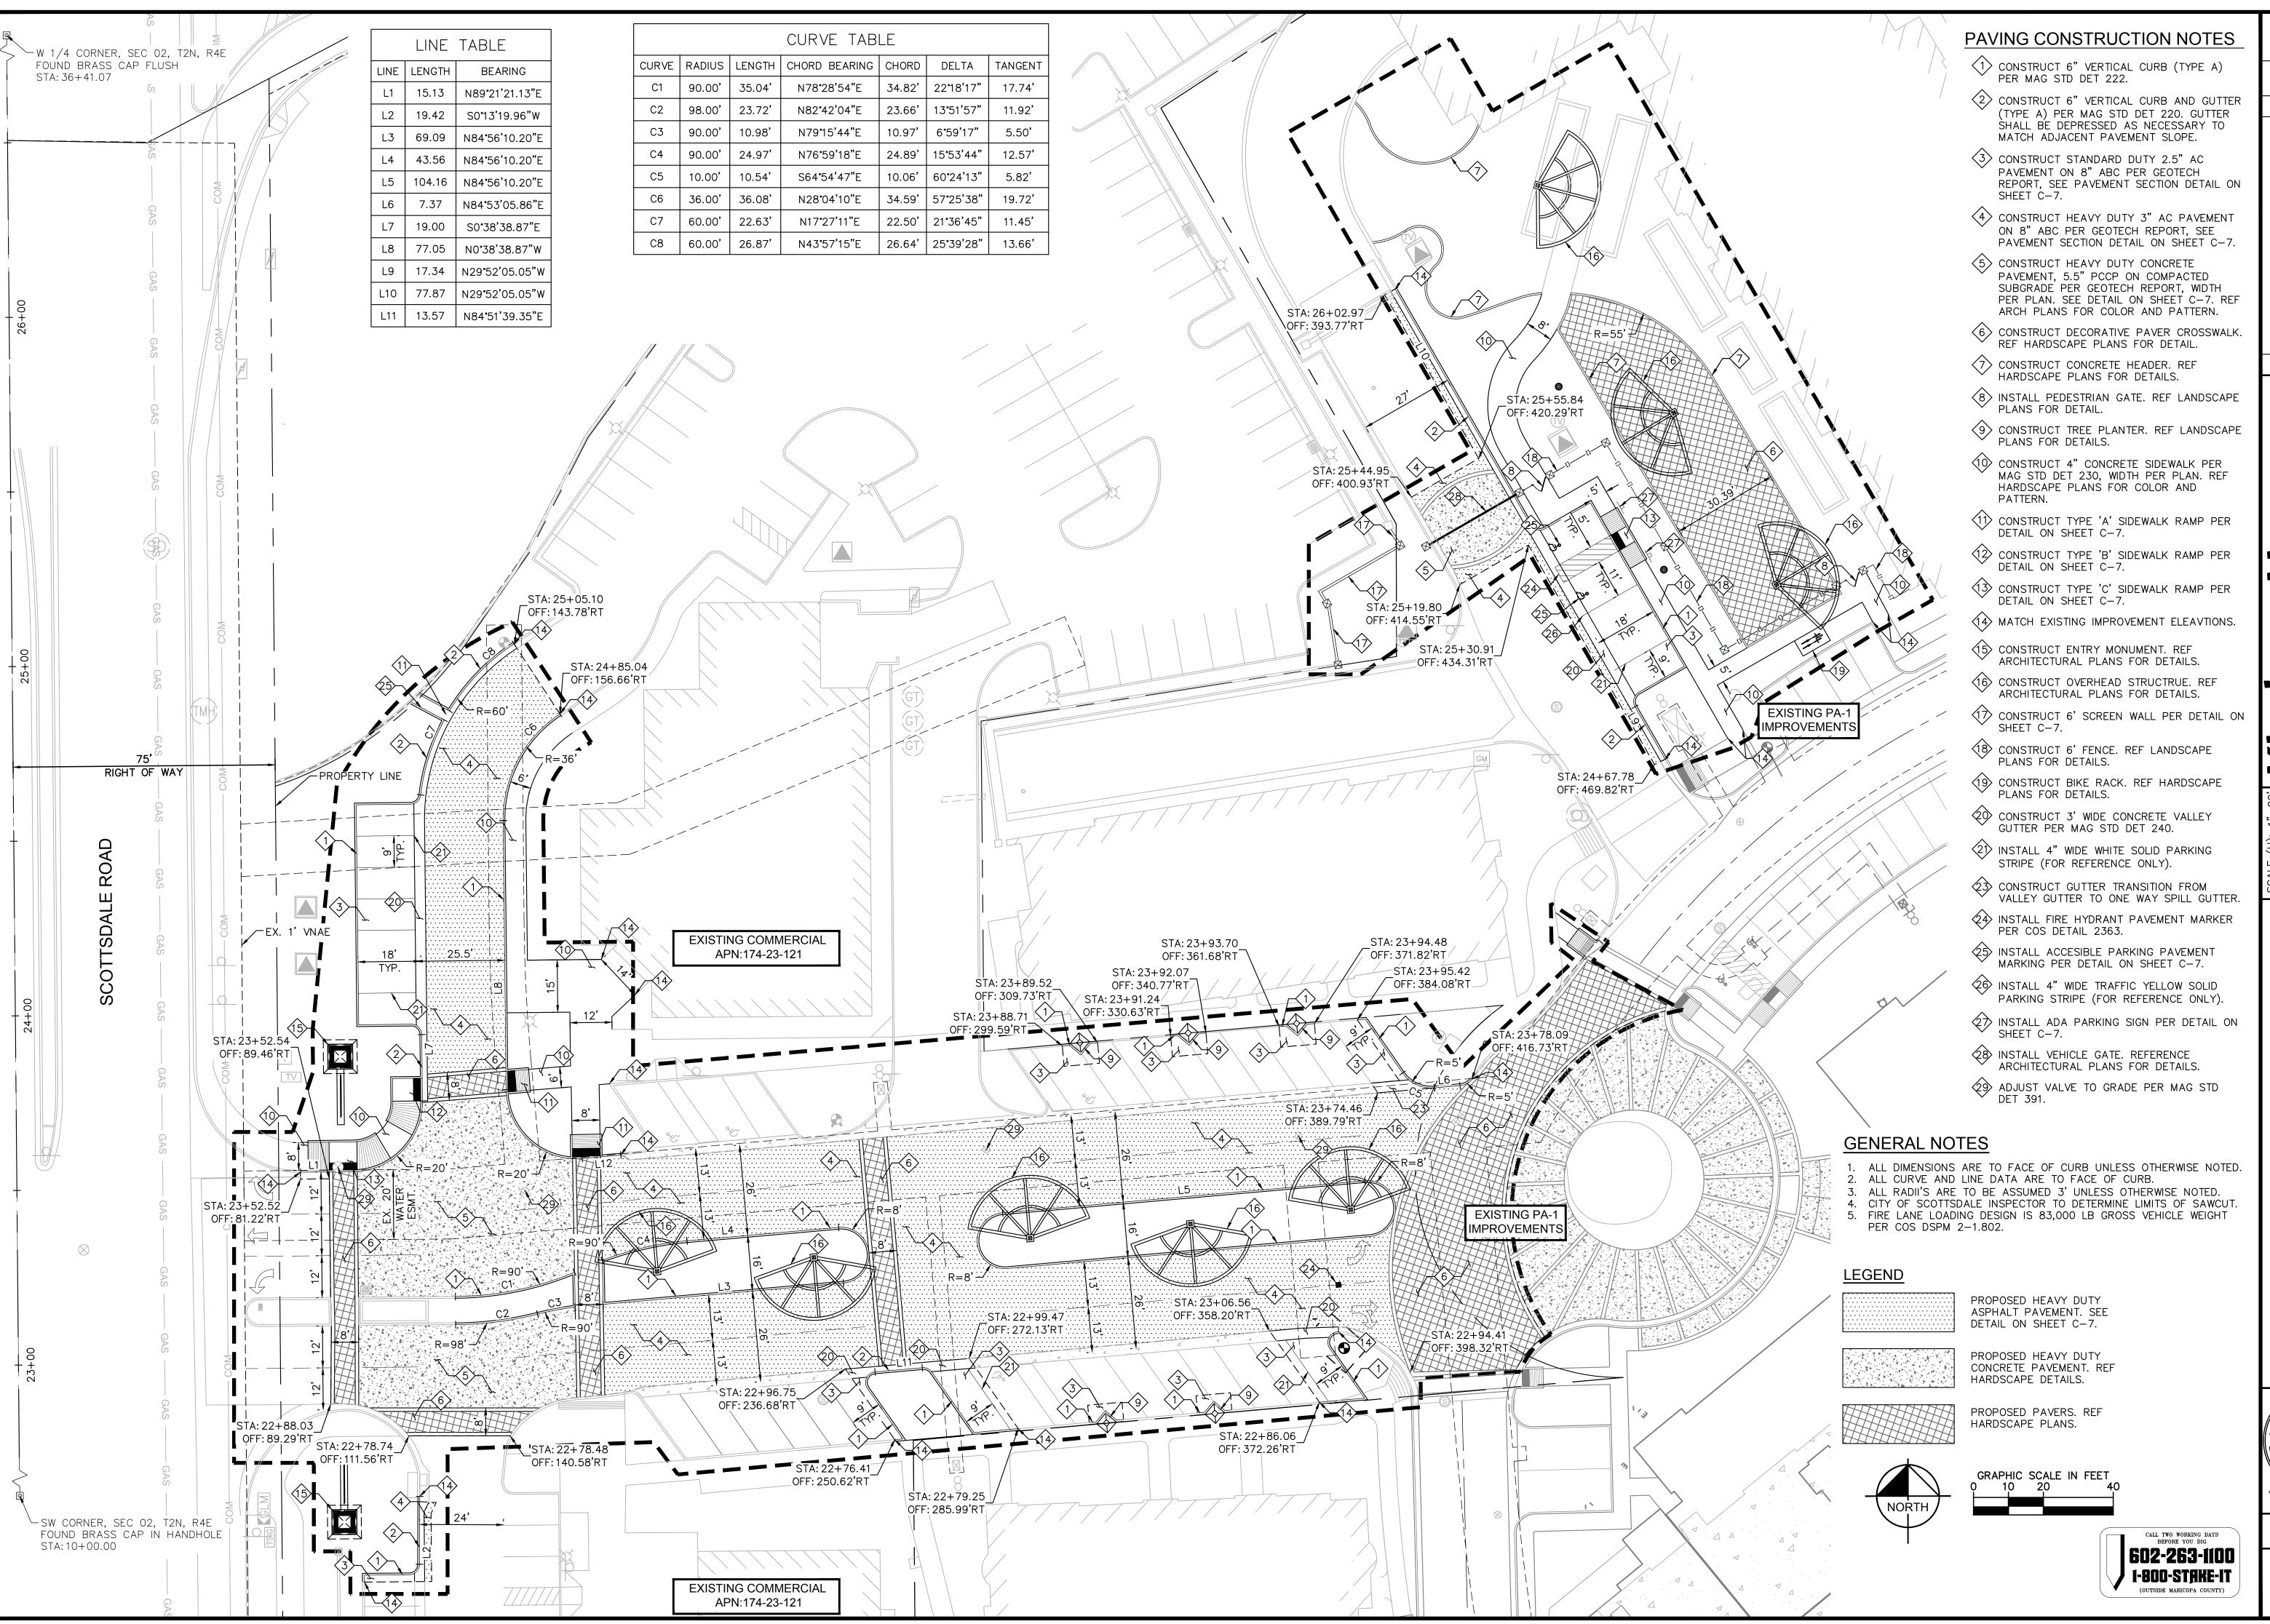


MICHAEL L.

PROJECT NO.

191166007


5 of 11

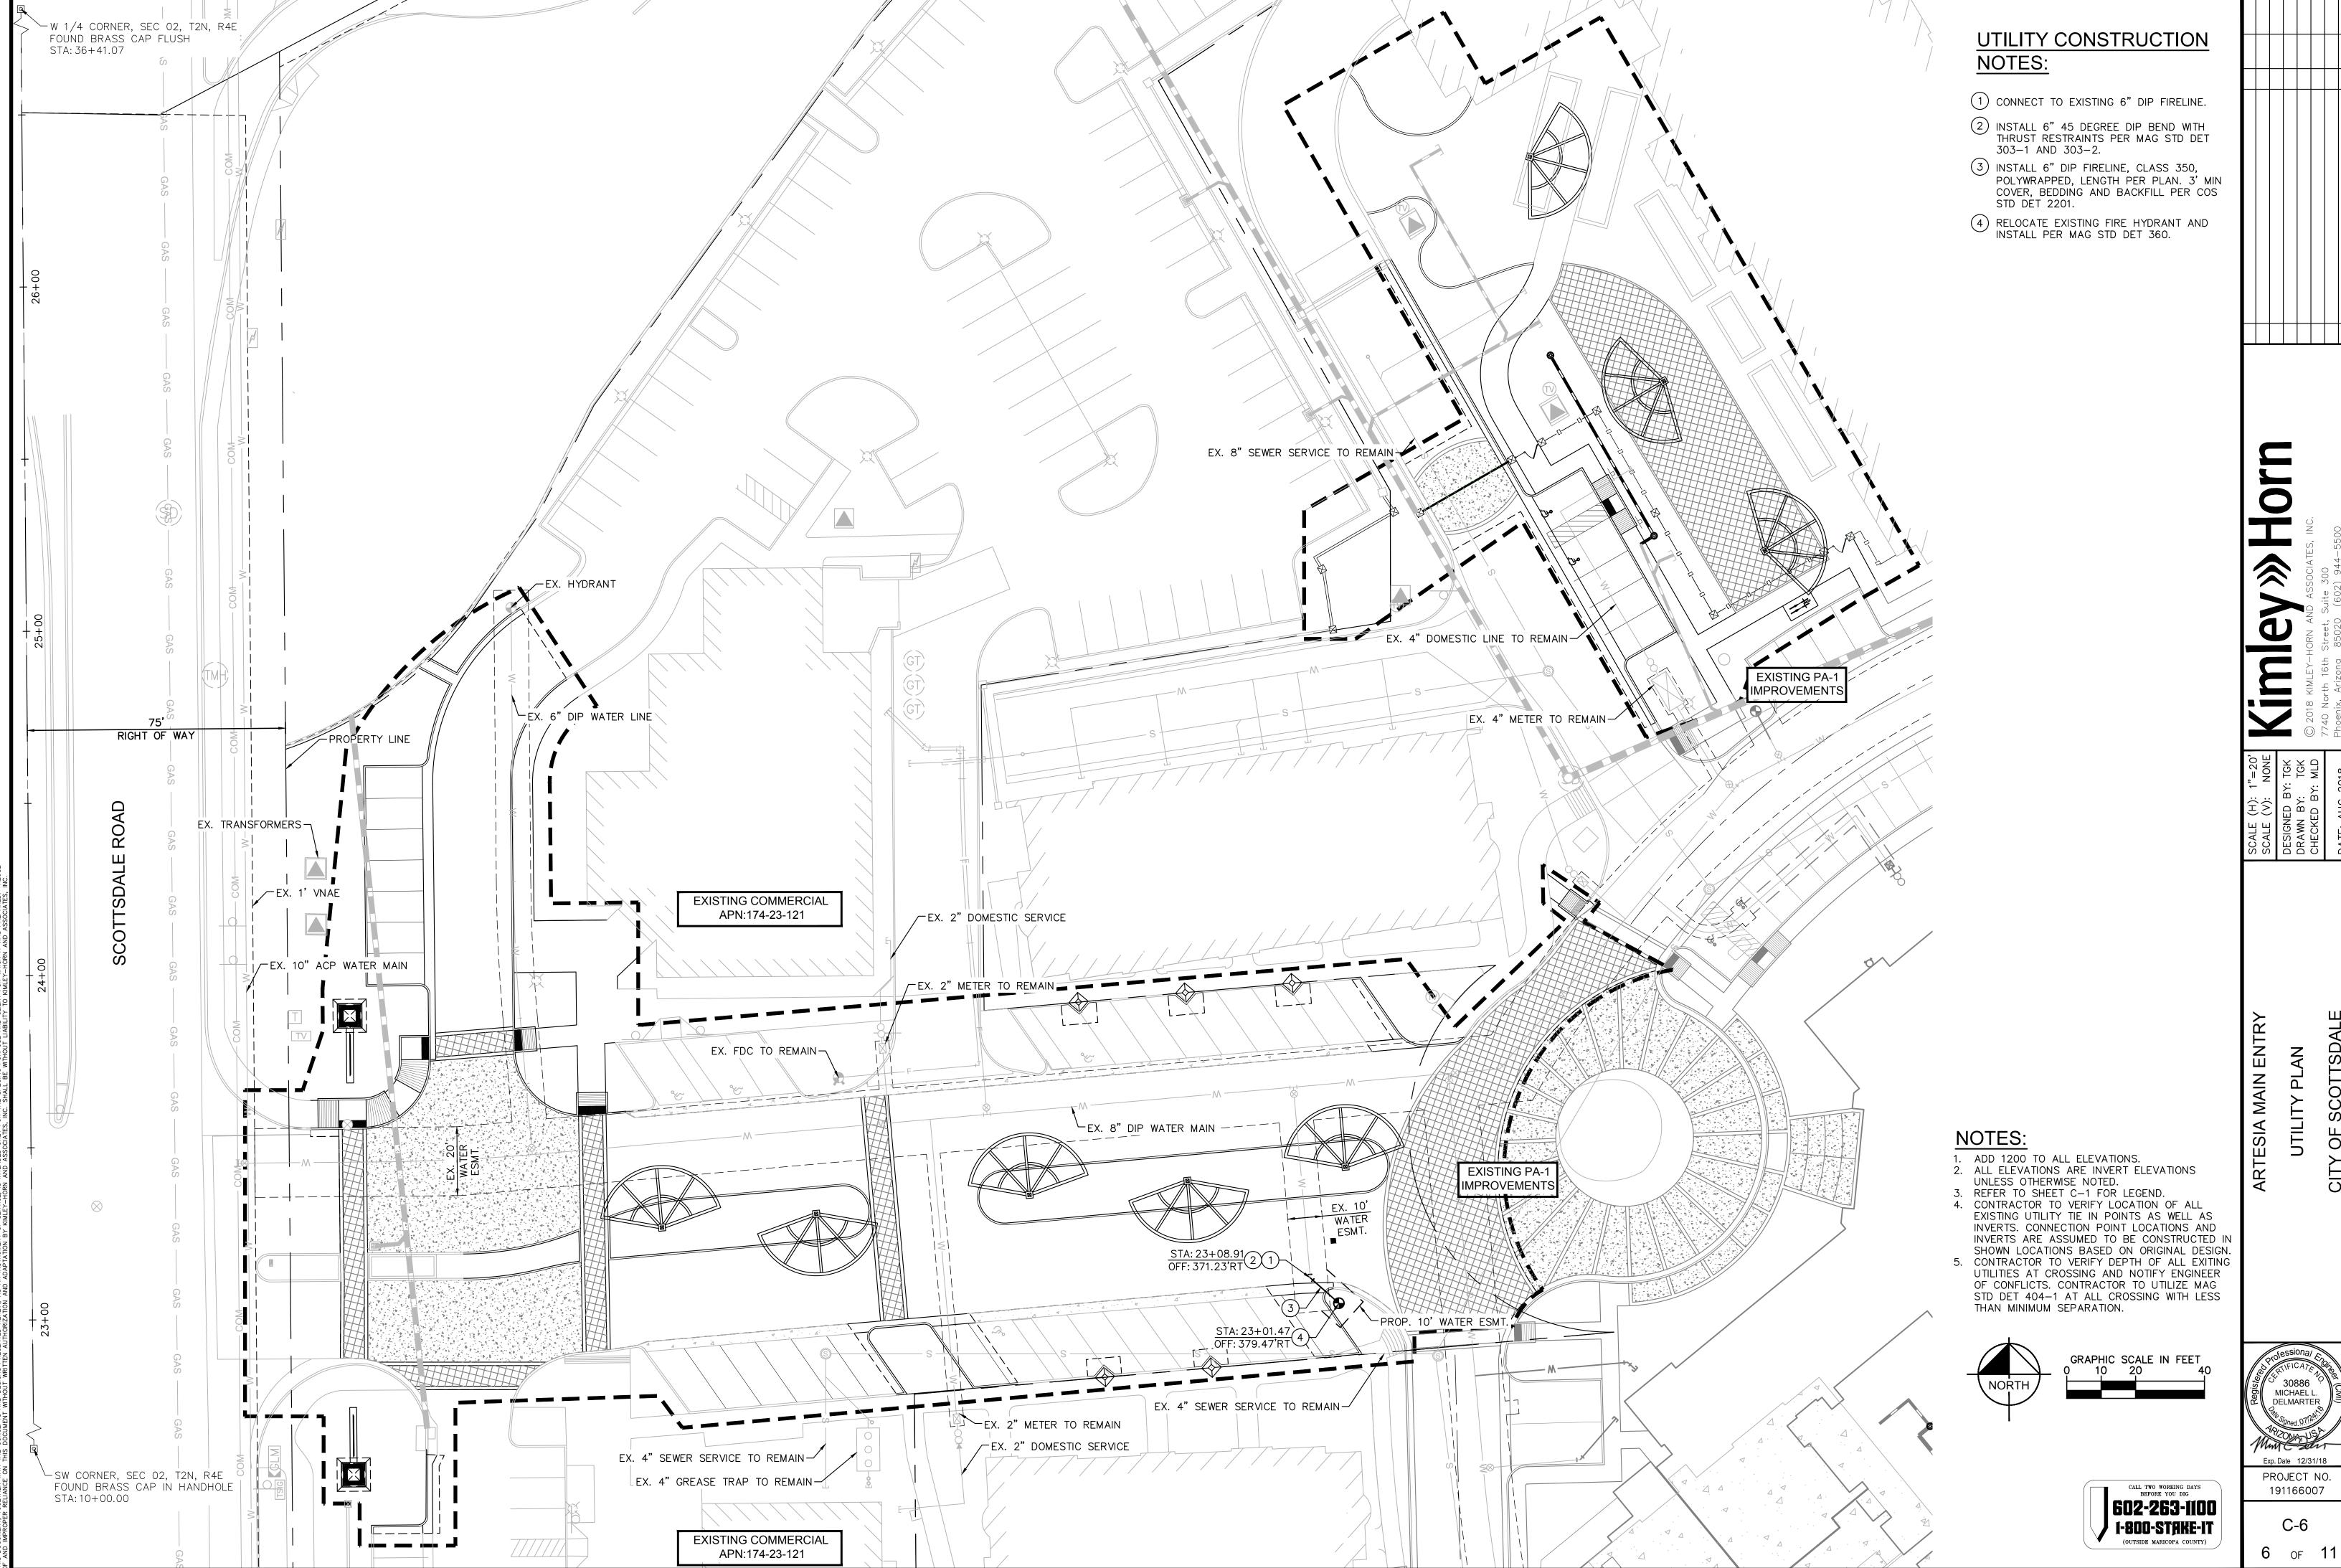

DECORATIVE PAVEMENT, REFER TO LANDSCAPE ARCHITECT'S PLANS FOR INFORMATION 7" PORTLAND CEMENT CONCRETE 6" AGGREGATE BASE COURSE MATERIAL PER MAG SEC 710 - COMPACTED SUBGRADE

DECORATIVE CONCRETE PAVEMENT DETAIL

N.T.S.

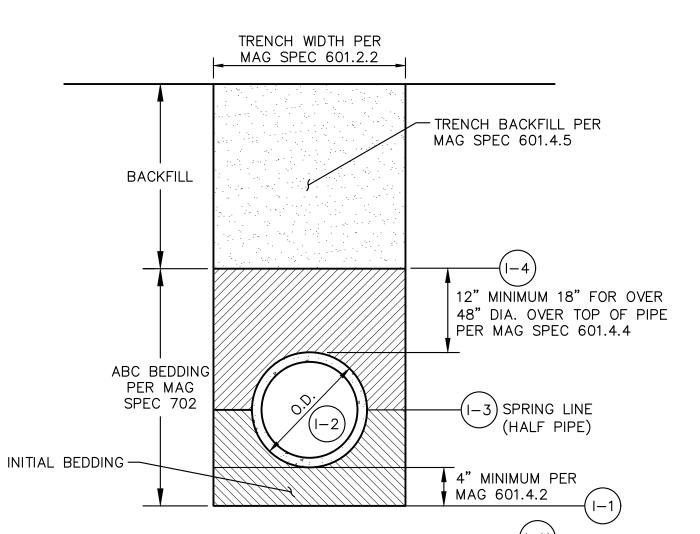

NOTES:

1. FOR USE WITH CORRUGATED HDPE PIPE WHICH SHALL CONFORM WITH MAG 738 AND SHALL BE INSTALLED PER MAG 603.

2. BEDDING TO 12" OVER PIPE SHALL BE ABC. HDPE PIPES LARGER THAN 48" REQUIRE 18" OF COVER.

3. NO BEDDING IS TO BE CONSIDERED A PART OF THE ROADWAY STRUCTURAL SECTION.

4. ALL COMPACTION DENSITIES SHALL BE PER MAG 601.4.6.

PRECAUTIONS TO AVOID PIPE MOVEMENT WHEN PLACING BACKFILL.

5. CONTRACTOR SHALL TAKE

6. THIS DETAIL IS NOT TO SUPERSEDE MORE STRINGENT MANUFACTURER REQUIREMENTS.

HDPE STORM DRAIN PIPE BEDDING AND BACKFILL DETAIL


INSPECTIONS: I-1. THE TRENCH SHALL BE INSPECTED PRIOR TO PLACEMENT OF BEDDING.


I-2. THE PIPE AND INITIAL BEDDING SHALL BE INSPECTED PRIOR TO ANY ADDITIONAL BEDDING.

I-3. THE PIPE SHALL BE INSPECTED AND COMPACTION TESTS SHALL BE COMPLETED AT SPRING LINE PRIOR TO BACKFILLING THE TRENCH.


I-4. THE BEDDING SHALL BE INSPECTED AND COMPACTION TESTS SHALL BE COMPLETED PRIOR TO BACKFILLING THE TRENCH.


N.T.S.

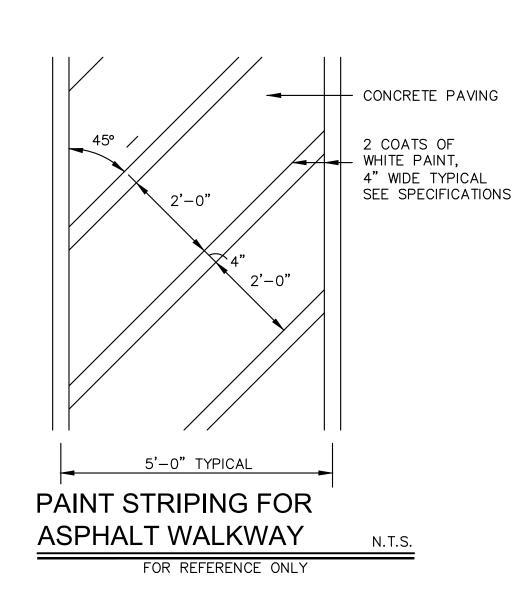


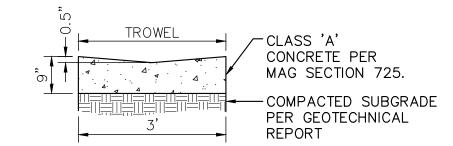



VALLEY GUTTER DETAIL N.T.S.

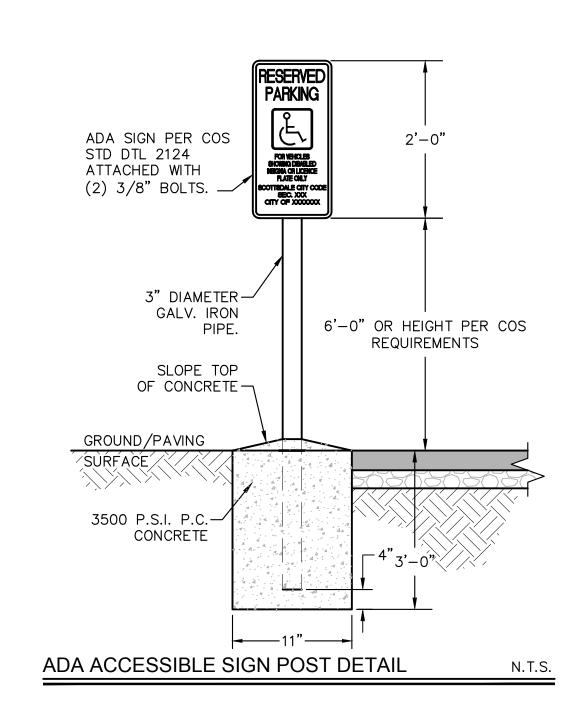


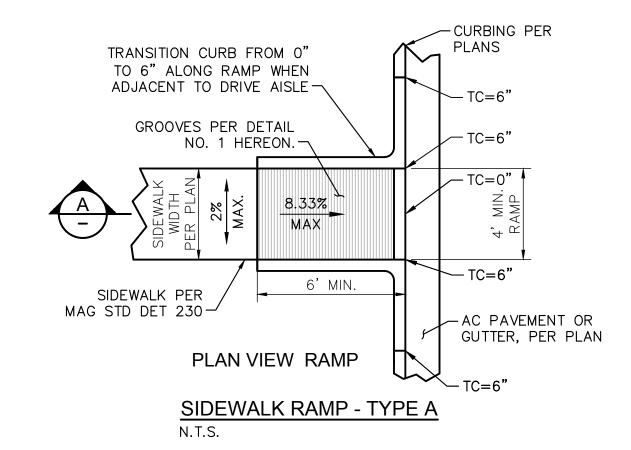

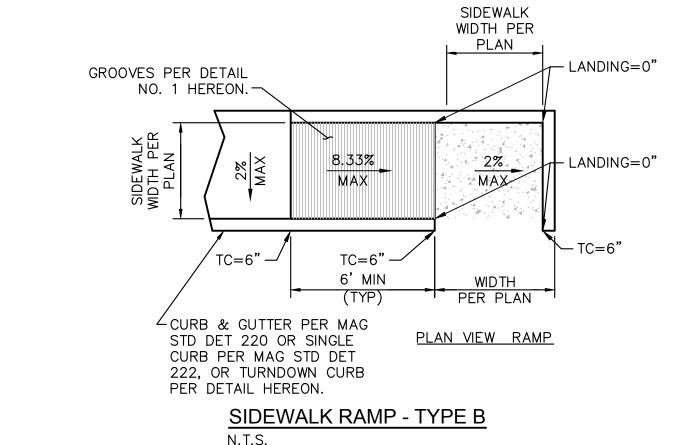

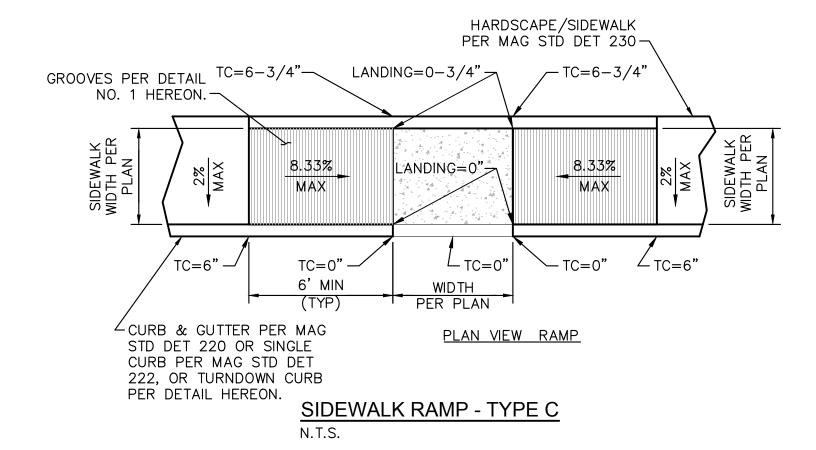

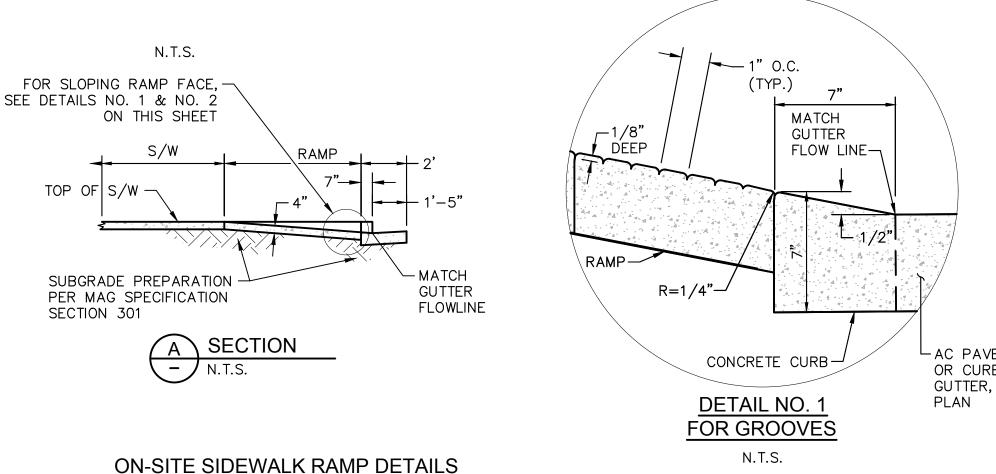

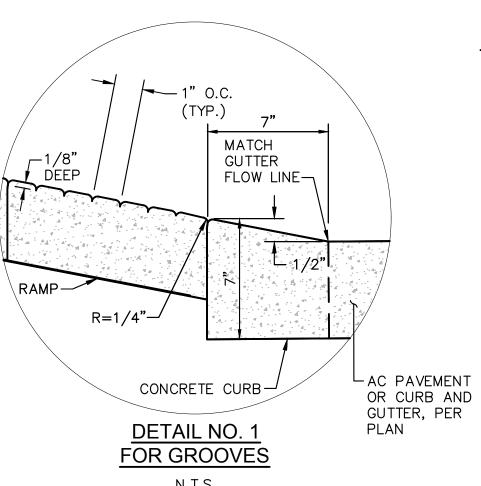

NOTES:

1. CONTROL ELEVATIONS SHOWN HERE ARE IN RELATION TO THE GUTTER. GUTTER ELEVATION=0.


2. CLASS "B" CONCRETE CONSTRUCTION PER MAG SPECIFICATION SECTION 725. 3. ALL RAMPS MUST MEET ADA ACCESSIBILITY GUIDELINES (ADAAG) STANDARDS; 2% MAX CROSS

SLOPES AND 12:1 MAX LONGITUDINAL SLOPES. 4. SIDEWALKS WITH LONGITUDINAL SLOPES OF LESS THAN 5% ARE

NOT CONSIDERED RAMPS PER ADA. 5. CURB RAMPS ON ACCESSIBLE ROUTES SHALL COMPLY WITH ADA 406, 405.2 THROUGH 405.5, 405.10, AND ADA 406.1. 6. THE RUNNING SLOPE OF WALKING SURFACES SHALL NOT BE STEEPER THAN 1:20. THE CROSS SLOPE OF

WALKING SURFACES SHALL NOT BE STEEPER THAN 1:48 PER 2010 ADA

N.T.S.

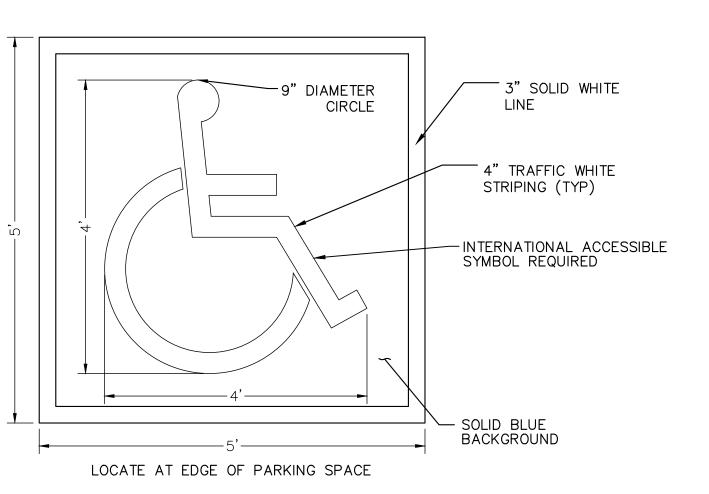

INTERNATIONAL ACCESSIBLE PARKING SYMBOL DETAIL N.T.S.

CALL TWO WORKING DAYS BEFORE YOU DIG 602-263-1100 1-800-STAKE-IT

30886 MICHAEL L. DELMARTER PROJECT NO.

C-7

SHEE-**DETAILS**

191166007

of **11**

STORM WATER POLLUTION PREVENTION PLAN ARTESIA MAIN ENTRY

A PORTION OF THE SOUTHWEST QUARTER OF SECTION 2, T-2-N. R-4-E, OF THE GILA AND SALT RIVER BASE AND MERIDIAN SCOTTSDALE, ARIZONA

USGS QUADRANGLE MAP N.T.S.

ENGINEER

KIMLEY-HORN & ASSOCIATES 7740 N 16TH STREET, SUITE 300 PHOENIX, AZ 85020 PHONE: (602) 944-5500 FAX: (602) 944-7423 CONTACT: MICHAEL L. DELMARTER, P.E.

ARCHITECTS

WATER & SEWER

BENCHMARK

BASIS OF BEARINGS

LEGAL DESCRIPTION

C-8

C-9

C-10

C-11

FLOOD INFORMATION

BFEs HAVE BEEN DETERMINED.

ELECTRIC

TELEPHONE

CABLE T.V.

CITY OF SCOTTSDALE

COX COMMUNICATIONS

COX COMMUNICATIONS

SHEET INDEX

THE FLOOD ZONE DESIGNATION FOR THIS AREA IS ZONE X, SHADED

MAP NUMBER 04013C1770L, REVISED OCTOBER 16, 2013.

DEFINED AS: AN AREAS INUNDATED BY 0.2% ANNUAL CHANCE FLOODING, FOR WHICH

STORMWATER MANAGEMENT PLAN COVER

STORMWATER MANAGEMENT PLAN DETAILS

STORMWATER MANAGEMENT PLAN DETAILS

STORMWATER MANAGEMENT PLAN

SOUTHWEST GAS CO.

THE BEARING N.0°30'40"W. ON THE MONUMENT

RECORDED IN BOOK 226, PAGE 38, M.C.R.

LINE OF SCOTTSDALE ROAD AS SHOWN ON PLAT

CITY OF SCOTTSDALE BRASS CAP IN HANDHOLE

AT THE INTERSCTION OF SCOTTSDALE RD. AND

LINCOLN DR. ELEV. = 1302.435 (NAVD 88).

REPRESENTED ON THIS PLAN ARE BASED ON

SCOTTSDALE BENCHMARK AS PROVIDED ABOVE.

I HEREBY CERTIFY THAT ALL ELEVATIONS

THE ELEVATION DATUM FOR THE CITY OF

SEE SHEET C-1 FOR LEGAL DESCRIPTION.

BUCILLA GROUP ARCHITECTURE, INC CONTACT: GREG G. BUCILLA 19782 MAC ARTHUR BLVD., SUITE 270 IRVINE, CA 92612 PHONE: (949) 851 9080

OWNER/DEVELOPER

MERITAGE HOMES 8800 E. RAINTREE DRIVE, SUITE 300 SCOTTSDALE, AZ 85260 CONTACT: TROY HILL E-MAIL: TROY.HILL@MERITAGEHOMES.COM PHONE: (480) 515-8164

HUBBARD ENGINEERING 1201 S. ALMA SCHOOL RD. SUITE 300 MESA, AZ 85210 PH: (480) 398-3313 FAX: (480) 892-7051 CONTACT: ADRIAN BURCHAM

FAX: (480) 375-2941

SURVEYOR

EROSION AND SEDIMENT CONTROLS

STABILIZATION PRACTICES:

EMPORARY CONTROLS:

TEMPORARY CONTROLS: STABILIZED CONSTRUCTION ENTRANCES

DUST CONTROL APPLIED WITH A FINE SPRAY OF WATER PERMANENT CONTROLS:

LANDSCAPING AREAS AND PAVEMENT IN ROADWAYS. <u>TRUCTURAL PRACTICES:</u>

INLET PROTECTION, SEDIMENT TRAPS, SILT FENCE, DIVERSION DIKES. PERMANENT CONTROLS:

SEDIMENT BASINS (RETENTION BASIN), ROCK OUTLET PROTECTION.

STORM WATER MANAGEMENT: THE STORM WATER WILL BE PROVIDED BY OVERLAND TO SURFACE DETENTION BASINS ON-SITE, HELPING PREVENT FUTURE POLLUTION FROM LEAVING THE SITE.

THE STORM WATER CONTROLS USED TO RETAIN SEDIMENT ON-SITE ARE SEDIMENT TRAPS, SILT FENCES, DIVERSION DIKES, INLET PROTECTION, AND STABILIZED CONSTRUCTION ENTRANCES.

<u>SELECTION/INSTALLATION/AND MAINTENANCE:</u> SEE SPECIFIC BMP CUT SHEETS FOR INFORMATION ON SHEETS C-10 TO C-11.

MAINTENANCE/INSPECTION PROCEDURES

MAINTENANCE:

ALL STRUCTURAL BMP'S WILL FOLLOW THE SPECIFICATION LISTED IN THE BMP DETAILS ON SHEETS C-10 TO C-11.

INSPECTIONS:

INSPECTION AND MAINTENANCE PRACTICES THAT WILL BE USED TO MAINTAIN STORM WATER POLLUTION PREVENTION CONTROLS:

 LESS THAN ONE HALF OF THE SITE WILL BE DENUDED AT ONE TIME. 2. ALL CONTROL MEASURES WILL BE INSPECTED AT LEAST ONCE BIWEEKLY AND AFTER A RAINFALL AMOUNT EQUAL TO OR GREATER THAN 0.5 INCHES IN A 24

3. ALL MEASURES SHALL BE MAINTAINED IN FULLY OPERATIONAL CONDITION. IF A REPAIR IS NECESSARY IT WILL BE INITIATED WITHIN 24 HOURS OF OBSERVATION.

4. BUILT UP SEDIMENT WILL BE REMOVED FROM ORGANIC FILTER BARRIERS WHEN IT HAS REACHED ONE-THIRD THE HEIGHT OF THE BARRIERS. 5. ORGANIC FILTER BARRIERS WILL BE INSPECTED FOR DEPTH OF SEDIMENT, TEARS,

AND TO SEE THAT THE FENCE POSTS ARE FIRMLY IN THE GROUND. 6. THE SEDIMENT TRAPS WILL BE INSPECTED FOR DEPTH OF SEDIMENT, AND BUILT UP SEDIMENT WILL BE REMOVED WHEN THE DESIGN CAPACITY IS REDUCED BY

7. A MAINTENANCE INSPECTION REPORT WILL BE MADE AFTER EACH INSPECTION. 8. THE GENERAL CONTRACTOR PROJECT SUPERINTENDENT WILL BE RESPONSIBLE FOR INSPECTION, MAINTENANCE AND REPAIR ACTIVITIES, AND ALL REQUIRED INSPECTION/MAINTENANCE REPORTS.

9. INGRESS/EGRESS ROCK TRACK OUT AREAS WILL BE INSPECTED FOR EVIDENCE OF OFF-SITE TRACKING OF SEDIMENT, DEBRIS, AND OTHER POLLUTANTS FROM ALL PAVED AREAS. SEDIMENT, DEBRIS, OR POLLUTANTS SHALL BE CLEANED AND DISPOSED OF AS SOON AS PRACTICABLE.

CHANGES TO THE STORM WATER POLLUTION PREVENTION PLAN AS A RESULT OF INSPECTION SHALL BE COMPLETED AND IMPLEMENTED WITHIN SEVEN DAYS OF INSPECTION.

ALL BMP'S SHALL BE MAINTAINED IN FULLY FUNCTIONING ORDER UNTIL THE BMP IS NO LONGER NEEDED IN THAT PHASE OF CONSTRUCTION OR PERMANENT STABILIZATION HAS OCCURRED. ANY INEFFECTIVE OR IMPROPERLY INSTALLED BMP'S SHALL BE BEGIN REPAIR/REPLACEMENT WITHIN 24 HOURS AND COMPLETION WITHIN 7 DAYS OF OBSERVATION.

WATERS RECEIVING STORM WATER DISCHARGES

UN-NAMED GULF COURSE, PER USGS 7.5 MINUTE QUADRANGLE MAP, PARADISE VALLEY, ARIZONA. THERE ARE NO THREATENED OR ENDANGERED SPECIES OR CRITICAL HABITATS ON OR IMMEDIATELY ADJACENT TO THE SITE.

NOTICE OF INTENT

CONSTRUCTION OF IMPROVEMENT FOR THIS PROJECT WILL DISTURB MORE THAN 1 ACRE AND IS THEREFORE REQUIRED TO OBTAIN AN AZPDES PERMIT. THE GENERAL CONTRACTOR IS RESPONSIBLE FOR FILING NOI, NOT, AND FOR DEVELOPING, FILING, AND UPDATING THE STORM WATER MANAGEMENT PLAN (SWMP) FOR THIS PROJECT.

OPERATOR CONTROL

THE OPERATOR OF THIS SWPPP SHALL BE THE CONTRACTOR SELECTED BY THE RESPONSIBLE FOR THE INSTALLATION, MAINTENANCE AND OPERATION OF THIS SWPPP

OWNER. THE GENERAL CONTRACTOR SELECTED BY THE OWNER SHALL BE AND THE BMP'S USED HEREON.

BASE FLOOD ELEVATION COUNTY PANEL # DATE OF FIRM COMMUNITY SUFFIX (IN AE ZONE USE DEPTH) NUMBER PANEL DATE (INDEX DATE) NUMBER ZONE NONE, < 1'1770 OCTOBER 16, 2013 , SHADED ZONE

SEQUENCE OF CONSTRUCTION

- INSTALL STABILIZED CONSTRUCTION ENTRANCES. (BMP EC-5) (BMP EC-7) 2. PREPARE TEMPORARY PARKING AND STORAGE AREA. (BMP EC-7) (BMP GH-1)
- 3. CONSTRUCT SILT FENCE ON THE SITE. (BMP EC-7) (BMP SPC-5)
- 4. CONSTRUCT DIVERSION DIKES, AND SEDIMENTATION BASINS/TRAPS. (BMP EC-9) (BMP EC-7) (BMP SPC-9)5. DO NOT CLÉAR AND GRUB THE ENTIRE SITE ALL AT ONCE. CLEAR AND GRUB AS
- CONSTRUCTION ACTIVITIES REQUIRE. (BMP EC-7) (BMP GH-3) 6. START CONSTRUCTION OF BUILDING PAD AND STRUCTURES. (BMP EC-7) (BMP
- 7. BEGIN GRADING THE SITE. (BMP EC-7)
- 8. INSTALL UTILITIES, UNDERDRAINS, STORM SEWERS, CURBS AND GUTTERS. (BMP EC-7)
- 9. INSTALL INLET PROTECTION AROUND ALL STORM SEWER STRUCTURES. (BMP
- 10. PREPARE SITE FOR PAVING. (BMP EC-7)
- 11. PAVE SITE. (BMP EC-7)
- 12. REINSTALL INLET PROTECTION DEVICES. (BMP SPC-7)
- 13. COMPLETE GRADING AND INSTALL PERMANENT STABILIZATION AND PLANTINGS.
- 14. REMOVE ALL TEMPORARY EROSION AND SEDIMENT CONTROL DEVICES (ONLY IF SITE IS STABILIZED).

STORM WATER POLLUTION PREVENTION PLAN POSTING

THE CONTRACTOR SHALL RETAIN A COPY OF THE STORM WATER POLLUTION PREVENTION PLAN IN THE ON-SITE JOB TRAILER AT ALL TIMES. IN ADDITION THE CONTRACTOR SHALL POST A SIGN AT THE MAIN ENTRANCE CONTAINING THE AZPDES AUTHORIZATION NUMBER (OR COPY OF NOLAUTHORIZATION). CONSTRUCTION SITE CONTACT NAME AND TELEPHONE NUMBER. BRIEF PROJECT DESCRIPTION. AND THE LOCATION OF STORM WATER MANAGEMENT PLAN.

STABILIZATION EFFORTS

SITE STORM WATER SHALL BE ROUTED TO MULTIPLE SEDIMENT TRAPS THROUGH OVERLAND FLOW AND DIVERSION DIKES TO CAPTURE SEDIMENT AND LIMIT RUNOFF AND THE DISCHARGE OF POLLUTANTS. SILT FENCES SHALL BE PLACED DOWNSTREAM FROM THE SEDIMENT TRAPS TO ELIMINATE ANY POTENTIAL DISCHARGE OF SEDIMENT AND POLLUTANTS FROM THE SEDIMENT TRAPS.

SEDIMENT TRAPS ARE LOCATED THROUGHOUT THE SITE AND PROVIDE 2000 CY OF STORAGE PER ACRE DISTURBED. SEE CALCULATIONS FOR DRAINAGE AREAS AND TRAP SIZE. EACH SEDIMENT TRAP SHALL INCLUDE A ROCK OUTFALL TO DISSIPATE

STORM WATER VELOCITY AT OUTFALL LOCATIONS. **GENERAL PERMIT REQUIREMENTS**

THIS STORM WATER POLLUTION PREVENTION PLAN IS CONSISTENT WITH THE AZPDES CONSTRUCTION GENERAL PERMIT.

SOURCES OF POTENTIAL POLLUTANTS

CONSTRUCTION ACTIVITIES: GRADING, EXCAVATION, CLEARING, GRUBBING, DEMOLITION. CONSTRUCTION EQUIPMENT: FUEL, OIL GREASE, ETC. LITTER: CONSTRUCTION CHEMICALS, CONCRETE, MASONRY, CEMENT, ETC.

STORM WATER POLLUTION PREVENTION PLAN MODIFICATIONS THIS STORM WATER POLLUTION PREVENTION PLAN SHALL BE MODIFIED BY THE

CONTRACTOR AS NEEDED WITHIN 15 BUSINESS DAYS AFTER ANY CHANGE IN DESIGN, CONSTRUCTION, OPERATION OR MAINTENANCE AT THE SITE THAT HAS SIGNIFICANT EFFECT ON THE DISCHARGE OR NOT PREVIOUSLY ADDRESSED IN THE SWPPP.

IF THE CURRENT STORM WATER POLLUTION PREVENTION PLAN IS DETERMINED TO BE INEFFECTIVE, THE CONTRACTOR SHALL REVISE THE PLAN APPROPRIATELY TO MITIGATE DISCHARGE AND WATER QUALITY EXCEEDENCES WITHIN 15 BUSINESS DAYS. OTHER CONTROLS

WASTE DISPOSAL:

ALL SOLID WASTE SHALL BE STORED IN A SECURED DUMPSTER. THE DUMPSTER SHALL MEET ALL STATE AND LOCAL WASTE MANAGEMENT REGULATIONS. THE DUMPSTER SHALL BE EMPTIED AS NEEDED. NO CONSTRUCTION MATERIALS WILL BE BURIED

ALL HAZARDOUS WASTE SHALL BE DISPOSED OF IN A MANNER AS SPECIFIED BY THE MANUFACTURER AND STATE AND LOCAL REGULATIONS.

ALL SANITARY WASTES WILL BE COLLECTED FROM PORTABLE UNITS AS NEEDED.

DESIGNATED WASHOUT AREAS: A WASHOUT AREA SHALL BE CONSTRUCTED FOR THE TEMPORARY COLLECTION OF

EXCESS CONCRETE AND NON-STORMWATER DISCHARGES FROM VEHICLE WASHING. CONCRETE SHALL BE REMOVED FROM THE SITE AND TRANSPORTED TO A LOCAL LANDFILL AS NEEDED.

OFF-SITE TRACKING:

A STABILIZED CONSTRUCTION ENTRANCE WILL BE CONSTRUCTED TO REDUCE VEHICLE TRACKING OF SEDIMENTS INTO THE PUBLIC RIGHT-OF-WAY. THE PAVED STREETS ADJACENT TO THE SITE WILL BE INSPECTED AND SWEPT AS NEEDED TO REMOVE

DUST CONTROL:

A DUST CONTROL PERMIT MUST BE OBTAINED FROM MARICOPA COUNTY AIR QUALITY DEPARTMENT PRIOR TO COMMENCEMENT OF WORK.

RECORD MAINTENANCE

INSPECTION RECORDS SHALL BE KEPT ON SITE AT THE JOB TRAILER AT ALL TIMES. EACH INSPECTION SHALL REQUIRE AN INSPECTION FORM TO BE FILLED OUT AND SIGNED BY THE INSPECTOR.

THE CONTRACTOR SHALL KEEP RECORDS OF ALL CONSTRUCTION ACTIVITIES ON SITE THE RECORDS SHALL INCLUDE START AND END DATES FOR ALL MAJOR CONSTRUCTION ACTIVITIES INVOLVING GRADING. THE CONTRACTOR SHALL ALSO MAKE RECORD OF WHEN STABILIZATION IS INITIATED AND COMPLETED AND ANY REASON FOR DELAYS.

ALL INSPECTION RECORDS SHALL BE MAINTAINED BY THE CONTRACTOR FOR AT LEAST 3 YEARS AFTER CONSTRUCTION IS COMPLETED.

HOUSEKEEPING (SPILL PREVENTION)

GENERAL SUBSTANCES USED ONSITE INCLUDE: GREASE, GASOLINE, CONCRETE, LUMBER, ASPHALT, PAINTS, BUILDING CONSTRUCTION MATERIALS, FERTILIZERS, AND PESTICIDES.

ANY RELEASE OF A MATERIAL IN EXCESS OF A REPORTABLE QUANTITY WILL BE REPORTED PER FEDERAL REGULATIONS. ALL MATERIALS STORED ONSITE WILL BE STORED IN A NEAT, ORDERLY MANNER AND IN THE ORIGINAL CONTAINERS. ALL MANUFACTURER'S RECOMMENDATIONS FOR SPILL PREVENTION, CONTAINMENT, CLEAN-UP, AND DISPOSAL SHALL BE FOLLOWED.

GOOD HOUSEKEEPING:

THE CONTRACTOR SHALL EMPLOY GOOD HOUSEKEEPING METHODS AND MANUFACTURER'S RECOMMENDATIONS IN THE USE, STORAGE, AND DISPOSAL OF ALL MATERIALS TO BE USED ON SITE.

TIMING OF CONTROLS/MEASURES

THE SILT FENCES/ORGANIC FILTER BARRIERS AND SEDIMENT TRAPS SHALL BE INSTALLED ON SITE PRIOR TO COMMENCEMENT OF CLEARING AND GRUBBING FOR CONSTRUCTION ACTIVITIES. AREAS WHERE CONSTRUCTION ACTIVITIES CEASE FOR MORE THAN 14 DAYS SHALL BE STABILIZED WITH A TEMPORARY MEASURE. ONCE CONSTRUCTION ACTIVITY CEASES PERMANENTLY IN AN AREA, THAT AREA SHALL BE STABILIZED WITH PERMANENT LANDSCAPING AND OR PAVEMENT. AFTER THE ENTIRE SITE IS STABILIZED THE SEDIMENT ACCUMULATED IN THE SEDIMENT TRAP(S) WILL BE REMOVED AND ANY DIVERSION DIKE(S) WILL BE REMOVED.

HYDROLOGICAL INFORMATION

CONSTRUCTION ACTIVITY DESCRIPTION: CONSTRUCTION OF COMMERCIAL SITE

| LAND USE | <u>AREA</u> | <u>C-VALUE</u> |
|------------------------------------|-------------|----------------|
| AREA TO BE DISTURBED | 1.59 AC± | |
| AREA TO BE PAVED | 1.29 AC± | 0.95 |
| AREA TO BE ROOFED | 0.00 AC± | 0.95 |
| AREA TO BE SOD/SEED | 0.00 AC | 0.30 |
| AREA TO BE DUSTPROOFED/STABILIZED | 0.30 AC± | 0.45 |
| RUNOFF COEFFICIENT BEFORE CONSTRUC | CTION | 0.86 |
| RUNOFF COEFFICIENT AFTER CONSTRUCT | TON | 0.86 |


- 1. THIS PLAN IS FOR THE DURATION OF CONSTRUCTION ONLY. CONTRACTOR SHALL SUBMIT NOTICE OF TERMINATION PERMIT UPON COMPLETION OF THE PROJECT (FINAL STABILIZATION).
- 2. ALL NECESSARY INSPECTIONS AND/OR CERTIFICATIONS REQUIRED BY CODES AND/OR UTILITY SERVICE COMPANIES SHALL BE PERFORMED PRIOR TO ANNOUNCED CERTIFICATE OF COMPLETION.
- 3. NO DRY WELLS, WATER BODIES, OR ENVIRONMENTALLY SENSITIVE AREAS EXIST



MICHAEL L. DELMARTER

PROJECT NO. 191166007

OF 11

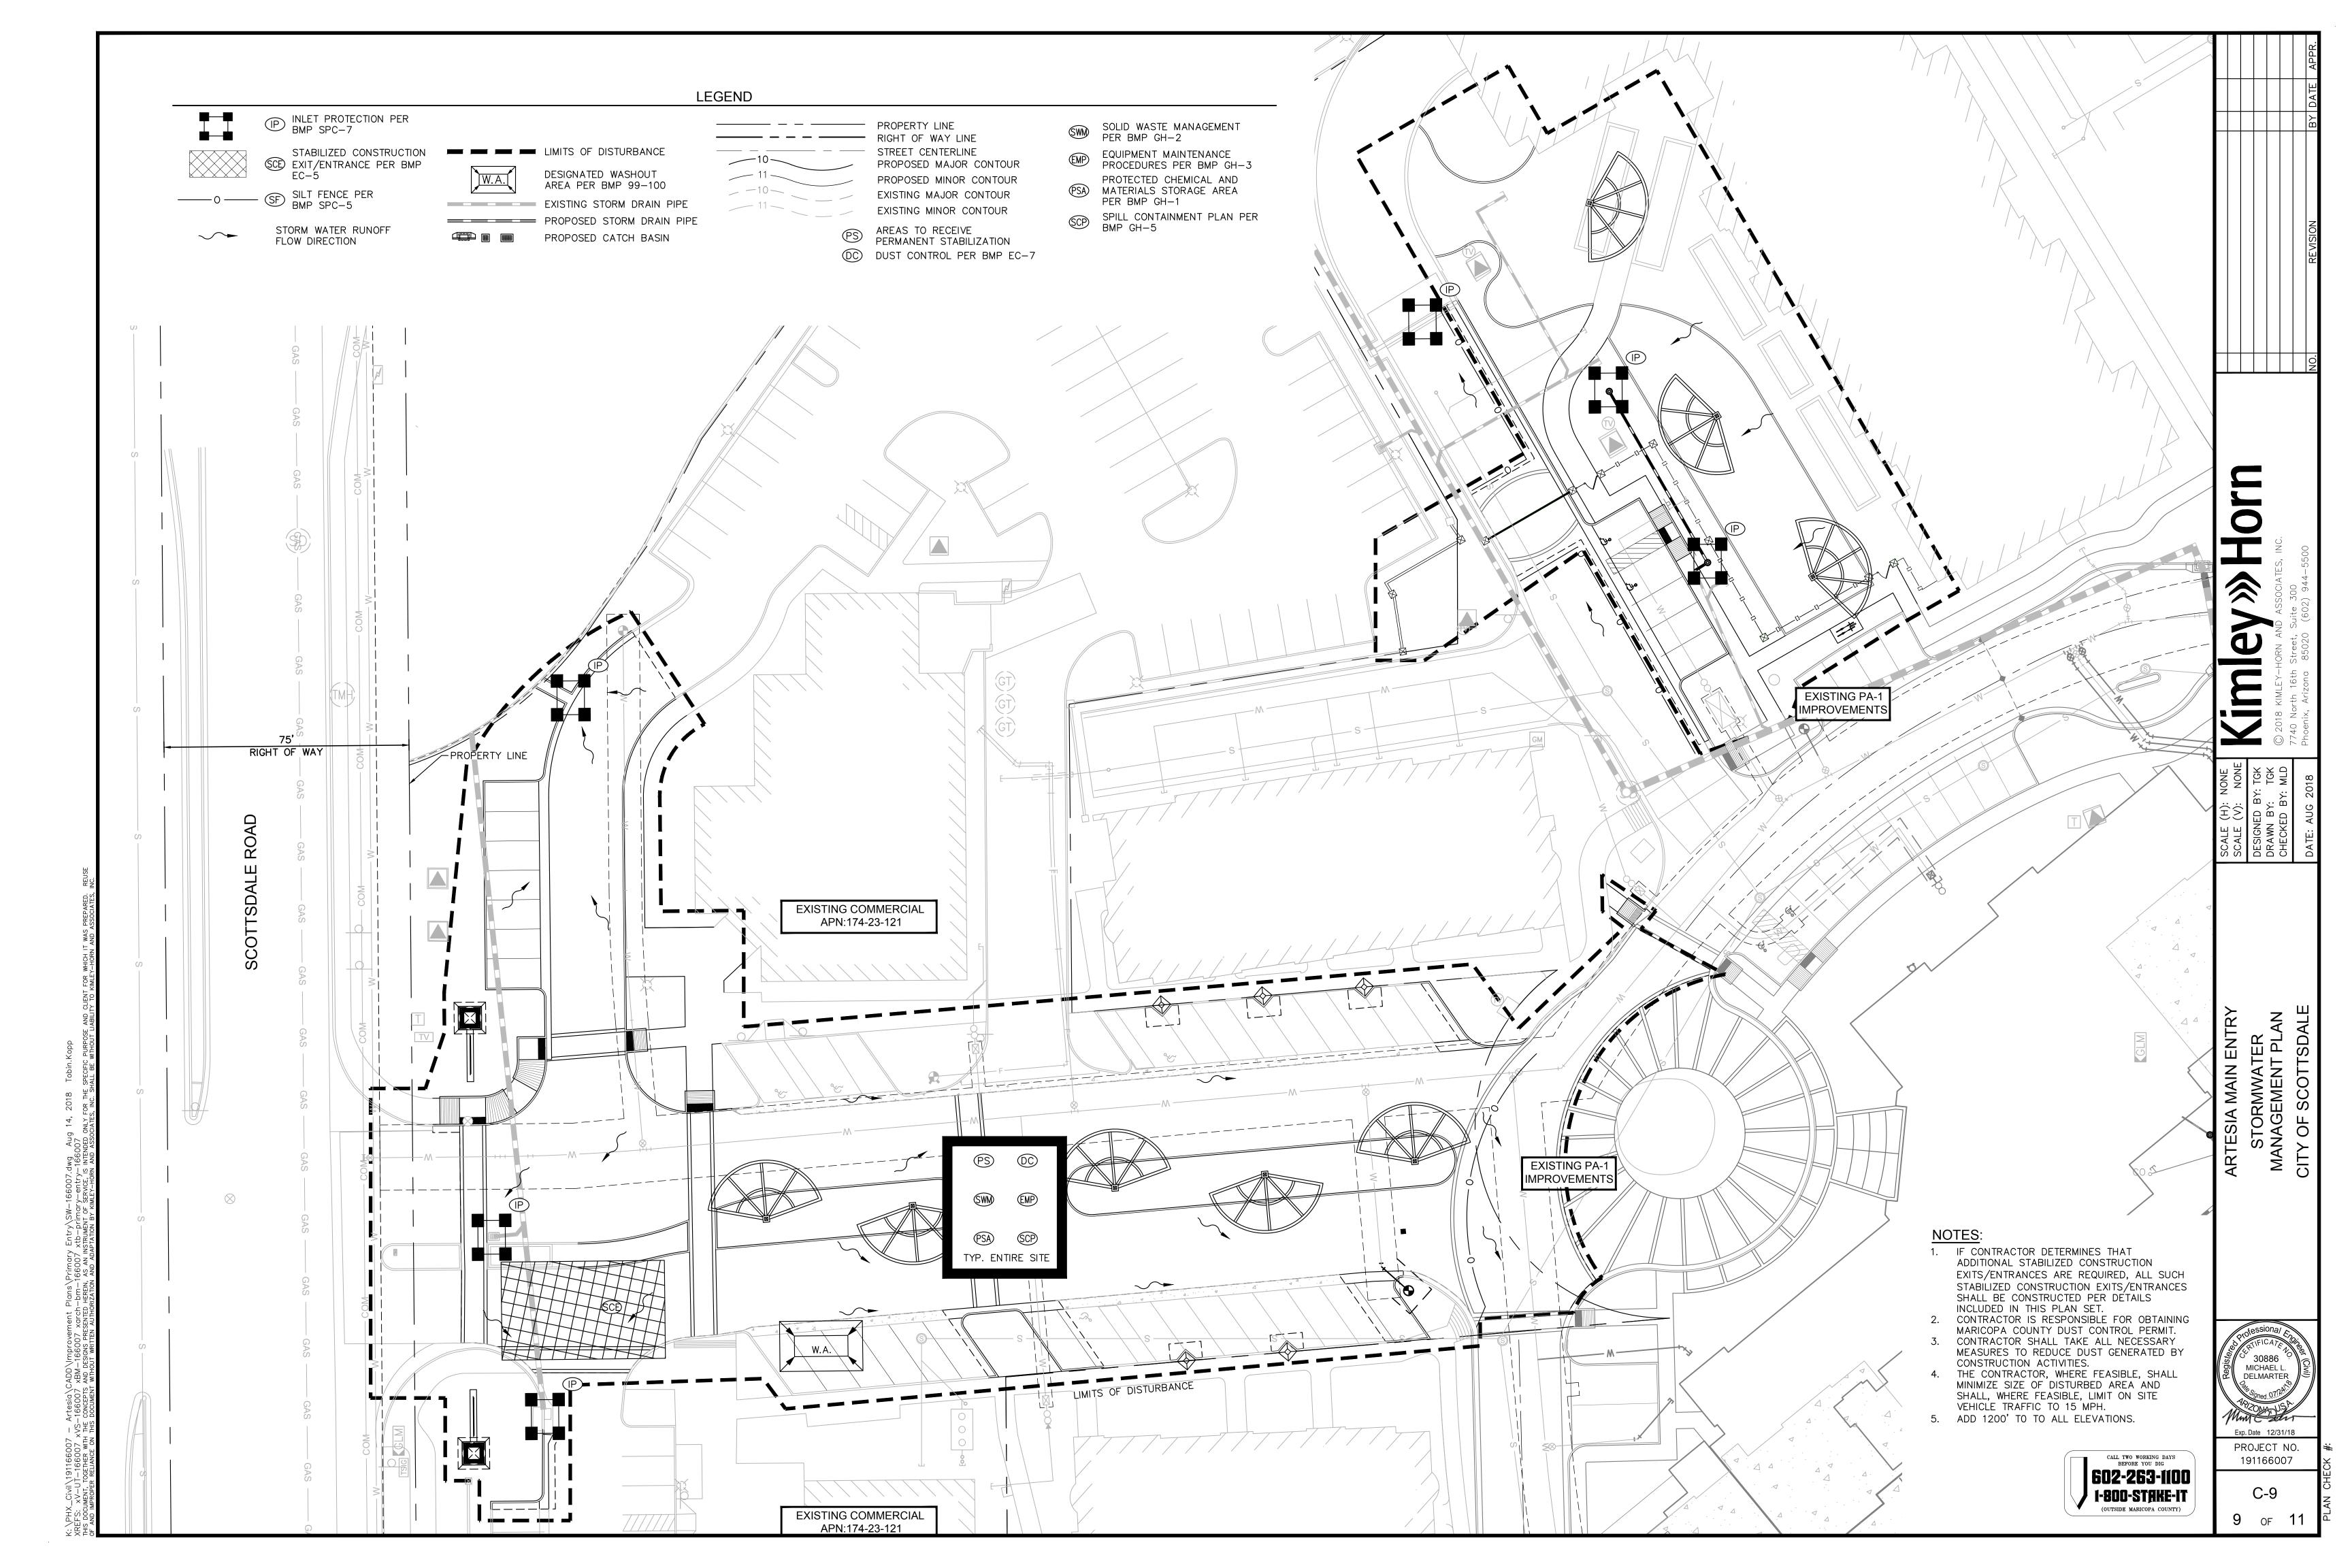

EC-5: Stabilized Construction Entrance

DEFINITION

A stabilized pad of aggregate underlain with filter cloth located at any point where traffic will be entering or exiting a construction site to or from a public right-of-way, street, alley, sidewalk or parking area. For added effectiveness, a wheel wash or wash rack area can be incorporated into the design to further reduce sediment tracking.

| | GENERAL INFORMATION |
|---|--|
| I | Applicability - Effectiveness Perimeter and Access Controls - high |
| Γ | Most effective when used with: |
| 1 | MOSt effective when asea with. |
| | EC-6 Construction Road Stabilization |

GH-6 Road Sweeping/Trackout Cleaning

GH-4 Designated Washdown Areas - wheel

wash is especially useful with clay soils.

| RATINGS | | | |
|---------------------------|---|---|---|
| Associated Costs | Н | M | L |
| Implementation | | Х | |
| Maintenance | | Х | |
| Training | | | Х |
| Target Pollutants Removal | Н | М | L |
| Oil and Grease | | | Х |
| Nutrients | | | Х |
| Sediment | | Х | |
| Floatable Material | | | Х |
| Metals | | Х | |
| Other Construction Waste | | | Х |

| FIGURES |
|--|
| Photos/Sketches |
| Stabilized Construction Entrance Photos |
| CAD Drawings |
| Stabilized Construction Entrance Drawing |
| |


Erosion Control -5 Page 1 of 6

5-39

Erosion Control: Best Management Practices

Stabilized Construction Entrance EC-5 **Drawing**

Drainage Design Manual for Maricopa County

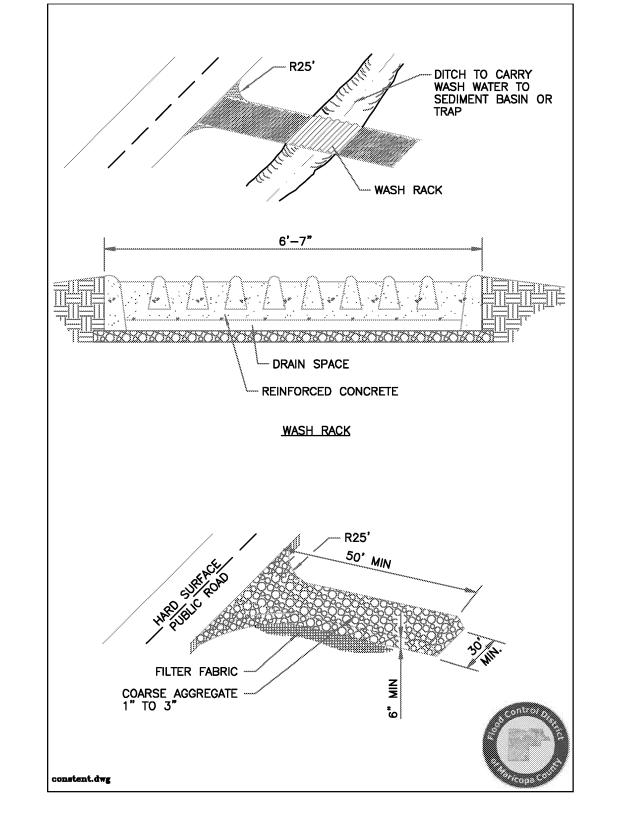

Erosion Control - 5 5-44 Page 6 of 6

August 15, 2013

Erosion Control: Best Management Practices

Erosion Control: Best Management Practices

Drainage Design Manual for Maricopa County

EC-7

EC-7: Dust Control

DEFINITION

<u>Revegetation</u>

A comprehensive plan to limit offsite sediment depression by minimizing or controlling airborne fugitive dust.

| GENERAL INFORMATION |
|--|
| Applicability - Effectiveness Perimeter and Access Controls - high |
| Most effective when used with: |
| EC-5 Stabilized Construction Entrance |
| EC-6 Construction Road Stabilization |
| GH-6 Road Sweeping/Trackout Cleaning |
| Alternative BMPs: |
| For long term dust control, consider <u>SPC</u> |

| RATINGS | | | |
|---------------------------|---|---|---|
| Associated Costs | Н | М | L |
| Implementation | | | Х |
| Maintenance | Х | | |
| Training | | | Х |
| Target Pollutants Removal | Н | М | L |
| Oil and Grease | | | Х |
| Nutrients | | | Х |
| Sediment | Х | | |
| Floatable Material | | | Х |
| Metals | | Х | |
| Other Construction Waste | | | Х |

Erosion Control: Best Management Practices

| FIGURES |
|---------------------------------|
| Photos/Sketches |
| EC-7 Dust Control Photos |
| Tables |
| Commonly Used Dust Suppressants |

August 15, 2013

Erosion Control - 7 Page 1 of 7

5-51

Drainage Design Manual for Maricopa County Erosion Control: Best Management Practices **EC-7** Dust Control Table **TABLE 5.2** COMMONLY USED DUST SUPPRESSANTS **Functional** Limitations **Advantages** Mechanism Frequent light applications may be necessar Moisture wets particles, during hot dry weather and can be labor Usually readily available, low material cost, thereby increasing their mass intensive. Over application may result in los and binding them together. of traction, erosion, or points of road failure.

Drainage Design Manual for Maricopa County Erosion Control: Best Management Practices Dust Control Table **TABLE 5.2** COMMONLY USED DUST SUPPRESSANTS (CONTINUED) **Relative Cost** Comparison **Environmental** Characteristics (average life Considerations expectancy) Minimal environmental hazard. If applied Low initial cost, high longexcessively, may result in erosion and

term maintenance cost (0

sediment runoff. Supply may be limited in some areas and, depending on the source, may require a water right permit.

Freshwater

PROJECT NO. 191166007

C-10

Drainage Design Manual for Maricopa County

GH-2

GH-2: Solid Waste Management

August 15, 2013

The routine collection, recycling, and disposal of accumulated solid waste generated at the con-

| Applicability - Effectiveness Debris Management, Cleanup, and Wash - moderate Trash Collection/Management - high |
|--|
| Most effective when used with: |
| GH-1: Chemical Management |
| GH-3: Equipment Maintenance Procedur |
| GH-5: Spill Containment Plan |
| Alternative BMPs: |
| None |

| RATINGS | | | |
|----------------------------|-----|---|---|
| Associated Costs | Н | М | L |
| Implementation | | Х | |
| Maintenance | | Х | |
| Training | | Х | |
| Target Pollutants Removal | Н | М | L |
| Oil and Grease | | | Х |
| Nutrients | | Х | |
| Sediment | | | Х |
| | ١., | | |
| Floatable Material | X | | |
| Floatable Material Metals | X | | |

| FIGURES | |
|-------------------------------|--|
| Photos/Sketches | |
| Solid Waste Management Photos | |
| CAD Drawings | |
| None | |

General Housekeeping - 2 August 15, 2013 5-173 Page 1 of 6

GH-4 **Areas**

Drainage Design Manual for Maricopa County

GH-4: Designated Washdown

DEFINITION

Procedures and practices that are designed to minimize or eliminate the discharge of concrete waste materials to the storm drain systems of watercourses.

| GENERAL INFORMATION |
|--|
| Applicability - Effectiveness Inlet Drain Protection - high Debris Management, Cleanup, and Washout - high |
| Most effective when used with: |
| GH-1: Chemical Management |
| GH-3: Equipment Maintenance Procedures |
| GH-5: Spill Containment Plan |
| Alternative BMPs: |
| None |

| Associated Costs | Н | М | L |
|---------------------------|---|---|---|
| Implementation | | Х | |
| Maintenance | | Х | |
| Training | | Х | |
| Target Pollutants Removal | Н | M | L |
| Oil and Grease | | Х | |
| Nutrients | | | Х |
| Sediment | | | Х |
| Floatable Material | | | Х |
| Metals | | Х | |
| Other Construction Waste | Х | | |

| FIGURES |
|---------------------------------------|
| Photos/Sketches |
| GH-4 Designated Washdown Areas Photos |
| CAD Drawings |
| None |

General Housekeeping - 4 5-183 Page 1 of 5

SPC-5 SPC-5: Silt Fence **DEFINITION** A geotextile fabric stretched between either wooden or metal posts with the lower edge of the fabric securely embedded in the soil. The fence is typically located downstream of disturbed areas to intercept sheet flow runoff.

| GENERAL INFORMATION | RATINGS | | | |
|--|---------------------------|---|---|----------|
| Applicability - Effectiveness | Associated Costs | Н | М | L |
| Slope Protection - moderate Excavated Areas (trenches, pits, etc.) - high | Implementation | | Х | |
| Perimeter and Access Controls - high | Maintenance | Х | | |
| Most effective when used with: | Training | | | Х |
| An Erosion Control (EC) BMP | Target Pollutants Removal | Н | М | L |
| Alternative BMPs: | Oil and Grease | | | Х |
| EC-9: Diversion Dikes | Nutrients | | | Х |
| SPC-1: Organic Filter Barrier | Sediment | | Х | |
| SPC-2: Sand Bag Barrier | Floatable Material | Х | | |
| SPC-3: Gravel Filter Berms | Metals | | | Х |
| SPC-6: Revegetation | Other Construction Waste | | Х | |
| SPC-7: Storm Drain Inlet Protection | | I | 1 | <u> </u> |
| | FIGURES | | | |

| FIGURES | |
|--------------------|--|
| Photos/Sketches | |
| Silt Fence Photos | |
| CAD Drawings | |
| Silt Fence Drawing | |

Sediment and Pollutant Control - 5 5-121 Page 1 of 8

DEFINITION

GENERAL INFORMATION


August 15, 2013


August 15, 2013


CALL TWO WORKING DAYS BEFORE YOU DIG 602-263-1100


1-800-STAKE-IT

10 of 11

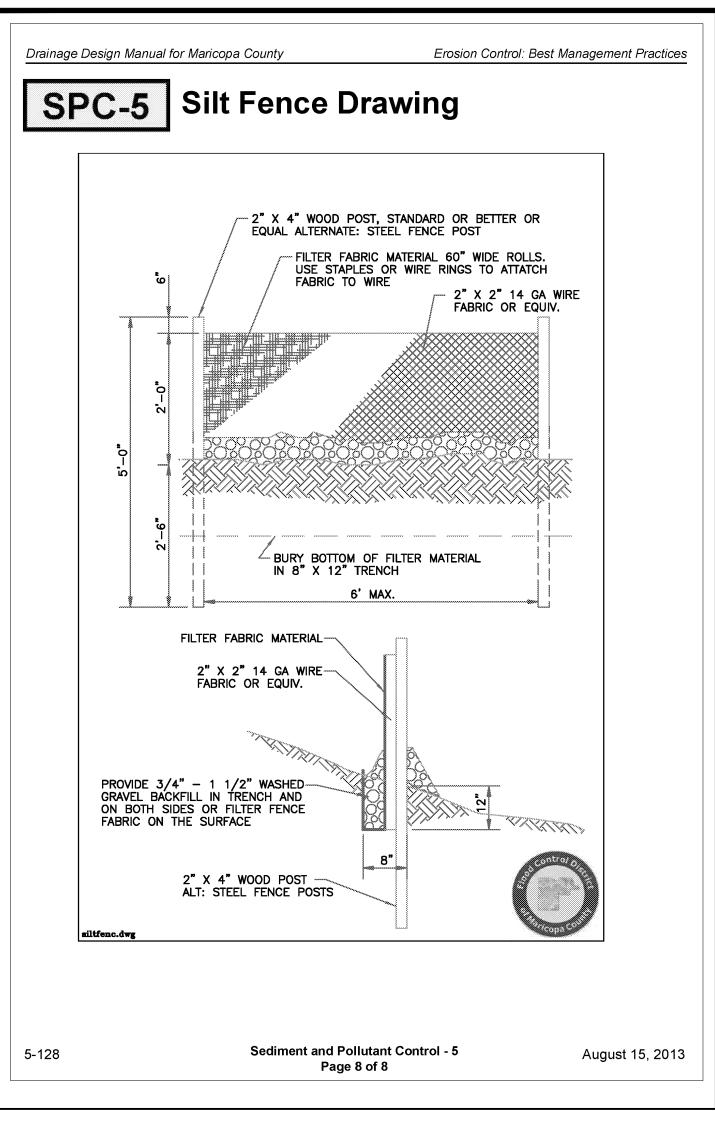

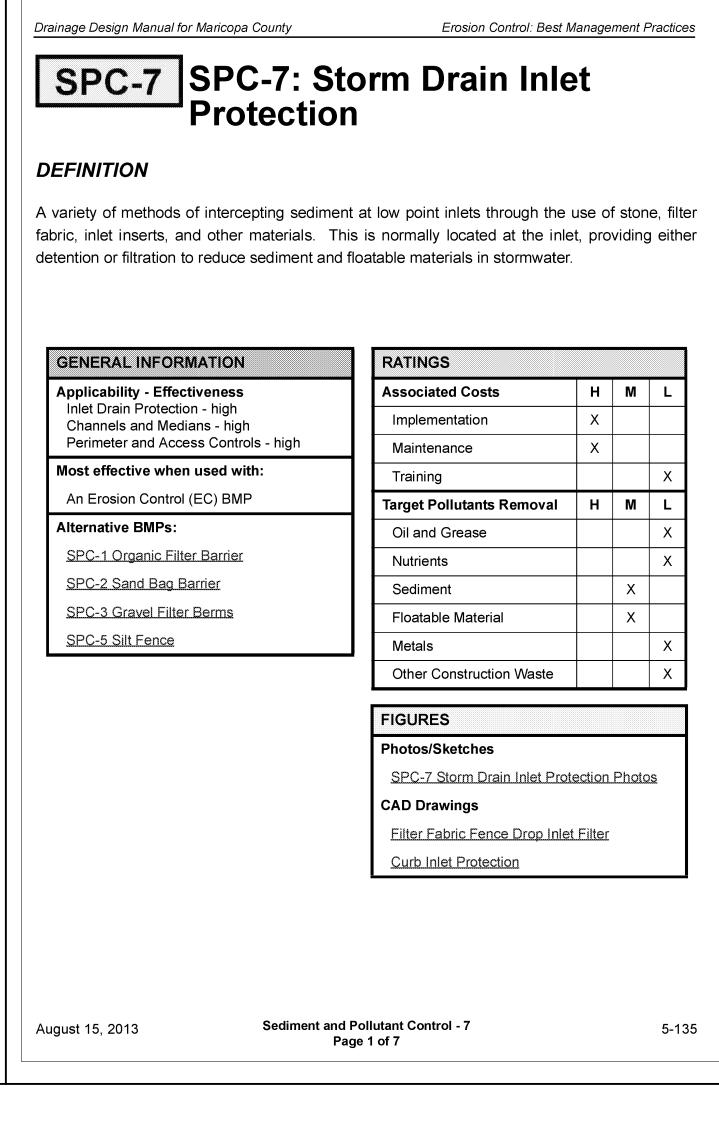

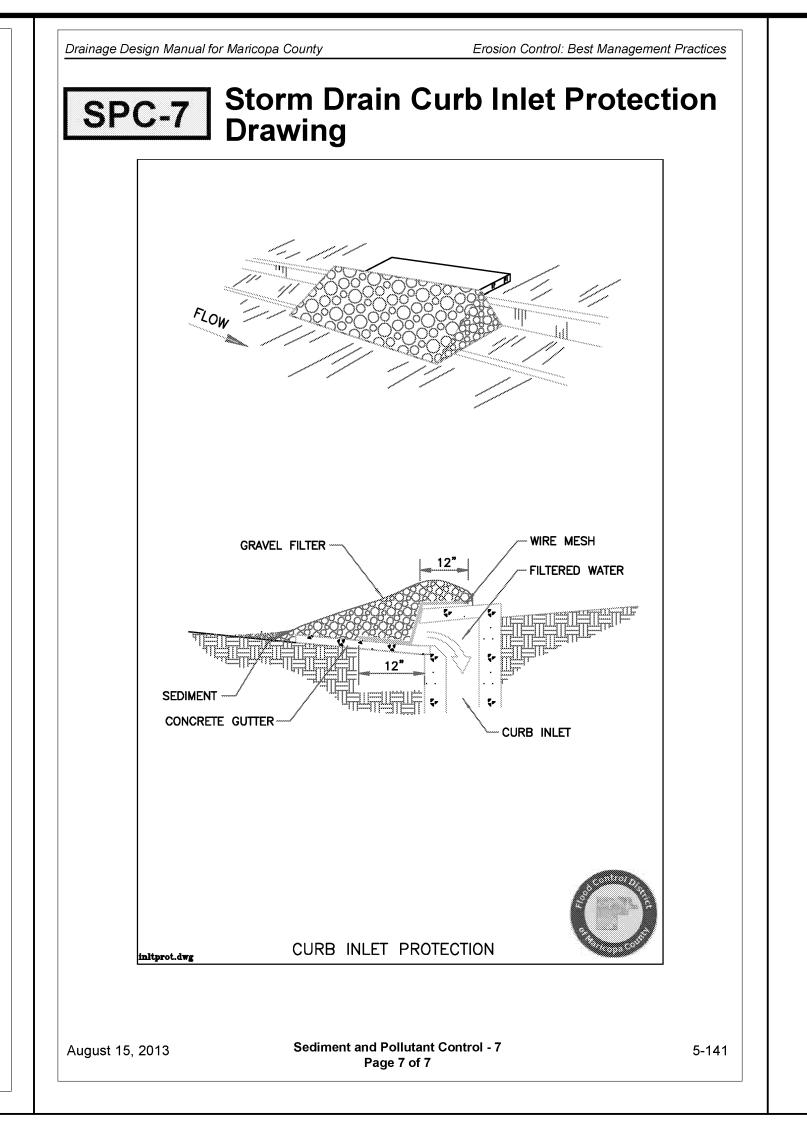

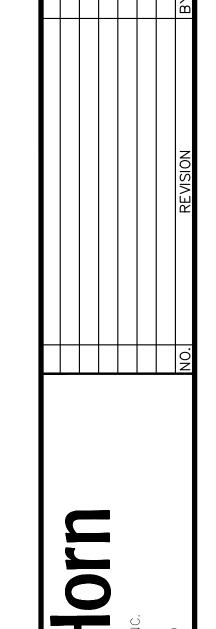

Exp. Date 12/31/18
PROJECT NO.
191166007

11 of 11

CALL TWO WORKING DAYS
BEFORE YOU DIG

602-263-1100
1-800-STAKE-IT
(OUTSIDE MARICOPA COUNTY)



BGA Bucilla Group Architecture

ARCHITECTURE | PLANNING | URBAN DESIGN | INTERIOR DESIGN


Bucilla Group Architecture 19782 Mac Arthur Blvd., Suite 270 Irvine, CA 92612 Phone: 949-851-9080 www.bg-architecture.com Antesia

Main Entry Drive - Illustrative Master Plan

Scottsdale Road & Indian Bend Road
Scottsdale, AZ | August 10, 2018

0 20 40 60 100
Scale: 1" = 20'-0" @ 30"x42"



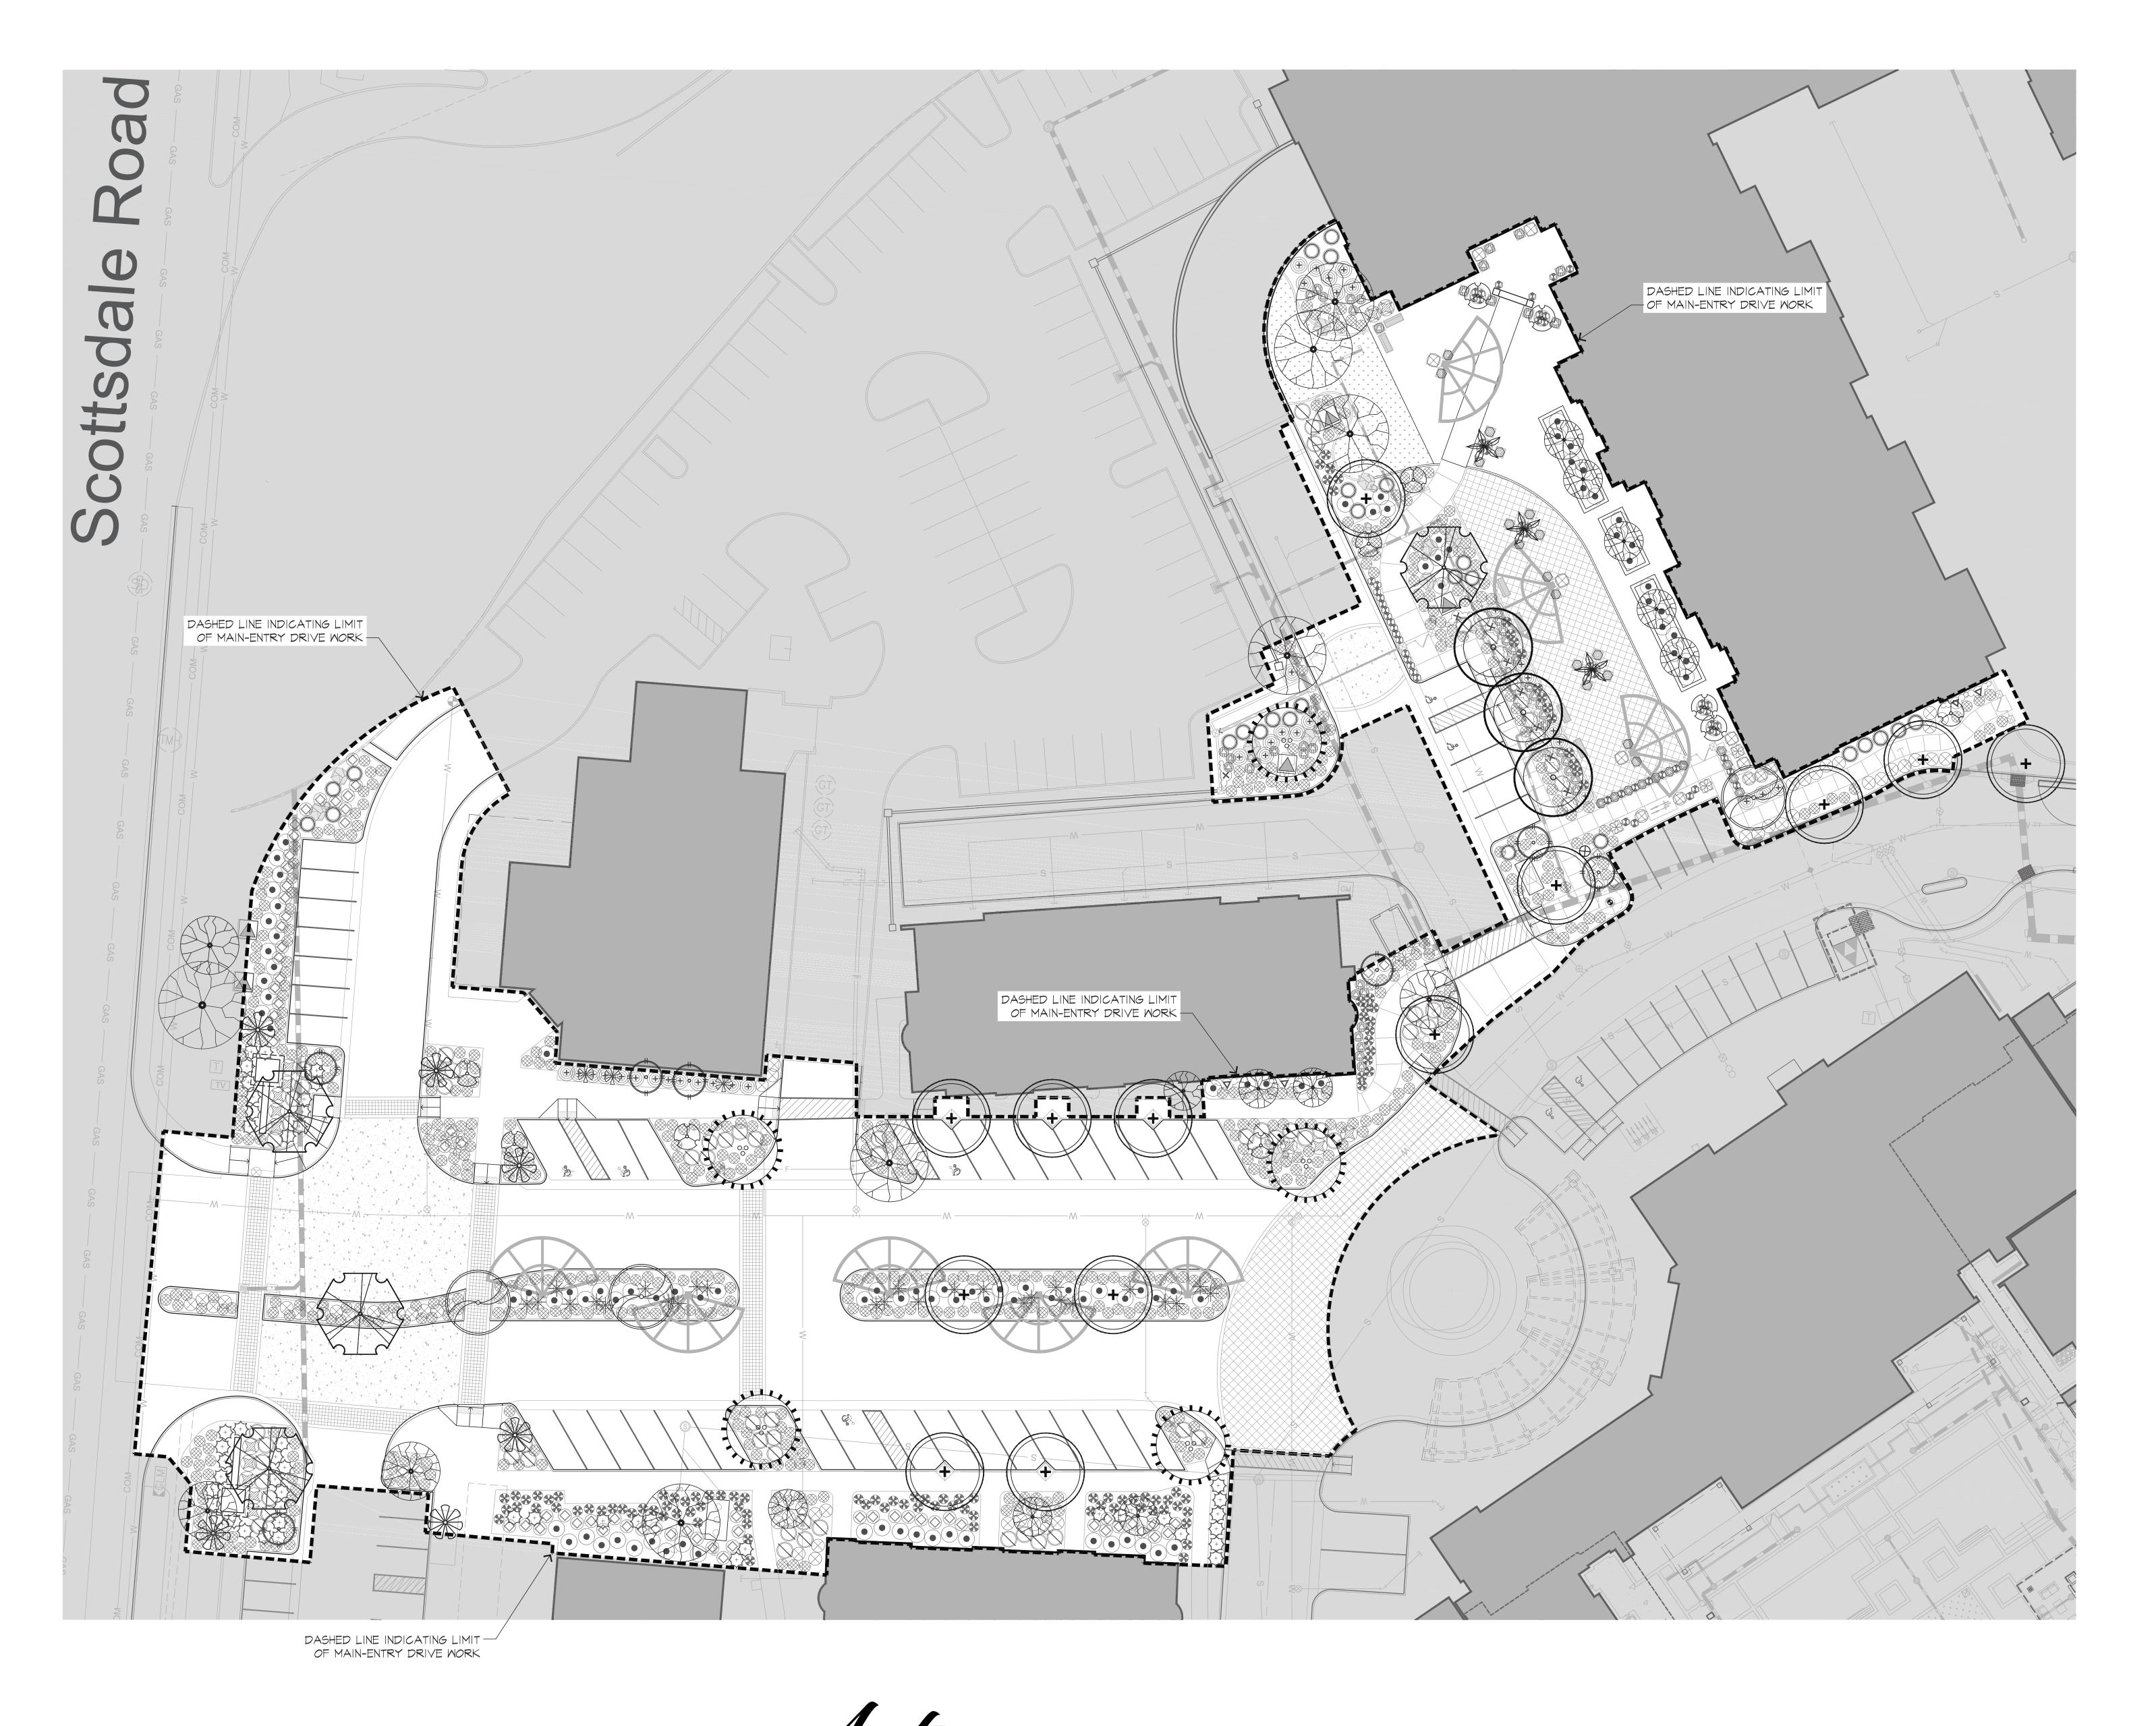

BGA Bucilla Group Architecture

ARCHITECTURE | PLANNING | URBAN DESIGN | INTERIOR DESIGN

Bucilla Group Architecture 19782 Mac Arthur Blvd., Suite 270 Irvine, CA 92612 Phone: 949-851-9080 www.bg-architecture.com Main Entry Drive - Conceptual Landscape Plan

Eviewed by any municipal entity and relevant documents, surveys, covenants, easements, etc. may not have been provided which can impact the design, yield and layout. The depiction herein may reflect building sizes, designs, yields, amenities, roadways, and improvements, etc., some or hange without notice.





NOTES

Synthetic Lawn 1,400 s.f.
PIONEER 'DARBY' TURF

Decomposed Granite 1/2" SCREENED 21,968 s.f.
COLOR: 'DESERT GOLD'

OTHER LANDSCAPE MATERIAL NOTES

PLANTING LEGEND

Bauhinia congesta

FEATHER BUSH

Olneya tesota

Ulmus parvifolia CHINESE ELM

HERITAGE LIVE OAK

Sophora secundiflora
TEXAS MOUNTAIN LAUREL

Existing Tree to Remain

PALM TREES

DATE PALM

FAN PALM

Phoenix dactylifera

Washingtonia robusta

Existing Palm to Remain

SHRUBS & ACCENTS

Caesalpinia pulcherrima

RED BIRD OF PARADISE

DWARF BOTTLEBRUSH
Carissa grandiflora

Chamaerops humilis

MEDITERRANEAN FAN PALM

Leucophyllum frutescens

Myrtus communis 'Compacta'

GREEN CLOUD SAGE Muhlenbergia rigens

Hesperaloe parviflora 'Brakelights'

NATAL PLUM

Euphorbia rigida

SILVER SPURGE

RED YUCCA

DEER GRASS

DWARF MYRTLE
Portulacaria afra

ELEPHANT FOOD
Ruellia peninsularis

DESERT RUELLIA

BOUGAINVILLEA

GROUNDCOVER

Lantana camara 'Gold Mound'

GOLD MOUND LANTANA

Convolvulus cneorum
BUSH MORNING GLORY

Callistemon viminalis x 'Little John'

Agave attenuata FOXTAIL AGAVE

IRONWOOD

WHITE ORCHID TREE

Cercidium x "Desert Museum"

Lysiloma microphylla v. thornberi STANDARD TRUNK 36" BOX 7

DESERT MUSEUM PALO VERDE

Quercus virginiana 'Heiritage'

NOTES SIZE QTY

STANDARD TRUNK 36" BOX 3

STANDARD TRUNK 48" BOX 5

STANDARD TRUNK 54" BOX 4

STANDARD TRUNK 36" BOX 3

STANDARD TRUNK 36" BOX 13

STANDARD TRUNK 24" BOX 11

STANDARD TRUNK 18' HT. 6 UNIFORM HEIGHT, CALIPER, PRUNING

STANDARD TRUNK 12' HT. 3 SKINNED

SIZE QTY

SIZE QTY

5 GAL. 49

5 GAL. 26

5 GAL. 72

5 GAL. 50

15 GAL. 9

5 GAL. 29

5 GAL. 27

5 GAL. 67

5 GAL. 36

5 GAL. 65

2 GAL. 61

5 GAL. 103

5 GAL. 15

SIZE QTY

5 GAL. 8

SIZE QTY

1 GAL. 604

1 GAL. 106

QTY

SELECT SPECIMEN

EXISTING

NOTES

EXISTING

NOTES

SYMBOL TREES

COLOR: 'DESERT GOLD'

Small Boulder (~3'-0" DIA.)

COLOR: 'DESERT GOLD'

SUB-GRADE


1/3 MASS
12


COLOR: 'DESERT GOLD'

SUB-GRADE





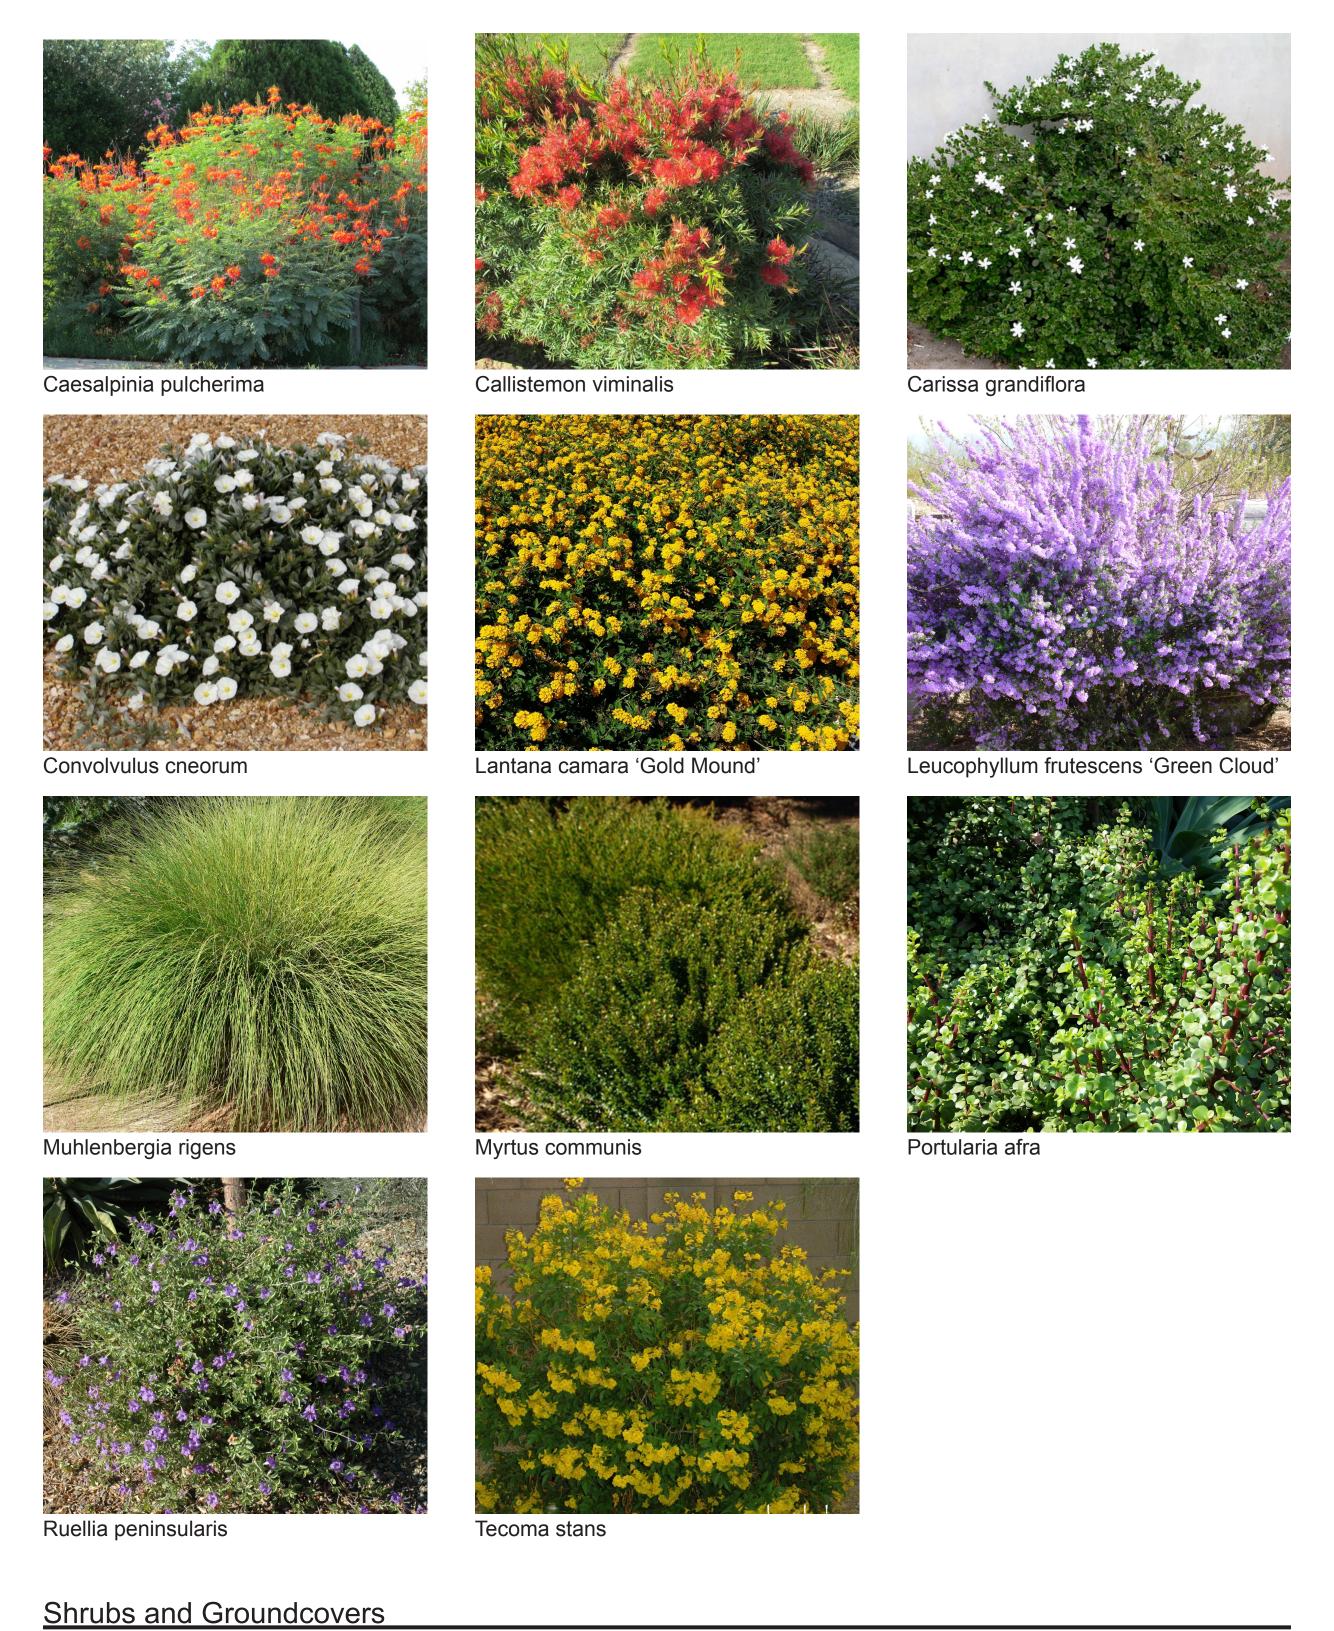

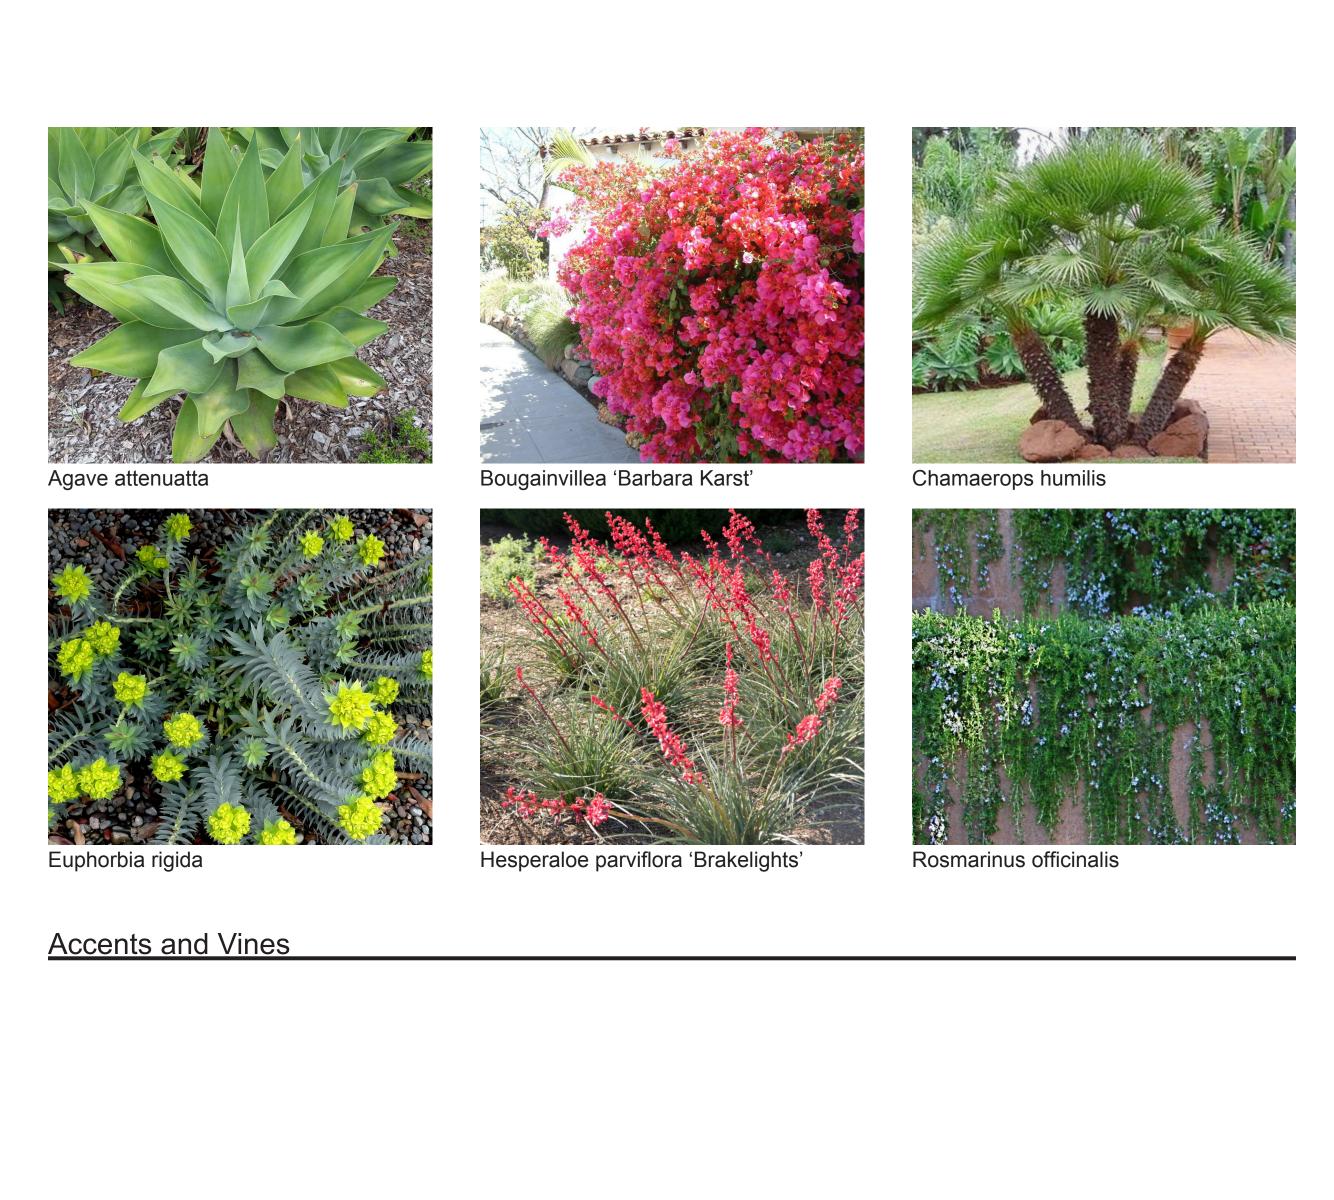







andeaana Matarial

Inert Landscape Material










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Bucilla Group Architecture 19782 Mac Arthur Blvd., Suite 270 Irvine, CA 92612 Phone: 949-851-9080 www.bg-architecture.com





HARDSCAPE KEYNOTES
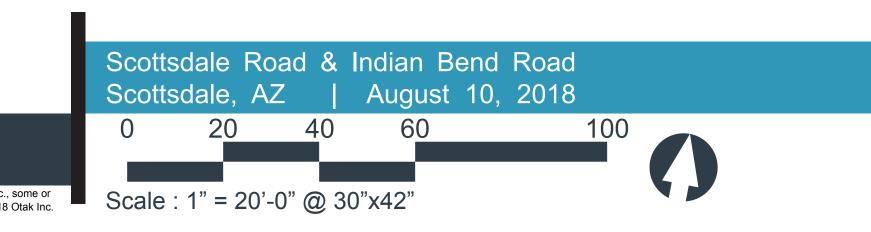
| (x) | EXISTING CONDITIONS / DISCIPLINE REFERENCE | | | |
|---|---|---|--|--|
| KEY | DISCIPLINE | DESCRIPTION | | |
| A.I | ARCHITECT | MONUMENT SIGNAGE | | |
| A.2 | ARCHITECT | SHADE STRUCTURE | | |
| C.5 C.6 | CIVIL ENGINEER CIVIL ENGINEER CIVIL ENGINEER CIVIL ENGINEER | ASPHALT PAVING CROSSWALK STRIPING PARKING STALL - TYPICAL PARKING STALL - ACCESSIBLE | | |
| E.3 E.4 E.5 E.6 E.7 E.8 E.9 E.10 | EXISTING | MAIN ENTRY SCOPE OF WORK BOUNDA VEHICLE RAMP TO GARAGE BELOW VEHICLE RAMP RETAINING WALL GARAGE EXHAUST VENT OPENING BELOW-GRADE STRUCTURE (DASHED L RESIDENTIAL BUILDING RETAIL BUILDING EQUIPMENT SCREEN WALL RAISED PLANTER WALL CURB RAMP PEDESTRIAN PAVING / SIDEWALK ASPHALT PAVING | | |

(IO) PAVING & FLATWORK

| (1.0) | PAVING & | FLATWORK | · |
|-------|----------|----------|------------------------------------|
| KEY | DTL. | SHEET | DESCRIPTION |
| 1.0 | - | - | CONCRETE SIDEWALK - WIDTH PER PLAN |
| 1.1 | - | - | ACCENT PEDESTRIAN PAVERS |
| 1.2 | - | - | ACCENT VEHICULAR PAVERS |
| 1.3 | - | - | ACCENT VEHICULAR PAVING |
| 1.4 | - | - | 6" CONCRETE HEADER |
| 1.5 | - | - | ACCENT TREE GRATE |
| | | | |


2.0 SITE DETAILS


| KEY | DTL. | SHEET | DESCRIPTION |
|-----|------|-------|--------------------------------|
| 2.0 | - | - | 5'-0"H. SECURITY GATE |
| 2.1 | - | - | 5'-0"H. SECURITY FENCE |
| 2.2 | - | - | 6'-0"H. BLOCK COLUMN |
| 2.3 | _ | - | 6'-0"H. BLOCK SITE WALL |
| 2.4 | - | - | VEHICULAR GATE - SLIDING TYPE |
| 2.5 | - | - | PLANTER POTS - LAYOUT PER PLAN |
| 2.6 | - | - | BIKE RACK WITH CONCRETE PAD |
| 2.7 | - | - | PEDESTRIAN BENCH |
| | | | |

3.0 INERT LANDSCAPE MATERIALS KEY DTL. SHEET DESCRIPT


| | D 1 L 1 | 011221 | BECOKE HOL |
|-----|-----------------------|--------|-------------------------------------|
| 3.0 | - | = | ARTIFICIAL TURF |
| 3.1 | - | - | DECOMPOSED GRANITE @ LANDSCAPE AREA |




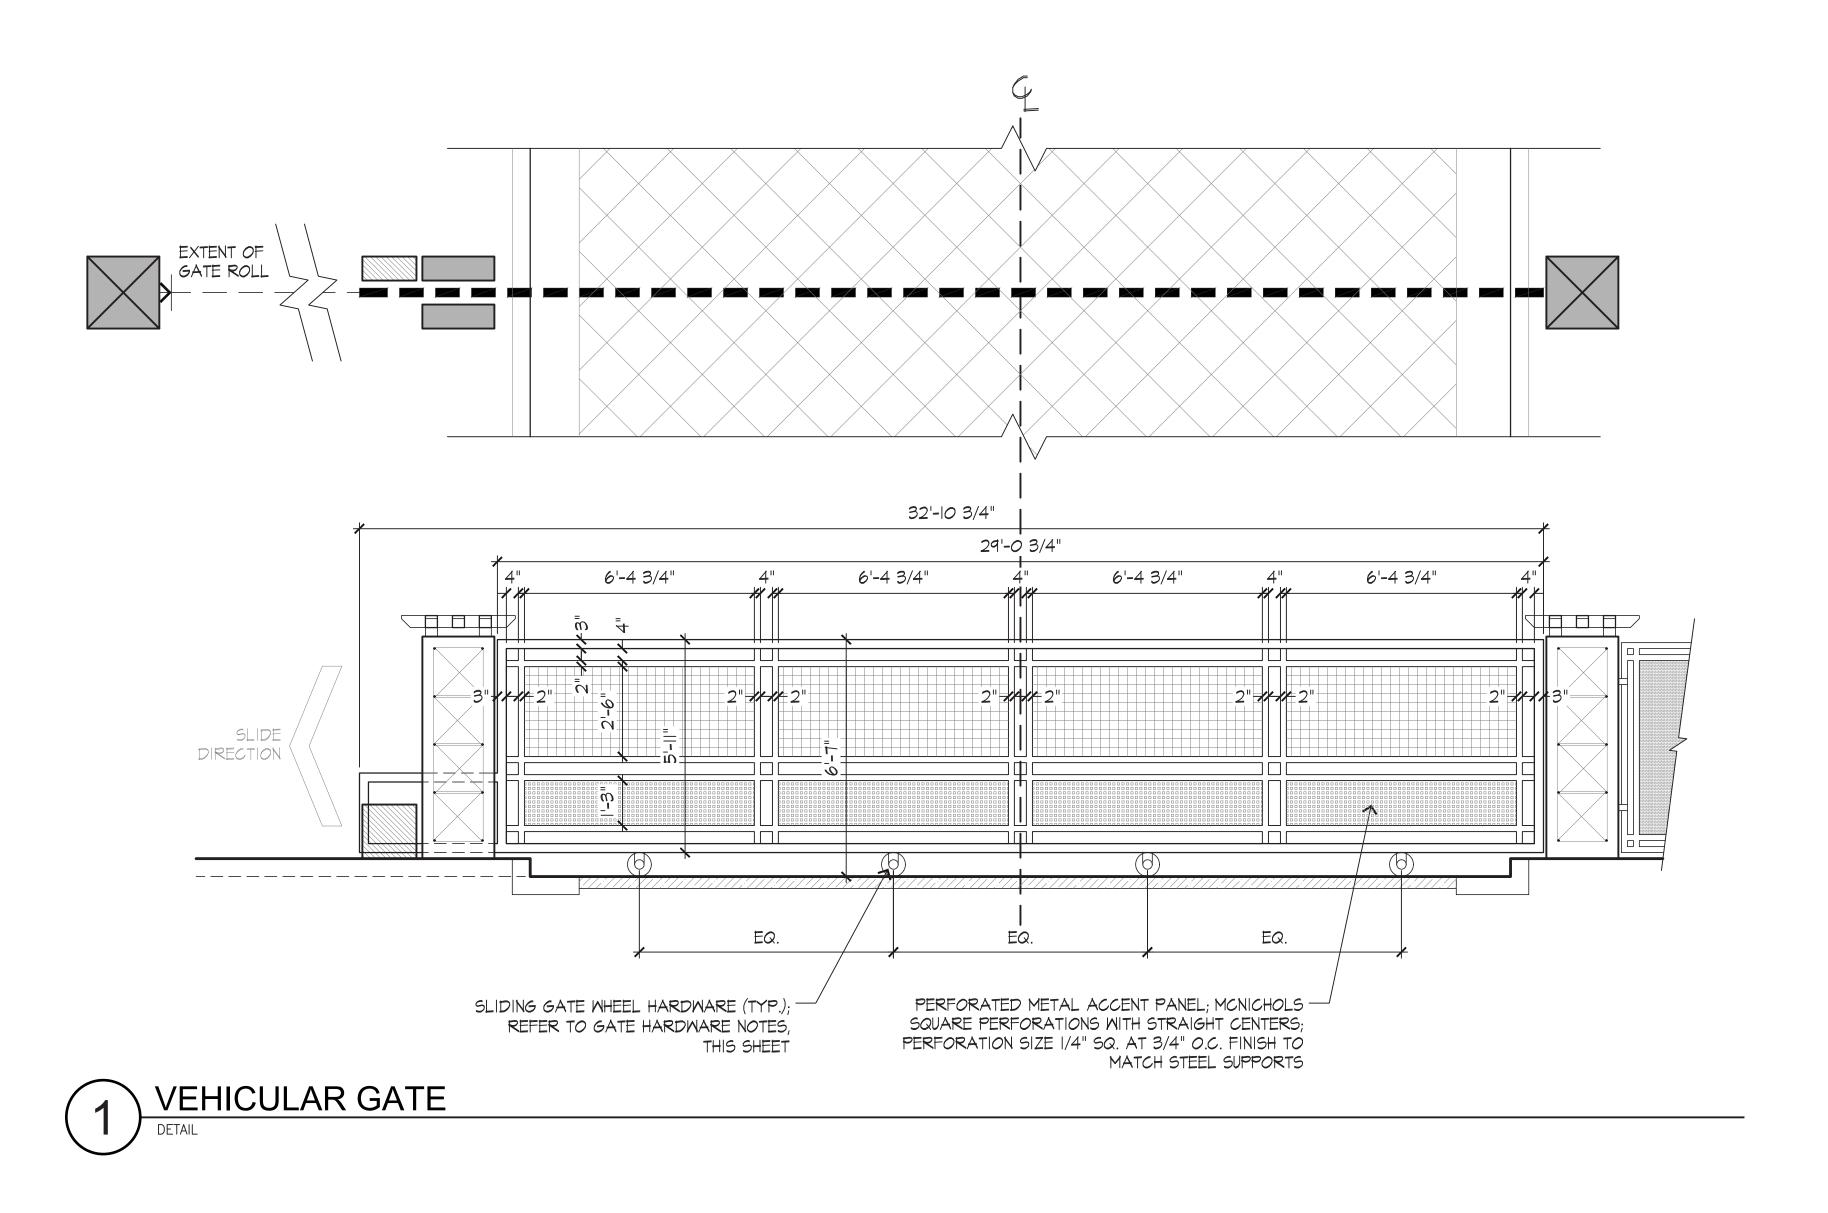

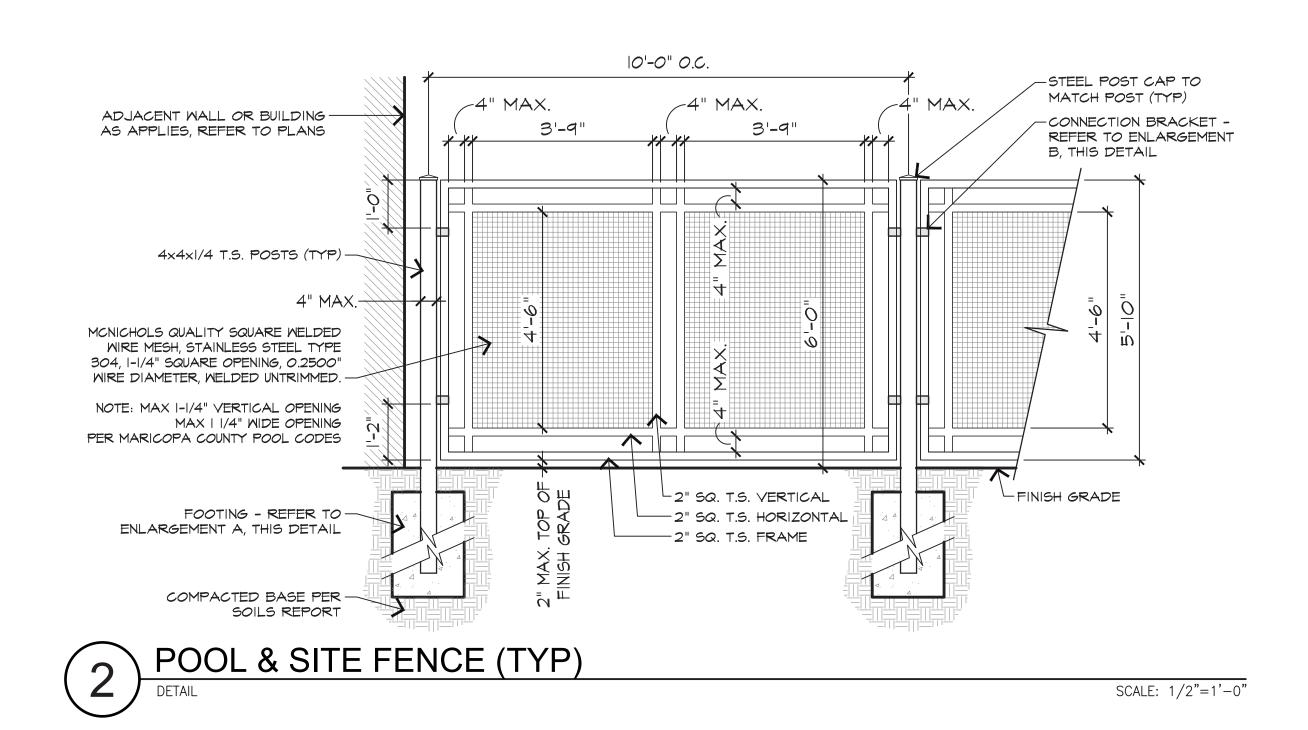


• FOOTING SIZES AND REBAR TO BE REVIEWED AND APPROVED BY STRUCTURAL ENGINEER. POOL GATE TO BE KEYED, SELF-CLOSING, AND SHALL SWING AWAY FROM POOL AREAS - 2" SQ. TUBE STEEL GATE FRAME ALL METAL FINISHES SHALL MATCH ARCHITECTURAL METAL FINISHES UNLESS OTHERWISE SPECIFIED - HEAVY-DUTY HINGE OR APPROVED EQUAL, (2) PER LEAF, WELDED ON 4" SQ. CONCRETE-FILLED TUBE STEEL GATE POST. BY GATE MANUFACTURER. (TYP) - ADJACENT WALL, FENCE, OR COLUMN AS APPLIES, REFER TO PLANS - 2" SQ. TUBE STEEL ACCENT BARS (TYP) 4" SQ. CONCRETE-FILLED TUBE STEEL GATE POST WITH CAP; PROVIDE I" MIN. - 2" MAX. CLEARANCE BETWEEN POST AND ADJACENT WALL, FENCE, OR COLUMN (AS APPLIES) PERFORATED METAL ACCENT PANEL; MCNICHOLS SQUARE PERFORATIONS WITH STRAIGHT CENTERS; PERFORATION SIZE 3/8" SQ. BAR SIZE 1/8" ADA COMPLIANT LATCH HARDWARE. NOTE: PROVIDE MIN. 18" WIDE CLEAR AREA AT LATCH SIDE / PULL SIDE OF GATE PER ADA REQUIREMENTS. LATCH TO NOT ALLOW FOR REACH THROUGH ACCESS. ADA COMPLIANT KICK PLATE, IO"H. MIN. X GATE WIDTH FLAT SURFACE; STEEL PLATE FINISH TO MATCH TUBE STEEL SUPPORTS - FINISH GRADE / LANDSCAPE AREA - PAVING AS APPLIES, REFER TO PLANS (3) PEDESTRIAN GATE - SINGLE (TYP.)

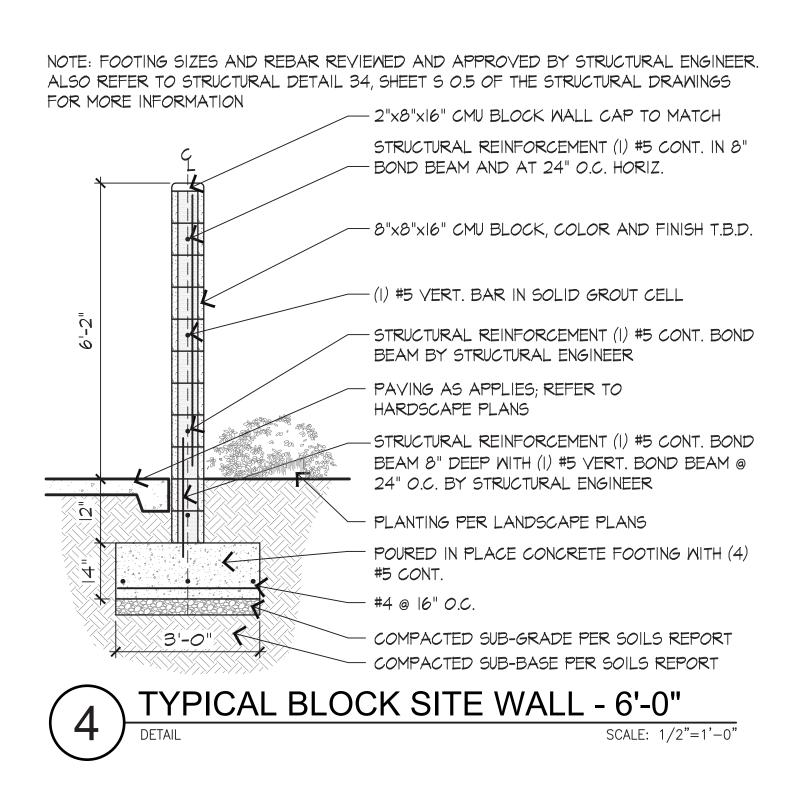

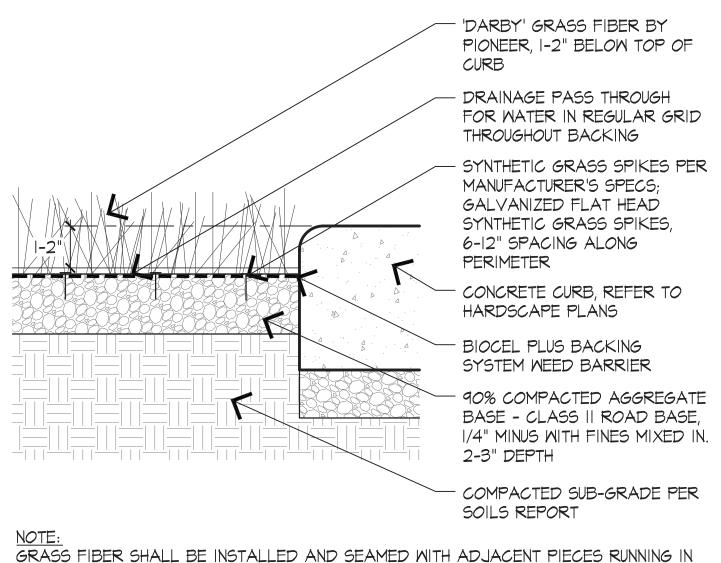



NOTE: GRASS FIBER SHALL BE INSTALLED AND SEAMED WITH ADJACENT PIECES RUNNING IN THE SAME DIRECTION; SEAMS SHALL BE GLUED WITH SUITABLE SEAMING GLUE AND SEAMING CLOTH PER MANUFACTURER'S SPECS. NO ADHESIVE TAPE SHALL BE USED. POWER BROOMING: LAST STAGE OF INSTALLATION PER MANUFACTURER'S SPECS.

(5) ARTIFICIAL TURF INSTALL (TYP.)

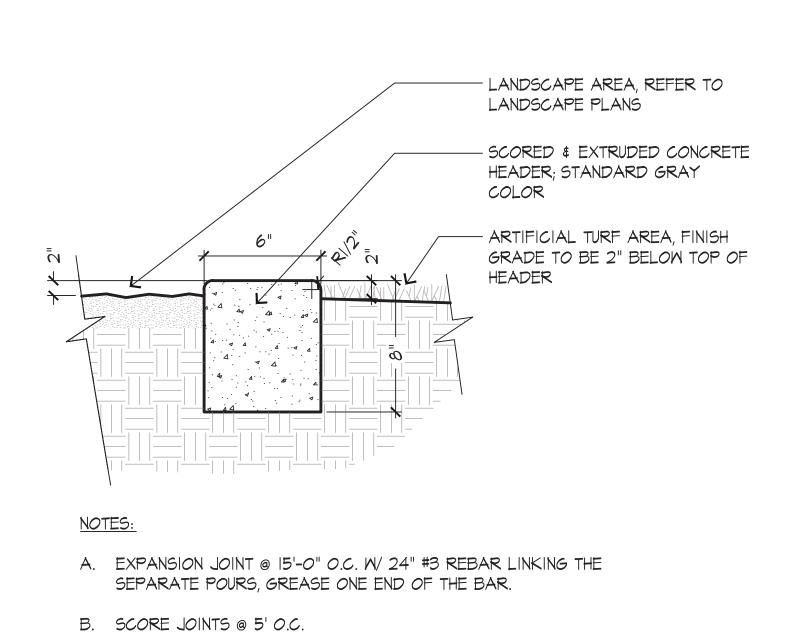

CONCRETE HEADER

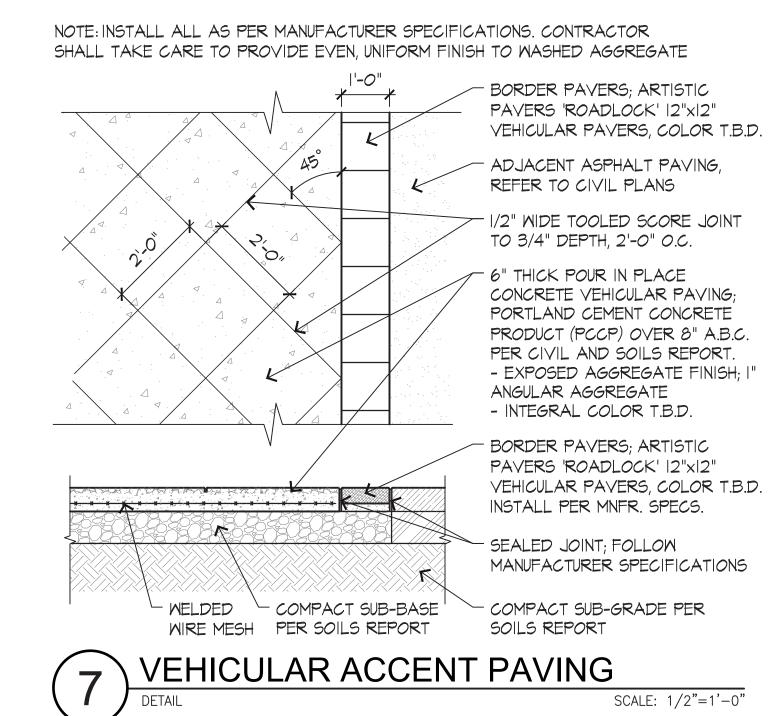

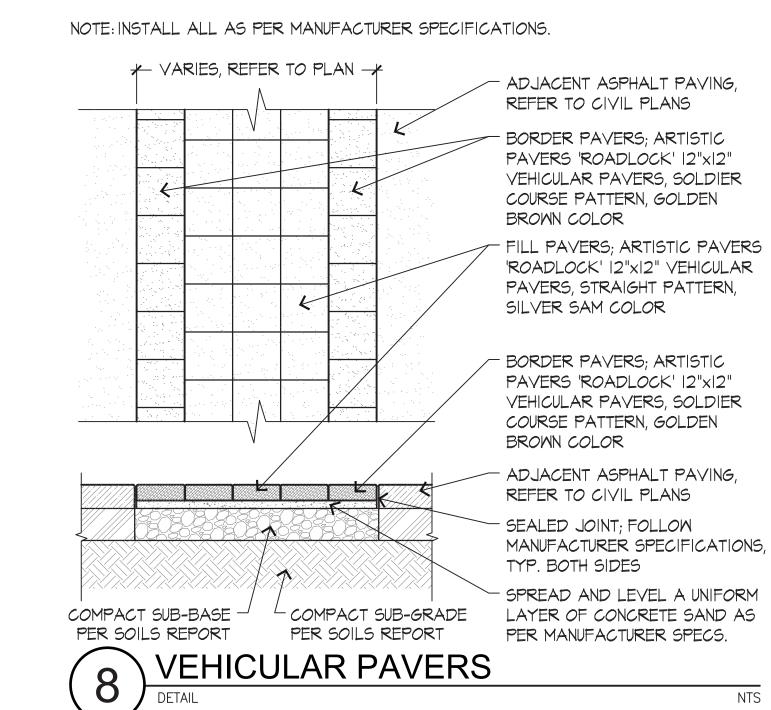

SCALE: 1/2"=1'-0"

Bucilla Group Architecture


Bucilla Group Architecture 19782 Mac Arthur Blvd., Suite 270 Irvine, CA 92612 Phone: 949-851-9080 www.bg-architecture.com



Scottsdale Road & Indian Bend Road Scottsdale, AZ | August 10, 2018

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REQUIRED OPEN SPACE CALCULATIONS:

MAIN ENTRY AREA S.O.W.: 83,767 s.f. 4.79 AC

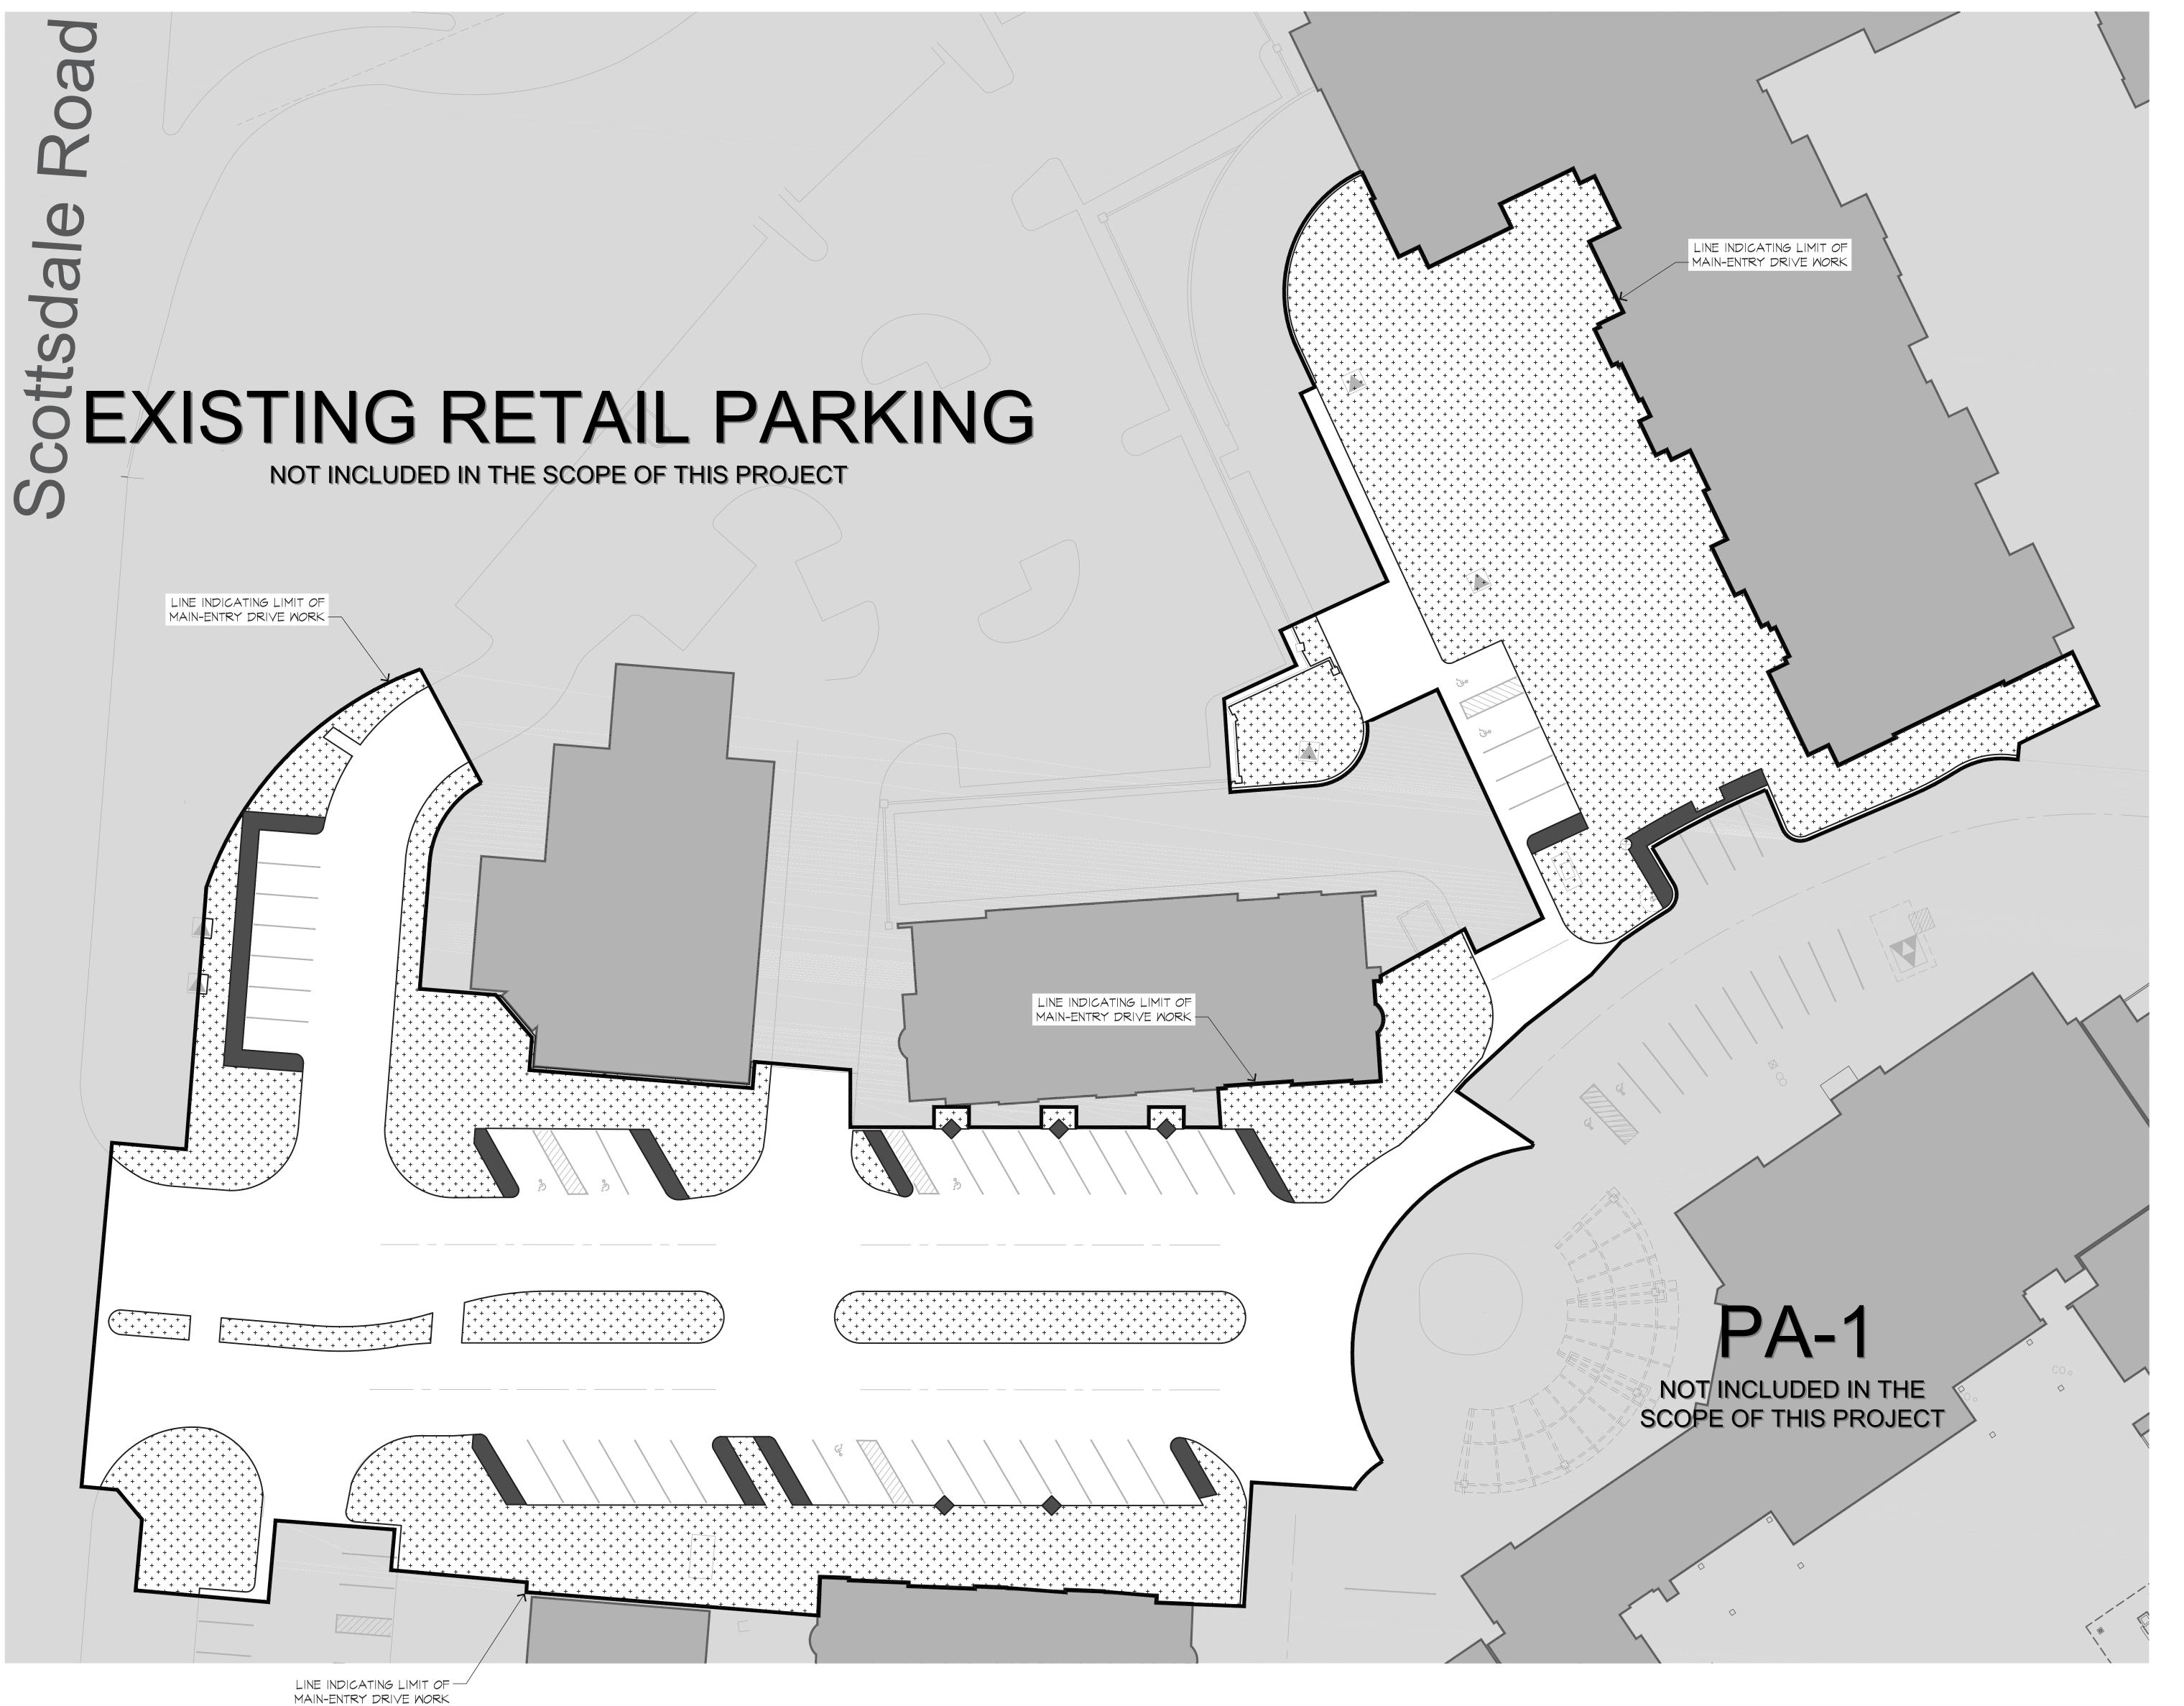BUILDING HEIGHT FLOOR TO FLOOR: 20'-0"

FIRST 10' OF HEIGHT: = $10\% \times SCOPE$ OF WORK AREA = $0.10 \times 83,767 = 7,377 \text{ s.f.}$

NEXT 10' OF HEIGHT: = $10' \times .004 \times 83,767 = 3,351$ s.f.

OPEN SPACE REQUIRED

(NOT INCLUDING PARKING LOT LANDSCAPING)

= 7,377 + 3,351 $= 10,728 \text{ s.f.} (\sim 12.8\%) \text{ REQUIRED}$

= 42,137 s.f. (~50.3%) PROVIDED

PARKING LOT LANDSCAPING REQUIRED CALCULATIONS:

PARKING LOT AREA × 15%

8,582 s.f. x 0.15 = 1,288 s.f. REQUIRED = 1,840 s.f. PROVIDED

RIGHT-OF-WAY LANDSCAPING REQUIRED:

RIGHT-OF-WAY LANDSCAPING IS NOT APPLICABLE AS NO PUBLIC RIGHTS-OF-WAY EXIST WITHIN THE SCOPE OF THIS PROJECT



OPEN SPACE (NOT INCLUDING PARKING LOT LANDSCAPING)

40,297 SQ.FT. PROVIDED




PARKING LOT LANDSCAPING

1,840 SQ.FT. PROVIDED


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Narrative

Date August 17, 2018

Project Artesia - Project Entry Drive

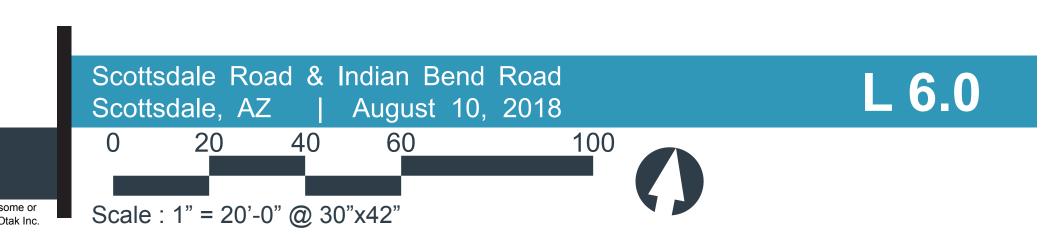Scottsdale, Arizona

Program **Project Entry Drive**

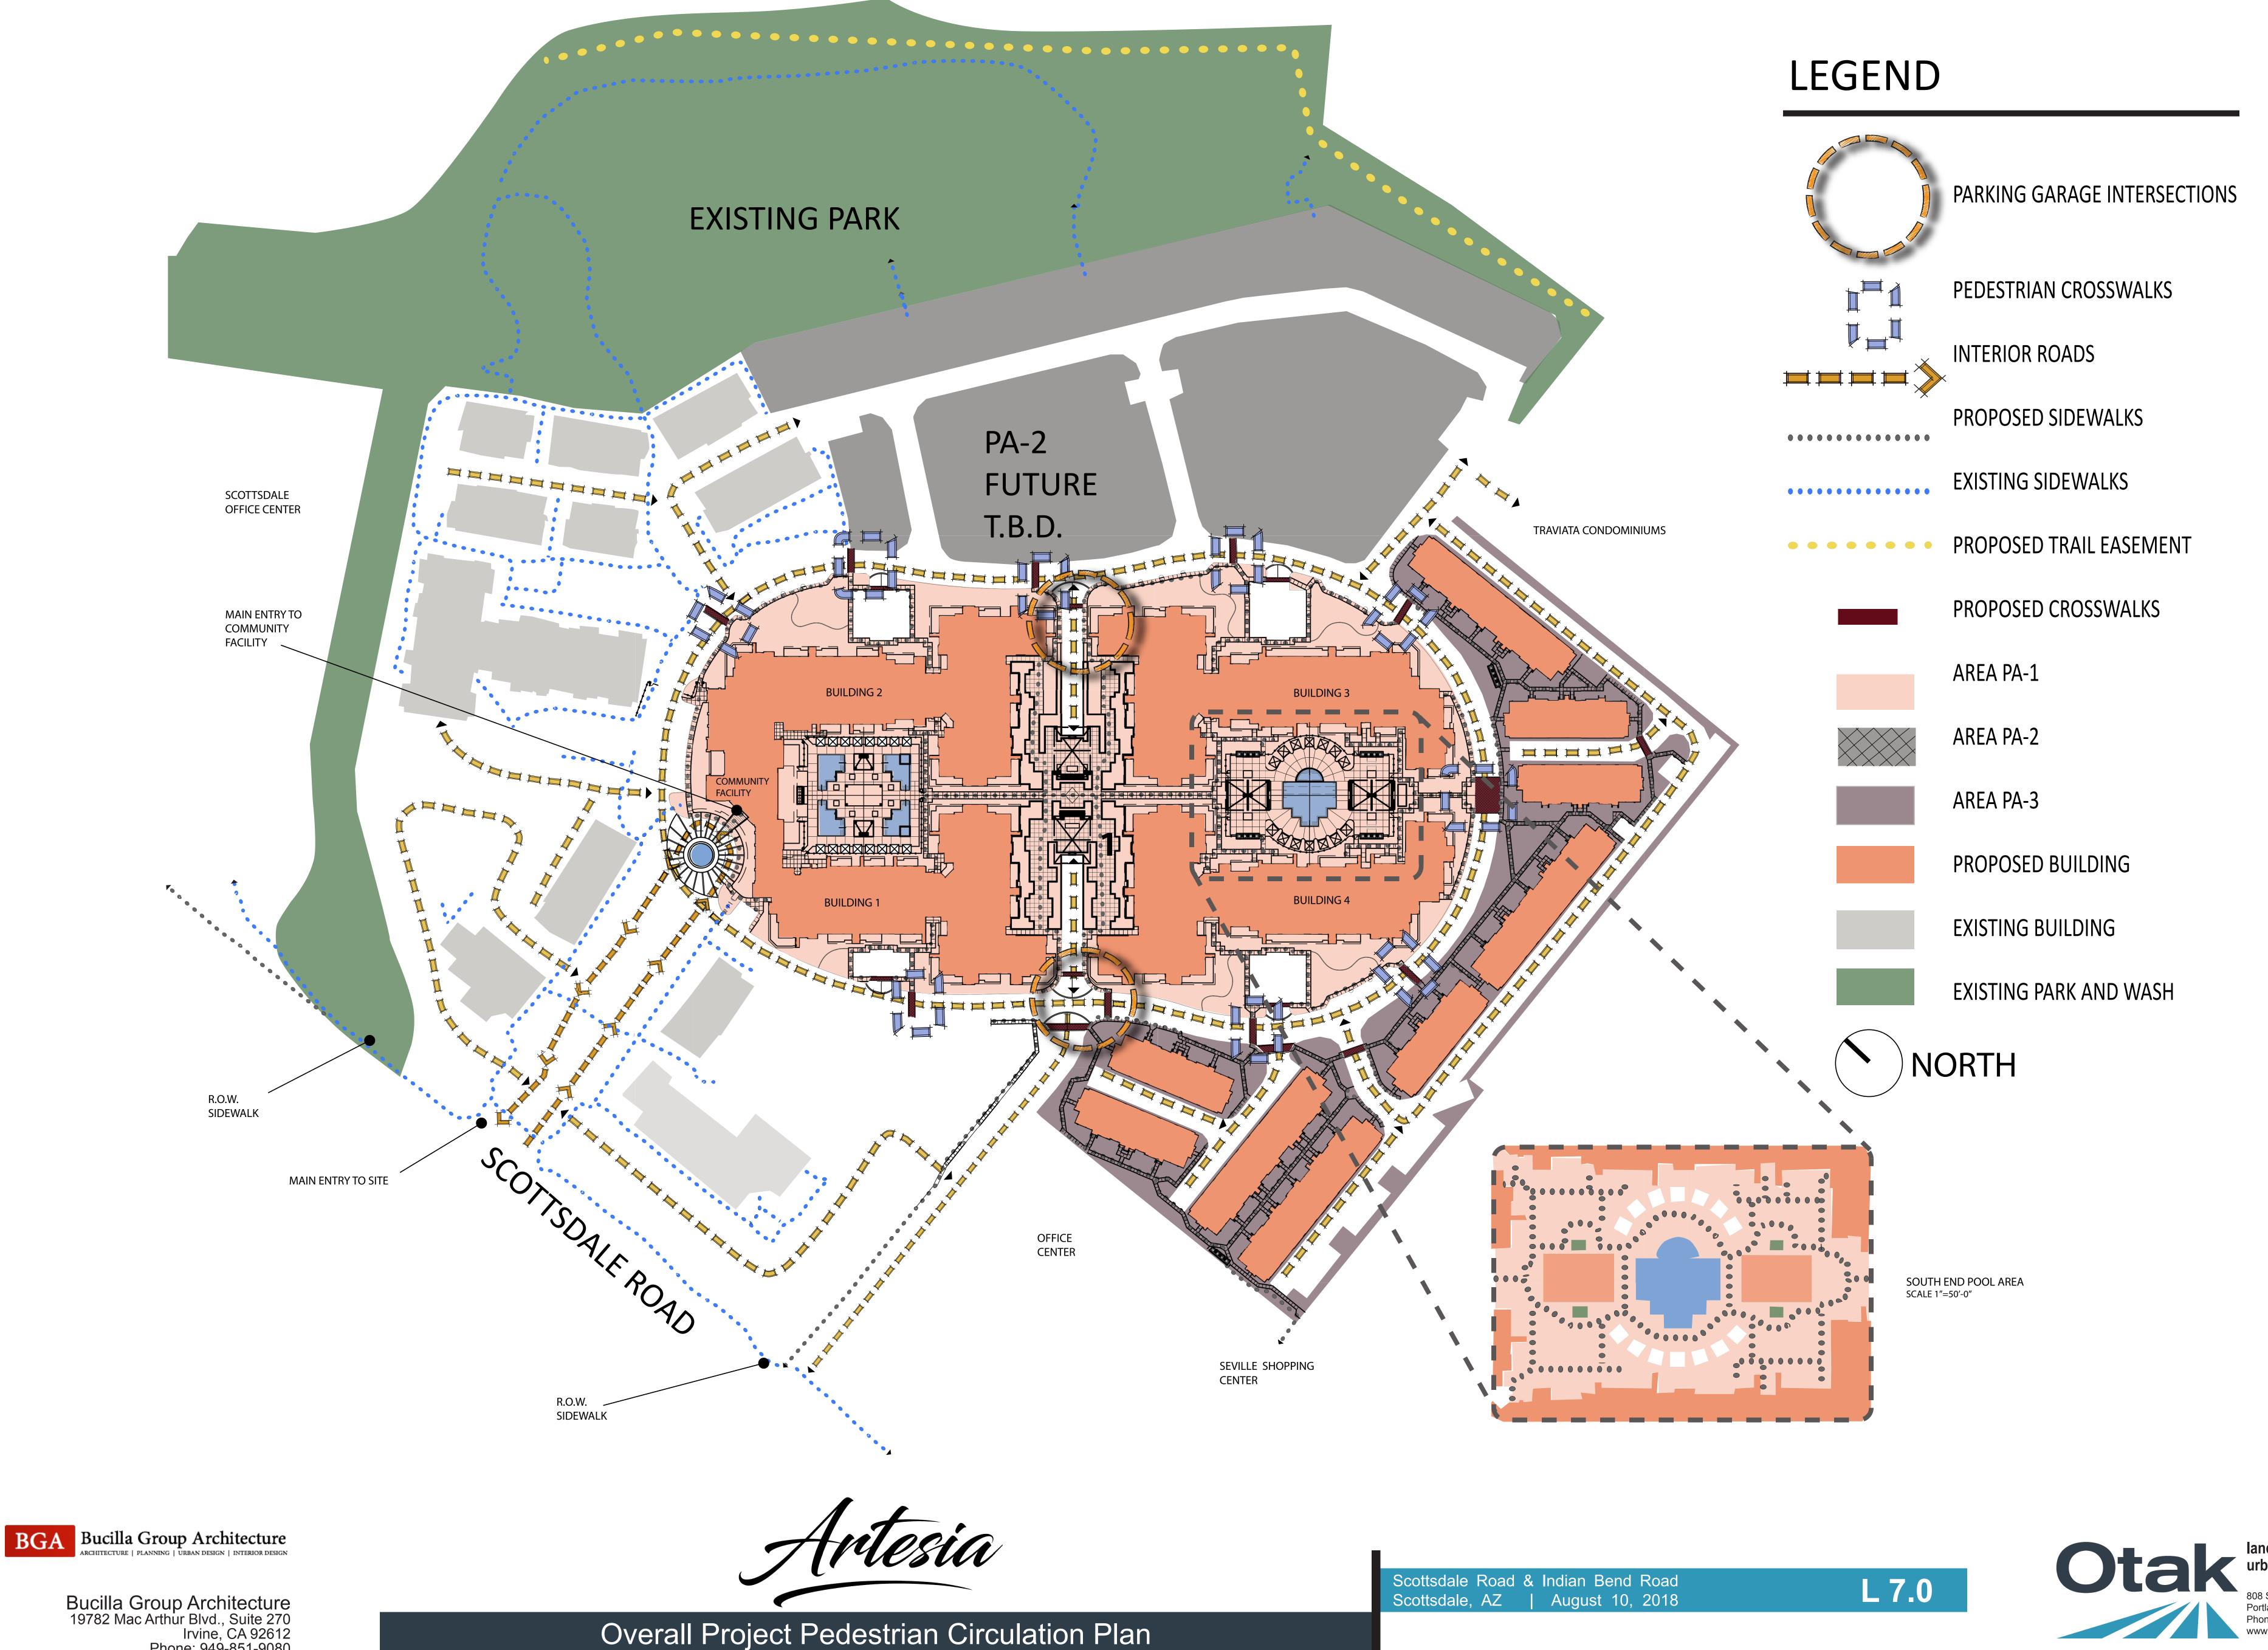Signage - Monument / Island Median / Retail Zone

Entering from North Scottsdale Road, signage monuments are located each side of the entry drive, which are derived out of color and materials from the Community Facility Porte- Cochere character at the end of the retail zone..

The overall theme of the signage - monument materials, are composed of desert stone color pilasters with the introduction of a bronze patina metal frame, along with the project name - Artesia - floating across the frame edge.

Driving past the entry, existing Retail frontage edges both sides of the street. The improvement to this retail zone, would be to the island medians for enhanced landscape and positioning of gateway art in the further use of porte-cochere elements containing the metal frame / stone pilasters, banners and lighting. Two island medians would have the undulating porte-cochere elements meandering along the retail portion to then terminate at the focused circular water element fronting the Community Facility.

The water element ends the festive approach thru the retail zone with a passive circular rain wash water feature surrounding an Artesia water sculpture. This re-purposed sculpture and water feature terminates the end of the retail zone and reinforces the semi-circular drop off area as the foreground to the Community Facility.

Architect of Record -

Greg G. Bucilla III, AIA

President / Principal

BUCILLA GROUP ARCHITECTURE, INC.



INDEX

INDEX SHEET


SP-10.0 PROJECT ENTRY PLAN

PROJECT ENTRY IMAGES SP-10.1 SP-10.2 PROJECT ENTRY IMAGES

SP-10.3 CONCEPTUAL VIEW-1

SP-10.4 CONCEPTUAL VIEW-2

SP-10.5 CONCEPTUAL VIEW-3

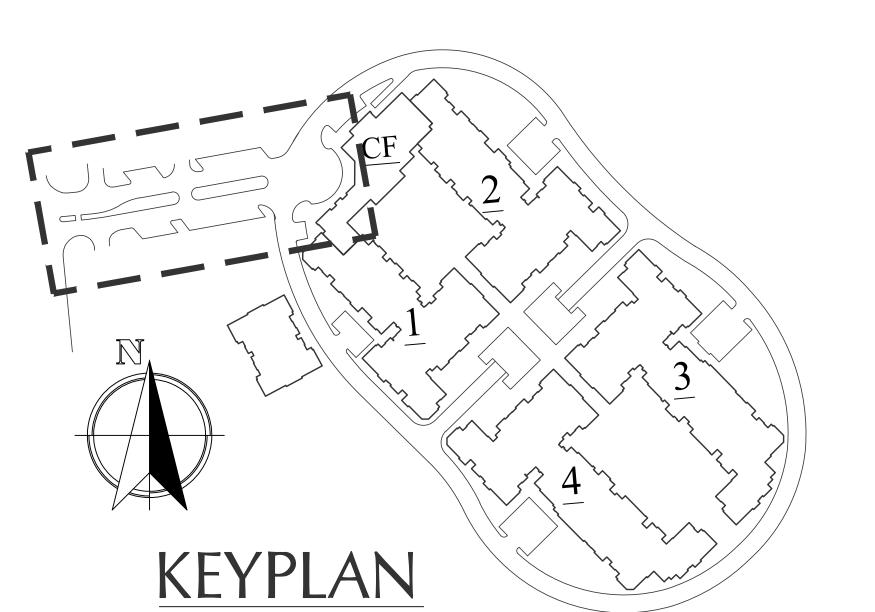

ARCHITECT:

HISTORIC PRESERVATION LEED VALUE ENGINEERING 19782 Mac Arthur Blvd., Suite 270, Irvine, Ca 92612 TEL 949. 851. 9080 FAX 949.623.0084 BUCILLA GROUP ARCHITECTURE, INC. hereby expressly reserves its common law copywright and other property rights in these plans. These plans are not to be

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ATTEST TO ARCHITECTURAL ONLY

ARTESIA 7171 N. SCOTTSDALE ROAD SCOTTSDALE, ARIZONA

ARTESIA DEVELOPMENT
PARTNERS, LLC
SCOTTSDALE, ARIZONA


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BGA No. 15029

PROJECT ENTRY INDEX SHEET

Sheet No.:

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MARCH 28, 2017 DRAFT DESIGN PACKAGE

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2 EXISTING NORTH BIRD'S EYE VIEW

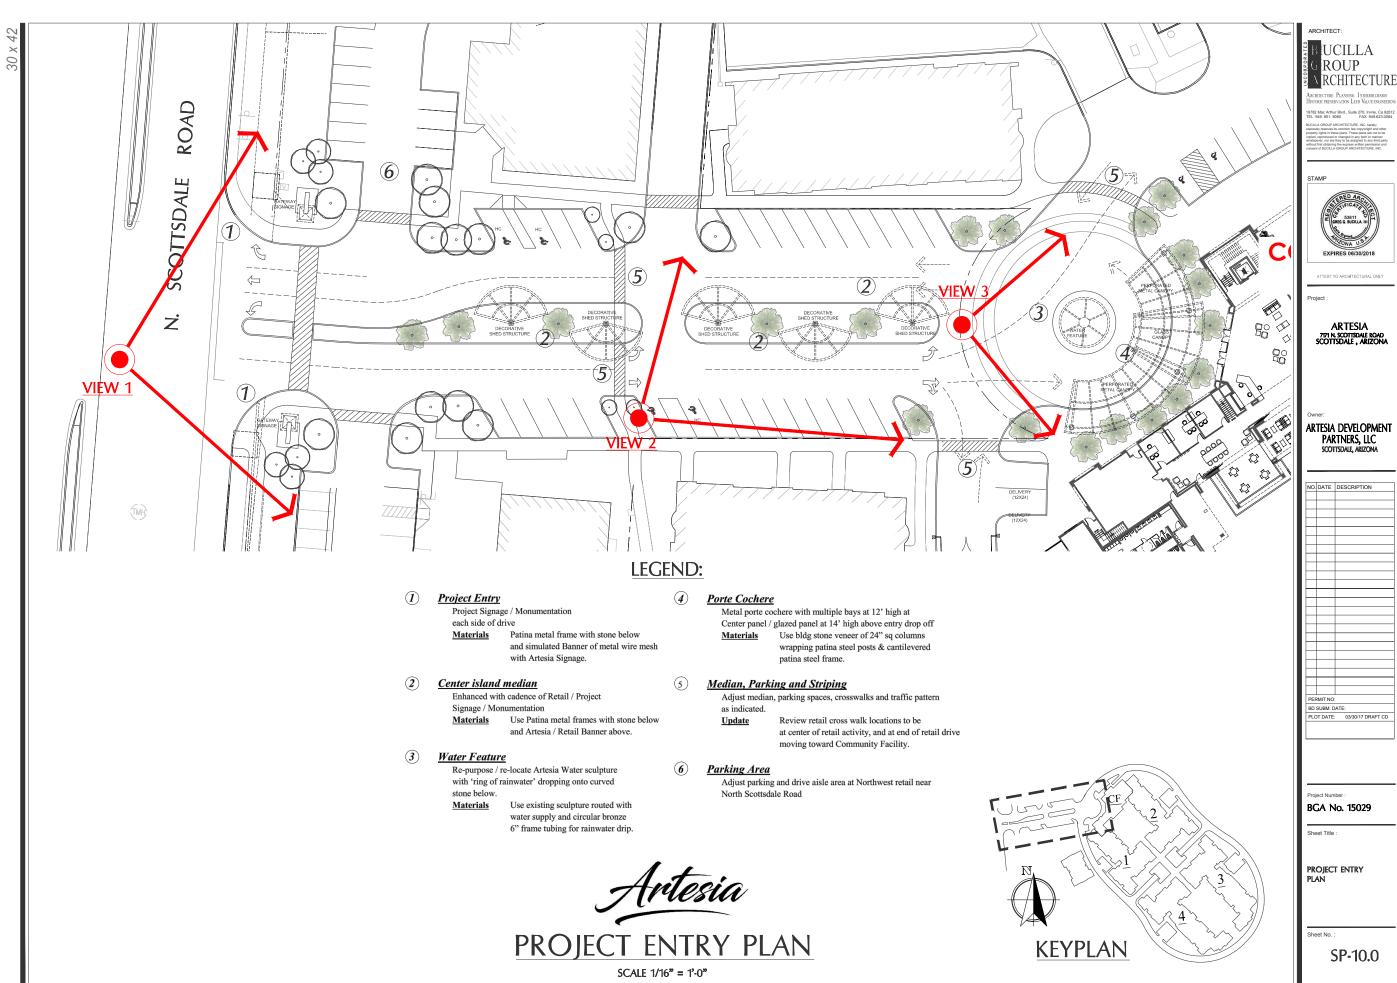(1) EXISTING PLAN VIEW




3 EXISTING EAST BIRD'S EYE VIEW (ROUNDABOUT)



(4) EXISTING NORTH BIRD'S EYE VIEW (ROUNDABOUT)



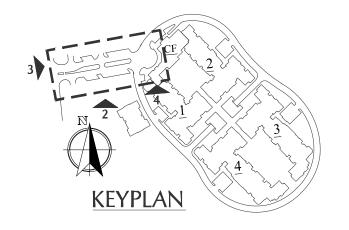

ADCUITE

BUCILLA
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HISTORIC PRISERVATION LEED VILUE ENGINEE

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TEL 1949, 851, 9080 FAX 948 623.00

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ATTEST TO ARCHITECTURAL ON

Project :

ARTESIA 7771 n. scottsdale road Scottsdale , arizona

Owner:

ARTESIA DEVELOPMENT
PARTNERS, LLC
SCOTTSDAIE, ARIZONA

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PROJECT ENTRY PLAN

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SP-10.1

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(5) EXISTING EAST BIRD'S EYE VIEW (ENTRY)



(6) EXISTING NORTHEAST STREET VIEW (ENTRY)




7 EXISTING EAST STREET VIEW (ENTRY)



(8) EXISTING SOUTHEAST STREET VIEW (ENTRY)



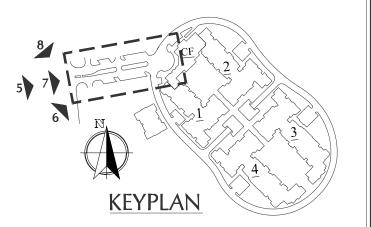

ARCHITE

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Project :

ARTESIA

Owner:

ARTESIA DEVELOPMENT
PARTNERS, LLC
SCOTTSDAIE, ARIZONA

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PROJECT ENTRY PLAN

Sheet No. :

SP-10.2

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ARTESIA DEVELOPMENT PARTNERS, LLC
BUCILLA GROUP ARCHITECTURE

VIEW 1

MAR 21, 2017 SP-10.3



ARTESIA DEVELOPMENT PARTNERS, LLC
BUCILLA GROUP ARCHITECTURE

VIEW 2

MAR 21, 2017 SP-10.4



Artesia TESIA DEVELOPMENT PARTNERS

ARTESIA DEVELOPMENT PARTNERS, LLC
BUCILLA GROUP ARCHITECTURE

VIEW 3

MAR 21, 2017 SP-10.5

Artesia

PRE-APPLICATION NARRATIVE



Northeast of the Northeast Corner of Indian Bend and Scottsdale Road Scottsdale, Arizona

Artesia Development Partners LLC
Joint Venture between iStar and Meritage Homes
8800 E. Raintree Drive, Suite 300
Scottsdale, AZ 85260
Contact: Troy Hill

Date: April 17, 2017

Project Team

<u>Developer</u> Artesia Development Partners LLC

8800 E. Raintree Drive, Suite 300

Scottsdale, AZ 85260

Telephone: 480.515.8164

Contact: Troy Hill

<u>Architect - Podium</u> Bucilla Group Architecture, Inc.

19782 MacArthur Blvd., Suite 270

Irvine, CA 92612

Telephone: 949.838.7019 Contact: Greg Bucilla

<u>Civil Engineer</u> Kimley Horn

7740 N. 16th Street, Suite 300

Phoenix, AZ 85020

Telephone: 602.906.1374 Contact: Mike Delmarter

<u>Landscape Architect</u> Otak

51 W. Third Street, Suite 201

Tempe, AZ 85281

Telephone: 480.557.6670 Contact: Mark Swartz

ARTESIA

This pre-application request is focused on Primary and Secondary Entrance of the Artesia Project.

Changes from original design of primary entrance:

- Reconfigure internal medians
- Re-purposing of artwork (water springs)
- Addition of entry monumentation

Changes from original design of primary entrance:

- Shortening of deceleration lane along Scottsdale Road into community for better traffic flow
- Residence only entrance
- Relocation of APS switching cabinets