


Final Approved Stamped Plans Full Size

APPROVED

Stipulation Set

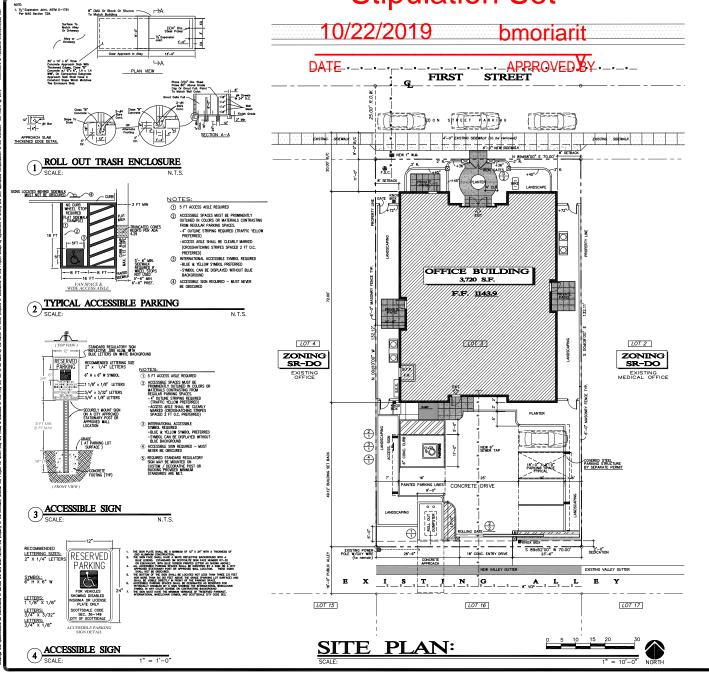

PROJECT DATA:

SIMONSON BUILDINGS, INC. MR. MICHAEL & CINDY SIMONSON 3402 NORTH 36TH STREET

PHOENIX, ARIZONA 85018 (602) 955-0504

ARCHITECTS AND PLANNERS INTERNATIONAL, INC. MR. NICK ACQUAFREDDA, R.A. 4717 E. MCDOWELL ROAD SUITE 100 PHOENIX, AZ 85008 (602) 273-4202 ÈMAIL: nick@architectsandplanners.com

7539 EAST FIRST STREET ADDRESS: SCOTTSDALE, ARIZONA 85251 PARCEL NUMBER: 130-25-021

NET S.F.= 9,247 S.F. ACRES: NET= 0.212 ACRES GROSS S.F.= 10,998 S.F. ACRES: NET= 0.252 ACRES

ALL CONSTRUCTION SHALL COMPLY WITH THE FOLLOWING CODES AND AMENDMENTS PER THEIR ADOPTED ORDINANCES: 2015 INTERNATIONAL BUILDING CODE (ORD 4284) W/I.C.C./ANSI-119.1 (2010) 2015 INTERNATIONAL MECHANICAL CODE (ORD 4284)

2015 INTERNATIONAL PLUMBING CODE (ORD 4284) 2014 NATIONAL ELECTRICAL CODE (ORD 4284) 2015 INTERNATIONAL FIRE CODE (ORD 4283)

LEGAL DESCRIPTION: Lot 3, Block 2, REDDELL MANOR, according to the plat of record in the office of the County Recorder of Maricopa County, Arizona, in Book 49 of Maps, page 27.

PROPOSED USE: PROFESSIONAL OFFICES

ZONING: SR-DO SERVICE RESIDENTIAL, DOWNTOWN OVERLAY

OCCUPANCY B (OFFICES)

CONSTRUCTION TYPE: V-B (FULLY SPRINKLED).
PER NFPA-13 STANDARDS FIRE PROTECTION DRAWING BY SEPARATE PERMIT

BUILDING AREA GROSS: TOTAL BUILDING AREA:

PARKING: TYPICAL PARKING STALL = 9'X18'

CITY OF SCOTTSDALE DOWNTOWN OVERLAY PARKING EXEMPTION 2,000 SQ. FT.

+ 1,812 SQ. FT. (EXISTING BUILDING) 3,812 SQ .FT. (TOTAL EXEMPTION) TOTAL PARKING REQUIRED:

TOTAL PARKING PROVIDED: 9.0 SPACES

SCOPE OF WORK

PROJECT SCOPE INCLUDES: SITE DEVELOPMENT FOR NEW OFFICES, CONCRETE PAVEMENT FOR PARKING, DECORATIVE MASONRY PROPERTY FENCES, ATTRACTIVE LANDSCAPING AND

NEW SINGLE STORY 3,720 SQ. FT. MASONRY BUILDING, WOOD FRAME INTERIOR PARTITIONS, CURVED WOOD ROOF TRUSES WITH STANDING SEAM METAL ROOFING, MECHANICAL, PLUMBING

VICINITY MAP:








OFFICE **PROFESSIONAL**


> <u>ပ</u> international જ architects



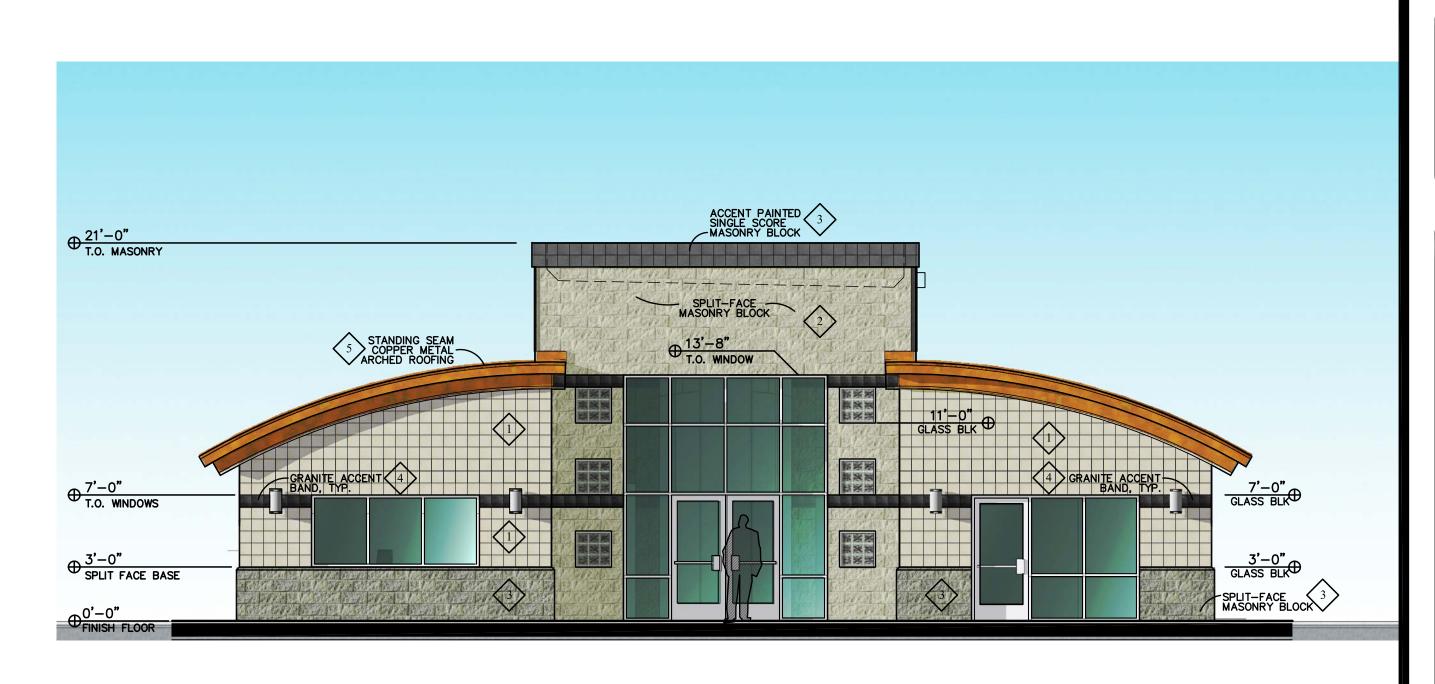



3/16" = 1'-0"

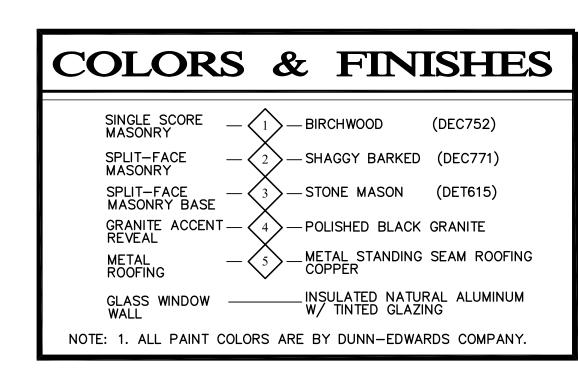


FRONT ELEVATION:

NORTH:

3/16" = 1'-0"

APPROVED

Stipulation Set 10/22/2019 bmoriarit APPROVED X

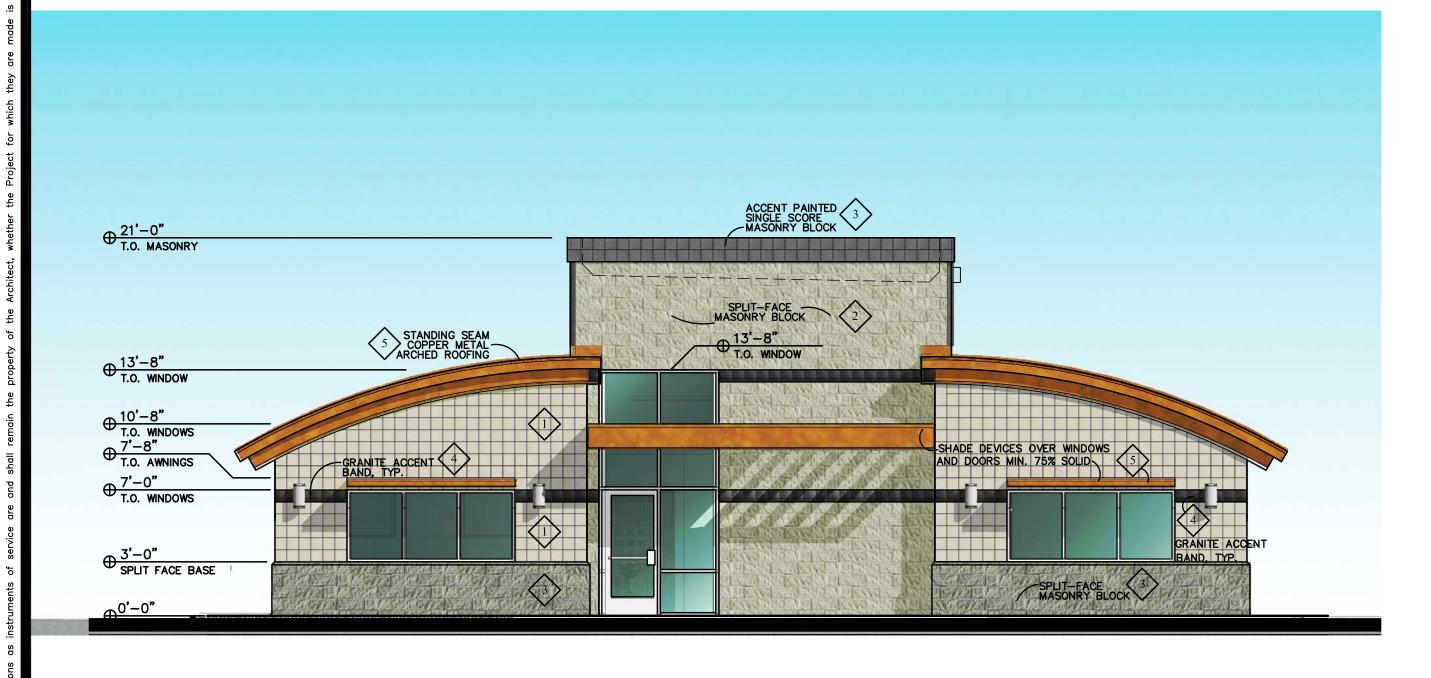



SOUTH ELEVATION:

WEST ELEVATION:

3/16" = 1'-0"

planners international, architects

d

job no.

SIMONSON BUILDING PROFESSIONAL OFFICE IMPROVEMENT

PLANTING MATERIAL LEGEND

<u> </u>				
	TREES	SIZE	NOTES	QTY
	Chilopsis linearis burgundy□ Desert Willo□ Caliper Si□e□1.5"	24" Box H 6⊡W 4□	Standard trun□ □ADWR	4
	Acacia farnesiana Desert S□eet Acacia Caliper Si□e □1.5"	24" Box H 7⊑W 3□	ADWR	2
	GROUNDCOVERS			QTY
$ \begin{array}{c c} & & & & \\ & & & & \\ & & & & \\ & & & \\ & & & \\ & & & \\ & & & \\ & & \\ & & \\ & & \\ & & \\ & & \\ & & \\ & & \\ & & \\ & $	Lantana montevidensis Trailing Lantana เGold□	5 Gallon	□ ADWR	2
	Lantana mo. Dallas Red□ Dallas Red Lantana	5 Gallon	□ ADWR	4
	Convolvulus mauritanicus Ground Morning Glory	1 Gallon	□ ADWR	6
�	Melampodium leucanthum Blac⊡foot Daisy	1 Gallon	ADWR	24
	SHRUBS / ACCENT	S		QTY
	Ruellia californica Bara Ruellia	5 Gallon Can Full	□ADWR	4
\odot	Muhlenbergia capillaris Regal Mist Grass	5 Gallon	□ ADWR	23
\odot	Aloe hybrid Blue Elf□ Blue Elf Aloe	5 Gallon	ADWR	23
\odot	Hesperaloe parviflora Red Yucca	5 Gallon	□ADWR	3
	Salvia greggii Autumn Sage	5 Gallon	□ADWR	28
	Agave murpheyi Murphy® Agave	5 Gallon	□ADWR	1
*	LANDSCAPE MATE	RIALS		

Decomposed Granite. 3/4" minus, Express Ari ona Gold 2" deep in 2,305 s t. planting areas per plan.

□ ADWR □ Ari □ Cona Department of Water Resources Approved Lo□-Water Use Plant

□SVT □ Sight Visibilty Triangle

IRRIGATION LEGEND

SYSTEM DESIGNED USING A RESIDUAL PRESSURE OF 80 PSI

RAIN BIRD ESP-ME RESIDENTIAL CONTROLLER, 4 STATION. ESP4MEI MODEL WALL MOUNT - METAL ENCLOSURE PAINT TO MATCH ARCHITECTURE FINISH WHERE MOUNTED.

BACKFLOW PREVENTER ASSEMBLY, FEBCO 825YA, WITH ENCLOSURE PER CITY OF SCOTTSDALE STD DETAIL 2354

LOCATION. EX. DRIP VALVE ASSEMBLY TO BE MAINTAINED DURING CONSTRUCTION. PRESSURE REG. SENNIGER 30 PSI - LOCATE IN SEPARATE BOXES MEDIUM FLOW 2-20GPM - 30 PSI (100 MESH)

CONNECT TO EX. DRIP VALVES, FIELD VERIFY

FLUSH CAP

1/2" FLUSH VALVE BOWSMITH 1.0 GPH (1 PER PLANT)

SPEARS FLUSH CAP

BOWSMITH 1.0 GPH 6 PORT (2 PER TREE) GROUPS OF SHRUBS WITHIN 6. EXISTING/ NEW TREES RECEIVE DEEP WATER

SERVICE POINT CONNECT TO EXISTING MUNICIPAL POTABLE PIPE LEGEND

MAINLINE - 1" SIZE PVC SCH. 40

FOR EMITTERS

WATER SERVICE

TREE LATERAL PVC SCH. 40 - SOLVENT WELD

SHRUB LATERAL

W

PVC SCH. 40 - SOLVENT WELD PIPE SLEEVE PVC SCH. 40 - 2 X PIPE SIZE MINIMUM WIRE SLEEVE PVC SCH. 40 - 1 1/2" SIZE

CITY OF SCOTTSDALE LANDSCAPE NOTES

- AREAS OF DECOMPOSED GRANITE WITHOUT PLANT MATERIALS/ GROUNDCOVER SHALL NOT EXCEED DIMENSIONS OF MORE THAN 7 FEET IN ANY ONE DIRECTION, MEASURED BETWEEN PLANT CANOPIES AND/OR COVERAGE.
- A MINIMUM OF 50 PERCENT OF THE PROVIDED TREES SHALL BE MATURE TREES PURSUANT TO THE CITY OF SCOTTSDALE'S ZONING ORDINANCE ARTICLE X, SECTION 10.301, AS DEFINED IN THE CITY OF SCOTTSDALE'S ZONING ORDINANCE ARTICLE III, SECTION 3.100.
- A SINGLE TRUNK TREE'S CALIPER SIZE, THAT IS TO BE EQUAL TO OR LESS THAN 4-INCHES, SHALL BE DETERMINED BY UTILIZING THE SMALLEST DIAMETER OF THE TRUNK 6-INCHES ABOVE FINISHED GRADE ADJACENT TO THE TRUNK. A TREES CALIPER SIZE, FOR SINGLE TRUNK TREES THAT ARE TO HAVE A DIAMETER GREATER THAN 4-INCHES, SHALL BE DETERMINED BY UTILIZING THE SMALLEST DIAMETER OF THE TRUNK 12-INCHES ABOVE FINISHED GRADE ADJACENT TO THE

A MULTIPLE TRUNK TREE'S CALIPER SIZE IS MEASURED AT 6" ABOVE THE LOCATION THAT THE TRUNK SPLITS ORIGINATES, OR 6" ABOVE THE FINISHED GRADE IF ALL TRUNKS ORIGINATE FROM THE SOIL.

AREA WITHIN THE SIGHT DISTANCE TRIANGLE IS TO BE CLEAR OF LANDSCAPING, SIGNS, OR OTHER VISIBILITY OBSTRUCTIONS WITH A HEIGHT GREATER THAN 2 FEET. TREES WITHIN THE SAFETY TRIANGLE SHALL HAVE A CANOPY THAT BEGINS AT 7 FEET IN HEIGHT UPON INSTALLATION. ALL HEIGHTS ARE MEASURED FROM NEAREST STREET LINE ELEVATION.

NO TURF AREAS ARE TO BE PROVIDED.

- RETENTION/DETENTION BASINS SHALL BE CONSTRUCTED SOLELY FROM THE APPROVED CIVIL PLANS. ANY ALTERATION OF THE APPROVED DESIGN (ADDITIONAL FILL, BOULDERS, ETC.) SHALL REQUIRE ADDITIONAL FINAL PLANS STAFF REVIEW
- ALL RIGHTS-OF-WAY ADJACENT TO THIS PROPERTY SHALL BE LANDSCAPED AND MAINTAINED BY THE PROPERTY OWNER.
- PRIOR TO THE ESTABLISHMENT OF WATER SERVICE, NON-RESIDENTIAL PROJECTS WITH AN ESTIMATED ANNUAL WATER DEMAND OF TEN (10) ACRE FEET OF MORE SHALL SUBMIT A CONSERVATION PLAN IN CONFORMANCE WITH SECTIONS 49-245 THROUGH 49-248 OF THE CITY CODE TO THE WATER CONSERVATION OFFICE.
- TURF SHALL BE LIMITED TO THE MAXIMUM AREA SPECIFIED IN SECTIONS 49-245 THROUGH 49-248 OF THE CITY CODE AND SHALL BE SHOWN ON LANDSCAPE PLANS SUBMITTED AT THE TIME OF FINAL PLANS.

10. NO LIGHTING IS APPROVED WITH THE SUBMITTAL.

- 11. THE LANDSCAPE SPECIFICATION SECTION(S) OF THESE PLANS HAVE NOT REVIEWED AND SHALL NOT BE PART OF THE CITY OF SCOTTSDALE'S APPROVAL.
- 12. ALL SIGNS REQUIRE SEPARATE PERMITS AND APPROVALS. NEW LANDSCAPING. INCLUDING SALVAGED PLANT MATERIAL, AND LANDSCAPING INDICATED TO REMAIN. WHICH IS DESTROYED, DAMAGED, OR EXPIRED DURING CONSTRUCTION SHALL BE REPLACED WITH LIKE SIZE, KIND, AND QUANTITY PRIOR TO THE ISSUANCE OF THE CERTIFICATE OF OCCUPANCY / LETTER OF ACCEPTANCE TO THE SATISFACTION OF THE INSPECTION SERVICES STAFF.
- 13. LANDSCAPE ARCHITECT STRONGLY RECOMMENDS APPLICATION OF "SUPERTHRIVE" HORMONE / VITAMIN TREATMENT TO MITIGATE TRANSPLANT SHOCK.

CITY OF SCOTTSDALE SIGNATURE BLOCK

ESTIMATED ANNUAL LANDSCAPE WATER DEMAND	
City Requirements	
10.0 ft/ac/year x XX sqft/ac x XX gal./cuft	= XX gal./yr max.
Total Landscape Water Usage	2,160 gal./year
Water Conservation	XXX gal./year
Total Acre Foot of Water Per Year	288 ft/ac/year

CITY OF SCOTTSDALE LANDSCAPE PLAN APPROVAL

DATE: APPROVED BY: CONSTRUCTION AND INSTALLATION SHALL BE IN ACCORDANCE WITH THIS PLAN AND ALL DEVIATIONS WILL REQUIRE REAPPROVAL. THE CITY WILL NOT ISSUE A CERTIFICATE OF OCCUPANCY UNTIL INSPECTION SERVICES STAFF APPROVES THE LANDSCAPE INSTALLATION.

ALL LANDSCAPE AREAS AND MATERIALS, INCLUDE THOSE LOCATED IN PUBLIC RIGHTS-OF-WAY, SHALL BE MAINTAINED IN A HEALTHY, NEAT, CLEAN AND WEED FREE CONDITION. ANSI A 300 STANDRD PRACTICES FOR PRUNING, SUPPORT SHALL BE THE RESPONSIBILITY OF THE

(Property Owner / Developer / HOA)

CITY OF SCOTTSDALE LANDSCAPE PLAN REAPPROVAL

REAPPROVAL #	REVISED SHEET #(S)	DESCRIPTION OF REVISION(S)		
CASE #:	APPROVED BY:	DATE:		
CONSTRUCTION	J AND INSTALLATION SHALL BE IN			

CONSTRUCTION AND INSTALLATION SHALL BE IN ACCORDANCE WITH THIS PLAN AND ALL DEVIATIONS WILL REQUIRE REAPPROVAL. THE CITY WILL NOT ISSUE A CERTIFICATE OF OCCUPANCY UNTIL INSPECTION SERVICES STAFF APPROVES THE LANDSCAPE INSTALLATION.

LANDSCAPE CALCULATIONS CITY OF SCOTTSDALE

LANDSCAPE MATERIAL NOT ON AD.W.R.:	0.0%
LANDSCAPE TURF AREA TOTAL	0 S.F.
LANDSCAPE ON-SITE TOTAL	2,120 S.F.
LANDSCAPE OFF-SITE TOTAL	185 S.F.
LANDSCAPE PARKING LOT TOTAL	500 S.F.
TOTAL PROJECT LANDSCAPE AREA	2,305 S.F.

SHEET INDEX

SHEET L0.1 L1.0 L2.0 L3.0	TITLE LANDSCAPE COVER LANDSCAPE PLAN IRRIGATION PLAN LANDSCAPE DETAIL
L4.0-L4.1	IRRIGATION DETAILS


OWNER CONTACT

SIMONSON BUILDING. INC MR. MICHAEL & CINDY SIMONSON 3402 N. 36TH ST. PHOENIX, ARIZONA 85018 (602) 955-0504

LANDSCAPE ARCHITECT

HARRINGTON PLANNING + DESIGN (HP+D) 3116 S. MILL AVENUE, SUITE 305 TEMPE. ARIZONA 85282 JASON HARRINGTON, RLA, ASLA, ASIC, APWA JASON@HARRINGTONPLANNINGDESIGN.COM

VICINITY MAP

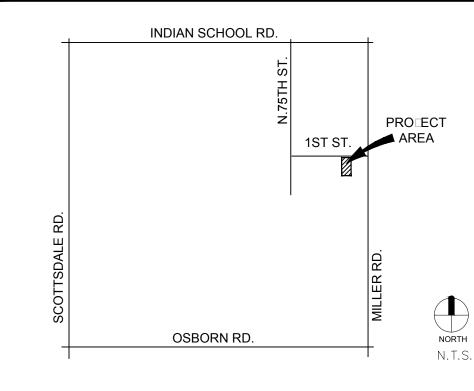

PROŒCT DATA

ZONING: SR-DO PLAN ID #: APN#104-54-399

HARRINGTON PLANNING DESIGN 3116 S. Mill Avenue, Suite 305 Tempe, Ari ona 85282 Tel 480-250-0116 .HarringtonPlanningDesign.com



REV. COMMENT 1ST Revie □ 05.03.19 DATE ISSUE LANDSCAPE **PACKAGE** AUGUST 15, 2019 DRAWN BY□ SL CHECK BY□ SL PRO□ NO.□ | 2019-016 CASE NO.□ NA


> LANDSCAPE COVER

1 of 6

ARIZONA BLUESTAKE CENTER CALL TWO WORKING DAYS

1.800.782.5348

NOTES: COMPLY WITH CITY OF SCOTTSDALE SUMARRY DATA PER ZONING ORDINACES 10.200

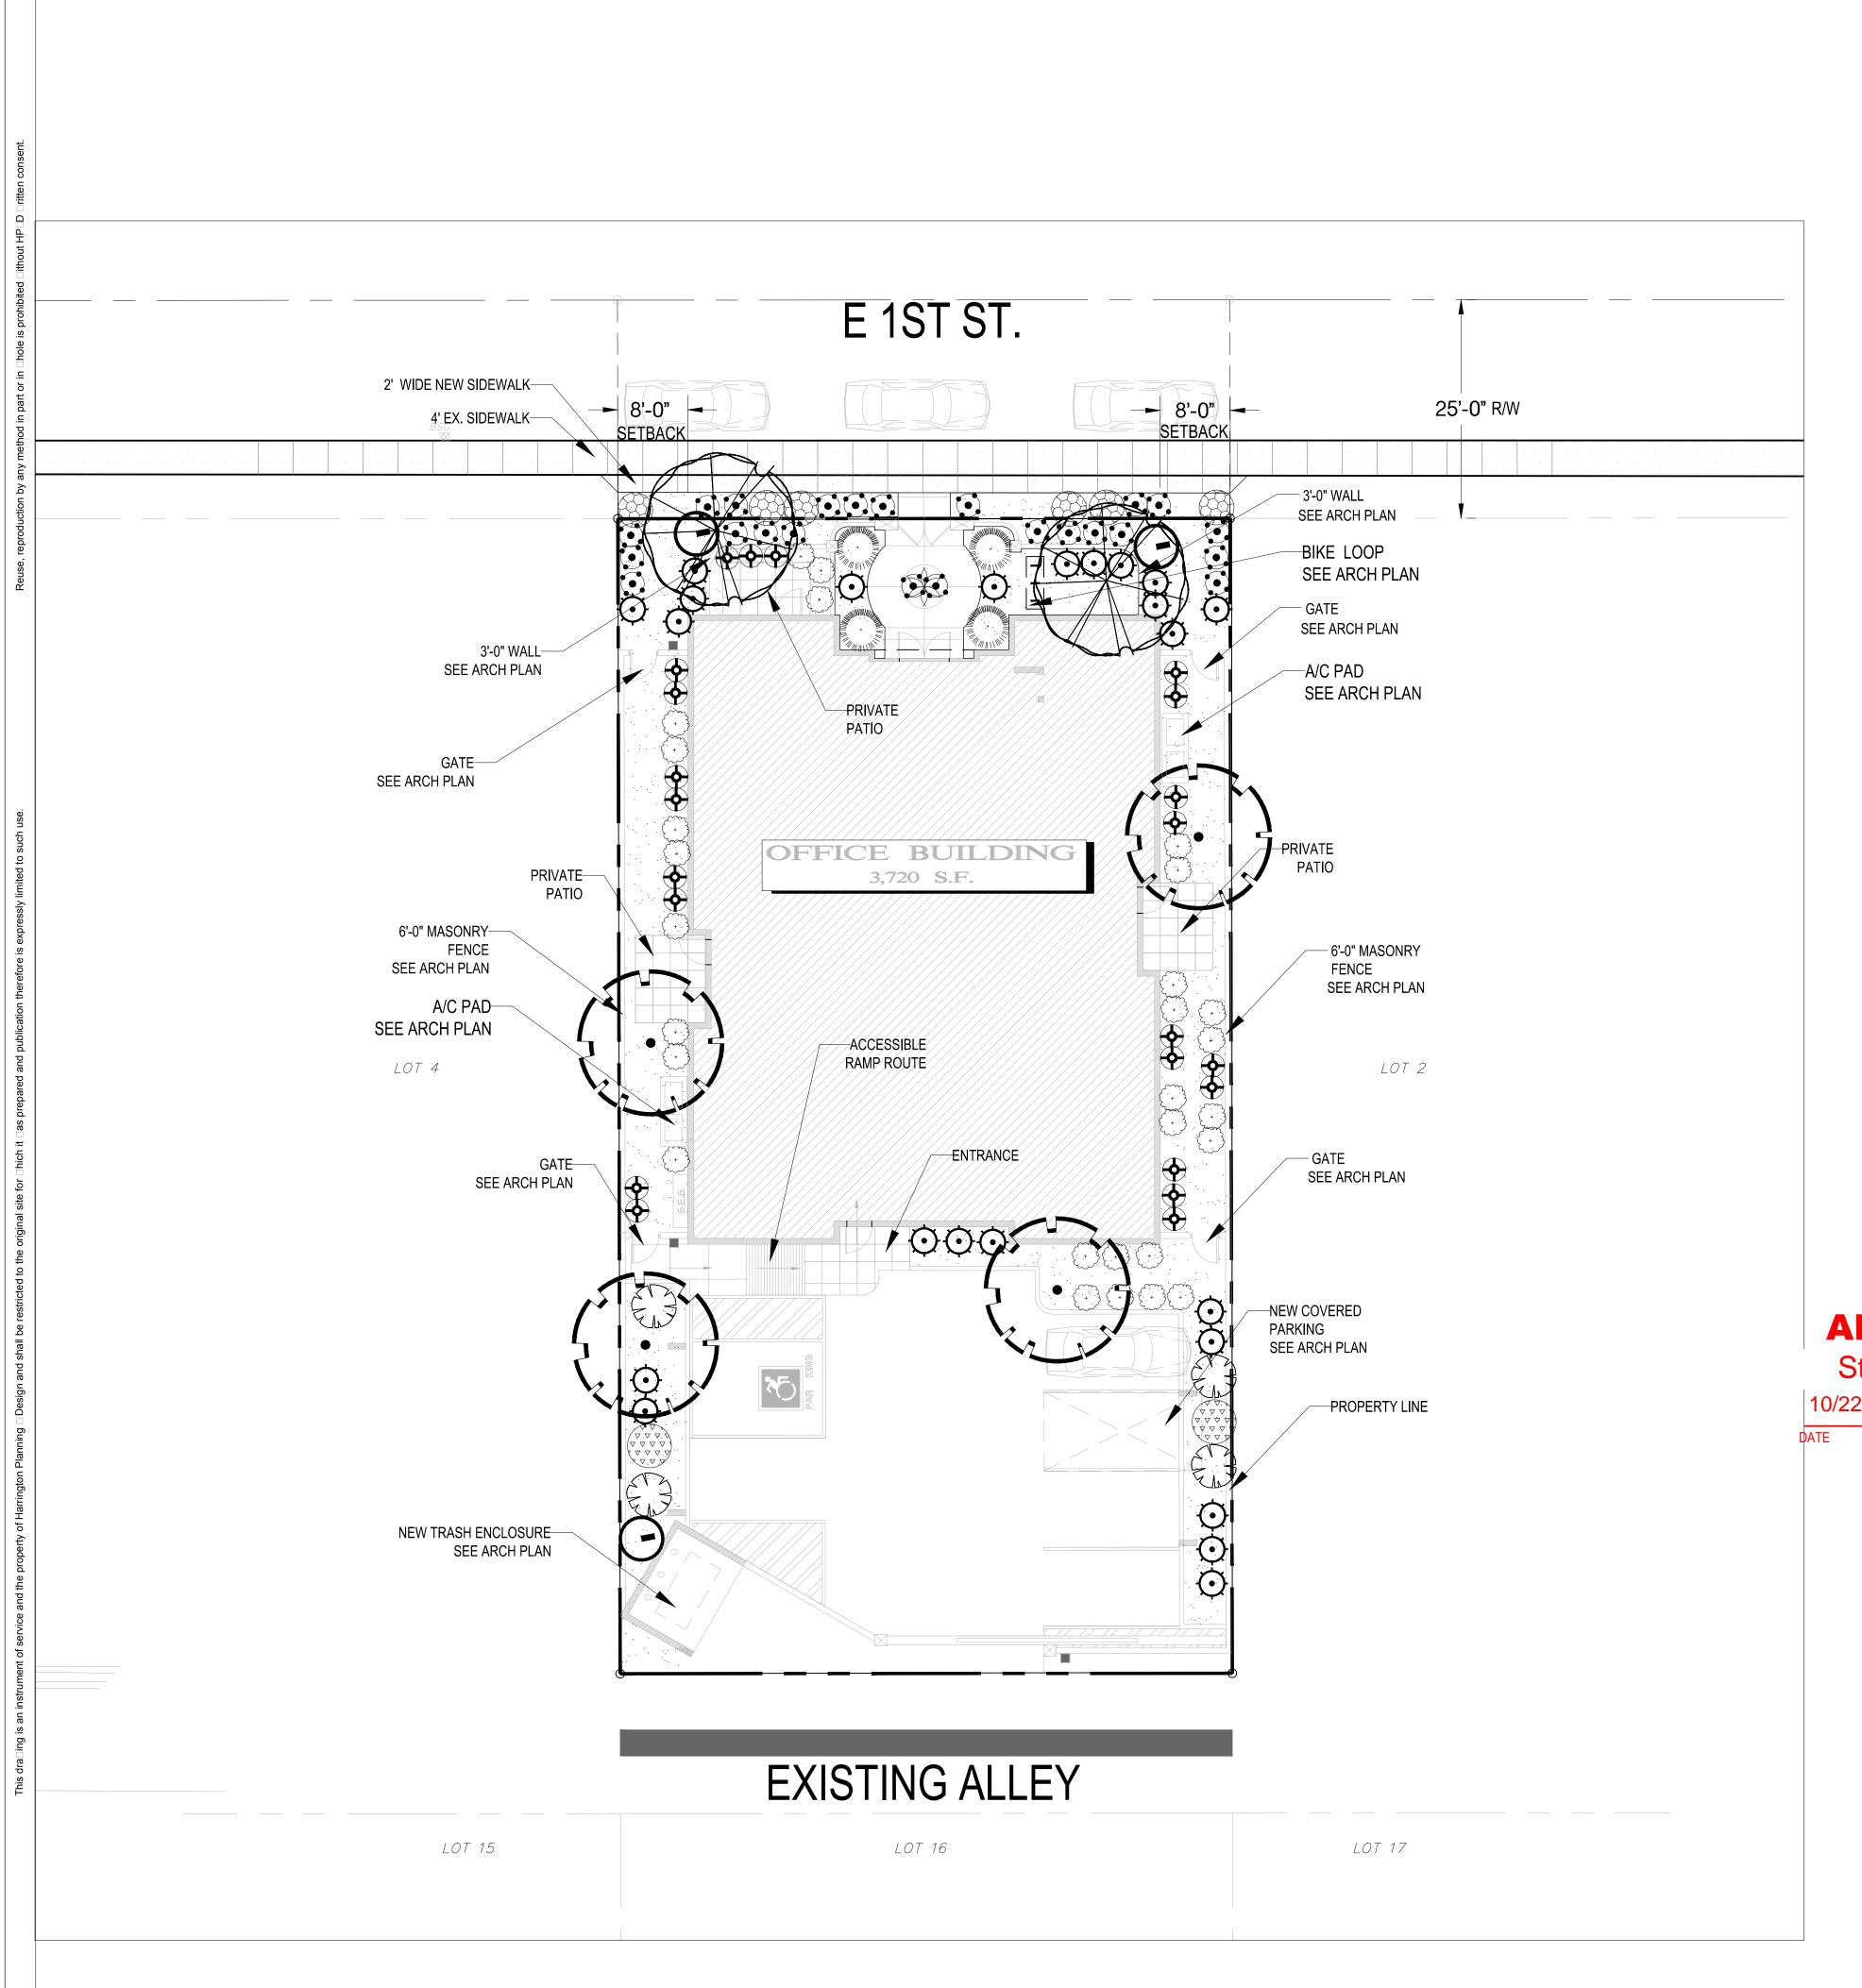

PLANTING MATERIAL LEGEND

	TREES	SIZE	NOTES	QTY
	Chilopsis linearis iburgundy□ Desert Willo□ Caliper Si □ 1.5"	24" Box H 6⊡W 4□	Standard trun□ □ADWR	4
	Acacia farnesiana Desert S□eet Acacia Caliper Si□e□1.5"	24" Box H 7⊑W 3□	ADWR	2
	GROUNDCOVERS			QTY
	Lantana montevidensis Trailing Lantana 'Gold□	5 Gallon	□ADWR	2
	Lantana mo.	5 Gallon	□ ADWR	4
	Convolvulus mauritanicus Ground Morning Glory	1 Gallon	□ADWR	6
\Phi	Melampodium leucanthum Blac foot Daisy	1 Gallon	□ ADWR	24
	SHRUBS / ACCENT	S		QTY
	Ruellia californica Baīa Ruellia	5 Gallon Can Full	□ADWR	4
	Muhlenbergia capillaris Regal Mist Grass	5 Gallon	□ADWR	23
\odot	Aloe hybrid Blue Elf□ Blue Elf Aloe	5 Gallon	□ A DWR	23
9	Hesperaloe parviflora Red Yucca	5 Gallon	□ ADWR	3
	Salvia greggii Autumn Sage	5 Gallon	□ADWR	28
	Agave murpheyi Murphy∖s Agave	5 Gallon	□ADWR	1
X	LANDSCAPE MATE	RIALS		
	5 10 11 0/41 1	oue Everees Ari	⊡ona Gold 2" deep ir	2,305 s

□ADWR □ Ari □ona Department of Water Resources Approved Lo □-Water Use Plant

□SVT □ Sight Visibilty Triangle

LANDSCAPE NOTES

FIELD VERIFY EXISTING SITE PRIOR TO BID AND CONSTRUCTION.
 REFER TO CIVIL ENGINEERING PLANS FOR VERTICAL AND HORIZONTAL CONTROL

3. PROTECT ALL UTILITIES DURING CONSTRUCTION.

APPROVEDStipulation Set

10/22/2019 bmoriarit


APPROVED Y

HARRINGTON
PLANNING DESIGN

3116 S. Mill Avenue, Suite 305
Tempe, Ari ona 85282
Tel 480-250-0116
DESIGN



SIMONSON BUILDING PROFESSIONAL OFFICE

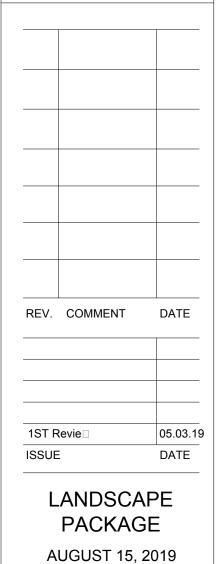


DRAWN BY SL

CHECK BY SL

PRO NO. 2019-016

CASE NO. NA

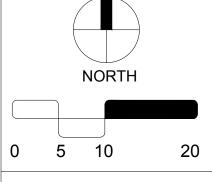

LANDSCAPE PLAN


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ARIZONA BLUESTAKE

CENTER

CALL TWO WORKING DAYS
BEFORE YOU DIG

1.800.782.5348

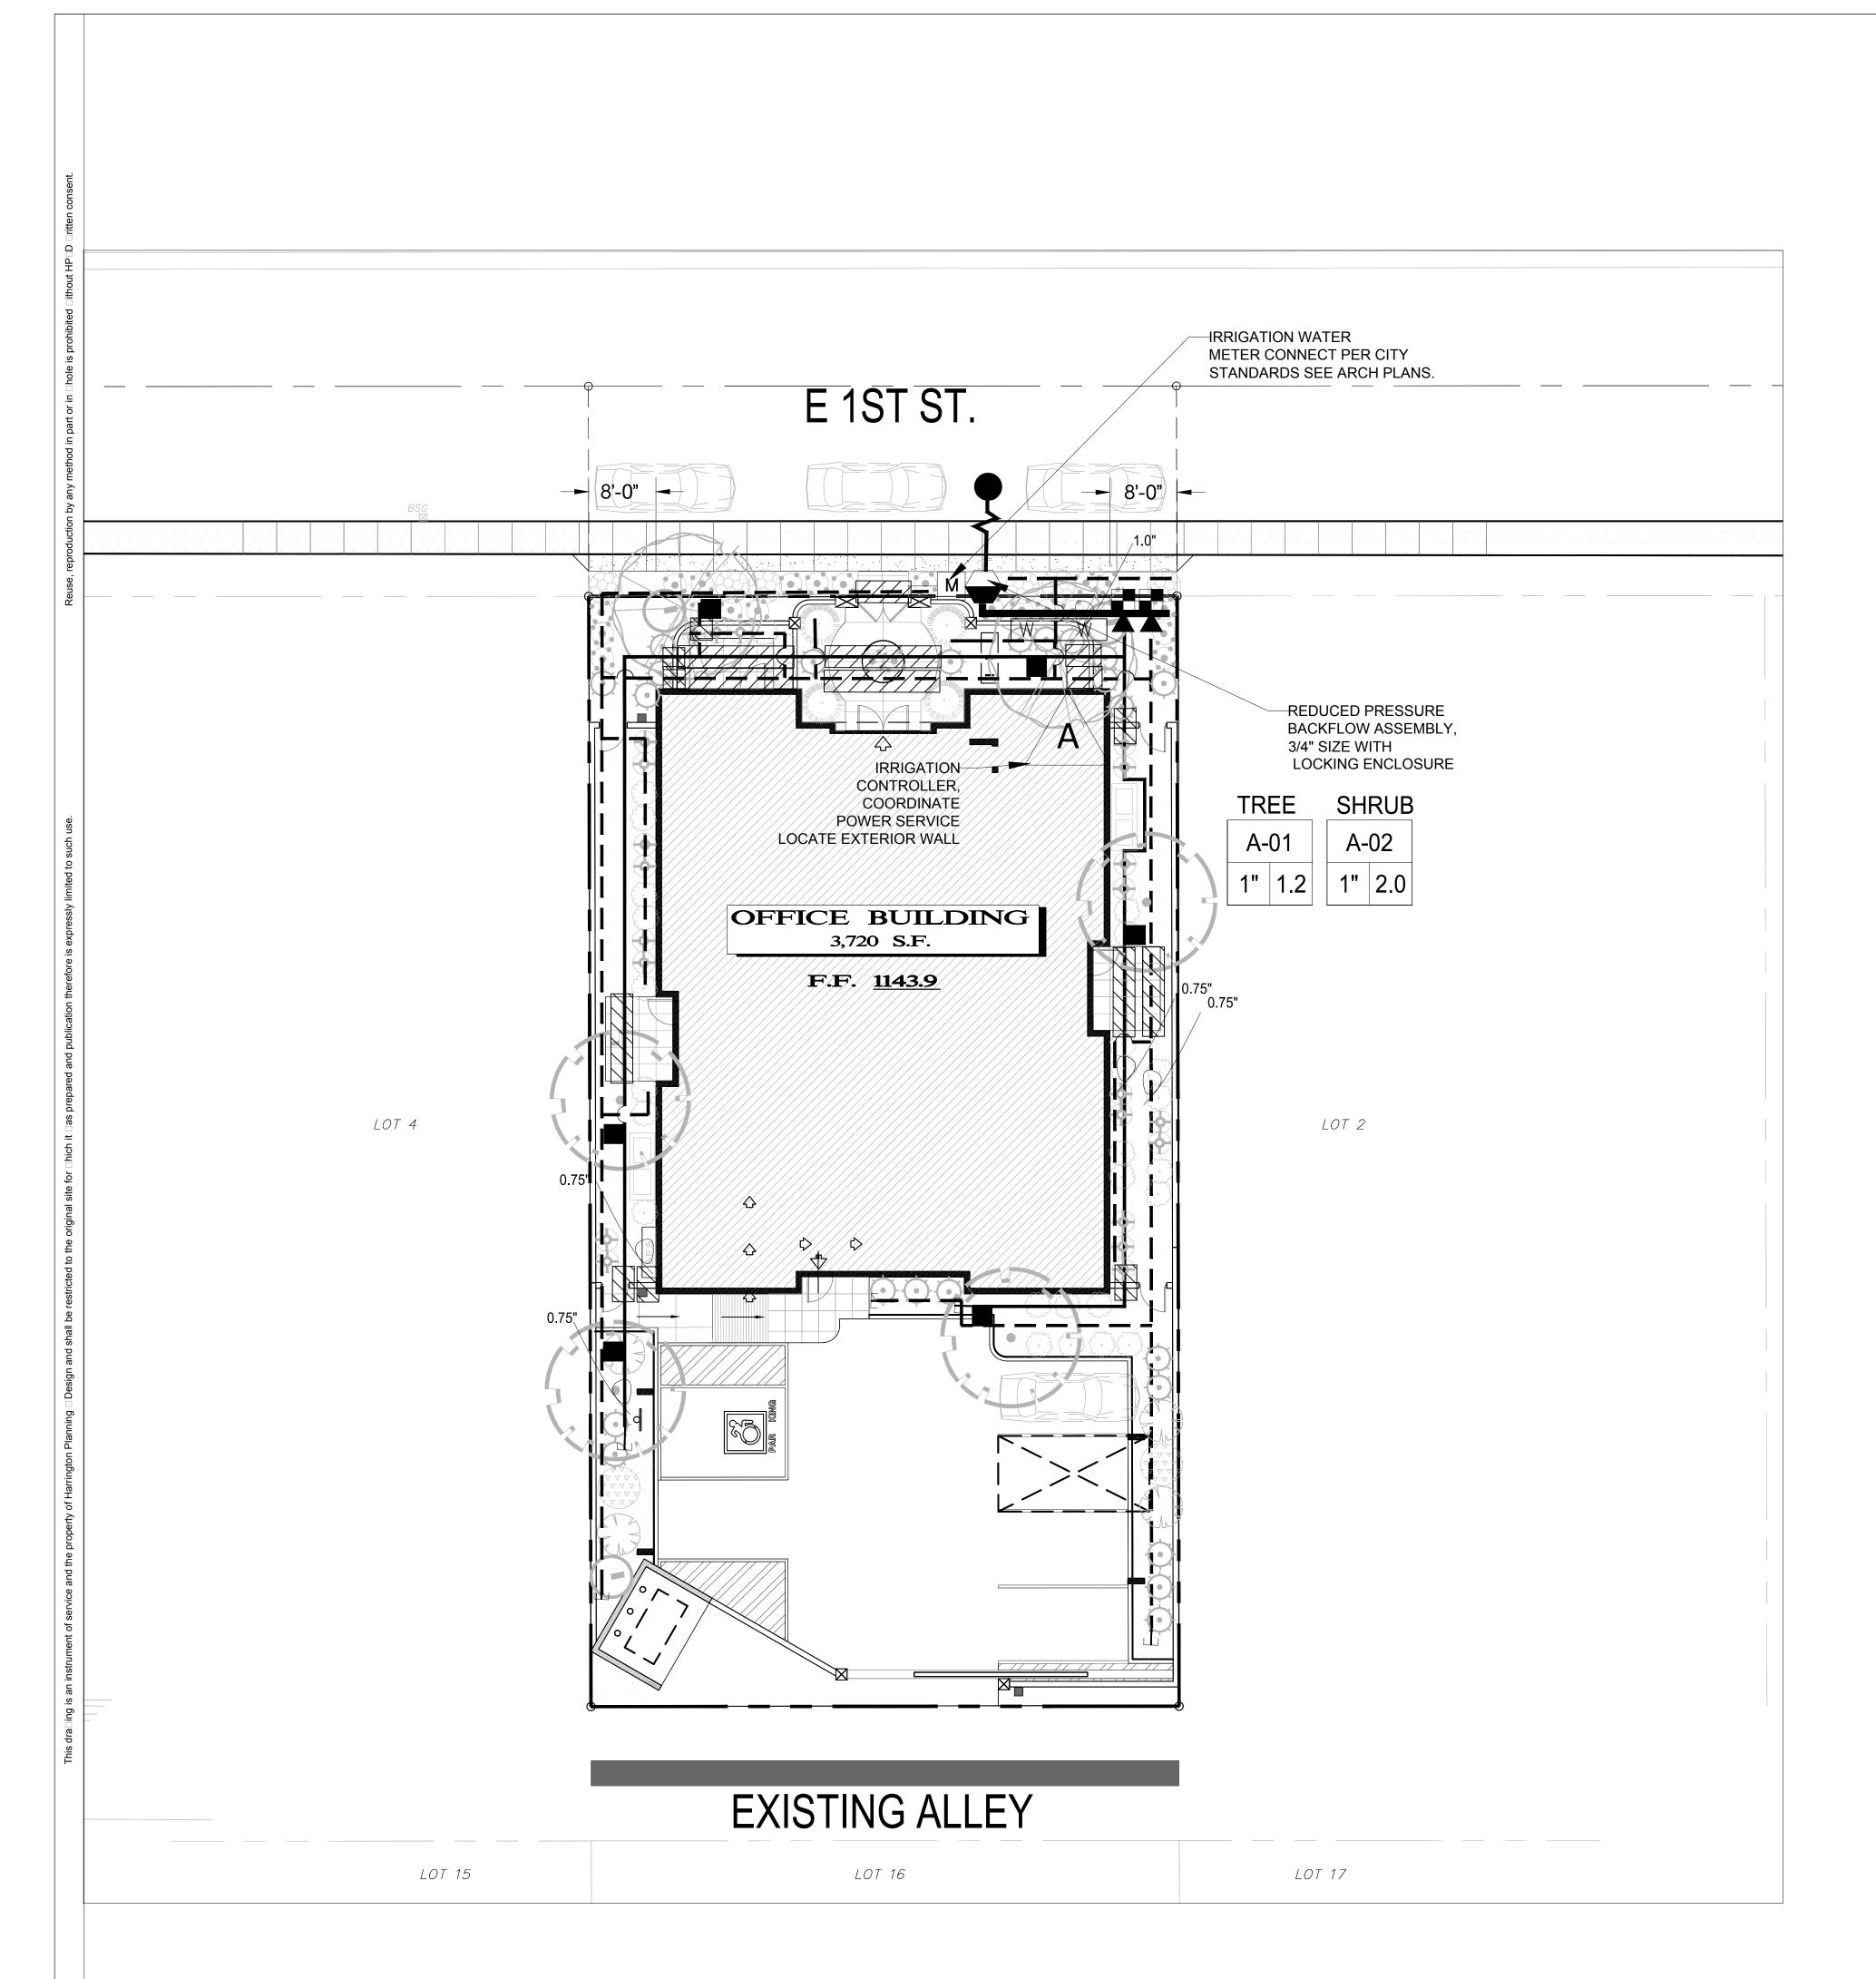

IRRIGATION LEGEND

SYSTEM DESIGNED USING A RESIDUAL PRESSURE OF 80 PSI

SYMBOL

RAIN BIRD ESP-ME RESIDENTIAL CONTROLLER, 4 STATION. ESP4MEI MODEL WALL MOUNT - METAL ENCLOSURE PAINT TO MATCH ARCHITECTURE

FINISH WHERE MOUNTED. BACKFLOW PREVENTER ASSEMBLY, FEBCO 825YA,

WITH ENCLOSURE PER CITY OF SCOTTSDALE STD

MAINTAINED DURING CONSTRUCTION.

CONNECT TO EX. DRIP VALVES, FIELD VERIFY LOCATION. EX. DRIP VALVE ASSEMBLY TO BE

PRESSURE REG. SENNIGER 30 PSI - LOCATE IN SEPARATE BOXES MEDIUM FLOW 2-20GPM - 30 PSI (100 MESH)

SPEARS FLUSH CAP 1/2" FLUSH VALVE

BOWSMITH N/S EMITTER - SP 1.0 GPH (1 PER PLANT)

BOWSMITH 1.0 GPH 6 PORT (2 PER TREE) GROUPS OF SHRUBS WITHIN 6

EXISTING/ NEW TREES RECEIVE DEEP WATER

FOR EMITTERS

SERVICE POINT CONNECT TO EXISTING MUNICIPAL POTABLE WATER SERVICE

MAINLINE - 1" SIZE PVC SCH. 40

TREE LATERAL

SHRUB LATERAL

PVC SCH. 40 - SOLVENT WELD

PVC SCH. 40 - SOLVENT WELD PIPE SLEEVE

PVC SCH. 40 - 2 X PIPE SIZE MINIMUM WIRE SLEEVE

PVC SCH. 40 - 1 1/2" SIZE

SITE IRRIGATION NOTES


- 1. FIELD VERIFY EXISTING SITE PRIOR TO BID AND CONSTRUCTION. 2. REFER TO CIVIL ENGINEERING PLANS FOR VERTICAL AND HORIZONTAL
- 3. PROTECT ALL UTILITIES DURING CONSTRUCTION. 4. OWNER SHALL MAINTAIN ALL LANDSCAPING FOR THIS PRO ECT.






□□.HarringtonPlanningDesign.com

SIMONSON BUILDING PROFESSIONAL OFFICE

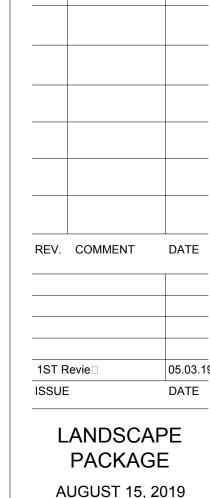

AUGUST 15, 2019

DRAWN BY□ SL CHECK BY□ SL PRO□ NO.□ 2019-016 CASE NO.□ NA

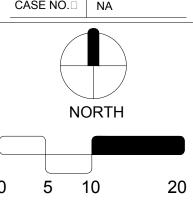

IRRIGATION PLAN

3 of 6


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pii2019-hpdi2019-016 - api - simonson buildingii04 - cadii01 - plotsii2019-016 - simonson building - I 2.0 - ir plan.dig iis-08a 8/16/2019 10ii25 AM



DEPTH OF

ROOTBALL

TREE PLANTING

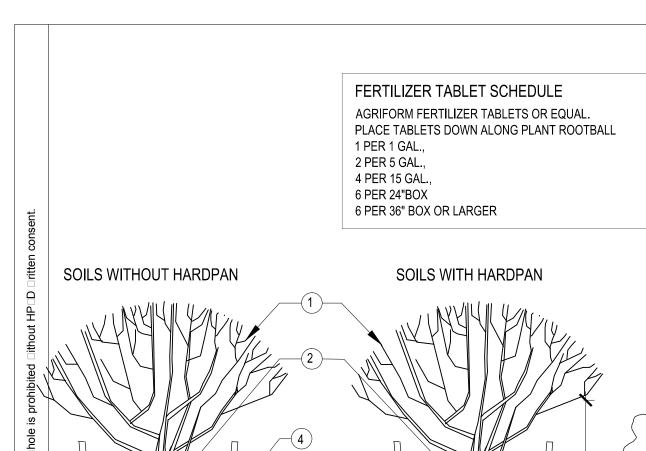3-4 X DIA.

ROOTBALL

PLAN VIEW

SECTION

SCALE: N.T.S.

(1) TREE, REF PLANTING LEGEND (2) TREE STAKE, REF. STAKING DETAIL (3) WALLS OF UNDISTURBED SOIL SHOULD BE SLOPED WITH ROUGH EDGES.

(4) TOP OF ROOTBALL FLUSH OR SLIGHTLY ABOVE FINISH GRADE

5 PLACE ROOTBALL ON UNDISTURBED SOIL (6) FREE OR CUT CIRCLING ROOTS (UNLESS PLANTS ARE KNOWN TO HAVE SENSITIVE

DISTURBANCE) (7) BACKFILL: PER SOIL AMENDMENT MIX OR NATIVE MATERIAL IF NONE DESCRIBED


ROOTS HANDLED WITH MINIMAL


(8) FERTILIZER TABLET. REFER TO FERTILIZER TABLET SCHEDULE


9 UNDISTURBED HARDPAN

(10) DIG A MIN. OF 3 DRAINAGE CHIMNEY HOLES BESIDE ROOT BALL AND THROUGH HARDPAN

1. TRIM AND MAINTAIN TO PROVIDE A MINIMUM 8'-0" CLEARANCE FROM ADJACENT PATH OR PAVEMENT TO TREE

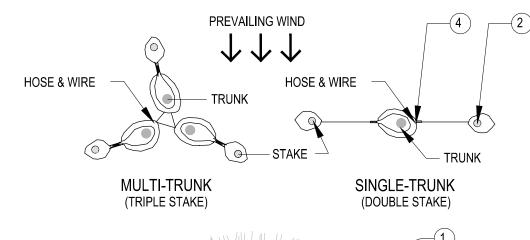

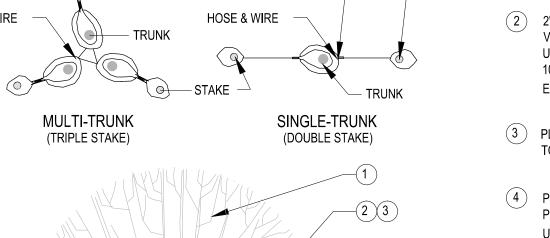

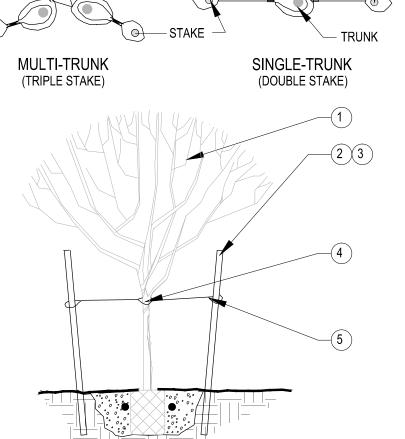

(1) TREE PLANTING, REF. DETAIL

(2) 2" DIA. LODGEPOLE OR 2" SQ. STAKES DRIVEN VERTICALLY OR SLIGHT ANGLE IN UNDISTURBED SOIL. 8' TALL FOR #15 GAL. SIZE, 10' TALL FOR 24" BOX OR LARGER NOTCH EACH STAKE WITH $\frac{3}{4}$ " CUT TO SECURE WIRE AT

3 PLACE OR CUT STAKES OFF BELOW THE CANOPY TO PREVENT DAMAGE TO OVERHEAD BRANCHES

(4) PLACE HOSE AND WIRE 6" ABOVE STRESS POINT OF TREE. NOTCH BACKSIDE OF POLY. USE $\frac{1}{2}$ " ID RUBBER HOSE 12"-15" LONG MIN.

(5) #12 DOUBLE STAND GALVANIZED WIRE, WRAP MINIMUM TWICE AROUND STAKE AND SECURE. WRAP MINIMUM OF 5X TO TIGHTEN WIRE END

1. TYPICALLY, LARGE SALVAGED TREES DO NOT NEED STAKING. 2. THE CONTRACTOR MAY USE THEIR OWN DISCRETION IN STAKING TREES OF 52" BOX OR LARGER AND SHOULD REVIEW SITE SPECIFIC CONDITIONS AND EACH TREE TO DETERMINE IF

4. DOUBLE STAKE SINGLE TRUNK TREES. TRIPLE STAKE MULTI-TRUNK TREES.

3.DO NOT DISTURB IRRIGATION SYSTEM DURING

STAKING IS NECESSARY.

DEPTH OF ROOTBALL

3X DIA. ROOTBALL

1 PLANT, REF. PLANT LEGEND

(2) WALLS OF UNDISTURBED SOIL SHOULD BE SLOPED WITH ROUGH EDGES

(3) TOP OF ROOTBALL FLUSH OR SLIGHTLY ABOVE FINISH GRADE

(4) PLACE ROOTBALL ON UNDISTURBED SOIL

6 BACKFILL:

5 FREE OR CUT CIRCLING ROOTS (UNLESS PLANTS ARE KNOWN TO HAVE SENSITIVE ROOTS HANDLE WITH MINIMAL DISTURBANCE)

> PER SPECIFIED SOIL AMENDMENT MIX, OR NATIVE MATERIAL IF NONE DESCRIBED. REMOVE ALL ROCK 1" OR GREATER FROM BACKFILL

7 FERTILIZER TABLET. REFER TO FERTILIZER

TABLET SCHEDULE (8) INERT MULCH OR DG. REFER TO PLANT

1. PROVIDE ADEQUATE DRAINAGE. REFER TO DETAIL


REGARDING SOILS WITH HARDPAN OR CALICHE.

FERTILIZER TABLET SCHEDULE AGRIFORM FERTILIZER TABLETS OR EQUAL. PLACE TABLETS DOWN ALONG PLANT ROOTBALL 1 PER 1 GAL., 2 PER 5 GAL.,


4 PER 15 GAL., 6 PER 24"BOX 6 PER 36" BOX OR LARGER

TREE STAKING DETAIL



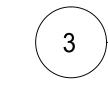

SHRUB PLANTING SCALE: N.T.S.

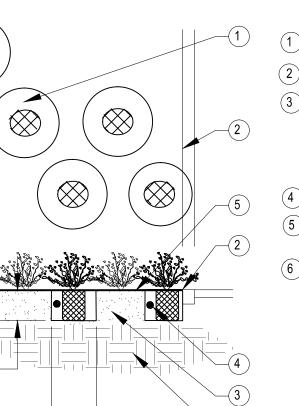

2X DIA.

ROOTBALL

4-5 X DIA.

MIN. 8'-0"

1 GROUNDCOVER / PLANT MATERIAL.

(2) EDGE OF PLANTING BED

(3) 12" TILL NATIVE SOIL BED OR BACKFILL SOIL MIX: 1 PART MULCH TO 3 PARTS TOPSOIL PLANTING PIT SIZES: 1 GAL. OR 5 GAL.: 2X WIDTH OF ROOTBALL DEPTH-2X WIDTH OF ROOTBALL

(4) PLANT FERTILIZER TABLET

1 PER 1 GAL.,

2 PER 2 GAL.,

3 PER 15 GAL. 4 PER 24"BOX

6 PER 36" BOX OR LARGER

(1) DECOMPOSED GRANITE PER

(2) CONCRETE CURB OR WALK PER

3 ENSURE PLANTING AREAS ARE

FREE OF DEBRIS AND WEEDS.

COMPACT TO 85% PROCTOR

DENSITY. PRE-TREAT FINISH

PRE-EMERENT CHEMICAL

GRADED LANDSCAPE AREAS WITH

PLANTING LEGEND.

CIVIL PLANS.

APPLICATION.


(5) INSTALL 2" THICK MULCH LAYER, REF. LEGEND FOR MULCH MATERIAL / INERT MATERIAL

(6) NATIVE SUBGRADE OR COMPACT FILL TO 85% STANDARD PROCTOR DENSITY

FERTILIZER TABLET SCHEDULE

AGRIFORM FERTILIZER TABLETS OR EQUAL.

PLACE TABLETS DOWN ALONG PLANT ROOTBALL

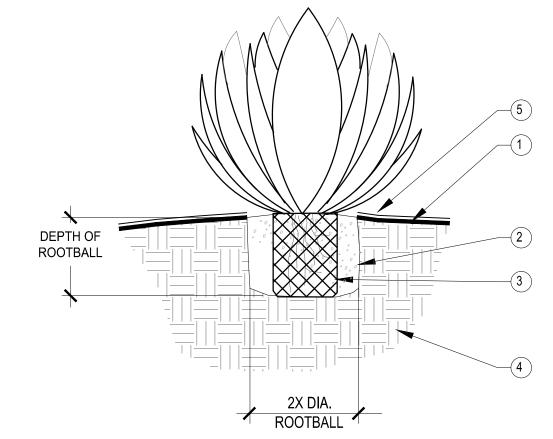

1) FINISH GRADE. SLOPE AWAY FROM BASE OF PLANT

2 PLANTING PIT TO BE AS DEEP AS ROOTS

(3) BACKFILL TO BE NATIVE SOIL TREATED WITH SOIL SULFUR. HAND TAMP IN PLACE. WATER ONLY AT TIME OF PLANTING

(4) NATIVE SOIL. REMOVE ROCK 1" OR LARGER FROM BACKFILL

1. IN AREAS WHERE CALICHE OR HARDPAN OCCURS

BENEATH THE ROOTS, BORE THROUGH IT WITH AN 8"

2. PLANT AT SAME LEVEL AS FINISH GRADE OF ORIGINAL

DIAMETER HOLE 12" DEEP.

SOIL LINE OF BASE OF PLANT.

(5) INERT MULCH OR DG. REFER TO LEGEND

1. COORDINATE FINAL GRADES WITH LANDSCAPE ARCHITECT AND PER PLANS. 2. REAPPLY DG TO AREAS THAT SETTLE 3.WET DG ROCK AFTER INSTALL TO REMOVE DUST AND SETTLE ROCK. 4. WASH DG FROM ADJACENT PAVEMENTS. 5. APPLY POST EMERGENT WEED CONTROL AFTER LANDSCAPE INSTALL COMPLETED.

1 DECOMPOSED GRANITE PER PLANTING

FINISH GRADE PER PLANS (2) ENSURE PLANTING AREAS ARE FREE OF DEBRIS AND WEEDS COMPACT TO 85% PROCTOR DENSITY. PRE-TREAT FINISH GRADED LANDSCAPE AREAS WITH

PRE-EMERENT CHEMICAL APPLICATION

3

NOTES: 1. REF. PLAN FOR DESIGN AND SPACING. GROUNDCOVER PLANTING

DEPTH OF

ROOTBALL






ACCENT PLANTING - CONTAINER [/] SCALE: N.T.S.



GRANITE INSTALLATION

LANDSCAPE

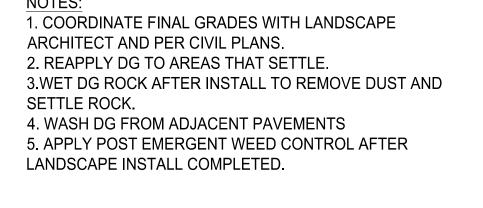

CONCRETE / GRANITE TRANSITION

SCALE: N.T.S.

p 2019-hpd 2019-016 - api - simonson building 04 - cad 01 - plots 2019-016 - simonson building - I 3.0 - Is details.d □ □ s-08a 8/15/2019 10 41 AM

1ST Revie□ 05.03.19 DATE ISSUE LANDSCAPE **PACKAGE** AUGUST 15, 2019 DRAWN BY□ SL CHECK BY□ SL PRO□ NO.□ | 2019-016 CASE NO.□ NA

REV. COMMENT

HARRINGTON

PLANNING DESIGN

3116 S. Mill Avenue, Suite 305

Tempe, Ari⊡ona 85282

Tel 480-250-0116

44161

□ASON E.

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DETAILS

4 of 6

ARIZONA BLUESTAKE CENTER CALL TWO WORKING DAYS

BEFORE YOU DIG 1.800.782.5348 SCALE: N.T.S.

CONTROLLER, WALL MOUNT

(1) WALL MOUNTED CONTROLLER. PROVIDE LOCKING ENCLOSURE.

LOCATE PER PLAN. (2) PVC SCH 40 ELL SWEEP FOR ELECTRICAL CONDUIT

(3) STEEL CONDUIT.

(4) COMPACT SOIL AROUND CONTROLLER CONDUIT TO SAME DENSITY AS UNDISTURBED 5 ADJACENT SOIL.

(5) FINISH GRADE / TOP OF DG.

(6) WALL SURFACE. (7) CONTROL VALVE WIRES AND SENSOR WIRE

(8) 120V POWER AND GROUND SOURCE. COORDINATE WITH ELECTRICAL CONTRACTOR. (9) J-BOX.

INSTALL WIRING PER LOCAL CODE AND MFG. RECOMMENDATIONS.

PROVIDE LIGHTNING PROTECTION AND

GROUNDING FOR CONTROLLER. PROVIDE LOCK FOR CONTROLLER ENCLOSURE. 4. PLACE WEATHERPROOF COPY OF CONTROLLER

ALLOW 3 FT. CLEARANCE IN FRONT OF CONTROLLER ENCLOSURE DOOR FOR ACCESS. PROVIDE WATERPROOF SEALANT FOR ALL

SCHEDULE INSIDE ENCLOSURE.

CONTROLLER OPENINGS. PAINT ENCLOSURE PER LEGEND OR OWNER DIRECTION.

24" Max. Inlet 48" Min. Hard Copper Inlet As Close To On Outlet Side Service Connection As LIST OF MATERIALS Possible (Immediately 1 Approved reduced pressure principle backflow After Water Meter). prevention assembly, ball valves included. Pipe spool, type "L" hard copper, 3/4" thru 2 1/2". Hard Copper On Inlet Side. 90° ell, copper, 3/4" thru 2 1/2".

Pipe union, brass or copper. Test cocks with brass plugs or adaptors with caps installed. (4 Required)

REDUCED PRESSURE PRINCIPLE BACKFLOW APPROVED BY: City of Scottsdale | Scottsdale Standards & Standard Details Specifications Committee ASSEMBLY FOR ASSEMBLIES 3/4 INCH THRU 2 1/2

BACKFLOW PREVENTER - CITY OF SCOTTSDALE STANDARD 2354

(1) PRESET PRESSURE REGULATOR, 30 PSI OR PER LEGEND.

(2) PVC SCH 80 FITTINGS.

(3) PVC SCH 40 MAINLINE / LATERAL. (4) COMPACT SOIL AROUND PRESSURE

REGULATOR ASSEMBLY TO SAME DENSITY AS UNDISTURBED ADJACENT SOIL. 5) FINISH GRADE / TOP OF DG.

(6) 12" VALVE BOX WITH LOCKING COVER, CARSON, AMETEK, OR APPROVED EQUAL. COLOR TO BE TAN IN DG, GREEN IN TURF. $(7)\frac{3}{8}$ " WASHED PEA GRAVEL SUMP, 1 CU. FT.

8 PCV ELL 3" HT SWIVEL W/ SCHRADER PRESSURE CHECK VALVE.

LEGEND. (10) PVC SCH 80 UNION.

(12"X12"X12") MIN.

NOTE:

1. SET VALVE BOX PARALLEL WITH GRADE.

(9) PVC SCH 40 LATERAL OR PER IRRIGATION


2. SEAL THREADED JOINTS WITH TEFLON .

3. DO NOT REST VALVE BOX ON MAIN LINE.

4. LOCATE ONLY 1 PRESSURE REGULATOR PER VALVE BOX. PROVIDE SUPPORT BRICKS TO VALVE BOX AS NECESSARY.

6. PROVIDE STAINLESS STEEL FASTENERS FOR LOCKING COVER.

PRESSURE REGULATOR - DRIP VALVE

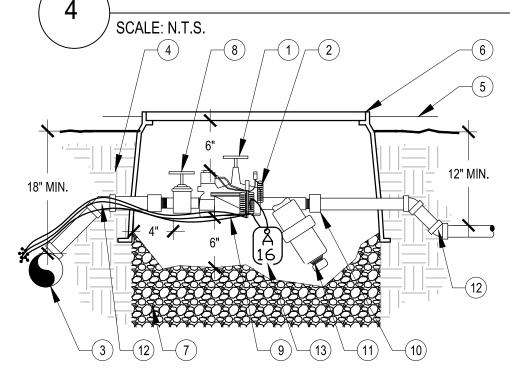

1. PROVIDE EXPANSION COILS AT EACH WIRE CONNECTION IN VALVE BOX. (WRAP WIRE AROUND PIPE 15 TIMES).

2. SET VALVE BOX PARALLEL W/ GRADE. SEAL THREADED JOINTS WITH TEFLON .

4. DO NOT REST VALVE BOX ON MAIN LINE. 5. LOCATE ONLY 1 VALVE ASSEMBLY PER VALVE

6. PROVIDE SUPPORT BRICKS TO VALVE BOX AS NECESSARY.

7. PROVIDE STAINLESS STEEL FASTENERS FOR LOCKING COVER.

> DRIP VALVE ASSEMBLY SCALE: N.T.S.

(1) ELECTRIC REMOTE VALVE PER LEGEND. ig(2ig) EPOXY FILLED CYLINDER WIRE CONNECTORS.

(3) PVC SCH 40 MAINLINE.

(hinspace 4 hinspace) COMPACT SOIL AROUND CONTROL VALVE PIT ASSEMBLY TO SAME DENSITY AS UNDISTURBED ADJACENT SOIL.

(5) FINISH GRADE / TOP OF DG.

 $ig(\ 6 \ ig)$ 12" VALVE BOX WITH LOCKING COVER, CARSON, AMETEK, OR APPROVED EQUAL. TAN COLOR IN DG, GREEN IN TURF.

(7) $\frac{3}{8}$ WASHED PEA GRAVEL SUMP, 2 CU. FT MIN.

(8) PVC ISOLATION BALL VALVE.

 $(\ 9\)$ Controller wire, tape and bundle at 10' intervals.

(10) PVC SCH 80 UNION.

11) WYE FILTER (#150 MESH) WITH STAINLESS STEEL SCREEN,

POSITION TO ONE SIDE AND DOWNWARD.

(12) PVC SCH 80 FITTINGS.

(13) VALVE TAG. STANDARD VALVE I.D. AND LETTER TO CORRESPOND TO CONTROLLER AND VALVE NUMBER. AFFIX TO CONTROL WIRE W/ ELECTRICAL WIRE TIE.

1) SCH. 40 PVC SLEEVE. TWICE DIAMETER OF SERVICE PIPE, SEE SLEEVE/PIPE

(2) WASHED AND GRADED MORTAR SAND BACKFILL IN ROCKY SOIL CONDITIONS.

GENERAL NOTES

hard copper.

backfilling trench.

Research Corporation.

1. Backflow assemblies must be tested by a certified tester that is recognized by the

2. Copper fittings shall be connected with lead free solder joints or approved equal.

3. Finished grade underneath the backflow pre-

Approvals for backflow assemblies must have

Seal Approval from the American Society of

Sanitation Engineers. Backflow assemblies

installed on fire supression systems must

also have approval from Underwriters

Laboratories and/or Factory Mutual

venter shall be at 95% compaction.

5. Inlet / outlet piping must be type "K"

6. Call for underground inspection before

4. All nipples to be copper or brass.


(3) PAVING.

(4) COMPACT SOIL AROUND SLEEVE TO SAME DENSITY AS UNDISTURBED ADJACENT

(5) FINISH GRADE / TOP OF DG.

(6) DISCRETELY PAINT OR MARK EDGE OF PAVING, CURB, OR WALK AT SLEEVE

(8) EXTEND SLEEVES 12" BEYOND EDGES.

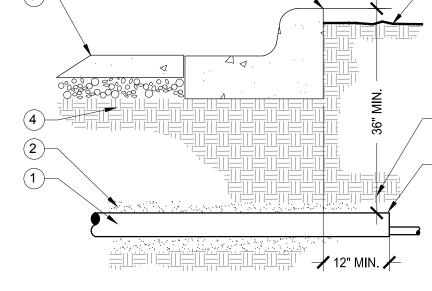

IN WATER SLEEVES.

NOTES:

1. CAP SLEEVES UNTIL USE.

2. MULTIPLE SLEEVES REQUIRE 4"

SEPERATION WITHIN SAME SLEEVE

3. PROVIDE SEPERATE WATER LINE AND WIRE SLEEVES AS REQUIRED. NO WIRES

IRRIGATION SLEEVE

SCALE: N.T.S.

SOIL.

LOCATIONS. (7) 36" MIN. DEPTH OR PER LOCAL CODE.

BACKFLOW PREVENTER ENCLOSURE

1. CONCRETE PAD SHALL BE SET PARALLEL W/ GRADE.

3. SET EYEBOLT WITH BOTTOM OF CIRCLE FLUSH WITH

4. BOLT BRACKET TO ENCLOSURE ON ENDS OR BOTH

SIDES. USE 1/4"X 1 1/4" TAMPER-PROOF BOLTS WITH

CONCRETE BASE THEN EYEBOLT CANNOT BE

2. TEFLON SEAL ALL THREAD JOINTS.

TURNED WHEN BRACKET IS IN PLACE.

HEX NUTS AND WASHERS PROVIDED.

SCALE: N.T.S.

(1) SCH. 40 PVC SLEEVE. TWICE DIAMETER OF

SERVICE PIPE, SEE SLEEVE/PIPE SCHEDULE. (2) WASHED AND GRADED MORTAR SAND BACKFILL IN ROCKY SOIL CONDITIONS.

(3) WALL PER WALL DETAIL.

(4) COMPACT SOIL AROUND SLEEVE TO SAME DENSITY AS UNDISTURBED ADJACENT SOIL.

(5) FINISH GRADE / TOP OF DG. (6) WALL FOOTING PER WALL DETAIL. DO NOT DISTURB FOOTING OR COMPACTION FOR

(8) EXTEND SLEEVES 12" BEYOND EDGES.

MINIMUM OF 12" IN ALL DIRECTIONS. (7) 36" MIN. DEPTH OR PER LOCAL CODE.

(1) METAL BACKFLOW ENCLOSURE, PAINT

(3) 4" CONCRETE PAD, CLASS B (2000 PSI),

EXTEND 4" AROUND ENCLOSURE.

(4) COMPACT SOIL AROUND BACKFLOW

UNDISTURBED ADJACENT SOIL.

(5) FINISH GRADE / TOP OF DG.

(6) TUBE STEEL FRAME,

5. WELD ENCLOSURE SOLID AT ALL JOINTS.

7. MIN. CLEARANCE INSIDE CAGE TO BE 6".

6. TOOL EXPOSED CONCRETE EDGES TO $\frac{3}{4}$ " RADIUS.

ENCLOSURE TO SAME DENSITY AS

(7) EXPANDED METAL, #12 GAUGE, SIDES

PER OWNER DIRECTION.

(2) BACKFLOW PREVENTER.

1. CAP SLEEVES UNTIL USE. 2. MULTIPLE SLEEVES REQUIRE 4" SEPARATION WITHIN SAME SLEEVE TRENCH. 3. PROVIDE SEPARATE WATER LINE AND WIRE

SLEEVES AS REQUIRED. NO WIRES IN WATER

IRRIGATION SLEEVE UNDER WALL

SCALE: N.T.S.

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1ST Revie□ 05.03.19 DATE ISSUE

LANDSCAPE PACKAGE

AUGUST 15, 2019 DRAWN BY□ SL

CHECK BY□ SL PRO□ NO.□ | 2019-016 CASE NO.□ NA

IRRIGATION

5 of 6

DETAILS

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1. SINGLE PORT EMITTER FOR SHRUBS, ACCENTS, AND

GROUND COVERS ONLY. SEAL THREAD JOINTS WITH TEFLON . 3. SLOPE CONDITIONS: PLACE EMITTER ON UPHILL SIDE

OF PLANT. DO NOT DISTURB ROOTBALL WITH PVC PIPE.

INSTALL EMITTERS ONLY AFTER SYSTEM FLUSH OF

6. LATERALS.

1. MULTI PORT EMITTER FOR TREES AND MASSED PLANTS ONLY.

2. TEFLON SEAL ALL THREAD JOINTS.

3. ON SLOPE CONDITIONS, PLACE EMITTER ON UPHILL SIDE OF PLANT.

4. DO NOT DISTURB ROOTBALL WITH PVC PIPE. 5. SPACE EMITTER TUBING EQUALLY AROUND DRIP LINE OF TREE. 6. INSTALL EMITTERS ONLY AFTER SYSTEM FLUSH OF

SCALE: N.T.S.

8. PROVIDE SUPPORT BRICKS TO VALVE BOX AS NECESSARY.

9. PROVIDE STAINLESS STEEL FASTENERS FOR LOCKING COVER.

(1) THREADED PRESSURE COMPENSATING EMITTER. SEE LEGEND FOR SIZE.

2 PVC SCH 80 FITTING, ELL OR TEE.

(3) PVC SCH 40 LATERAL OR PER IRRIGATION LEGEND. (4) COMPACT SOIL AROUND EMITTER TO SAME DENSITY AS

UNDISTURBED ADJACENT SOIL. (5) FINISH GRADE / TOP OF DG.

6 BUG CAP.

7) 1/4" DISTRIBUTION TUBING. LOOP FOR A 5 FT. MAXIMUM LENGTH. NO KINKS IN TUBING.

(8) PVC SCH 80 1/2" NIPPLE RISER, THREADED (LENGTH AS REQUIRED).

9 3" WASHED PEA GRAVEL SUMP, 1/2 CU. FT MIN.

(10) 1/4" DISTRIBUTION TUBE EMITTER STAKE.

(11) 6" VALVE BOX WITH LOCKING COVER, CARSON, AMETEK, OR APPROVED EQUAL. COLOR TO BE TAN IN DG, GREEN IN TURF.

1) BRONZE 1" THREADED FULL-PORT BALL VALVE.

2 PVC SCH 80 FITTINGS.

(3) PVC SCH 40 LATERAL OR PER IRRIGATION LEGEND.

4 COMPACT SOIL AROUND FLUSH CAP ASSEMBLY TO SAME DENSITY AS UNDISTURBED ADJACENT SOIL.

(5) FINISH GRADE / TOP OF DG.

(6) VALVE BOX WITH LOCKING COVER, CARSON, AMETEK, OR APPROVED EQUAL. 10" MIN. SIZE. COLOR TO BE TAN IN DG, GREEN

 $(7)\frac{3}{8}$ " WASHED PEA GRAVEL SUMP, 1 CU. FT MIN.

(8) PVC SCH 80 1/2" NIPPLE RISER (LENGTH AS REQUIRED).

1. SET VALVE BOX PARALLEL W/ GRADE.

2. SEAL THREADED JOINTS WITH TEFLON. DO NOT REST VALVE BOX ON MAIN LINE.


4. LOCATE ONLY ONE FLUSH CAP PER VALVE BOX.

5. PROVIDE SUPPORT BRICKS TO VALVE BOX AS NECESSARY.

6. PROVIDE STAINLESS STEEL FASTENERS FOR LOCKING

COVER.

SINGLE PORT EMITTER W/ DISTRIBUTION TUBING SCALE: N.T.S.

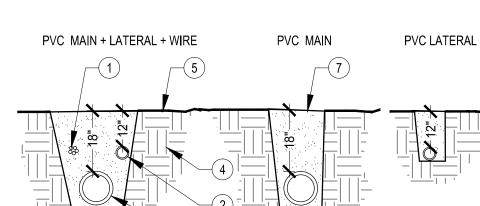

(1) CONTROL WIRE BUNDLE, TAPE AT 10' INTERVALS.

) PVC LATERAL LINE.

(1) PRESSURE COMPENSATING EMITTER,

(2) PVC SCH 80 FITTING, ELL OR TEE.

(5) FINISH GRADE / TOP OF DG.

(6) BUG CAP.

THREADED. SEE LEGEND FOR SIZE.

(3) PVC SCH 40 LATERAL OR PER IRRIGATION LEGEND.

(4) COMPACT SOIL AROUND EMITTER TO SAME

DENSITY AS UNDISTURBED ADJACENT SOIL.

(7) DISTRIBUTION TUBING. LOOP AROUND PVC FOR

A 5 FT MAXIMUM LENGTH. DO NOT KINK

8 PVC SCH 80 1/2" NIPPLE RISER, THREADED (LENGTH AS REQUIRED).

B) PVC SCH 40 MAINLINE. COMPACT SOIL AROUND CONTROL VALVE PIT

ASSEMBLY TO SAME DENSITY AS UNDISTURBED ADJACENT SOIL. FINISH GRADE / TOP OF DG.

S) SNAKE PVC PIPE IN TRENCHES.

COMPACT TRENCH BACKFILL IN 6" LIFTS. DENSITY TO MATCH ADJACENT SOIL CONDITIONS.

1. INSTALL 120 VOLT WIRING IN CONDUIT, PER LOCAL CODES.

2. SLEEVE LINES UNDER PAVING.

3. LOOP WIRE BUNDLES (20" MIN.) AT CHANGES IN TRENCH DIRECTION.

4. PROVIDE PIPE DETECTION TAPE FOR MAINLINE TRENCHES. 5. MAKE WIRE CONNECTION AND SPLICES WITH WATER PROOF CONNECTORS PER MFG.


RECOMMENDATIONS.

6. BACKFILL OF PIPE TRENCHES SHALL HAVE NO ROCK 1" IN SIZE OR LARGER. 7. PROVIDE 2" SAND BEDDING ALL AROUND PIPE IF ROCKY SOILS PRESENT.

TOP VIEW

IRRIGATION TRENCH

SCALE: N.T.S.

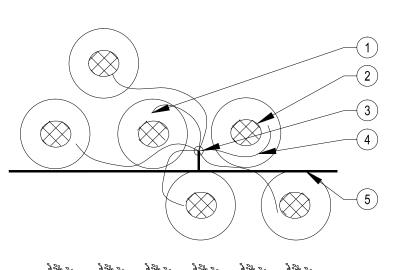

SCALE: N.T.S.

(1) EMISSION POINT (TYP.).

(2) PLANT ROOTBALL (TYP.).

 $ig(\,3\,ig)$ MULTI-PORT EMITTER, SEE EMITTER DETAIL.

(4) DISTRIBUTION TUBE, MAXIMUM LENGTH 5 FT. (TYP.) DO NOT KINK TUBING.

(5) LATERAL PIPE, SCH 40 PVC OR PER IRRIGATION

LEGEND.

NOTES:

1. MORE THAN ONE SHRUB MAY BE WATERED FROM A SINGLE MULTI-PORT EMITTER.

MAXIMUM LENGTH OF DISTRIBUTION

TUBING SHALL BE 5 FEET. 3. IF MORE THAN ONE DISTRIBUTION TUBE


AROUND PLANT ROOTBALL. 4. PLACE EMISSION POINT AT EDGE OF

ROOTBALL ON UPHILL SIDE OF PLANT.

USED PER SHRUB, EQUALLY SPACE

EMITTER LOCATIONS - SHRUBS

MULTIPORT EMITTER WITH DISTRIBUTION TUBING

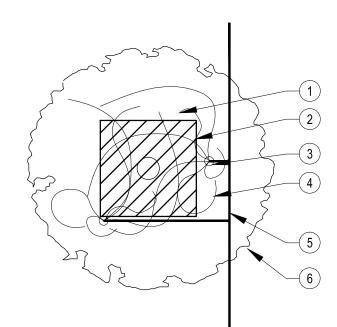

(1) EMISSION POINT (TYP.).

2 PLANT ROOTBALL (TYP.).

(3) MULTI-PORT EMITTER, SEE EMITTER DETAIL.

(4) DISTRIBUTION TUBE, MAXIMUM LENGTH 5 FT. (TYP.) DO NOT KINK TUBING.

5 LATERAL PIPE, SCH 40 PVC OR PER IRRIGATION LEGEND.

6 TREE CANOPY.

1. MAXIMUM LENGTH OF DISTRIBUTION TUBING

SHALL BE 5 FEET. 2. PLACE EMISSION POINT AT EDGE OF ROOTBALL

ON UPHILL SIDE OF PLANT.

3. ADJUST EMITTER LOCATIONS AS DRIPLINE OF TREE INCREASES WITH GROWTH.

4. PLACE 50% OF DISTRIBUTION TUBES OUTSIDE OF TREE ROOTBALL DURING INSTALL FOR FUTURE GROWTH.

STEP 1 STEP 2

[/] SCALE: N.T.S.

DRIP BALL VALVE FLUSH CAP

(1) SLIP BASE SOCKET OVER END OF WIRES.

(2) STRIP WIRES 5" FROM ENDS, TWIST ENDS TOGETHER.

(3) APPLY SEALER TO OUTSIDE OF SEALING PLUG, FILL CAVITY WITH SEALER.

(4) PLACE CRIMP SLEEVE OVER WIRE ENDS, CRIMP

SLEEVE AND BEND OVER EXCESS WIRE.

(5) PLACE BASE SOCKET OVER WIRE END SNUG TO CRIMP SLEEVE.

(6) PUSH SEALING PLUG INTO BASE SOCKET.

(7) PUSH WIRES TO END OF BASE SOCKET TO

ASSURE COMPLETE SEALING OF CONNECTION.. (8) RAINBIRD PEN-TITE WIRE CONNECTOR

1. FOR WIRE SIZES NO. 14, NO. 12, AND NO. 10

APPROVED EQUAL.

EMITTER LOCATIONS - TREES

SCALE: N.T.S.

SCALE: N.T.S.

STEP 4

IRRIGATION WIRE CONNECTIONS

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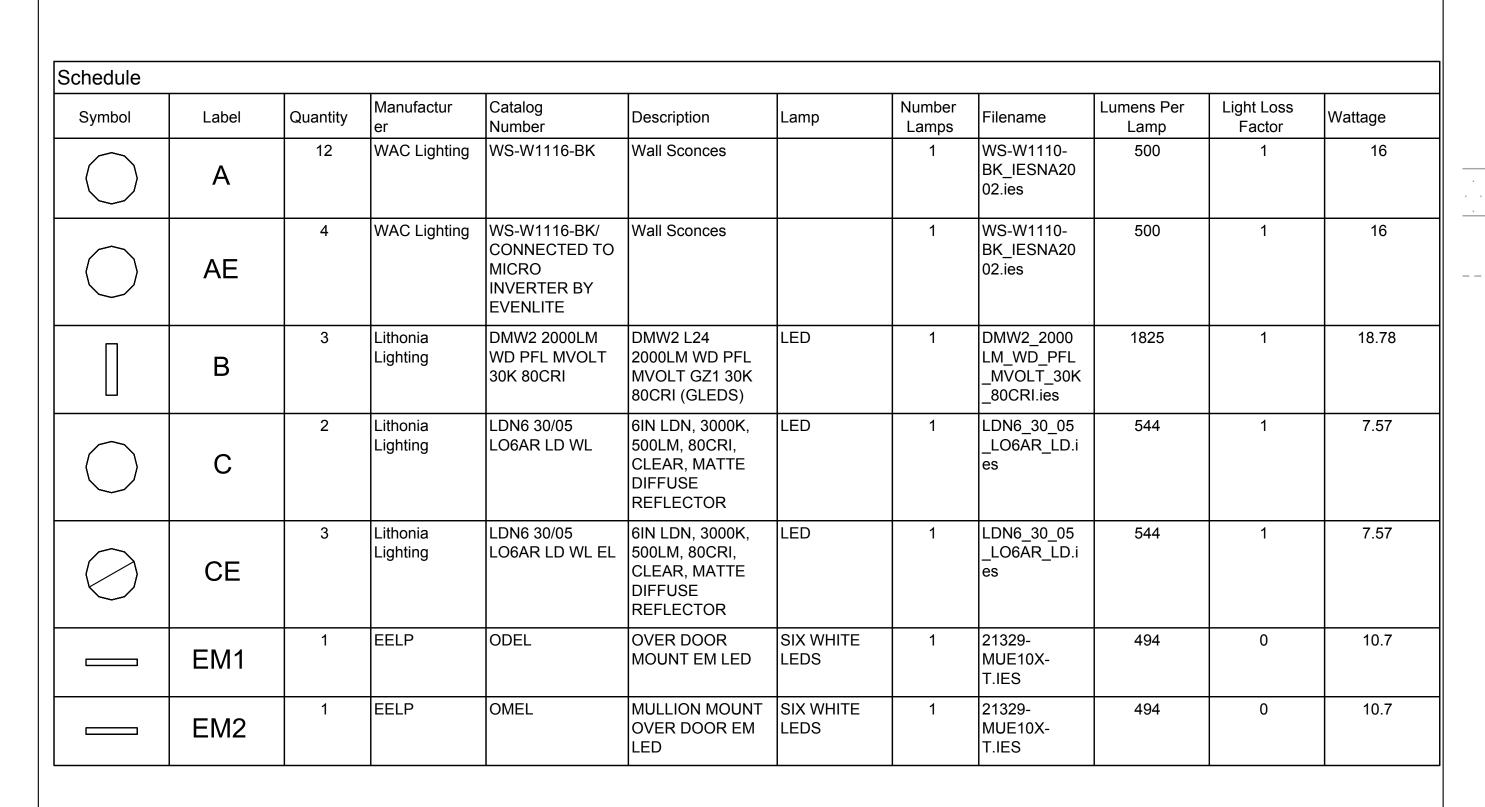
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IRRIGATION DETAILS

6 of 6

ARIZONA BLUESTAKE CENTER

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Statistics						
Description	Symbol	Avg	Max	Min	Max/Min	Avg/Min
FC @ GRADE	+	1.5 fc	6.5 fc	0.0 fc	N/A	N/A


APPROVED

Stipulation Set bmoriarit

10/22/2019


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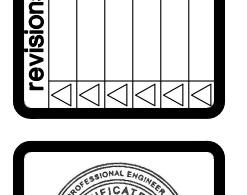
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PHOTOMETRIC SITE PLAN

1/8" = 1'-0"

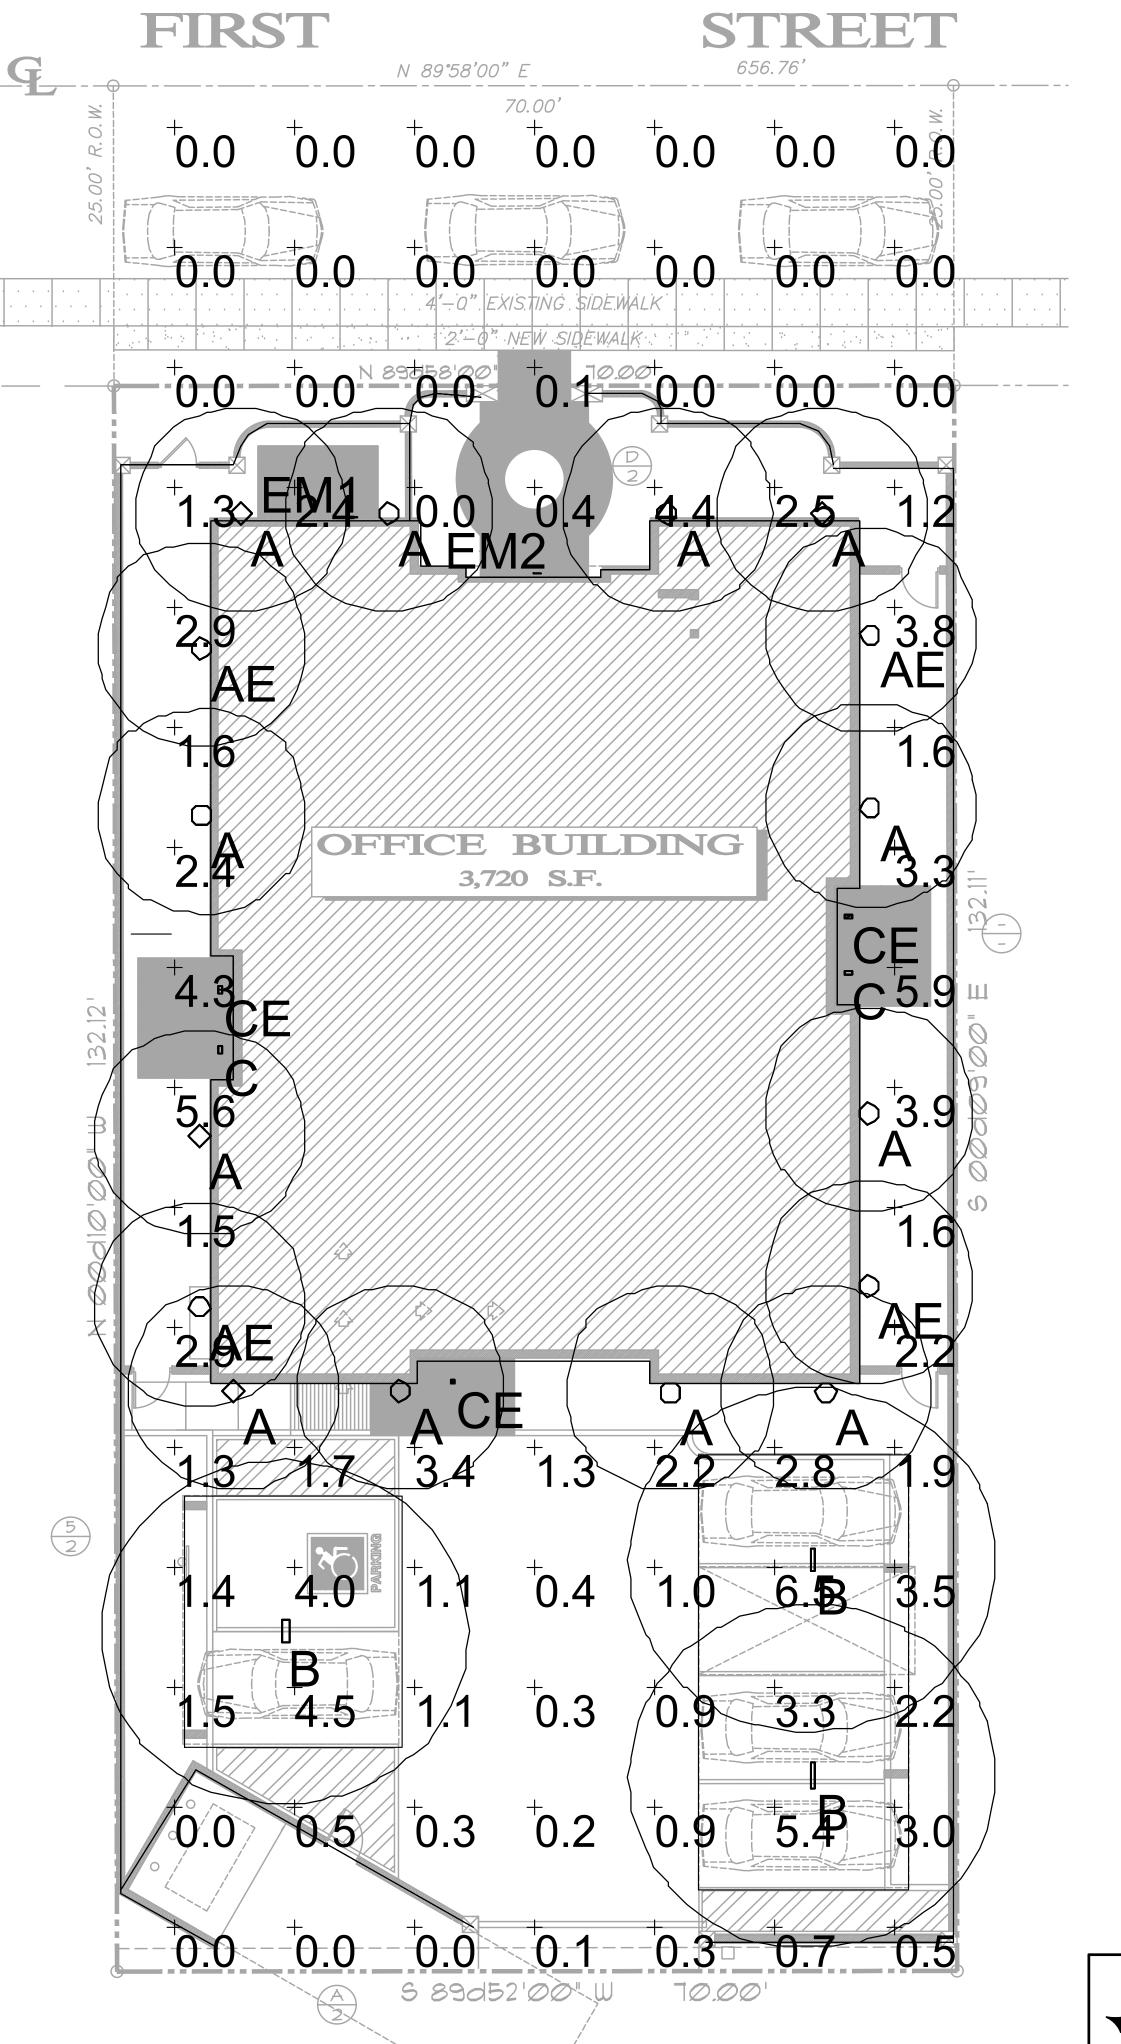






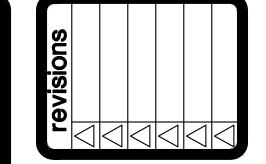


planners <u>2</u> international,

architects



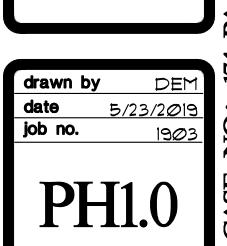

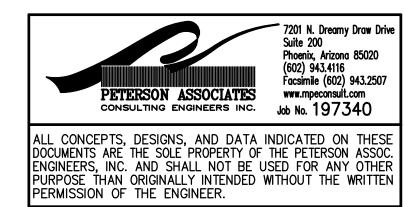

ELECTRICAL

LAMPS

BATTERY

- Dual voltage 120/277VAC

- Brownout protection

- Solid state charging and switching

 Overload and short circuit protection - AC power indicator and test switch

- Supplied with ultra-bright LED strip

the event of a power outage

- ETL Listed for Wet Locations

- Meets UL924 Requirements

NEC and OSHA compliant

- Recharge time 24 hours

CODE COMPLIANCE

IP66 Listed

- Made in USA

5 year warranty

WARRANTY

- Maintenance-free NiCad battery standard

Battery low voltage disconnect (LVD)

- Operating Temperature: -20°C - 40°C

- NFPA 101 Life Safety Code compliant

ORDERING INFORMATION

- Battery will operate fixture for a minimum of 90 minutes in

MODEL WATTAGE MOUNTING OPERATION

Specifications and dimensions subject to change without notice.

MODEL WATTAGE MOUNTING

COLOR

EELP • 2577 Neshaminy Interplex Dr. - KOR A, Suite 102 - Trevose, PA 19053 • PH: 800-490-4496 • •

 White - Bronze

CC - Custom Color

C - Ceiling EM - Battery Backup BA - Brushed Aluminum SD

OPERATION

OPTIONS

Self Diagnostics


SW-SD - Security Lighting and Diagnostics

CW1 - Custom Window Color Filter 3800

- Security Lighting with Controls Switch

ODEL 12032014

- Custom Window Color Filter 3200

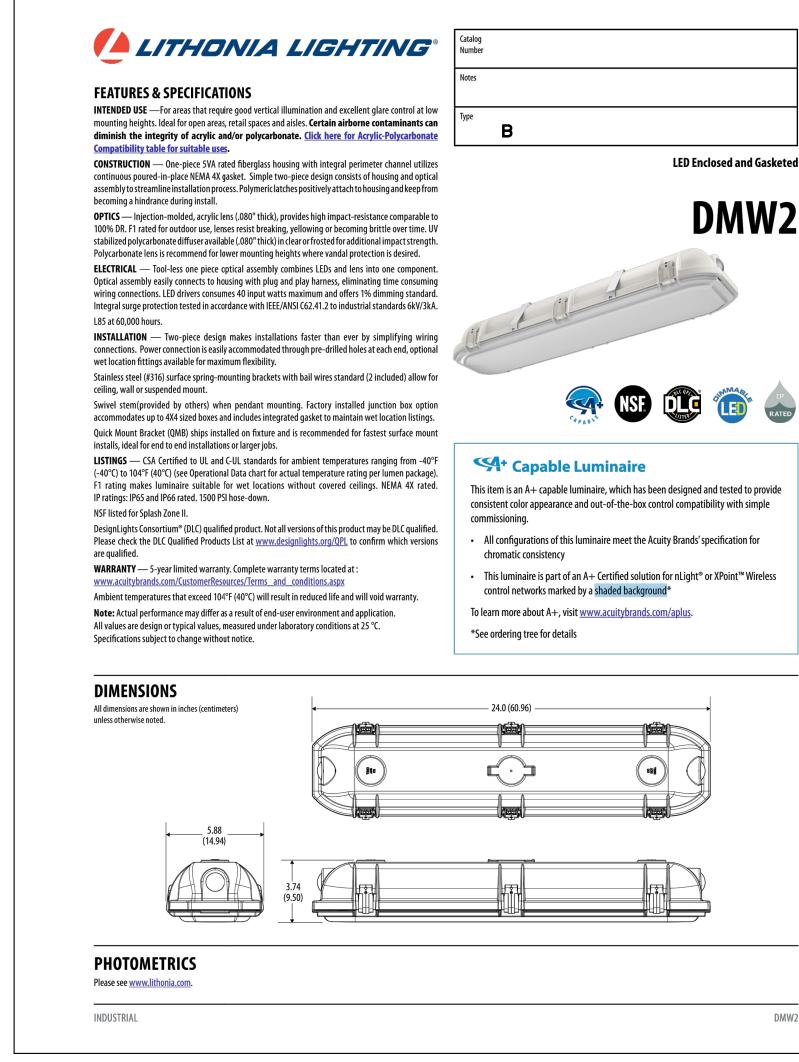




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OMEL 03312016

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Stipulation Set

bmoriarit
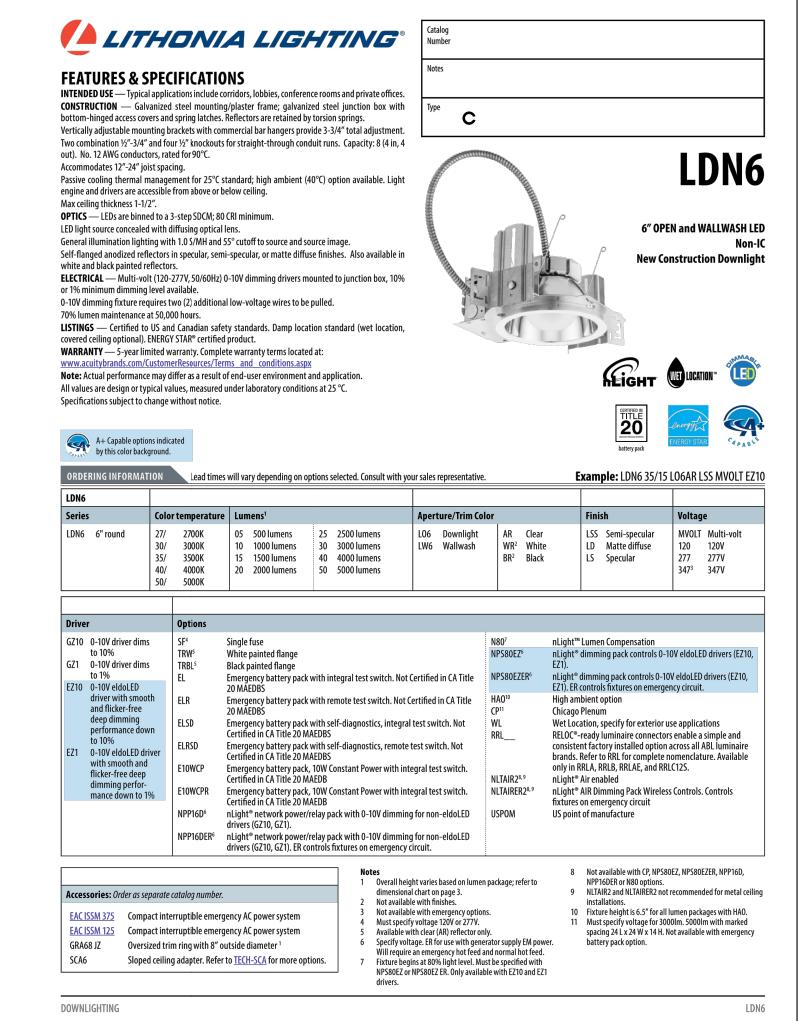
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10/22/2019



32452

ELMER G.

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