

PRELIMINARY WATER MASTER PLAN

Scottsdale Collective

Entertainment/Canal Districts

Scottsdale, AZ 85251

PRELIMINARY Basis of Design Report

- ACCEPTED
 ACCEPTED AS NOTED
 REVISE AND RESUBMIT



Disclaimer: If accepted; the preliminary approval is granted under the condition that a final basis of design report will also be submitted for city review and approval (typically during the DR or PP case). The final report shall incorporate further water or sewer design and analysis requirements as defined in the city design standards and policy manual and address those items noted in the preliminary review comments (both separate and included herein). The final report shall be submitted and approved prior to the plan review submission.

For questions or clarifications contact the Water Resources Planning and Engineering Department at 480-312-5685.

BY Idillon DATE 9/10/2020

BY Idillon DATE 8/31/2020

Prepared For:

Nelsen Partners

15210 N. Scottsdale Rd., Suite 300

Scottsdale, Arizona 85254

480.949.6800 www.NelsenPartners.com



Prepared by:



STIPULATION

Sustainability Engineering Group

8280 E. Gelding Drive, Suite 101

Scottsdale, AZ 85260

480.588.7226 www.azSEG.com

Project Number: 200409

Submittal Date: May 7, 2020 (Zoning)


Revision Date: August 7, 2020 (Zoning Resubmittal)

Case No.: 9-ZN-2020; 1-II-2020 Plan Check No.: TBD

STIPULATION

Table of Contents

1.	INTRODUCTION.....	1
1.1.	SUMMARY OF PROPOSED DEVELOPMENT:	1
1.2.	LEGAL DESCRIPTIONS AND AREA:	1
2.	DESIGN DOCUMENTATION	1
2.1.	DESIGN COMPLIANCE:	1
3.	EXISTING CONDITIONS.....	2
3.1.	EXISTING ZONING & LAND USE:.....	2
3.2.	EXISTING TOPOGRAPHY, VEGETATION AND LANDFORM FEATURES:	2
3.3.	EXISTING UTILITIES:.....	2
3.4.	FIRE HYDRANT FLOW TESTING:	2
4.	PROPOSED CONDITIONS.....	3
4.1.	MASTER PLAN:	3
4.2.	PROPOSED WATER SYSTEM (Refer to FIGURE 5):.....	3
4.3.	MAINTENANCE RESPONSIBILITIES:	3
5.	WATER SYSTEM COMPUTATIONS.....	4
5.1.	WATER FLOW DEMANDS:	4
5.2.	VARIANCE FROM STATED DESIGN FLOWS:	5
5.3.	WATER SYSTEM ANALYSIS:	5
6.	SUMMARY.....	5
6.1.	SUMMARY OF PROPOSED IMPROVEMENTS:.....	5
6.2.	PROJECT SCHEDULE:	6
7.	SUPPORTING MAPS.....	6
7.1.	UTILITY PLANS	6
8.	REFERENCES	6

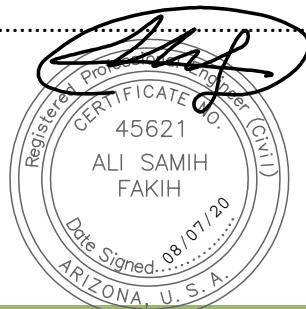

LIST OF FIGURES:

- FIGURE 1 - Vicinity Map
- FIGURE 2 - Local Projects, Approved or Proposed
- FIGURE 3 - Aerial
- FIGURE 4 - City Water Q-S Map 17-45

APPENDICIES:

- APPENDIX I - Fire Hydrant Flow Tests
- APPENDIX II - Preliminary Utility Exhibits

1. INTRODUCTION

1.1. SUMMARY OF PROPOSED DEVELOPMENT:

The report presents a preliminary water infrastructure analysis for redevelopment of three areas within the City of Scottsdale located south and east of the Camelback Road / Scottsdale Road intersection. The three areas have development options that include high density residential, resort hotel, restaurant, office, commercial/retail and fitness/spa uses. The intent of this design report is to show the proposed water infrastructure required to provide service to the following three redevelopments based on the recently performed system flow tests.

- A. City Center is a six-story residential development located adjacent to the intersection within the Arizona Canal District and will replace an existing commercial/office building.
- B. The Maya Hotel is a 12-story residential development located in the Entertainment District east of Buckboard Trail between Indian Plaza and Shoeman Lane.
- C. The Mint is a 9-story residential and retail development located south of Camelback Road and west of Civic Center Plaza also within the Entertainment District.

Refer to **FIGURE 1** for a Vicinity Map and **FIGURE 2** highlighting the projects noted above.

1.2. LEGAL DESCRIPTIONS AND AREA:

Each of the three Master Planned areas consist of multiple land parcels lying within Section 23, Township 2 North, Range 4 East of the Gila and Salt River Base and Meridian, Maricopa County, Scottsdale, Arizona.

- A. City Center: Parcels 173-41-016B, -017A, -015A and -021A, 173-41-005, and 173-41-004 consisting of 118,880 square feet or 2.729 acres more or less.
- B. The Maya: Parcels 173-41-260, -182 and -183 consisting of 16,292 square feet or 0.374 acres more or less.
- C. The Mint: Parcels 173-41-216, -149 thru -153, -119A and 173-40-123 consisting of 56,986 square feet or 1.308 acres more or less.

2. DESIGN DOCUMENTATION

2.1. DESIGN COMPLIANCE:

Preparation of this report has been done in accordance with requirements of the City of Scottsdale Design Standards & Policies Manual (DS&PM) 2018¹ and direction from the City of Scottsdale Water Resources Department. Design calculations for the proposed water infrastructure are all based on the DS+PM recommendations in Section 6-1.403.

3. EXISTING CONDITIONS

3.1. EXISTING ZONING & LAND USE:

Existing zoning across the three parcels includes C-3 DO and P-C-2/P-3 DO with land uses varying from commercial office, retail, restaurant and entertainment. This project proposes rezoning.

3.2. EXISTING TOPOGRAPHY, VEGETATION AND LANDFORM FEATURES:

This area of Scottsdale is relatively flat with minor grades sloping to the Indian Bend Wash approximately $\frac{1}{2}$ mile to the east. All three parcels have been previously developed with buildings and pavement covering most of the properties and minor site landscaping typical of the downtown vicinity.

Refer to **FIGURE 3** for an aerial of the overall project existing conditions.

3.3. EXISTING UTILITIES:

Water service to this area of Scottsdale largely consists of distribution piping varying in size from 6" to 12". A 20" water transmission line was constructed in Shoeman Lane between Scottsdale Road and Brown Avenue where it reduces to a 16" pipe and continues north to Camelback Road, then west crossing under the Arizona Canal. This transmission line is part of a larger loop that encircles the downtown area providing water to Zone 1A. Refer to **FIGURE 4** for City Quarter Section Map (QS 17-45).

Parcel A - City Center, has a water line extended through the property that will need to be removed. Camelback Road frontage to the site contains 8, 12 and 16" pipes. Brown Avenue contains the previously mentioned 16" pipe.

Parcel B – Maya, has a 12" DIP along Shoeman Lane to the west feeding an 8 and 6" distribution system along Buckboard Trail and Shoeman Lane to the east.

Parcel C – The Mint, has 8 and 12" ACP lines along the Camelback Road frontage and a 6" ACP along Saddlebag Trail, Civic Center Plaza, Indian Plaza and Saddlebag Trail.

All properties, consisting of multiple parcels have several meters and fire lines that will be inventoried for fee credit prior to being removed as necessary for new construction. Refer to Preliminary Utility Exhibits in APPENDIX II for anticipated limits of water line removals.

3.4. FIRE HYDRANT FLOW TESTING:

Flow testing was performed adjacent to all three sites on the morning of April 13, 2020. Results of the tests, including corresponding supply curves, are shown in **APPENDIX I**. Summarizing, all three tests have static pressures above 100 psi and at 30 psi provided flows from 4,603 gpm to 7,058 gpm. Table 1 shows results of the tests.

Table 1 - RESULT SUMMARY OF FIRE HYDRANT FLOW TESTING

DEVELOPMENT	FH LOCATIONS	STATIC PRESSURE (psi)	RESIDUAL PRESSURE (psi)	PITOT PRESSURE (psi)	FLOWING GPM	GPM @ 72 PSI	GPM @ 30 PSI
City Center	Brown Avenue & Shoeman Lane	100	90	33	2468	4303	7058
The Maya	Buckboard Trail & Shoeman Lane	102	84	37	2614	3444	5526
The Mint	Indian Plaza & Civic Center Plaza	104	80	34	2506	2927	4603

4. PROPOSED CONDITIONS

4.1. MASTER PLAN:

With strong pressures and flows in the existing water infrastructure, it is anticipated the three proposed projects can all be provided domestic, fire and irrigation service off connections to the existing system.

4.2. PROPOSED WATER SYSTEM (Refer to FIGURE 5):

City Center will need to remove a public water line crossing the site. The ends of this pipe located at the Arizona Canal and Brown Road can be used for fire protection. Two fire hydrants exist on the property and will be relocated as necessary, providing adequate coverage. The proposed development will be serviced off of the existing 16" water line along Brown Avenue.

The Maya will receive metered service and fire protection off the 8" main located in Buckboard Trail. A fire hydrant exists across at the intersection of Shoeman Lane and Buckboard Trail and will provide adequate protection for the proposed building.

The west Mint commercial building will receive metered service and fire protection from the 8" line in Camelback Road. The east hotel building will receive metered service and fire protection from the 6" line in Indian Plaza. Fire hydrants exist on Saddlebag Trail, Civic Center Plaza and Indian Plaza.

All unused existing water service lines to these sites will be removed to the main per City requirements unless reused for site development.

A Preliminary Utility Plan is included as **APPENDIX II**.

4.3. MAINTENANCE RESPONSIBILITIES:

No water main extensions are proposed. All proposed water meters will be installed in right-of-way or easement dedicated to the city. All proposed building service connections and fire lines will be private and maintained by the building owners. Backflow prevention will be provided on all metered services.

5. WATER SYSTEM COMPUTATIONS

5.1. WATER FLOW DEMANDS:

This Master Plan includes development options for the three sites.

The City design criteria and resulting maximum demands for the average, max day and peak hour flows are shown in Tables 1 through 4 below. The developer desires to maintain flexibility in designated uses. This report will only evaluate the maximum demands anticipated for each site as a basis for Zoning approval. Final uses/demands may be less.

Table 1: COS Design Criteria - Average Day Demands

Land Use	Unit Demand (gpm)	Unit	Max Day Factor	Peak Hour Factor
High Density Residential	0.27	per unit	2	3.5
Resort Hotel	0.63	per room	2	3.5
Restaurant	1.81E-03	per sq. ft.	2	3.5
Office	8.34E-04	per sq. ft.	2	3.5
Commercial/Retail	1.11E-03	per sq. ft.	2	3.5
Fitness/Spa	1.50E-03	per sq. ft.	2	3.5

Ideally this needs to be increased to 6 for under 15kft² and 5 for over 15kft² (for square footages being served in same building or meter)

Table 2: GREATEST WATER DEMAND CALCULATIONS - Parcel A (City Center)

	Units or Area (sq. ft.)	Unit Demand (gpm)	Avg. Day Demand (gpm)	Max Day Demand (gpm)	Peak Hour Demand (gpm)
High Density Residential	106	0.27	28.6	57.2	100.2
Resort Hotel	214	0.63	134.8	269.6	943.7
Restaurant	41,109	1.81E-03	74.4	148.8	520.9
Office		8.34E-04			
Commercial/Retail		1.11E-03			
Fitness/Spa		1.50E-03			
TOTAL DEMANDS:		237.8	475.7	1,564.8	

Table 3A: GREATEST WATER DEMAND CALCULATIONS - Parcel B (The Mint - West)

	Units or Area (sq. ft.)	Unit Demand (gpm)	Avg. Day Demand (gpm)	Max Day Demand (gpm)	Peak Hour Demand (gpm)
High Density Residential		0.27			
Resort Hotel		0.63			
Restaurant	13,881	1.81E-03	25.1	50.2	87.9
Office		8.34E-04			
Commercial/Retail		1.11E-03			
Fitness/Spa		1.50E-03			
TOTAL DEMANDS:		25.1	50.2	87.9	

Table 3B: GREATEST WATER DEMAND CALCULATIONS - Parcel B (The Mint - East)

	Units or Area (sq. ft.)	Unit Demand (gpm)	Avg. Day Demand (gpm)	Max Day Demand (gpm)	Peak Hour Demand (gpm)
High Density Residential		0.27			
Resort Hotel	116	0.63	73.1	146.2	255.8
Restaurant	14,135	1.81E-03	25.6	51.2	89.5
Office		8.34E-04			
Commercial/Retail		1.11E-03			
Fitness/Spa		1.50E-03			
TOTAL DEMANDS:		98.7	197.3	345.3	

Table 4: GREATEST WATER DEMAND CALCULATIONS - Parcel C (The Maya)

	Units or Area (sq. ft.)	Unit Demand (gpm)	Avg. Day Demand (gpm)	Max Day Demand (gpm)	Peak Hour Demand (gpm)
High Density Residential		0.27			
Resort Hotel	161	0.63	101.4	202.9	355.0
Restaurant	10,440	1.81E-03	18.9	37.8	66.1
Office		8.34E-04			
Commercial/Retail		1.11E-03			
Fitness/Spa	1,120	1.50E-03	1.7	3.4	5.9
TOTAL DEMANDS:		122.0	244.0	427.0	

All three facilities will require the public water system to provide 2500 gpm consistent with other high-rise/high-density projects in the City. All buildings will require mechanical engineering evaluations to determine the extent of any required building pumps and storage required within the structure.

5.2. VARIANCE FROM STATED DESIGN FLOWS:

No variance from the stated design criteria in the DS+PM is requested.

5.3. WATER SYSTEM ANALYSIS:

Based on the results of the fire hydrant flow tests conducted adjacent to each site, the existing water system appears to have adequate pressure and capacity to provide domestic service and fire protection.

6. SUMMARY

6.1. SUMMARY OF PROPOSED IMPROVEMENTS:

This Preliminary Master Plan supports the development of City Center, Maya and The Mint compliant to the requirements stated in Chapter 6 of the COS DS+PM. Preliminary analysis indicates the existing water infrastructure is sufficient to provide domestic service and fire protection. All existing metered

services, fire line and pipe not needed for the master planned development will be inventoried and shown to be removed per requirements of the DS+PM on the final improvement plans.

Final Basis of Design Reports will be submitted as each site progresses through the development review process.

6.2. PROJECT SCHEDULE:

The infrastructure removal and domestic/fire service connections required of each Parcel will be detailed on their respective improvement plans and constructed with the improvements for that Parcel. No timeline has presently been documented for the construction of individual Parcels. It is anticipated as each Parcel develops, all related water service and fire line appurtenances will be constructed as shown on **APPENDIX II**.

7. SUPPORTING MAPS

7.1. UTILITY PLANS

Preliminary Utility Exhibits with proposed service connections to the existing water system is included as **APPENDIX II**.

8. REFERENCES

1. COS QS Water Plan number 17-45
2. City of Scottsdale Design Standards & Policies Manual, 2018 (Chapter 6 – Water)

FIGURES

1 Vicinity Map

2 Local Projects, Approved or Proposed

3 Aerial

4 City Water Q-S Map 17-45


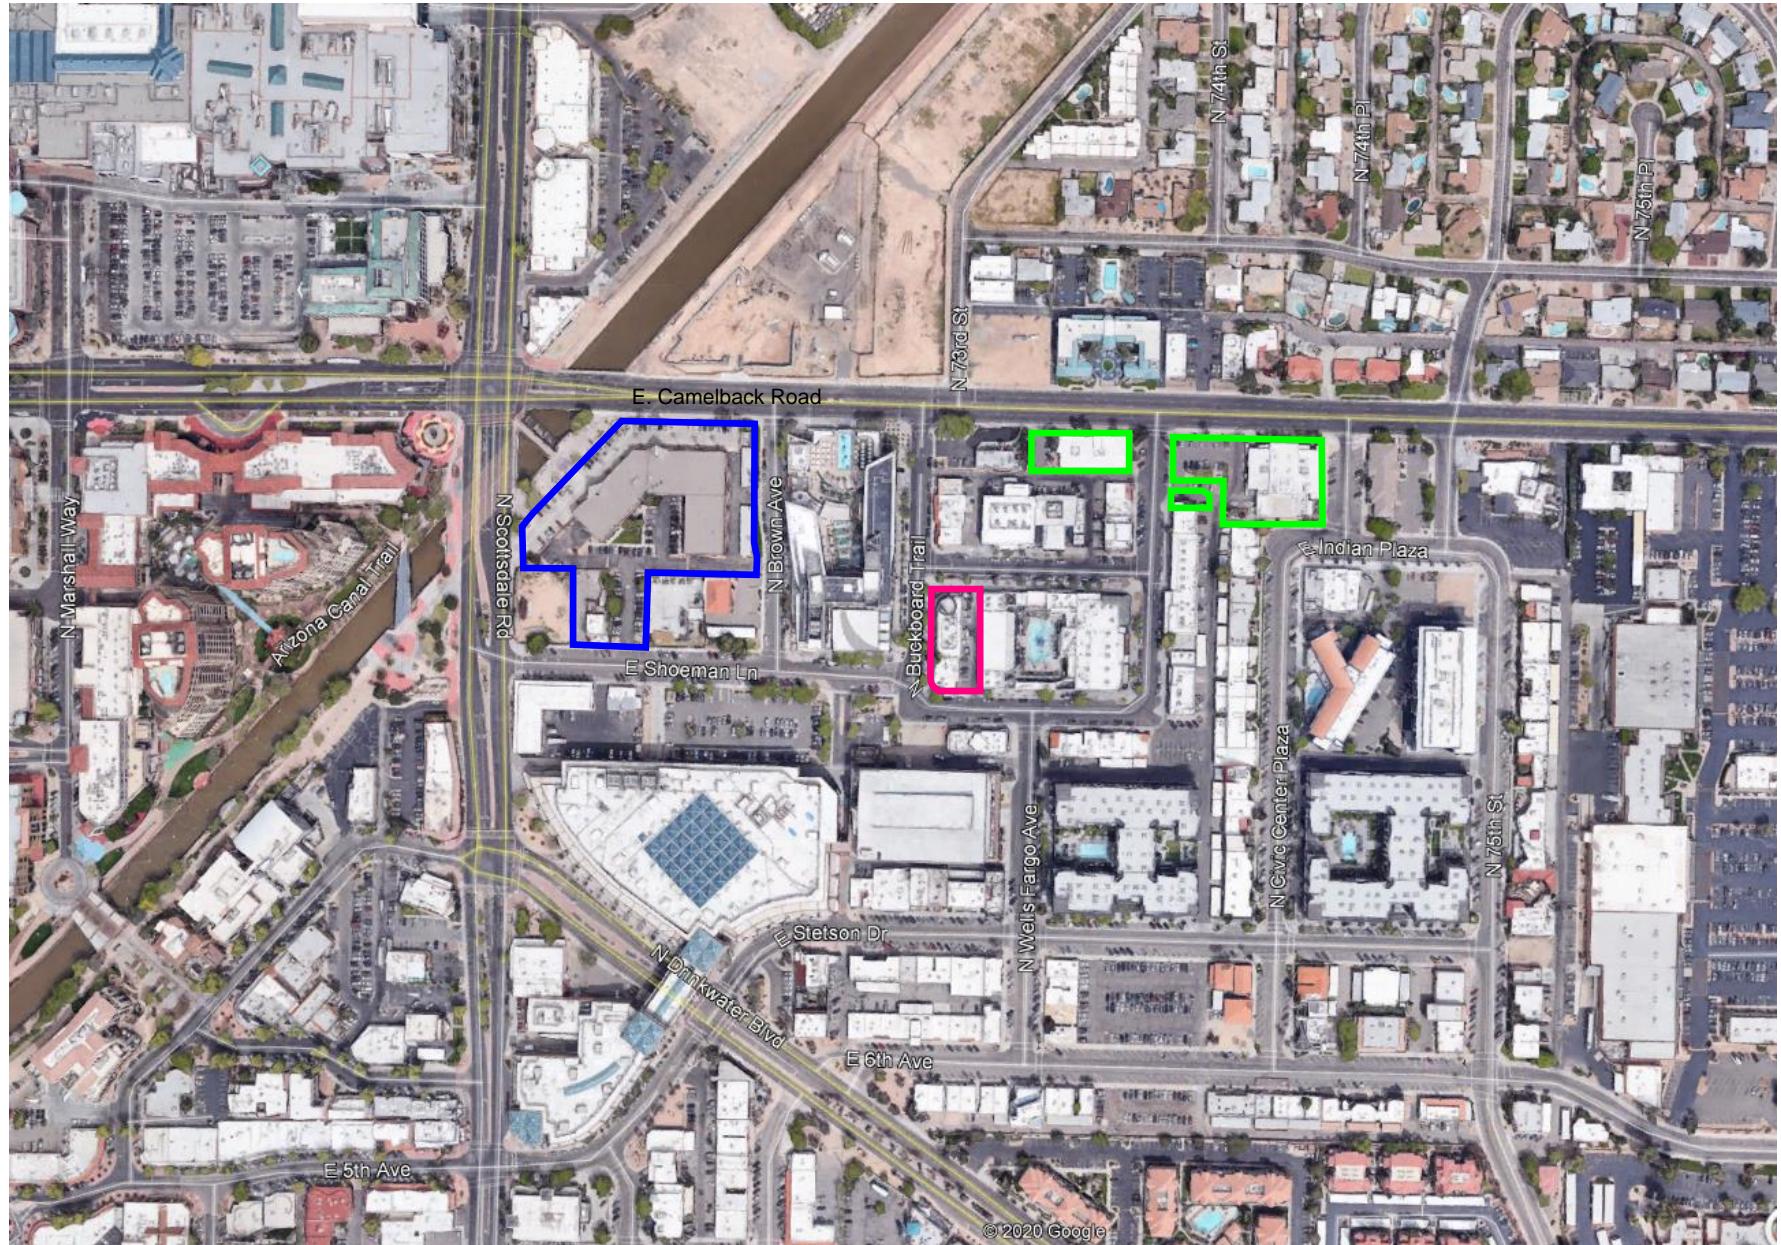


Figure 1- Vicinity Map

- City Center** (Blue outline)
- The Mint** (Green outline)
- Maya Hotel** (Pink outline)

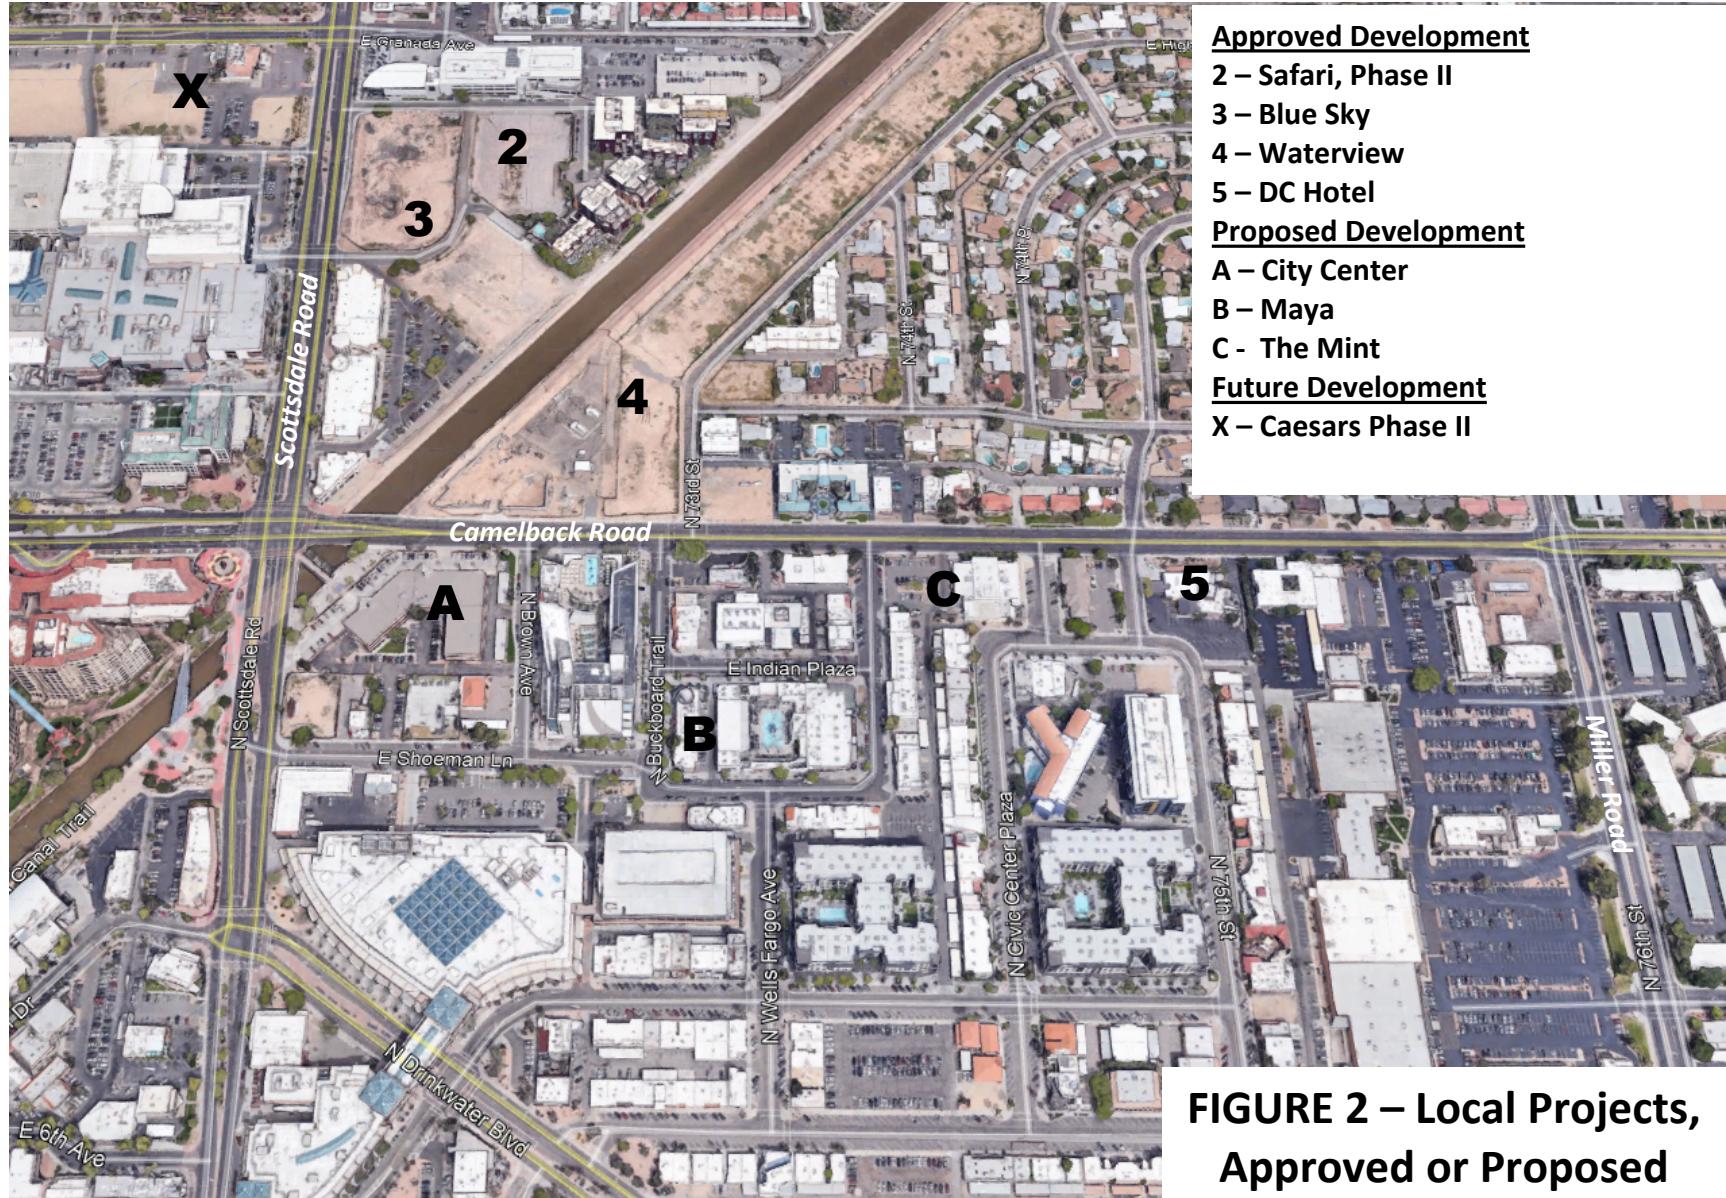

SCALE: N.T.S



**FIGURE 2 – Local Projects,
Approved or Proposed**


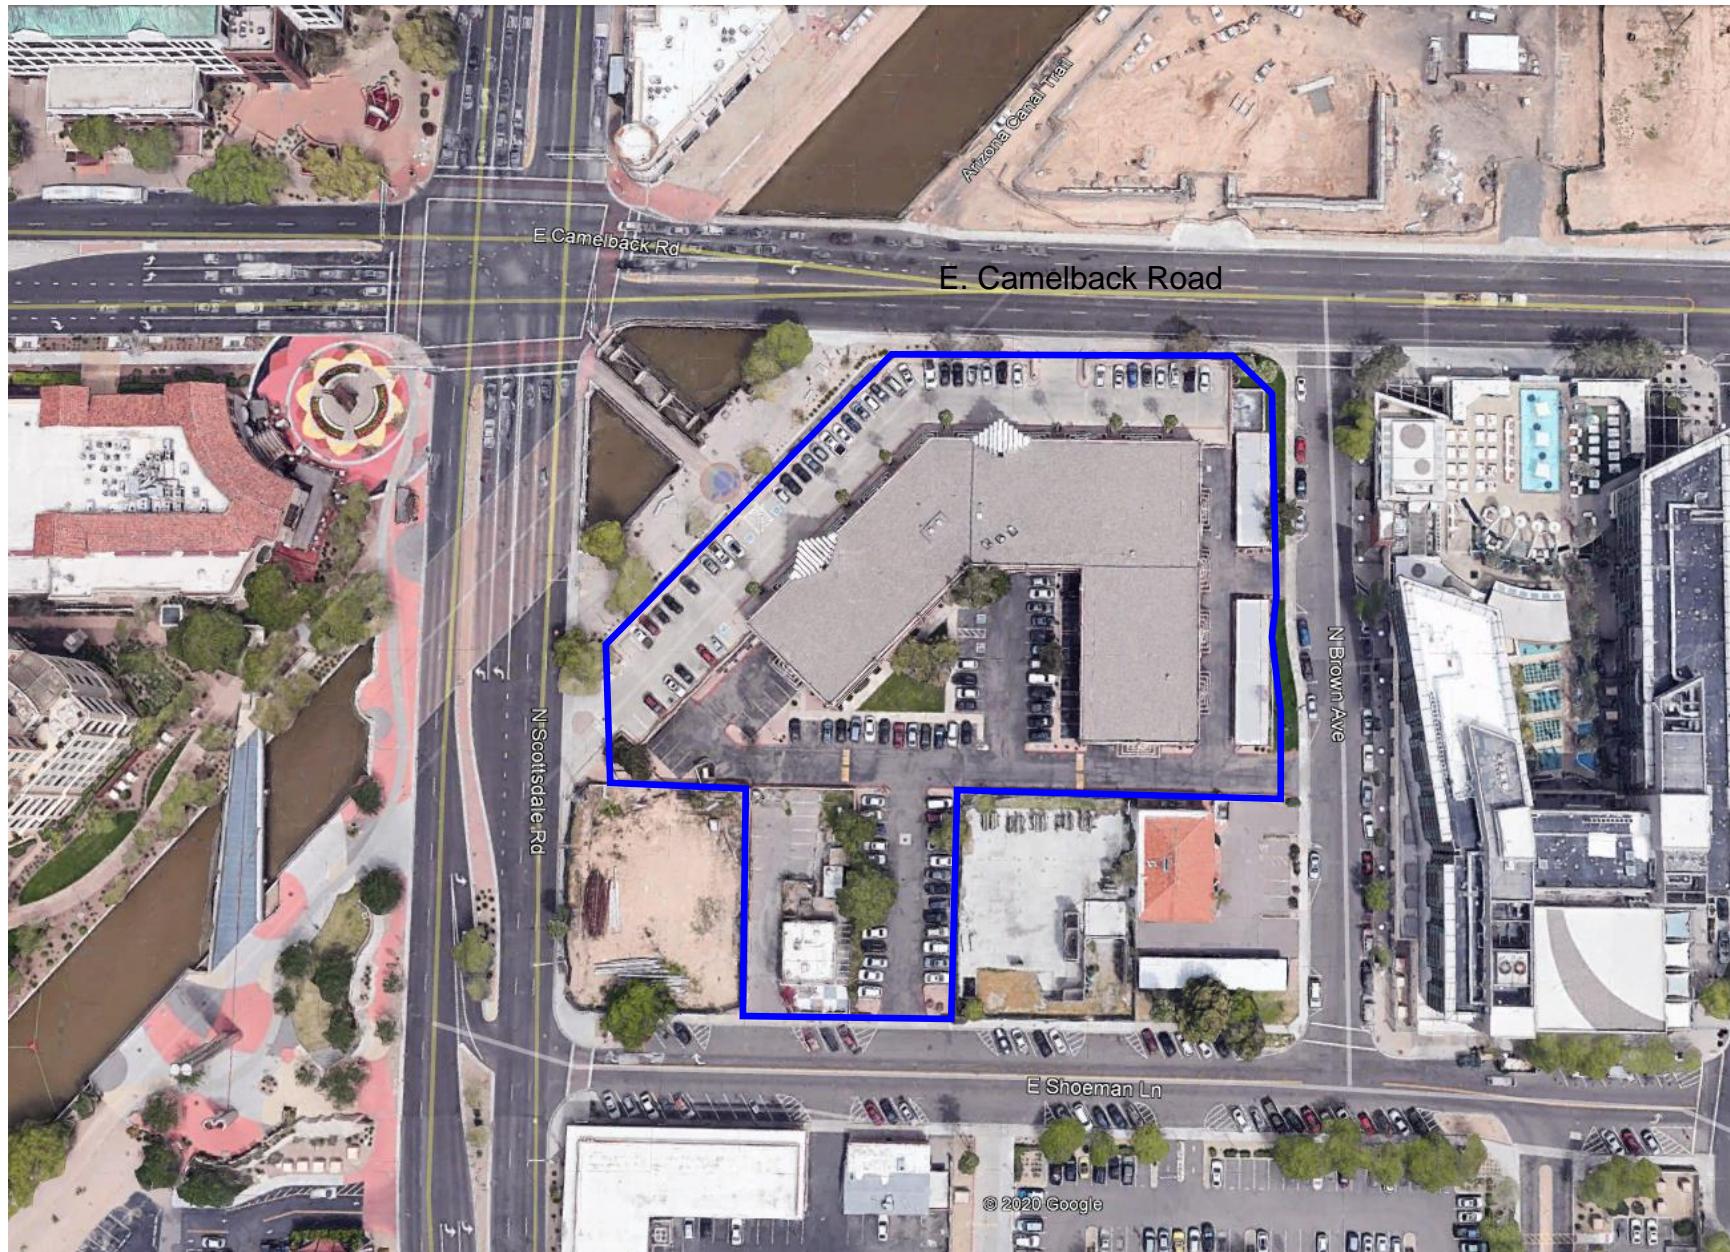


Figure 3A- Aerial Map
City Center



SCALE: N.T.S

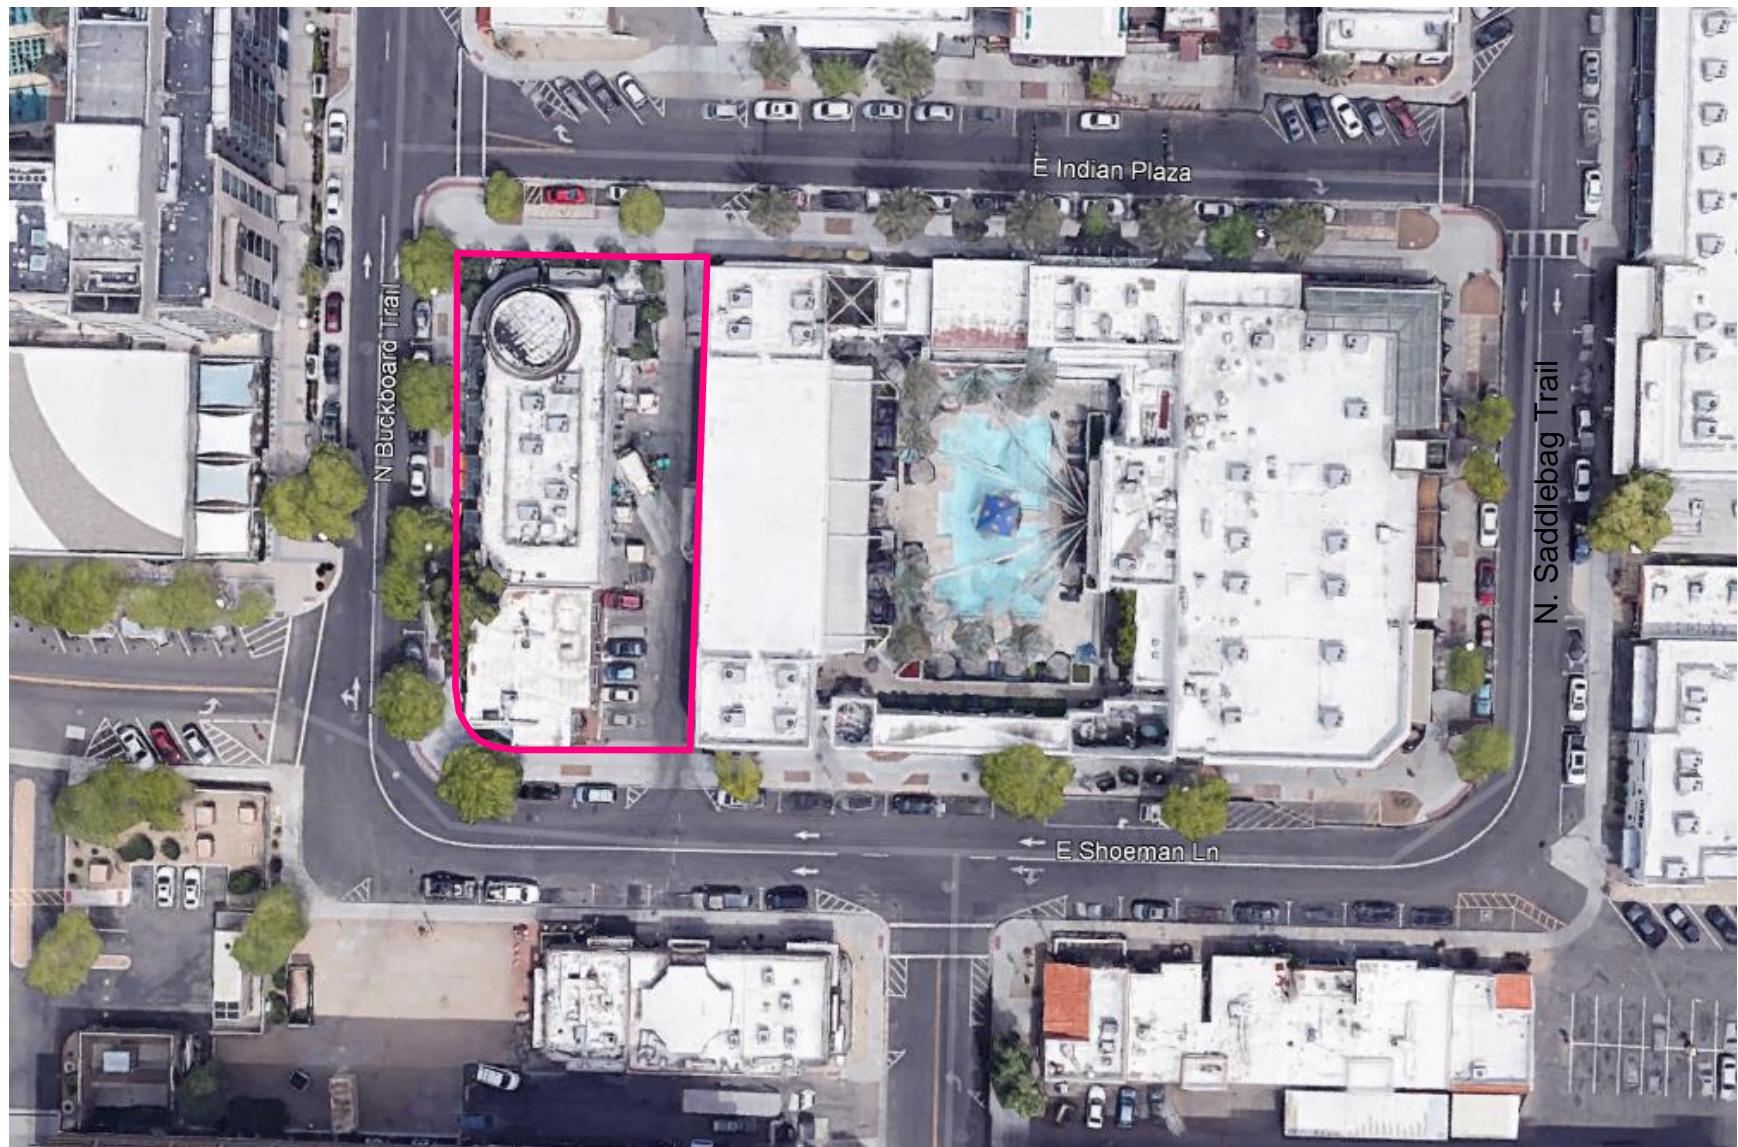


SCALE: N.T.S

**Figure 3B- Aerial Map
Maya Hotel**



SCALE: N.T.S

**Figure 3C- Aerial Map
The Mint**

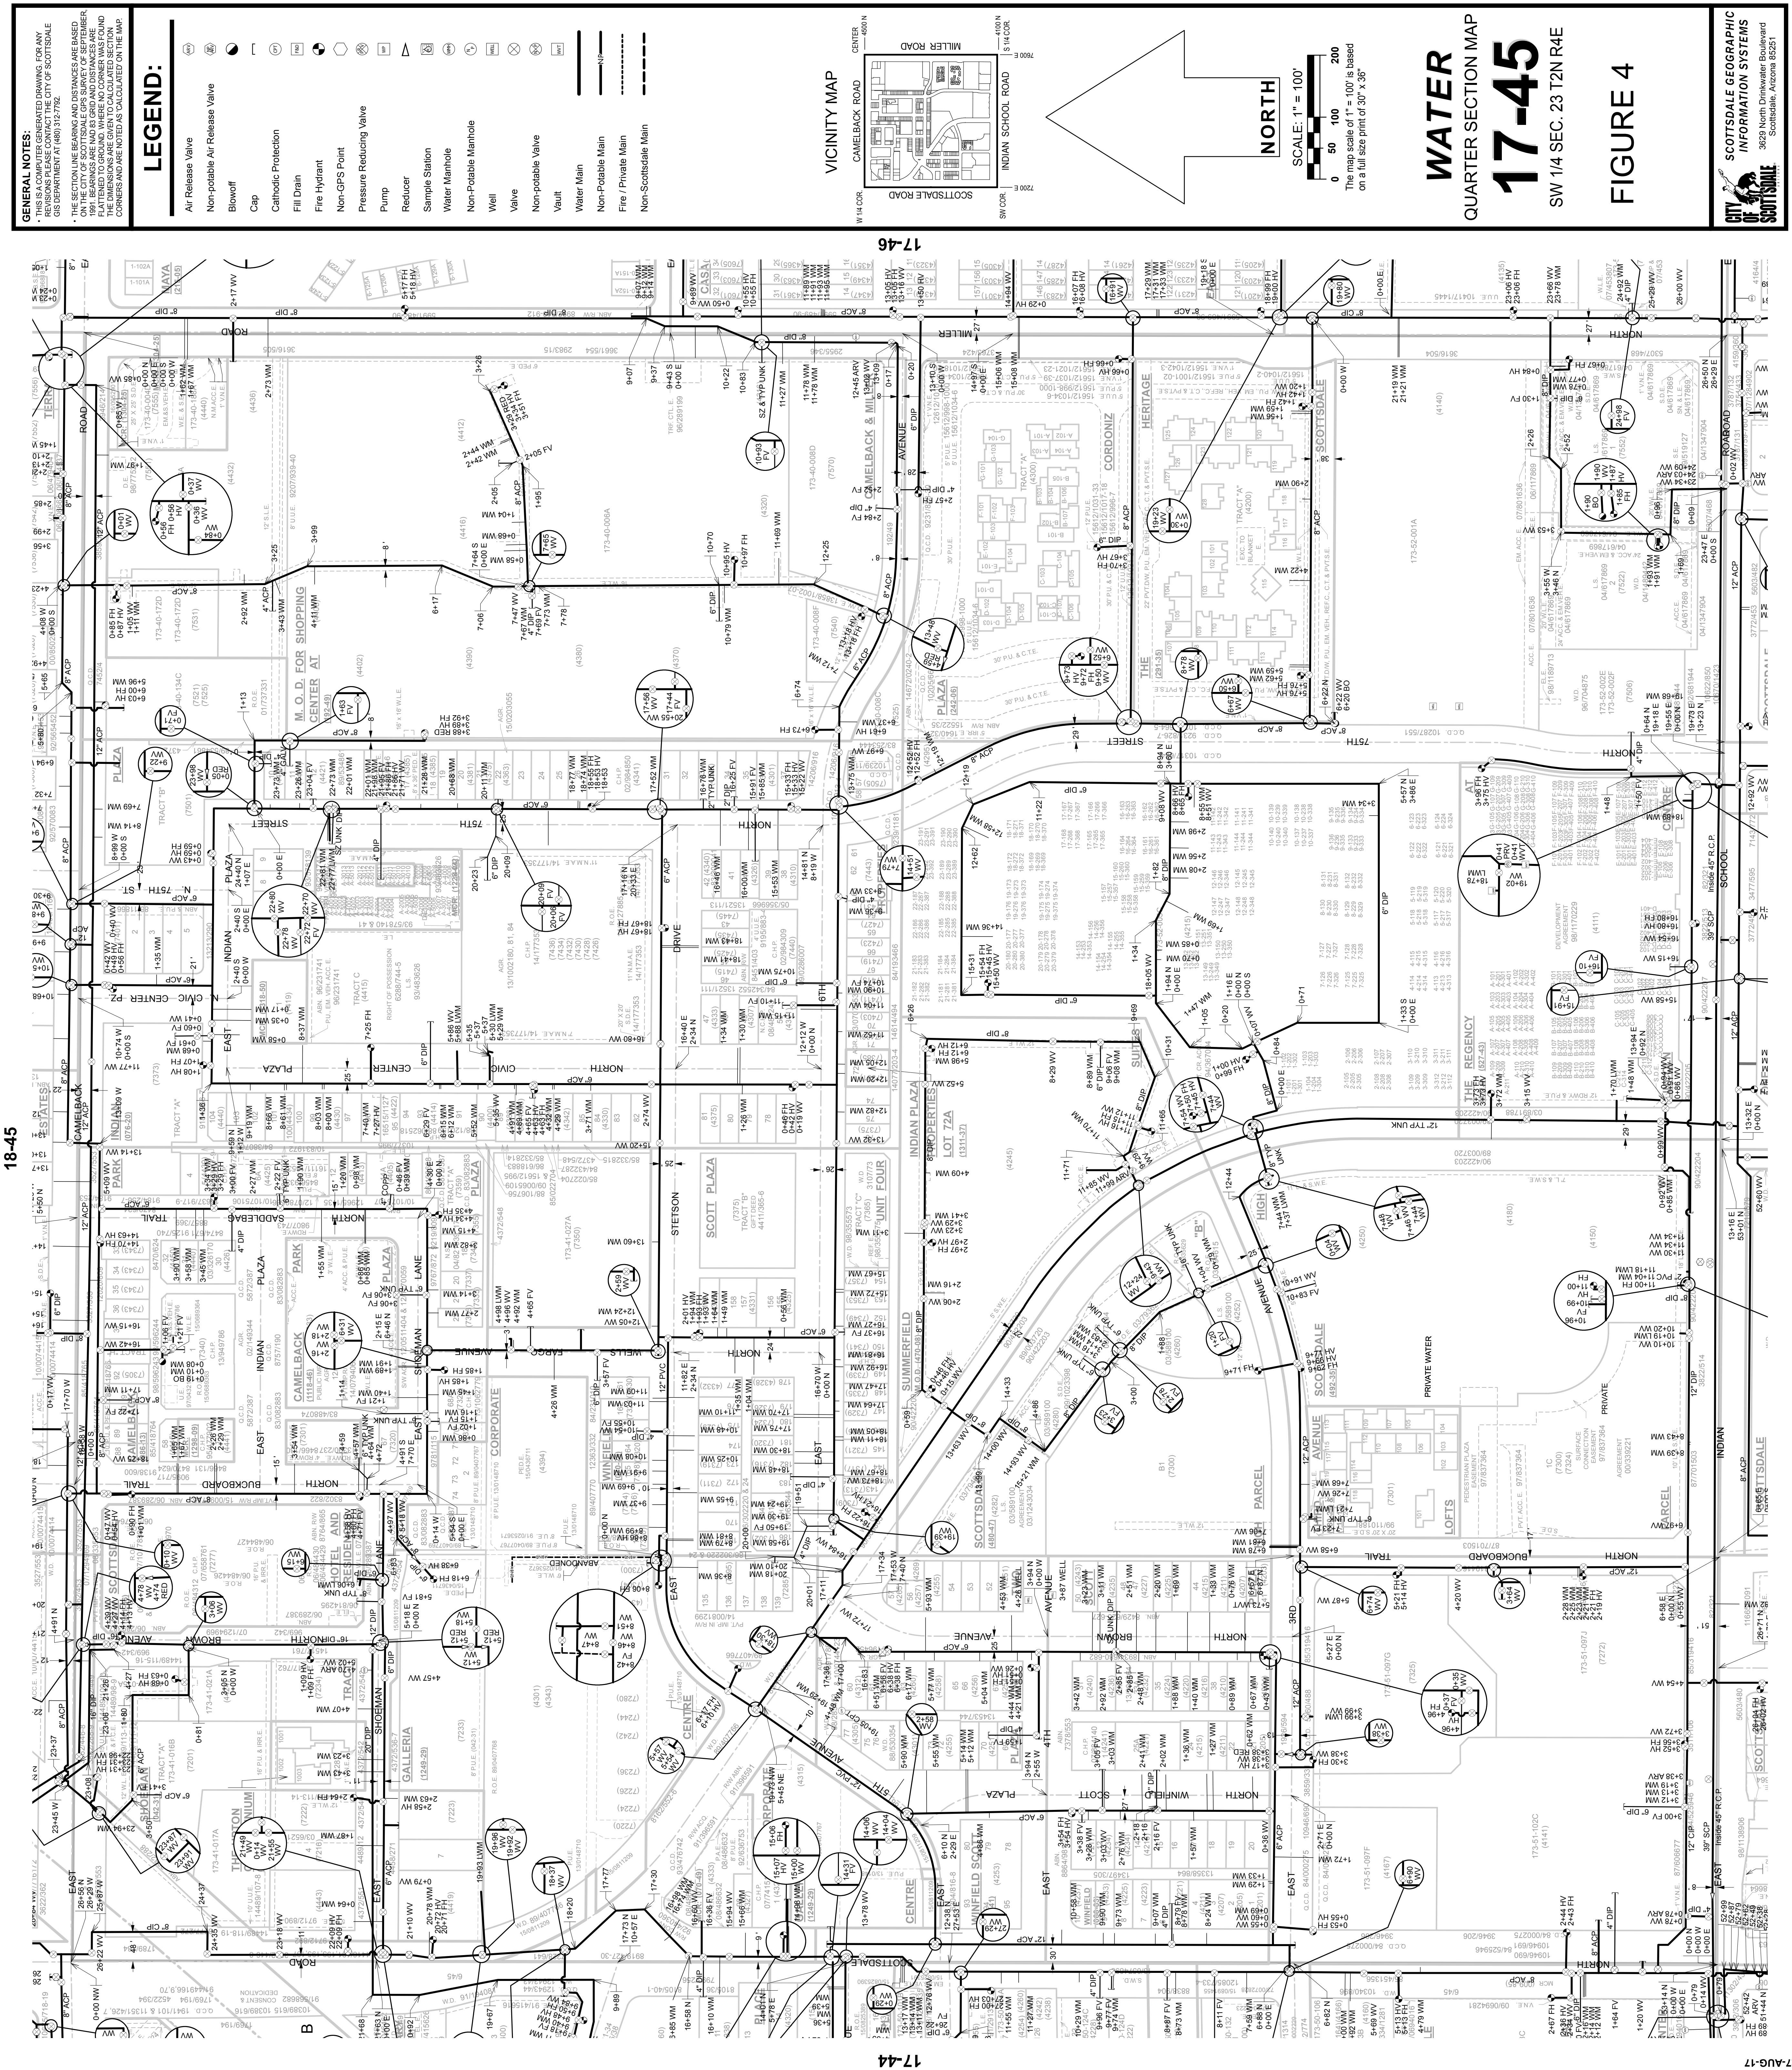

APPENDICES

- I. Design Requirements
- II. Water Demands
- III. Fire Hydrant Flow Tests

*8280 E. Gelding Dr., Suite 101
Scottsdale, AZ 85260*

Sustainability Engineering Group

info@azSEG.com 480.588.7226 www.azSEG.com

APPENDIX

9-ZN-2020
08/11/20



CITY OF SCOTTSDALE – DESIGN STANDARDS AND POLICIES MANUAL
EXCERPT FROM FIGURE 6-1.2

Table 1: COS Design Criteria - Average Day Demands

Land Use	Unit Demand (gpm)	Unit	Max Day Factor	Peak Hour Factor
High Density Residential	0.27	per unit	2	3.5
Resort Hotel	0.63	per room	2	3.5
Restaurant	1.81E-03	per sq. ft.	2	3.5
Office	8.34E-04	per sq. ft.	2	3.5
Commercial/Retail	1.11E-03	per sq. ft.	2	3.5
Fitness/Spa	1.50E-03	per sq. ft.	2	3.5

APPENDIX I – Design Requirements

8280 E. Gelding Dr., Suite 101
Scottsdale, AZ 85260

Sustainability Engineering Group

info@azSEG.com 480.588.7226 www.azSEG.com

APPENDIX

9-ZN-2020
08/11/20



PARCEL A – CITY CENTER WATER DEMANDS / OPTIONS

Option 1: WATER DEMAND CALCULATIONS - Parcel A (City Center)

	Units or Area (sq. ft.)	Unit Demand (gpm)	Avg. Day Demand (gpm)	Max Day Demand (gpm)	Peak Hour Demand (gpm)
High Density Residential	136	0.27	36.7	18.4	128.5
Resort Hotel	190	0.63	119.7	59.9	419.0
Restaurant	10,000	1.81E-03	18.1	9.1	63.4
Office		8.34E-04			
Commercial/Retail	36,887	1.11E-03	40.9	20.5	143.3
Fitness/Spa		1.50E-03			
TOTAL DEMANDS:		215.5	107.7	754.1	

Option 2: WATER DEMAND CALCULATIONS - Parcel A (City Center)

	Units or Area (sq. ft.)	Unit Demand (gpm)	Avg. Day Demand (gpm)	Max Day Demand (gpm)	Peak Hour Demand (gpm)
High Density Residential	237	0.27	64.0	128.0	224.0
Resort Hotel		0.63			
Restaurant	10,000	1.81E-03	18.1	36.2	63.4
Office		8.34E-04			
Commercial/Retail	36,887	1.11E-03	40.9	81.9	143.3
Fitness/Spa		1.50E-03			
TOTAL DEMANDS:		123.0	246.1	430.6	

Option 3: WATER DEMAND CALCULATIONS - Parcel A (City Center)

	Units or Area (sq. ft.)	Unit Demand (gpm)	Avg. Day Demand (gpm)	Max Day Demand (gpm)	Peak Hour Demand (gpm)
High Density Residential		0.27			
Resort Hotel	449	0.63	282.9	565.7	1,980.1
Restaurant	10,000	1.81E-03	18.1	36.2	126.7
Office		8.34E-04			
Commercial/Retail	36,887	1.11E-03	40.9	81.9	286.6
Fitness/Spa		1.50E-03			
TOTAL DEMANDS:		341.9	683.8	2,393.4	

APPENDIX II – Water Demands

8280 E. Gelding Dr., Suite 101

Scottsdale, AZ 85260

Sustainability Engineering Group

info@azSEG.com 480.588.7226 www.azSEG.com

APPENDIX

9-ZN-2020

08/11/20



PARCEL B – THE MINT WATER DEMANDS / OPTIONS

Option 1: WATER DEMAND CALCULATIONS - Parcel B (The Mint)

	Units or Area (sq. ft.)	Unit Demand (gpm)	Avg. Day Demand (gpm)	Max Day Demand (gpm)	Peak Hour Demand (gpm)
High Density Residential	62	0.27	16.7	58.6	58.6
Resort Hotel		0.63			
Restaurant	5,280	1.81E-03	9.6	19.1	33.4
Office	3,600	8.34E-04	3.0	6.0	10.5
Commercial/Retail	22,281	1.11E-03	24.7	49.5	86.6
Fitness/Spa		1.50E-03			
TOTAL DEMANDS:			54.0	133.2	189.1

Option 2: WATER DEMAND CALCULATIONS - Parcel B (The Mint)

	Units or Area (sq. ft.)	Unit Demand (gpm)	Avg. Day Demand (gpm)	Max Day Demand (gpm)	Peak Hour Demand (gpm)
High Density Residential		0.27			
Resort Hotel	116	0.63	73.1	255.8	255.8
Restaurant	5,280	1.81E-03	9.6	19.1	66.9
Office	3,600	8.34E-04	3.0	6.0	21.0
Commercial/Retail	22,281	1.11E-03	24.7	49.5	173.1
Fitness/Spa		1.50E-03			
TOTAL DEMANDS:			110.4	330.4	516.8

APPENDIX II – Water Demands

8280 E. Gelding Dr., Suite 101

Scottsdale, AZ 85260

Sustainability Engineering Group

info@azSEG.com 480.588.7226 www.azSEG.com

APPENDIX

9-ZN-2020

08/11/20



SEG

*"LEED®ing and Developing Smart Projects"***PARCEL C – MAYA WATER DEMANDS / OPTIONS*****Option 1: WATER DEMAND CALCULATIONS - Parcel C (The Maya)***

	Units or Area (sq. ft.)	Unit Demand (gpm)	Avg. Day Demand (gpm)	Max Day Demand (gpm)	Peak Hour Demand (gpm)
High Density Residential		0.27	0.0	0.0	0.0
Resort Hotel	160	0.63	100.8	50.4	352.8
Restaurant		1.81E-03			
Office		8.34E-04			
Commercial/Retail		1.11E-03			
Fitness/Spa		1.50E-03			
TOTAL DEMANDS:			100.8	50.4	352.8

**APPENDIX II –
Water Demands**

*8280 E. Gelding Dr., Suite 101
Scottsdale, AZ 85260*

Sustainability Engineering Group

info@azSEG.com 480.588.7226 www.azSEG.com

APPENDIX


9-ZN-2020
08/11/20

SHEET UPDATED 9/10/20,
SEE LAST PAGES OF
REPORT


OVERALL
UTILITY EXHIBIT & KEY MAP

PRELIMINARY
NOT FOR
CONSTRUCTION

SHEET 1

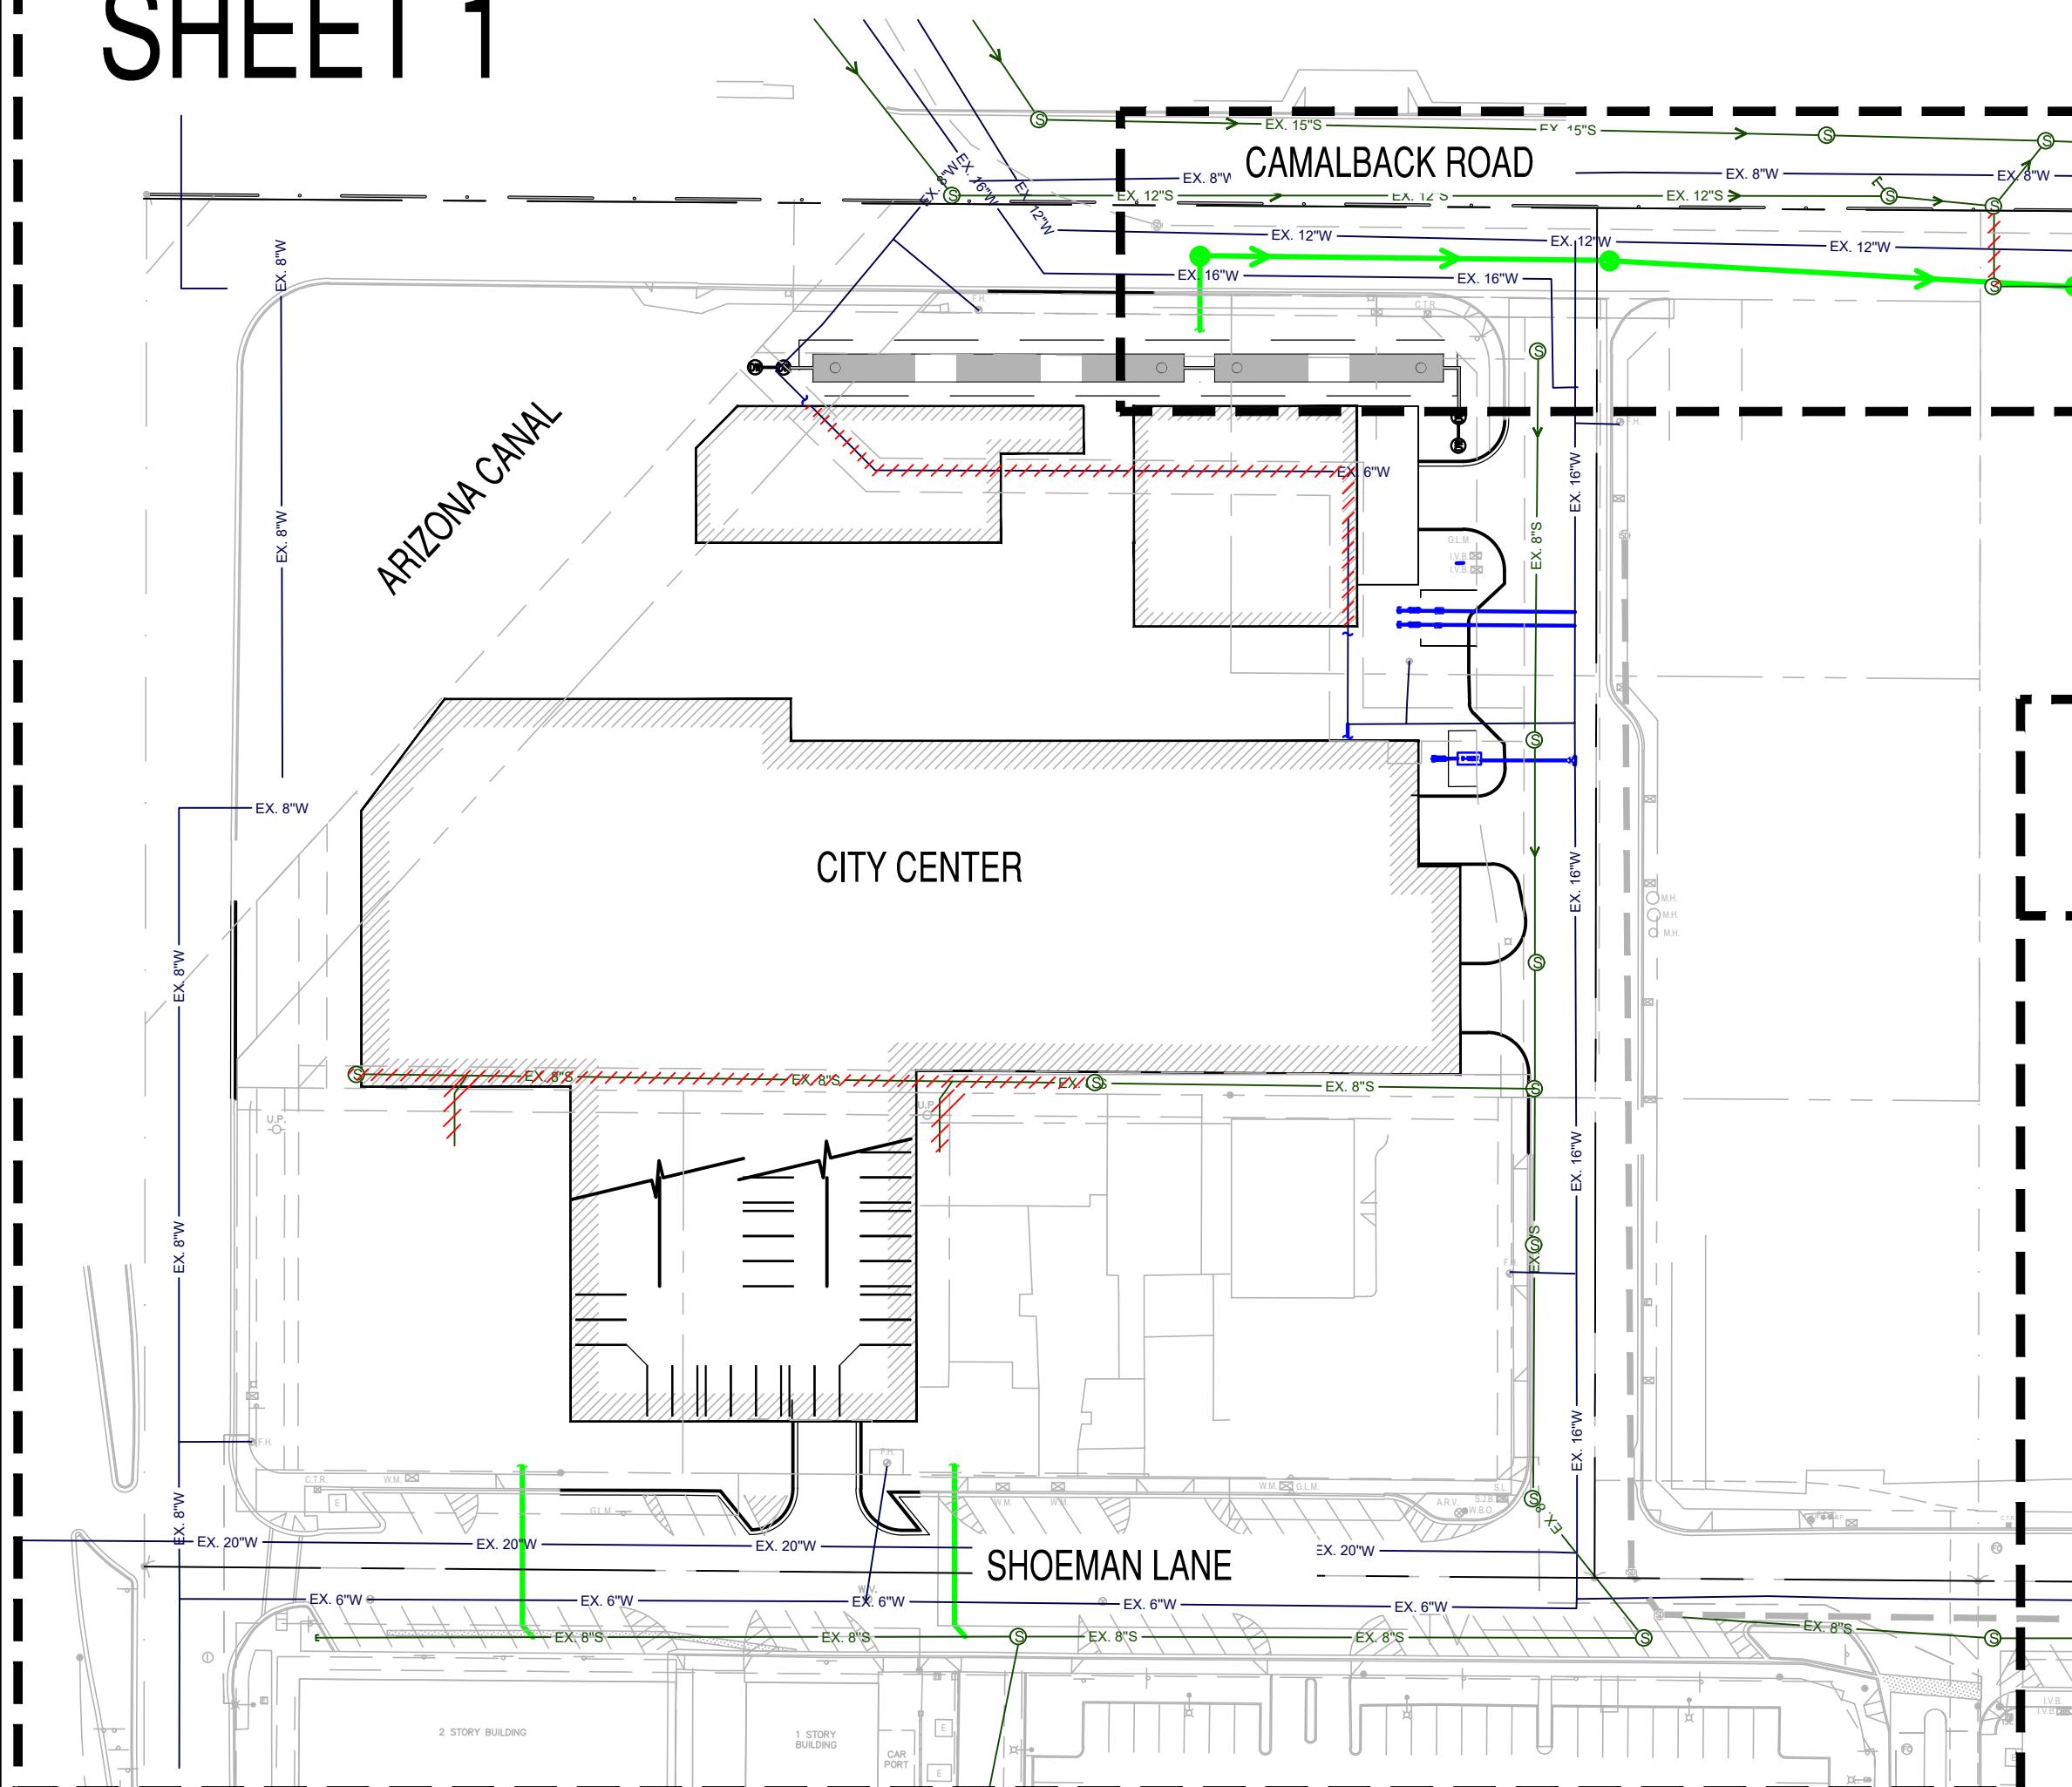

SHEET 2

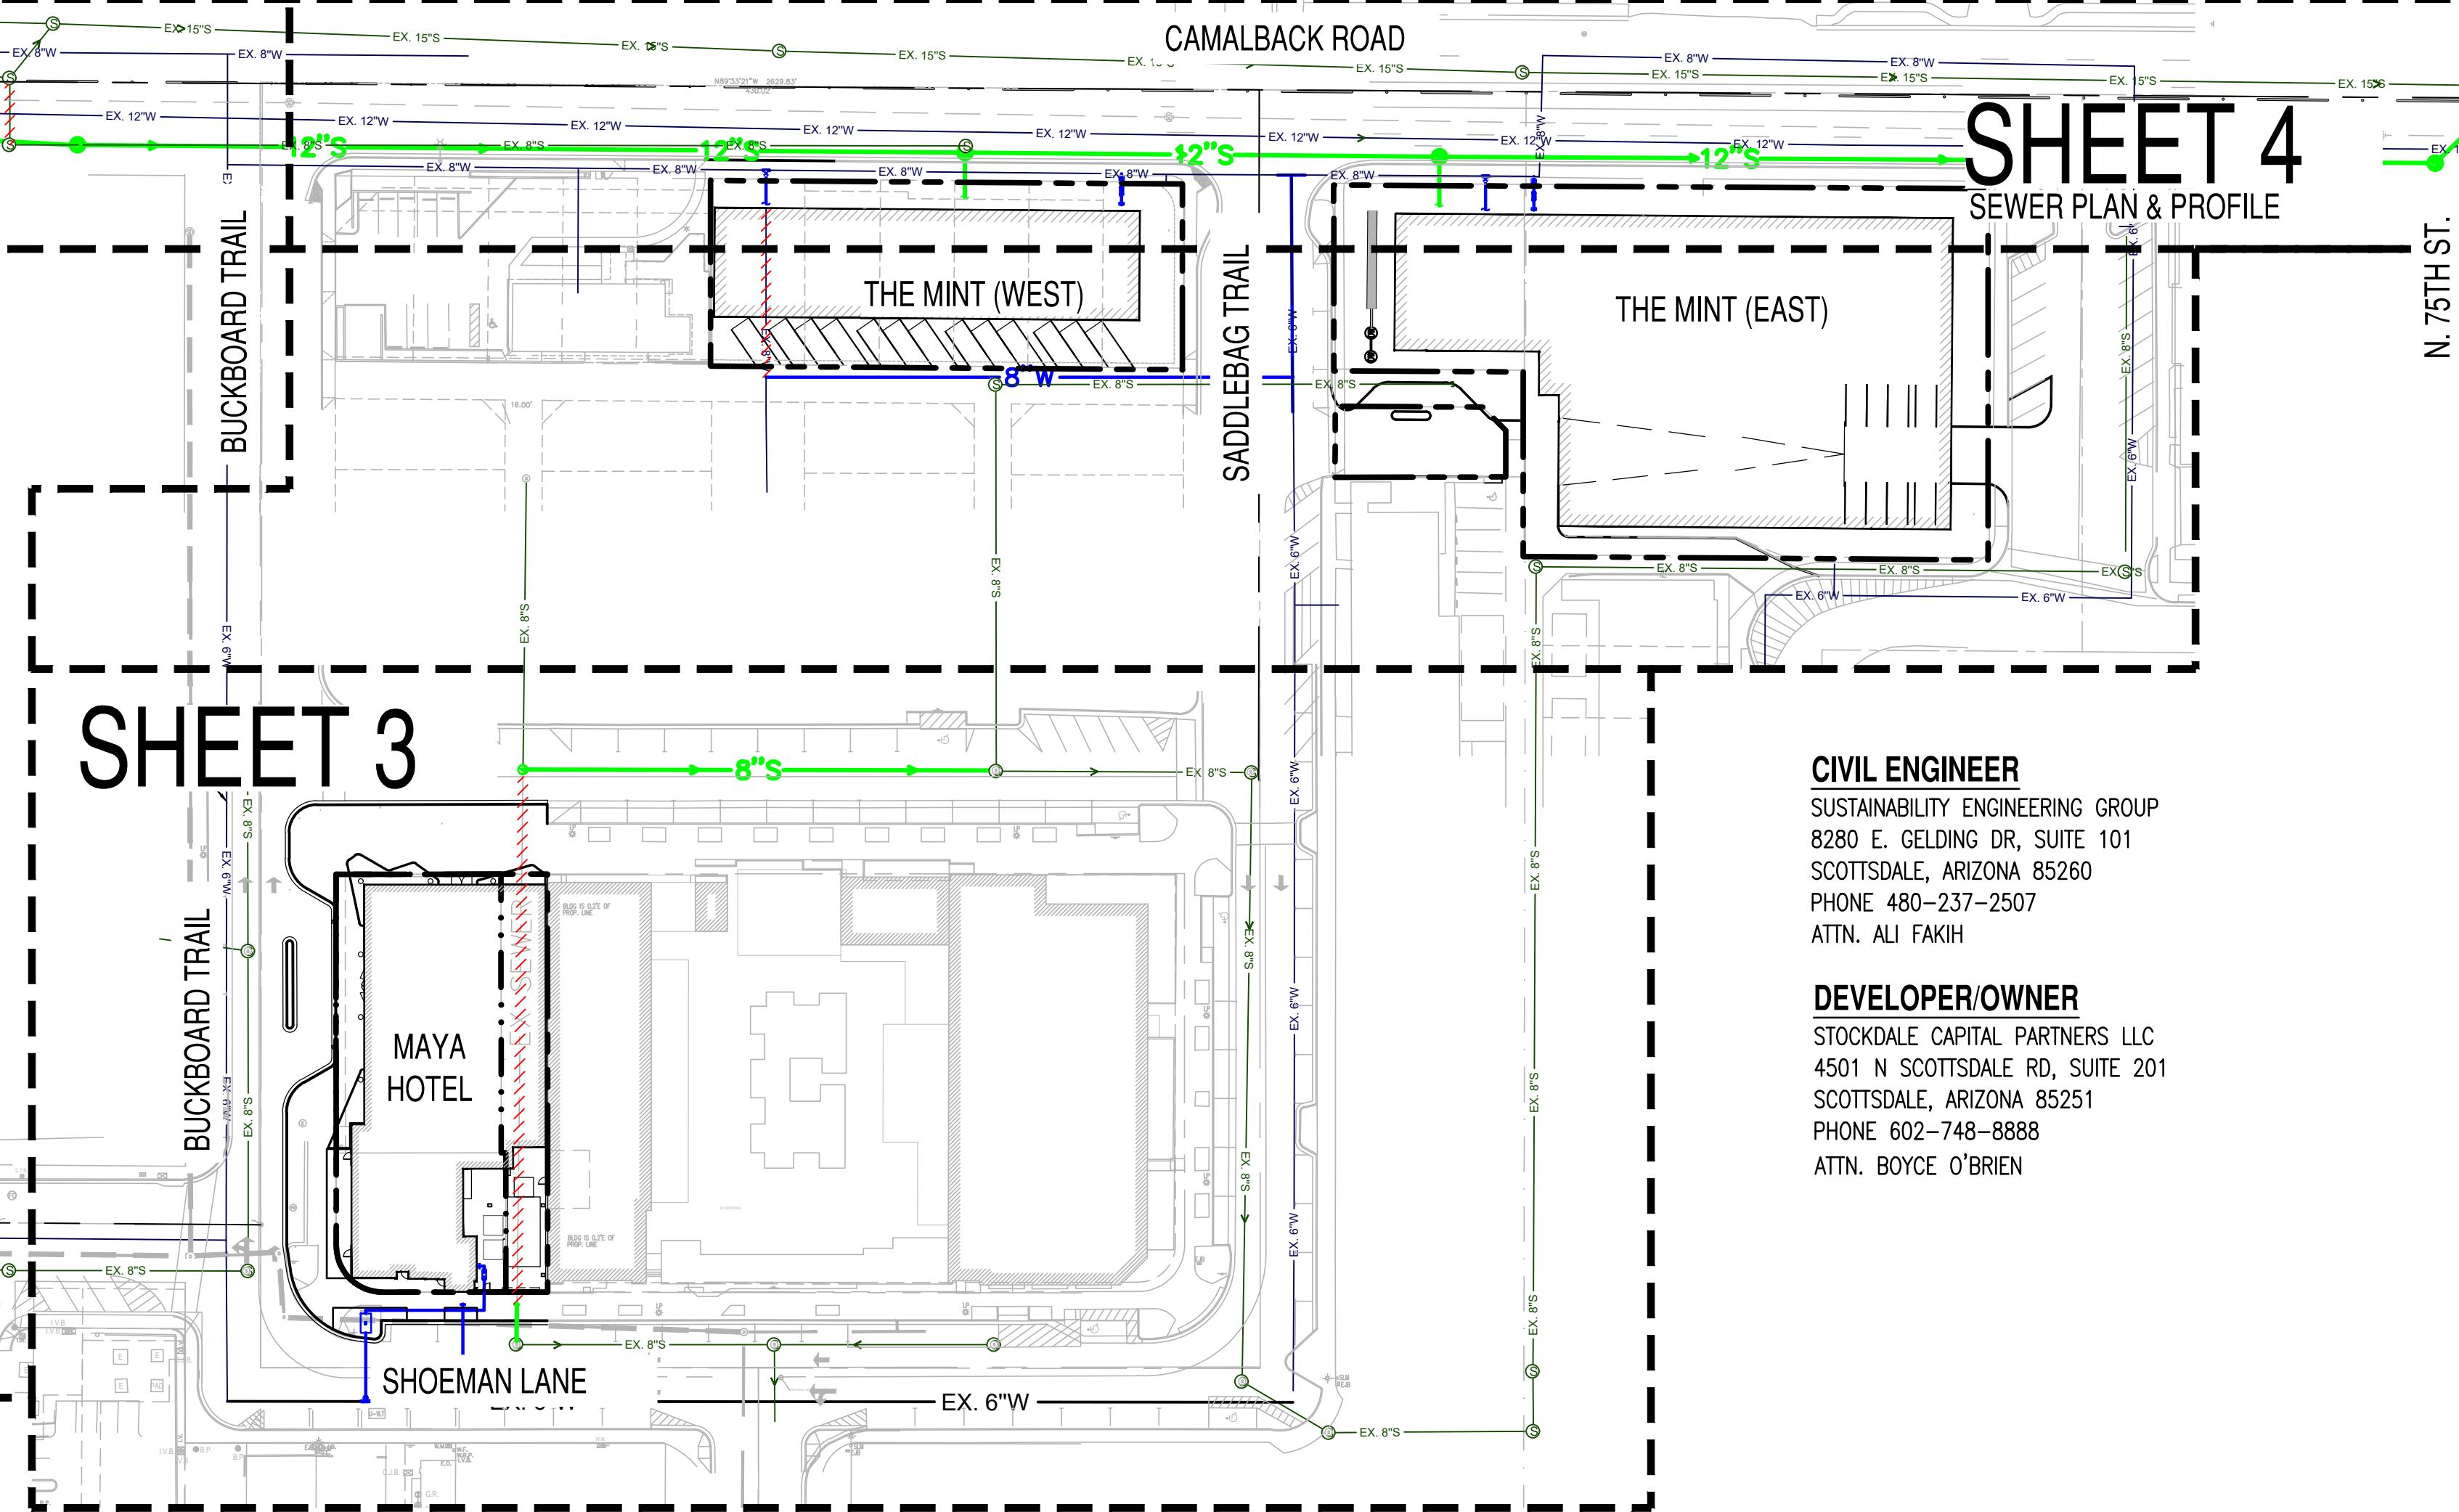

SHEET 4
SEWER PLAN & PROFILE

N. 75TH ST.

CIVIL ENGINEER
SUSTAINABILITY ENGINEERING GROUP
8280 E. GELDING DR, SUITE 101
SCOTTSDALE, ARIZONA 85260
PHONE 480-237-2507
ATTN. ALI FAKIH

DEVELOPER/OWNER
STOCKDALE CAPITAL PARTNERS LLC
4501 N SCOTTSDALE RD, SUITE 201
SCOTTSDALE, ARIZONA 85251
PHONE 602-748-8888
ATTN. BOYCE O'BRIEN

SUSTAINABILITY
ENGINEERING
GROUP



8280 E. GELDING DRIVE SUITE 101 SCOTTSDALE, ARIZONA 85260
WWW.AZSEG.COM TEL: 480-388-7226 FAX: 480-389-3534

THIS DRAWING IS AN INSTRUMENT OF SERVICE AND THE PROPERTY OF SUSTAINABILITY ENGINEERING GROUP, AND SHALL REMAIN THEIR PROPERTY. THE USE OF THIS DRAWING SHALL BE RESTRICTED TO THE ORIGINAL SITE FOR WHICH IT IS PREPARED AND PUBLICATION THEREOF IS EXPRESSLY LIMITED TO SUCH USE.

NOTE:


- MANHOLES 1 AND 2 RIMS HAS BEEN SET BASED ON THE SURVEY RECEIVED FROM MLC SERVICES,LLC.
- MANHOLES 3 THROUGH 7 RIMS HAS BEEN SET BASED ON QUARTER SECTION MAP.
- EXISTING MANHOLE AT THE CONNECTION POINT INVERTS AND RIM WAS SET BASED ON QUARTER SECTION MAP.

EXISTING LEGEND

— EX. S —	SEWER LINE
— EX. W —	WATER LINE
— IRR —	IRRIGATION LINE
— CB —	STORM DRAIN LINE
(S)	CATCH BASIN
(D)	SEWER MANHOLE
(WV)	STORM MANHOLE
(WMB)	WATER VALVE
(ECB)	WATER METER BOX
	ELECTRIC CABINET

PROPOSED LEGEND:

— — — —	PROPERTY LINE
— XW —	WATER LINE
— XS —	SEWER LINE
(WM)	WATER METER
(X)	GATE VALVE
(T.S.V.B.&C.)	T.S.V.B.&C.
(F)	BACK FLOW PREVENTER
(C)	CAP
(S)	SEWER MANHOLE
(Hatched)	WATER/SEWER LINE ABANDONMENT

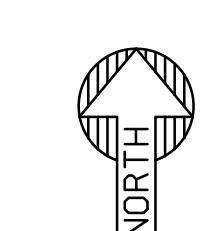

OVERALL UTILITY EXHIBIT & KEY MAP
SCALE: 1" = 60'


Call at least two full working days before you begin excavation.
ARIZONA 811
Arizona Blue Streak, Inc.

State 8-1-1 1-800-STAKE IT (782-8348)
In Maricopa County: (602) 233-1100

PROJECT	SCOTTSDALE COLLECTIVE	LOCATION
DRAWN	KA	04/28/2020
DESIGNED	KA	04/28/2020
QC	SC	
QA	AF	
PROJ. MGR.	AF	
DATE:	08/07/2020	
ISSUED FOR:	ZONING	
REVISION NO.:		
JOB NO.:	200226	
SHEET TITLE:	UTILITY EXHIBIT KEY MAP	
SHEET NO.:		

SHEET UPDATED 9/10/20,
SEE LAST PAGES OF
REPORT

CITY CENTER PRELIMINARY UTILITY EXHIBIT

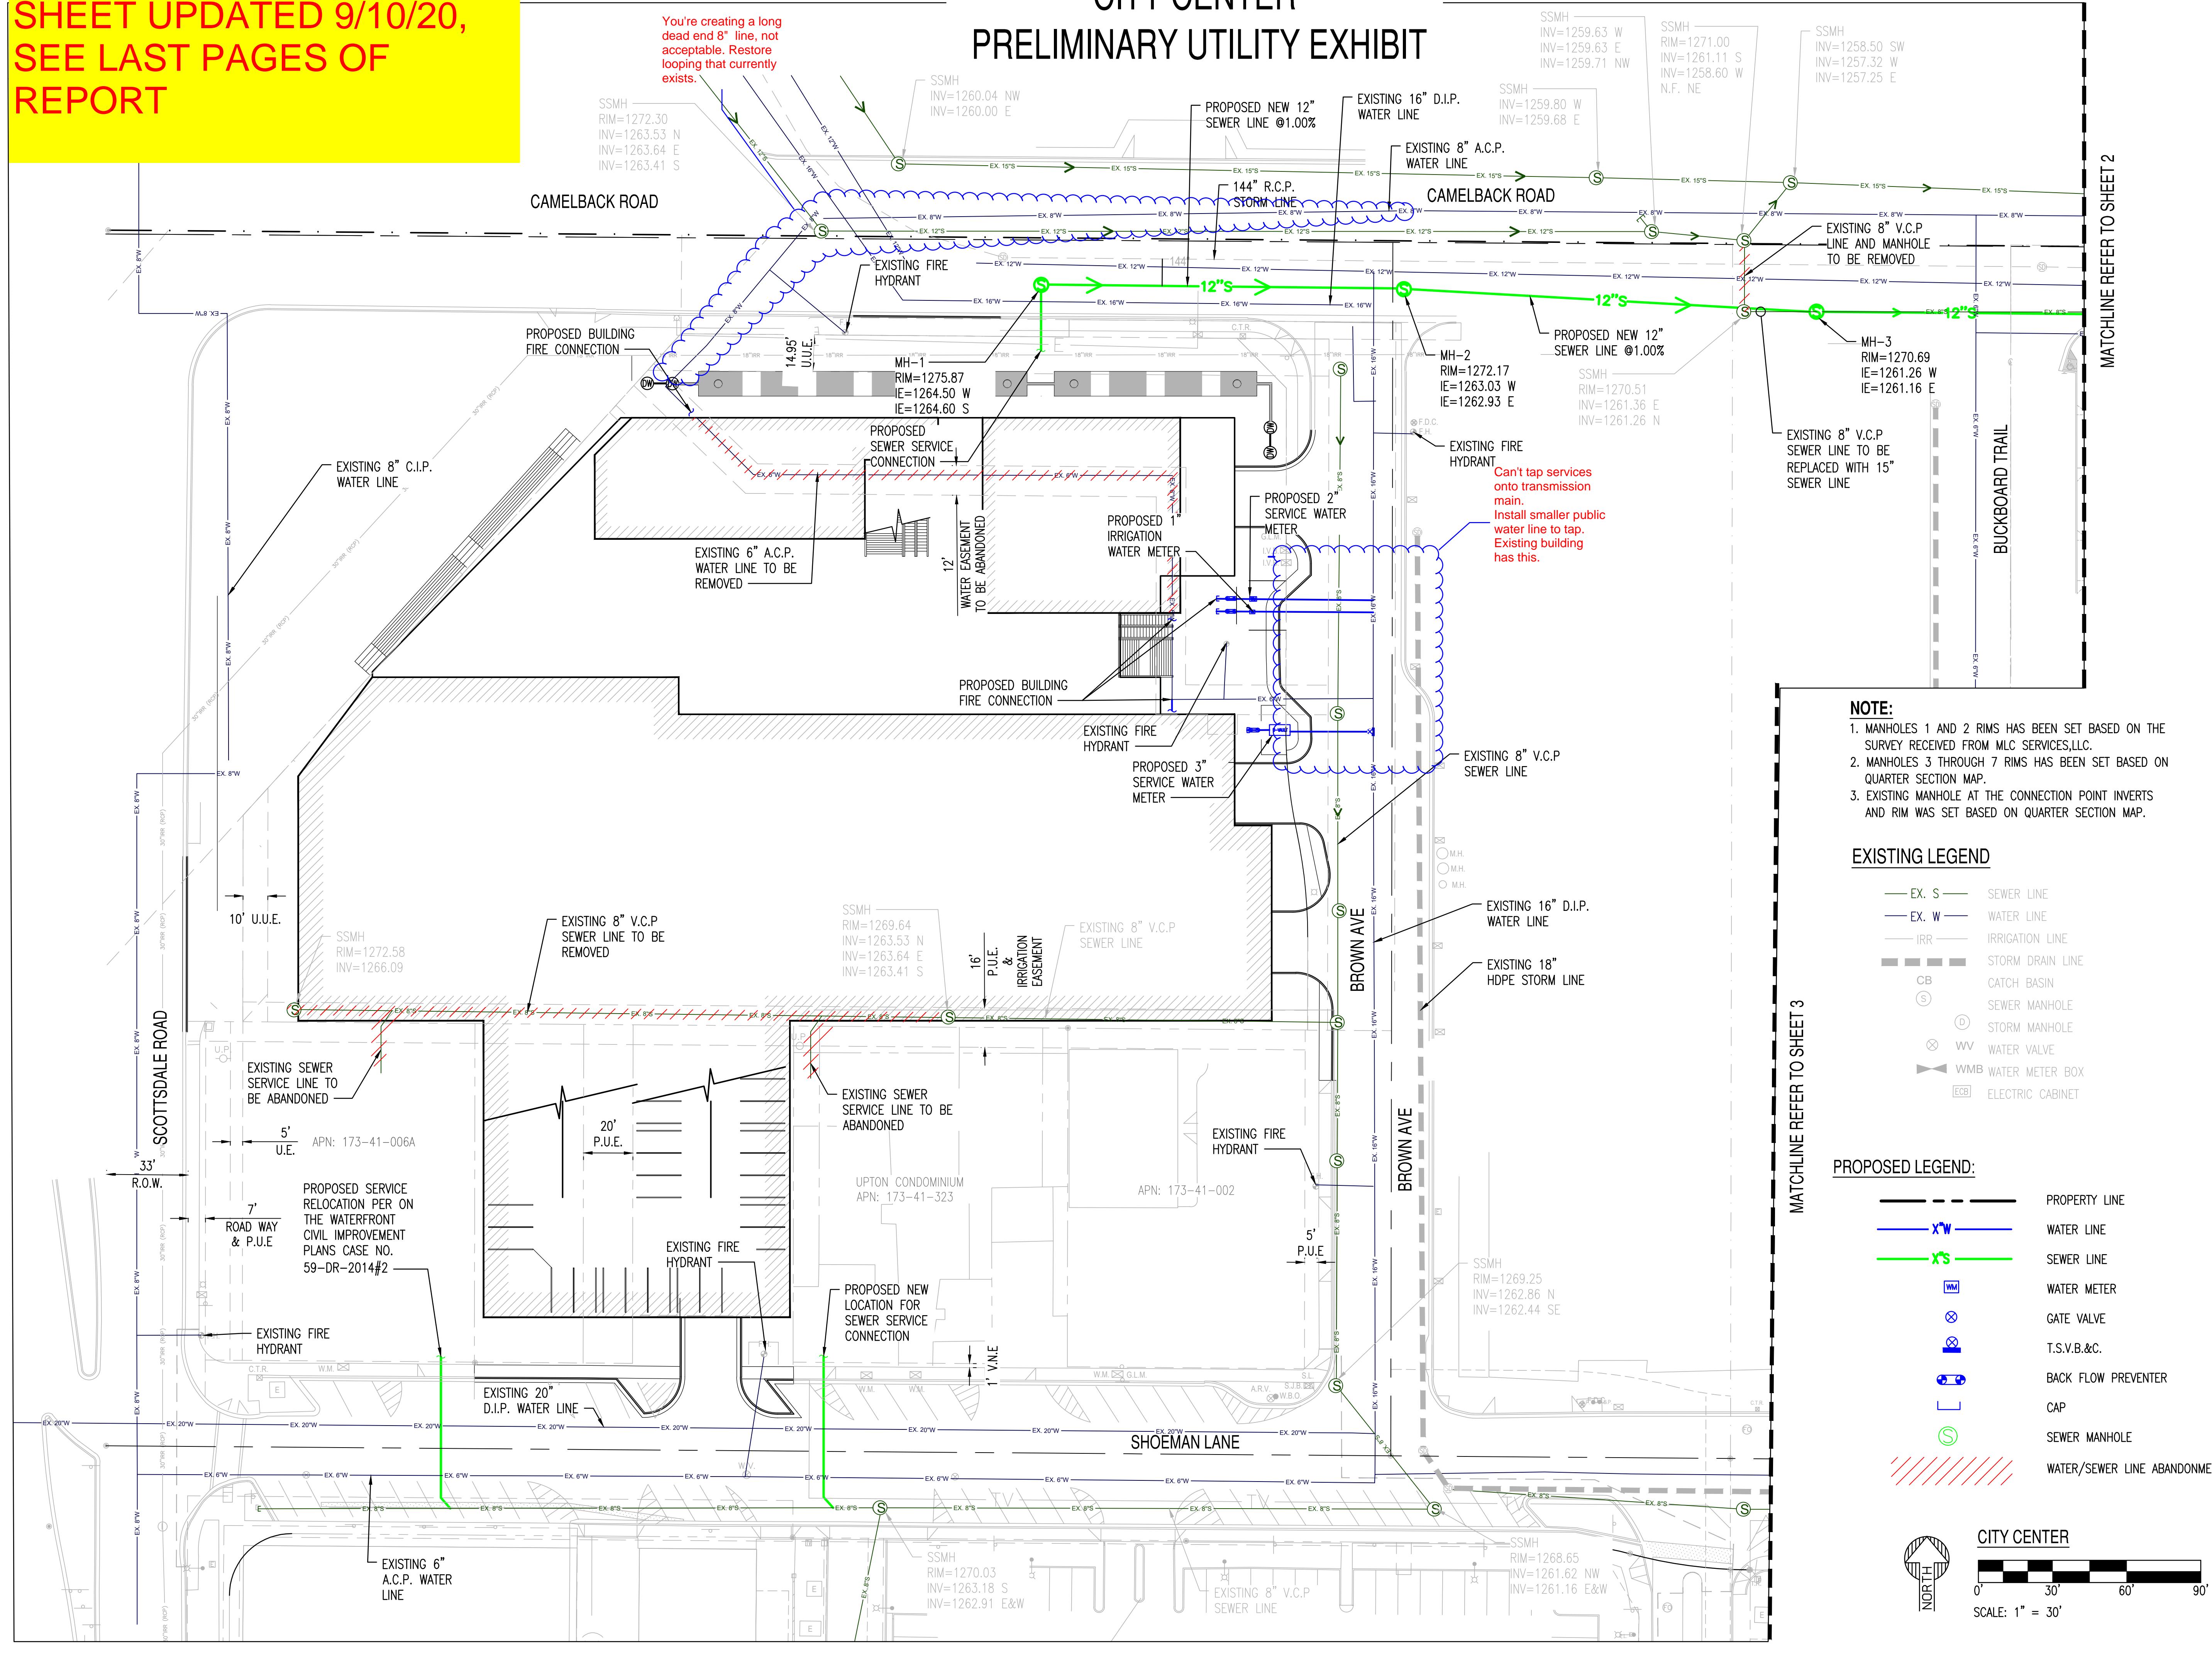

SUSTAINABILITY
ENGINEERING
GROUP



820 E. GELING DRIVE SUITE 101 SCOTTSDALE ARIZONA 85260
WWW.AZSEG.COM TEL: 480.389.7226 FAX: 480.389.3534

THIS DRAWING IS AN INSTRUMENT OF SERVICE AND THE PROPERTY OF SUSTAINABILITY ENGINEERING GROUP, AND SHALL REMAIN THEIR PROPERTY. THE USE OF THIS DRAWING SHALL BE RESTRICTED TO THE ORIGINAL SITE FOR WHICH IT IS PREPARED AND PUBLICATION THEREOF IS EXPRESSLY LIMITED TO SUCH USE.

SHEET UPDATED 9/10/20,
SEE LAST PAGES OF
REPORT



THE MINT
PRELIMINARY UTILITY EXHIBIT

PRELIMINARY
NOT FOR
CONSTRUCTION

SUSTAINABILITY
ENGINEERING
GROUP

820 E. GELDING DRIVE SUITE 101 SCOTTSDALE ARIZONA 85260
WWW.V2SEG.COM TEL: 480-389-7226 FAX: 480-389-3534

THIS DRAWING IS AN INSTRUMENT OF SERVICE AND THE PROPERTY OF SUSTAINABILITY ENGINEERING GROUP, AND SHALL REMAIN THEIR PROPERTY. THE USE OF THIS DRAWING SHALL BE RESTRICTED TO THE ORIGINAL SITE FOR WHICH IT IS PREPARED AND PUBLICATION THEREOF IS EXPRESSLY LIMITED TO SUCH USE.

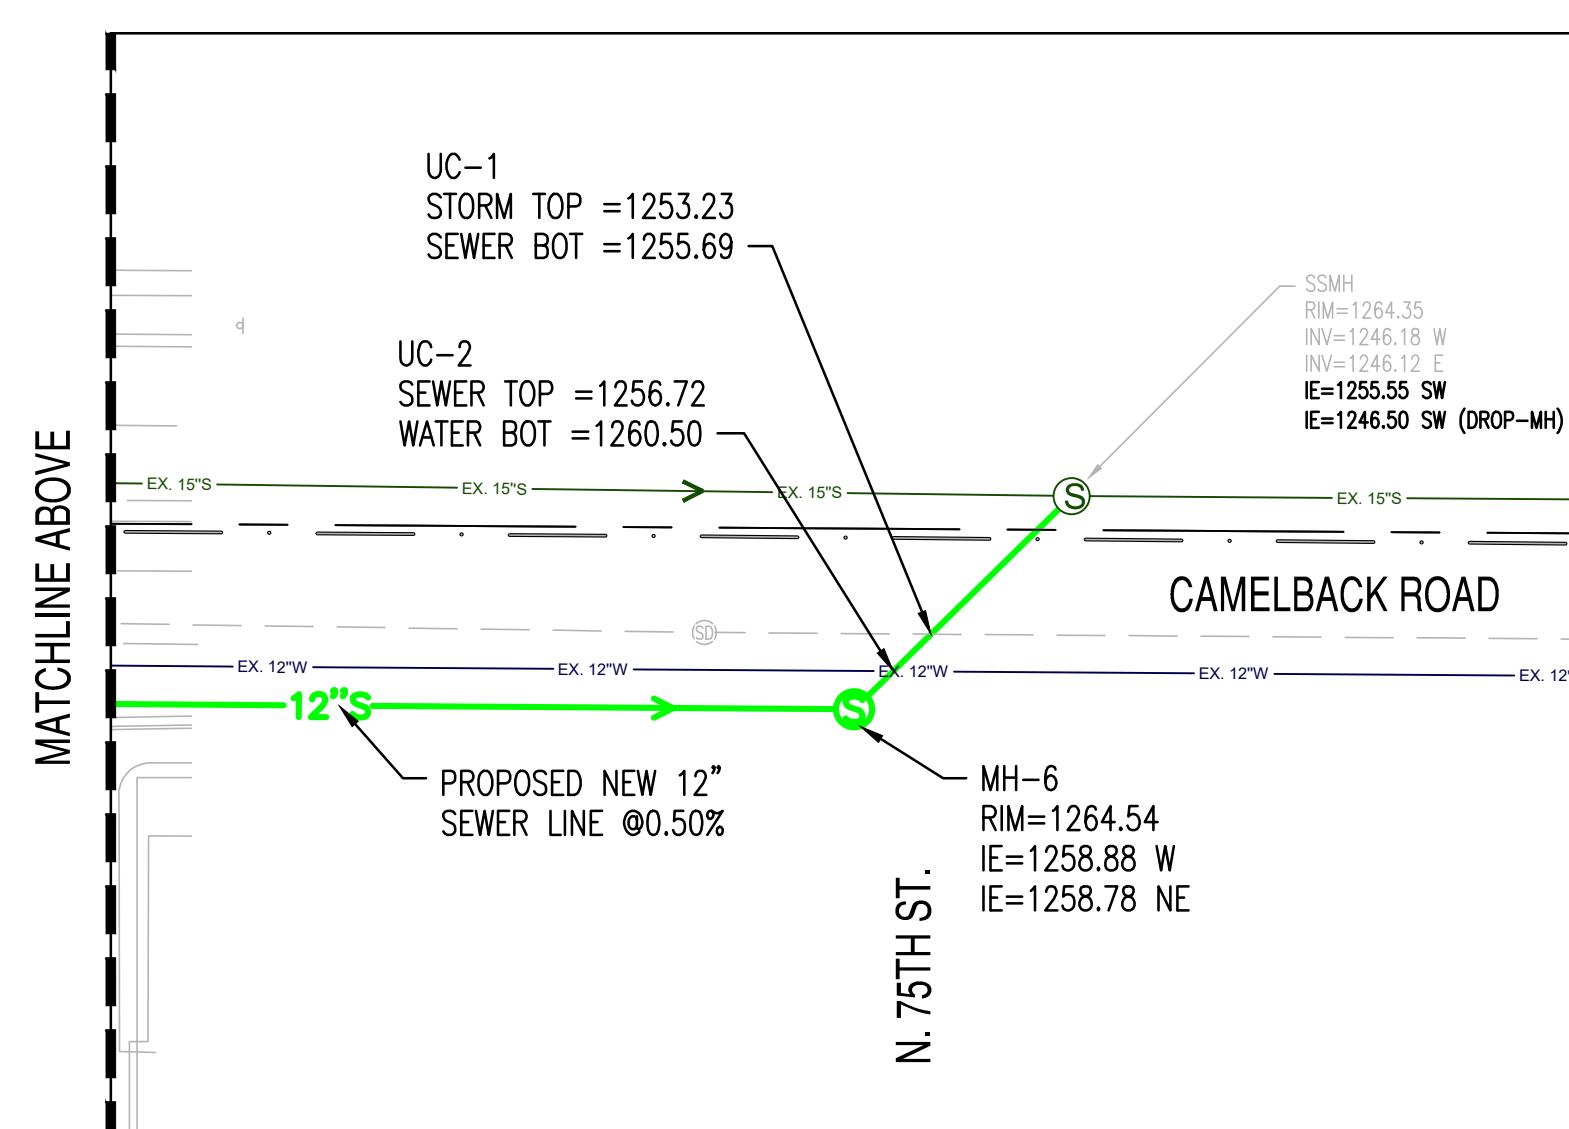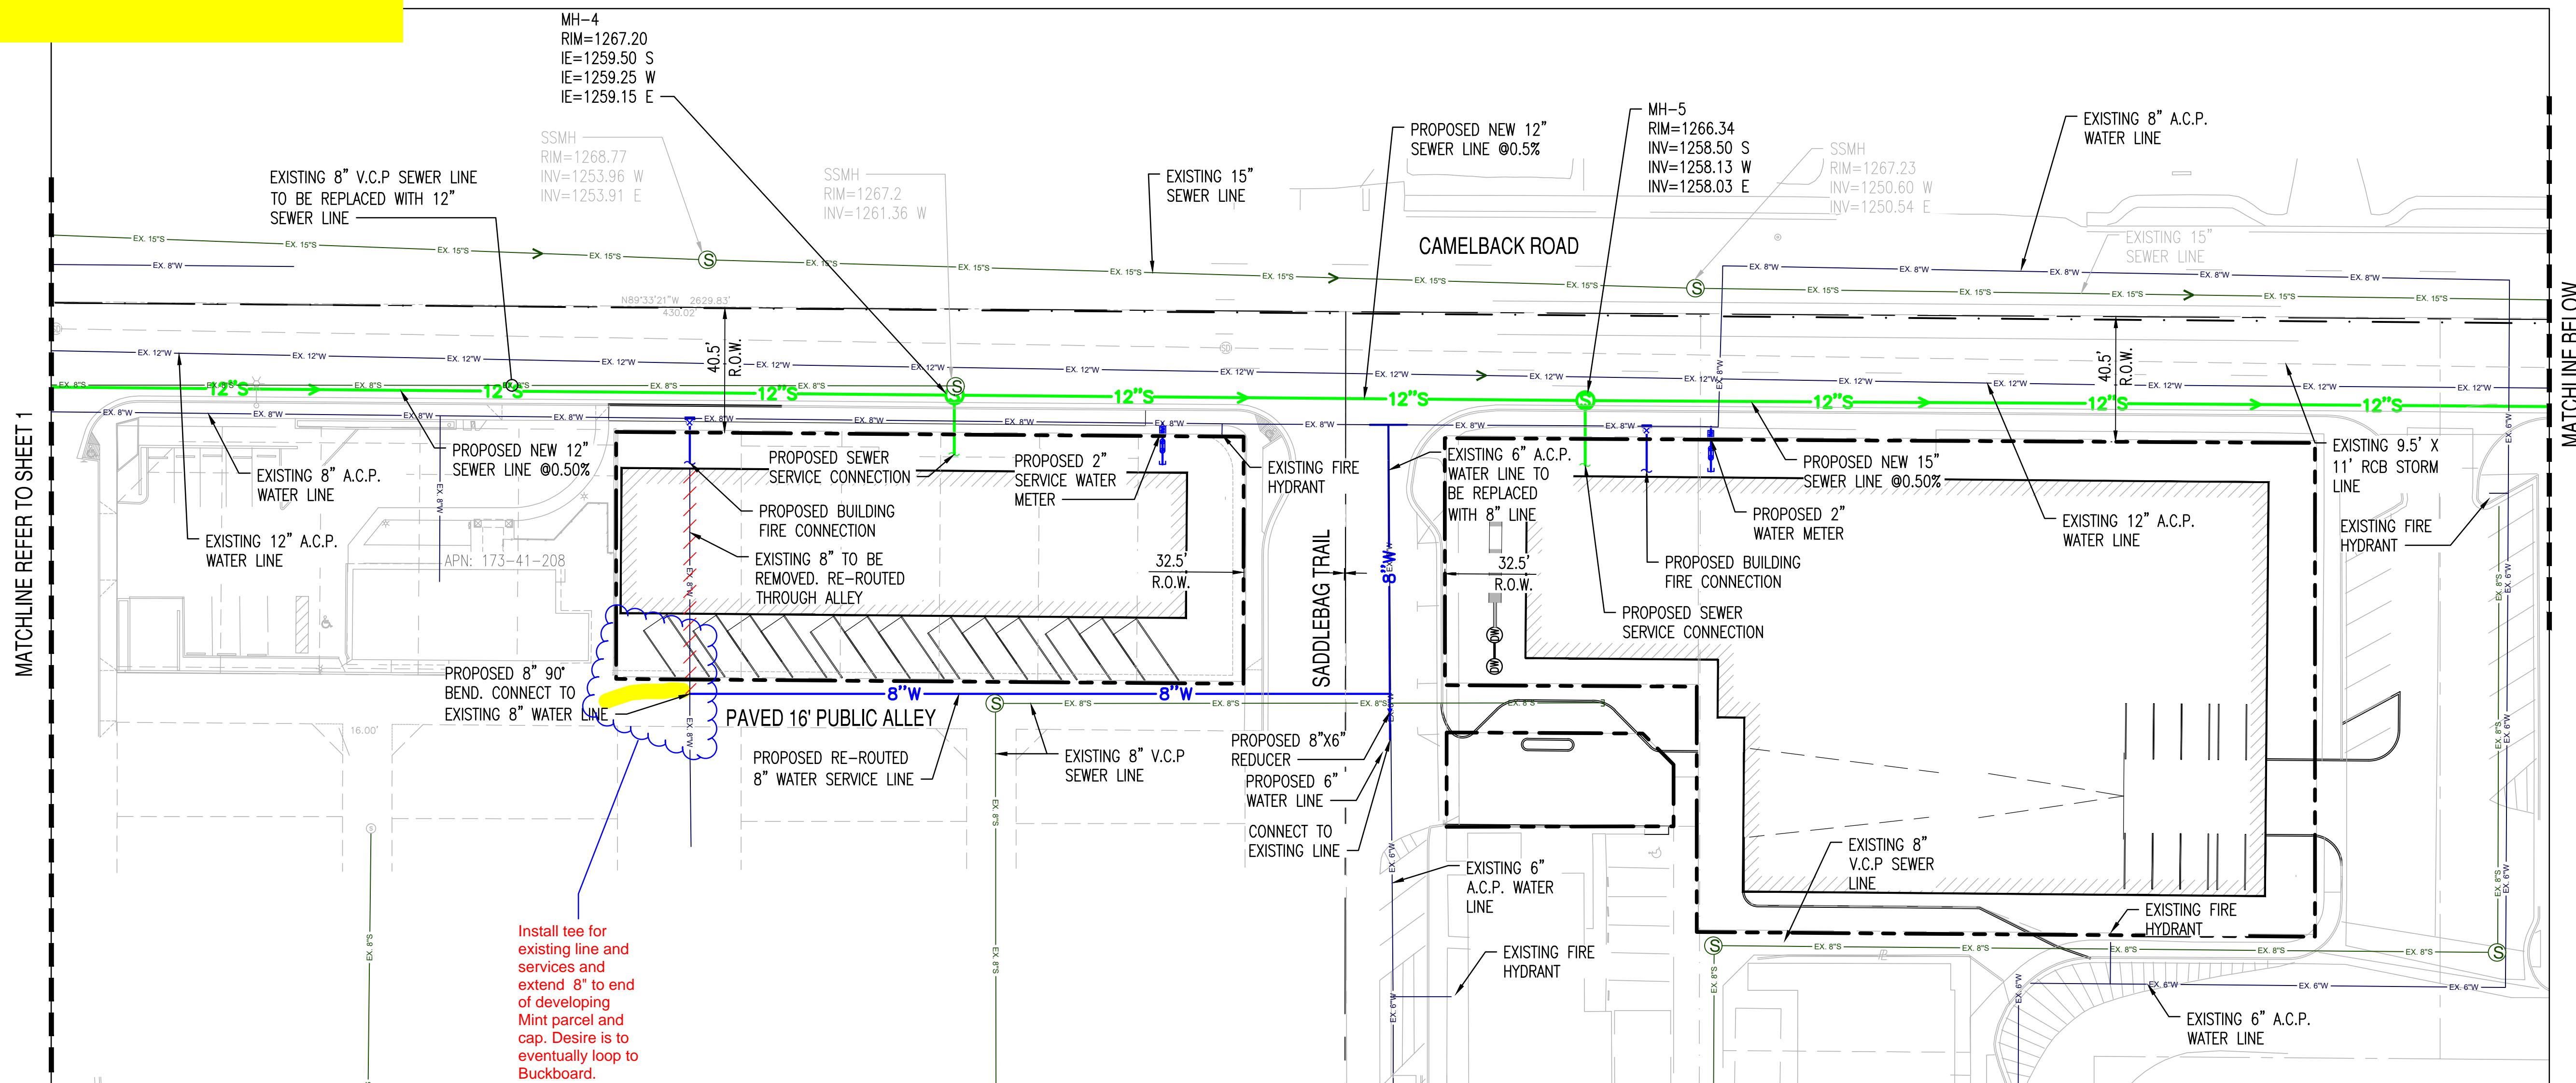

NOTE:


- MANHOLES 1 AND 2 RIMS HAS BEEN SET BASED ON THE SURVEY RECEIVED FROM MLC SERVICES,LLC.
- MANHOLES 3 THROUGH 7 RIMS HAS BEEN SET BASED ON QUARTER SECTION MAP.
- EXISTING MANHOLE AT THE CONNECTION POINT INVERTS AND RIM WAS SET BASED ON QUARTER SECTION MAP.

EXISTING LEGEND

EX. S	SEWER LINE
EX. W	WATER LINE
IRR	IRRIGATION LINE
CB	STORM DRAIN LINE
(S)	CATCH BASIN
(D)	SEWER MANHOLE
(X)	STORM MANHOLE
WV	WATER VALVE
WMB	WATER METER BOX
ECB	ELECTRIC CABINET

PROPOSED LEGEND:

—	PROPERTY LINE
XW	WATER LINE
XS	SEWER LINE
WM	WATER METER
(X)	GATE VALVE
(X)	T.S.V.B.&C.
[]	BACK FLOW PREVENTER
CAP	CAP
(S)	SEWER MANHOLE
	WATER/SEWER LINE ABANDONMENT

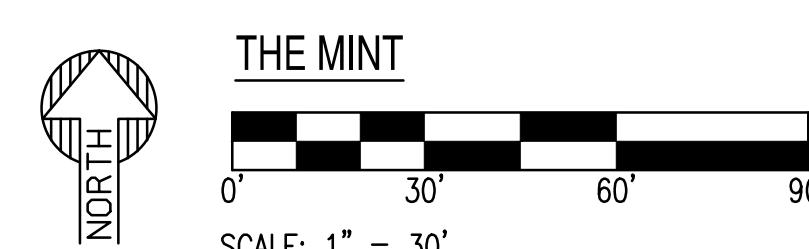

PROJECT
THE MINT

LOCATION
CAMELBACK RD &
SADDLEBAG TRAIL

DRAWN	KA	04/28/2020
DESIGNED	SC	04/28/2020
QC	AF	
QA	AF	
PROJ. MGR.	AF	
DATE:	08/07/2020	
ISSUED FOR:	PRELIMINARY REVIEW	
REVISION NO.:		
JOB NO.:	200226	
SHEET TITLE:	UTILITY EXHIBIT	
SHEET NO.:		

SHEET UPDATED 9/10/20,
SEE LAST PAGES OF
REPORT

MAYA HOTEL PRELIMINARY UTILITY EXHIBIT


PRELIMINARY
NOT FOR
CONSTRUCTION

SUSTAINABILITY
ENGINEERING
GROUP



820 E. GELDING DRIVE SUITE 101 SCOTTSDALE ARIZONA 85260
WWW.AZSEG.COM TEL: 480.388.7226 FAX: 480.389.3534

THIS DRAWING IS AN INSTRUMENT OF SERVICE AND THE PROPERTY OF SUSTAINABILITY ENGINEERING GROUP, AND SHALL REMAIN THEIR PROPERTY. THE USE OF THIS DRAWING SHALL BE RESTRICTED TO THE ORIGINAL SITE FOR WHICH IT IS PREPARED AND PUBLICATION THEREOF IS EXPRESSLY LIMITED TO SUCH USE.

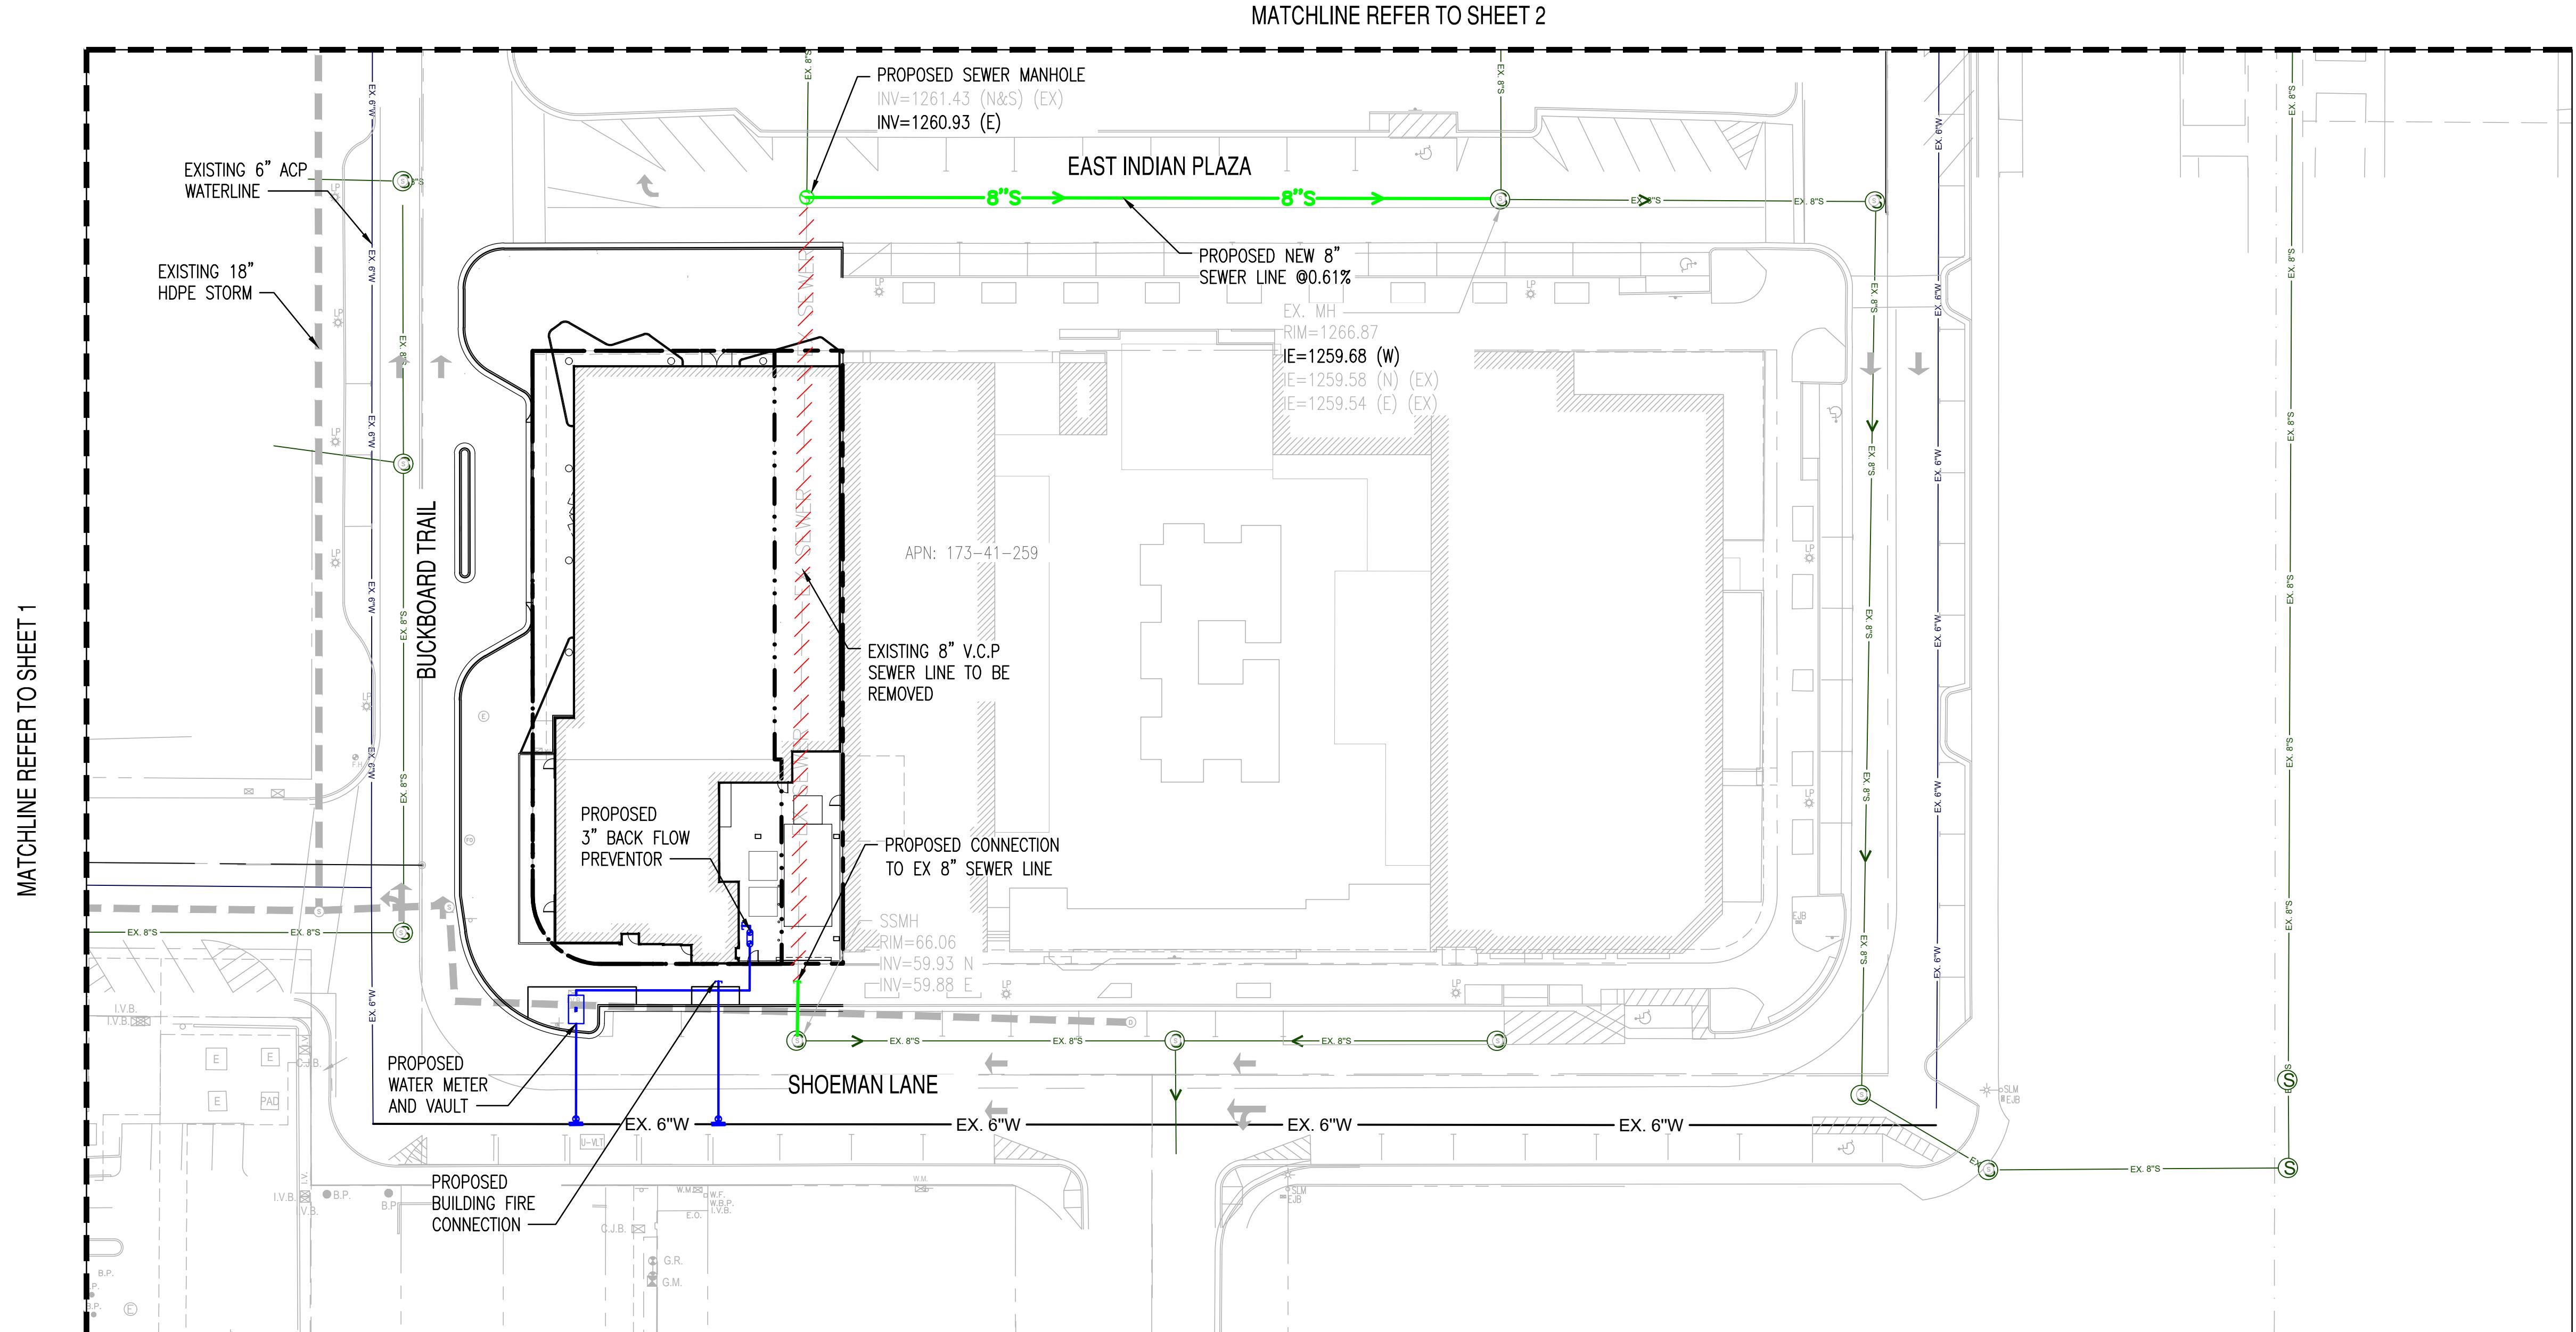


EXISTING LEGEND

- EX. S — SEWER LINE
- EX. W — WATER LINE
- IRR — IRRIGATION LINE
- CB — STORM DRAIN LINE
- CB — CATCH BASIN
- S — SEWER MANHOLE
- D — STORM MANHOLE
- WV — WATER VALVE
- WMB — WATER METER BOX
- ECB — ELECTRIC CABINET

PROPOSED LEGEND:

- — — PROPERTY LINE
- XW — WATER LINE
- XS — SEWER LINE
- WM — WATER METER
- G — GATE VALVE
- TSVB&C — T.S.V.B.&C.
- BFP — BACK FLOW PREVENTER
- C — CAP
- SM — SEWER MANHOLE
- / — WATER/SEWER LINE ABANDONMENT

MAYA HOTEL

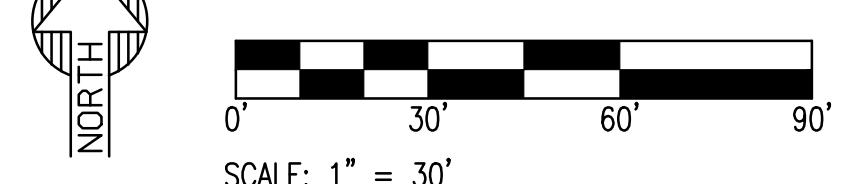



Call at least two full working days before you begin excavation.
ARIZONA 811
Arizona Blue Streak, Inc.
8-1-1 1-800-STAKE IT (782-5348)
In Maricopa County: (602) 255-1100

PROJECT	LOCATION
MAYA HOTEL	NWC EAST INDIAN PLAZA & BUCKBOARD TRAIL

DRAWN	KA	04/28/2020
DESIGNED	SC	04/28/2020
QC	AF	
QA	AF	
PROJ. MGR.	AF	
DATE:		08/07/2020
ISSUED FOR:		PRELIMINARY REVIEW
REVISION NO.:		
JOB NO.:		200226
SHEET TITLE:		UTILITY EXHIBIT
SHEET NO.:		

SHEET UPDATED 9/10/20,
SEE LAST PAGES OF
REPORT

PRELIMINARY
NOT FOR
CONSTRUCTION

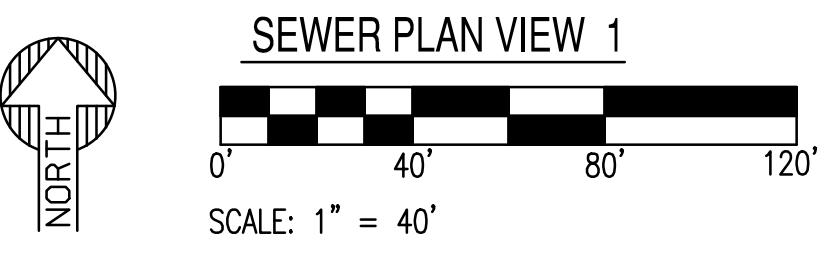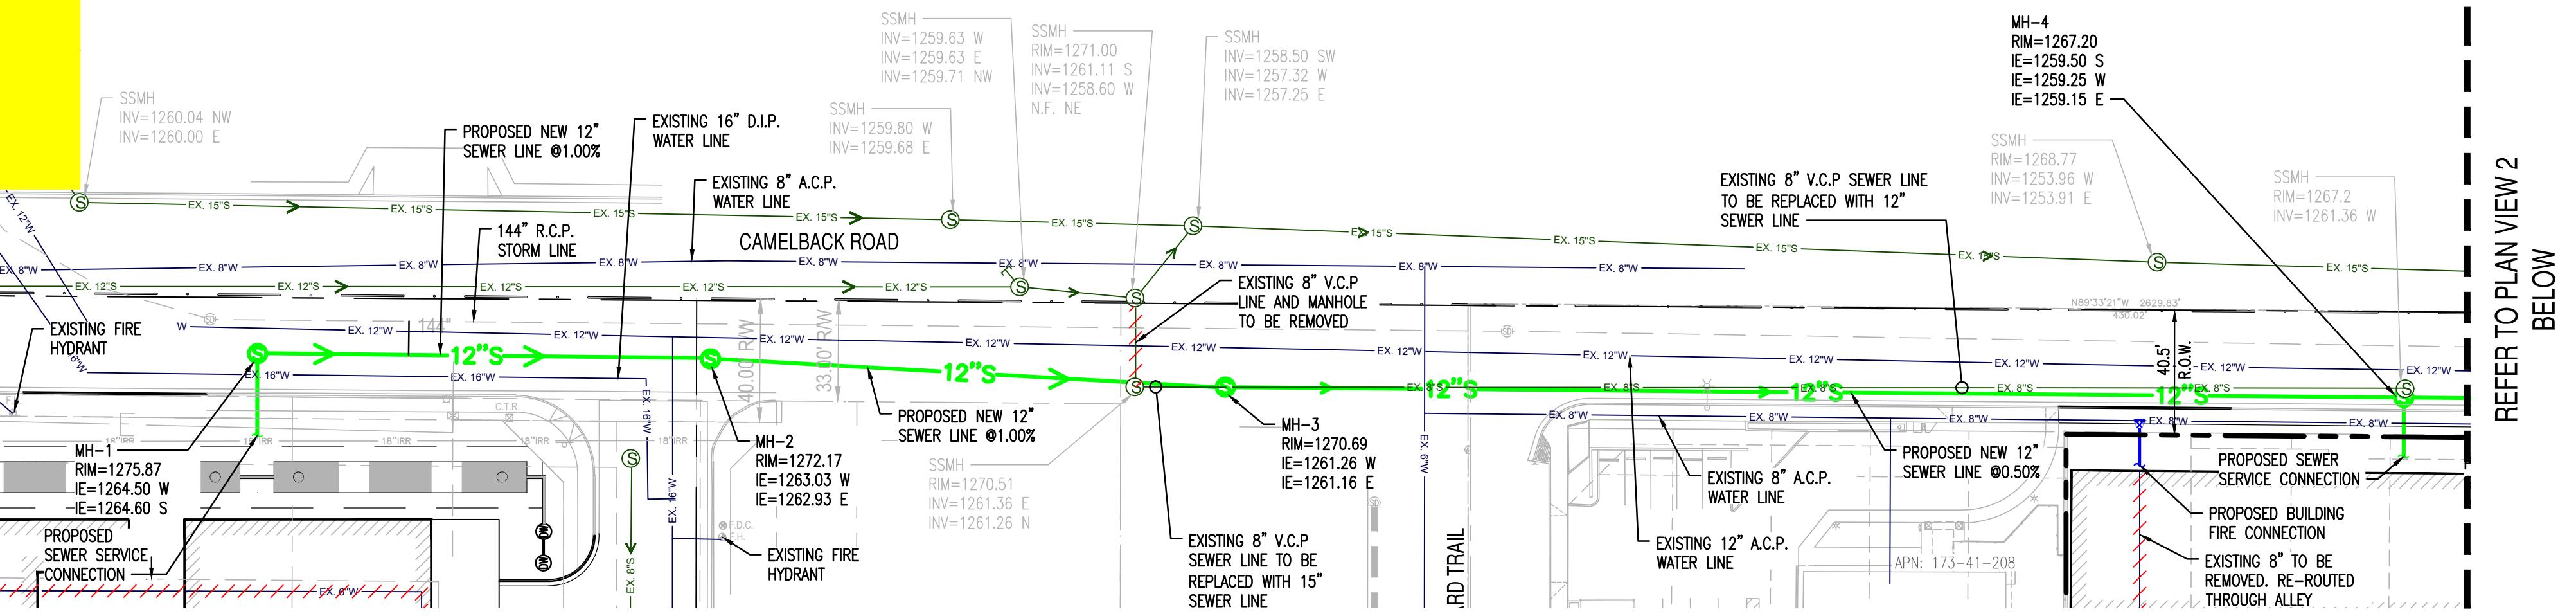

- NOTE:**
- MANHOLES 1 AND 2 RIMS HAS BEEN SET BASED ON THE SURVEY RECEIVED FROM MLC SERVICES, LLC.
 - MANHOLES 3 THROUGH 7 RIMS HAS BEEN SET BASED ON QUARTER SECTION MAP.
 - EXISTING MANHOLE AT THE CONNECTION POINT INVERTS AND RIM WAS SET BASED ON QUARTER SECTION MAP.


EXISTING LEGEND

— EX. S —	SEWER LINE
— EX. W —	WATER LINE
— IRR —	IRRIGATION LINE
CB	STORM DRAIN LINE
(S)	CATCH BASIN
(O)	SEWER MANHOLE
(WV)	STORM MANHOLE
(WMB)	WATER VALVE
(ECB)	WATER METER BOX
(ECB)	ELECTRIC CABINET

PROPOSED LEGEND:


— PROPERTY LINE —	PROPERTY LINE
— XW —	WATER LINE
— XS —	SEWER LINE
(WV)	WATER METER
(GV)	GATE VALVE
(TSVB&C.)	T.S.V.B.&C.
(BFP)	BACK FLOW PREVENTER
(C)	CAP
(S)	SEWER MANHOLE
(/)	WATER/SEWER LINE ABANDONMENT

REFER TO PLAN VIEW 1 ABOVE

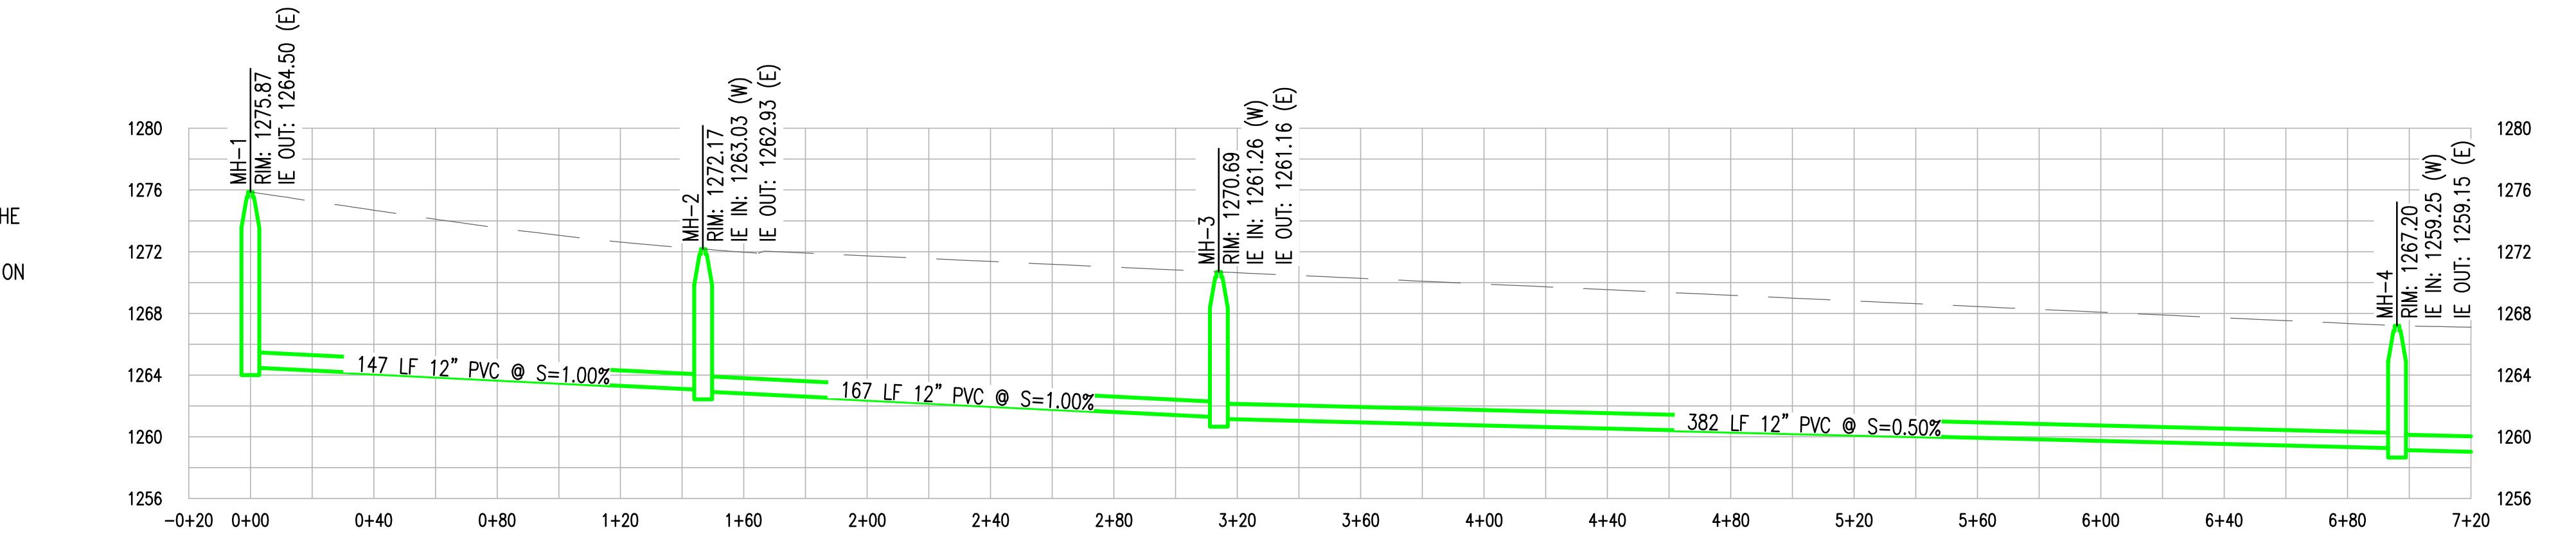


SEWER PROFILE VIEW 1

HORIZONTAL SCALE: 1" = 40'
VERTICAL SCALE: 1" = 4'

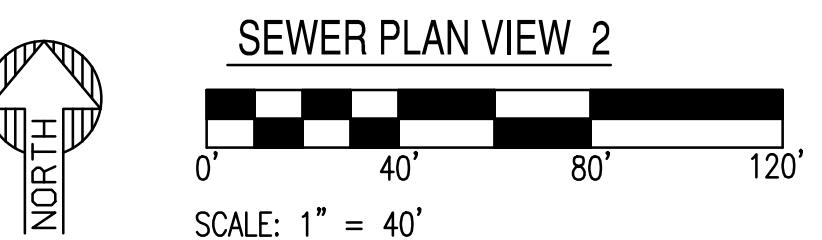


REFER TO PLAN VIEW 1 ABOVE

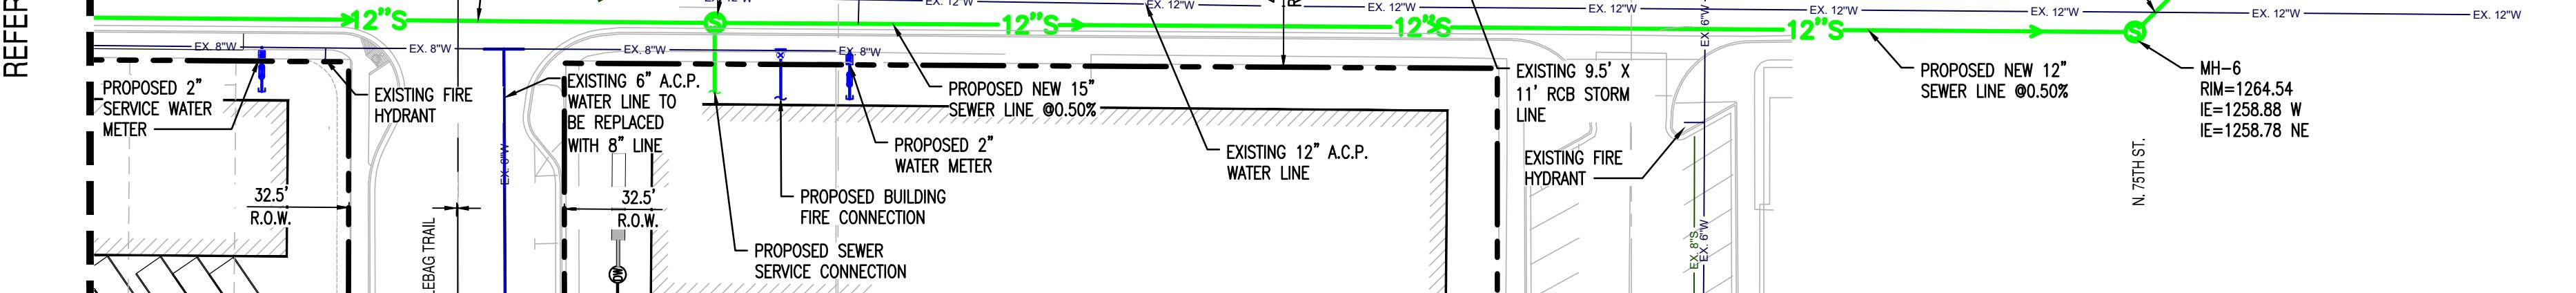

SEWER PROFILE VIEW 2

HORIZONTAL SCALE: 1" = 40'
VERTICAL SCALE: 1" = 4'

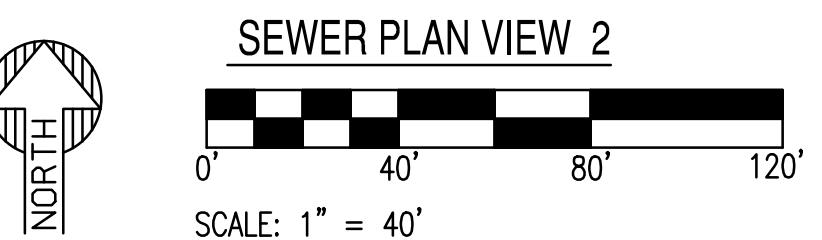

Call at least two full working days before you begin excavation.
ARIZONA 811
Arizona Blue Streak, Inc.
8-1-1 or 1-800-STAKE IT (825-8348)
In Maricopa County: (602) 255-1100

PROJECT: MAYA HOTEL
LOCATION: NW. EAST INDIAN PLAZA & BUCKBOARD TRAIL
DRAWN: KA 04/28/2020
DESIGNED: KA 04/28/2020
QC: SC
QA: AF
PROJ. MGR: AF
DATE: 08/07/2020
ISSUED FOR: PRELIMINARY REVIEW
REVISION NO.: DATE:
JOB NO.: 200226
SHEET TITLE: PROPOSED SEWER PLAN & PROFILE
SHEET NO.: 4

Arizona Flow Testing LLC

HYDRANT FLOW TEST REPORT

Project Name: Scottsdale Collective-City Center
Project Address: Brown Ave. & Shoeman Lane (NWC), Scottsdale, Arizona, 85251
Client Project No.: Not Provided
Arizona Flow Testing Project No.: 20137A
Flow Test Permit No.: C61868
Date and time flow test conducted: April 13, 2020 at 6:55 AM
Data is current and reliable until: October 13, 2020
Conducted by: Floyd Vaughan - Arizona Flow Testing, LLC (480-250-8154)
Coordinated by: Ray Padilla -City of Scottsdale-Inspector (602-541-0586)

Raw Test Data

Static Pressure: **100.0 PSI**
(Measured in pounds per square inch)

Residual Pressure: **90.0 PSI**
(Measured in pounds per square inch)

Pitot Pressure: **33.0 PSI**
(Measured in pounds per square inch)

Diffuser Orifice Diameter: One 4-inch Pollard Diffuser
(Measured in inches)

Coefficient of Diffuser: 0.9

Flowing GPM: **2,468 GPM**
(Measured in gallons per minute)

GPM @ 20 PSI: **7,587 GPM**

Data with 28 PSI Safety Factor

Static Pressure: **72.0 PSI**
(Measured in pounds per square inch)

Residual Pressure: **62.0 PSI**
(Measured in pounds per square inch)

Distance between hydrants: Approx.: 250 feet

Main size: Not Provided

Flowing GPM: **2,468 GPM**

GPM @ 20 PSI: **6,013 GPM**

Flow Test Location

North ↑



FH Test for City Center at Brown Avenue and Shoeman Lane



| PACKAGED ENCLOSURES | PUMPS | APPS | BLOG | CONTACT



Logarithmic Graph of Water Supply

Summary: This app provides a $N^{1.85}$ logarithmic graph based on NFPA 291 recommendations. We also offer a blank PDF logarithmic flow test sheet.


Graph Points

100	Static Pressure
90	Residual Pressure
2468	Residual Flow

Data Points

Flow	Pressure
4303.388	72

Flow Test

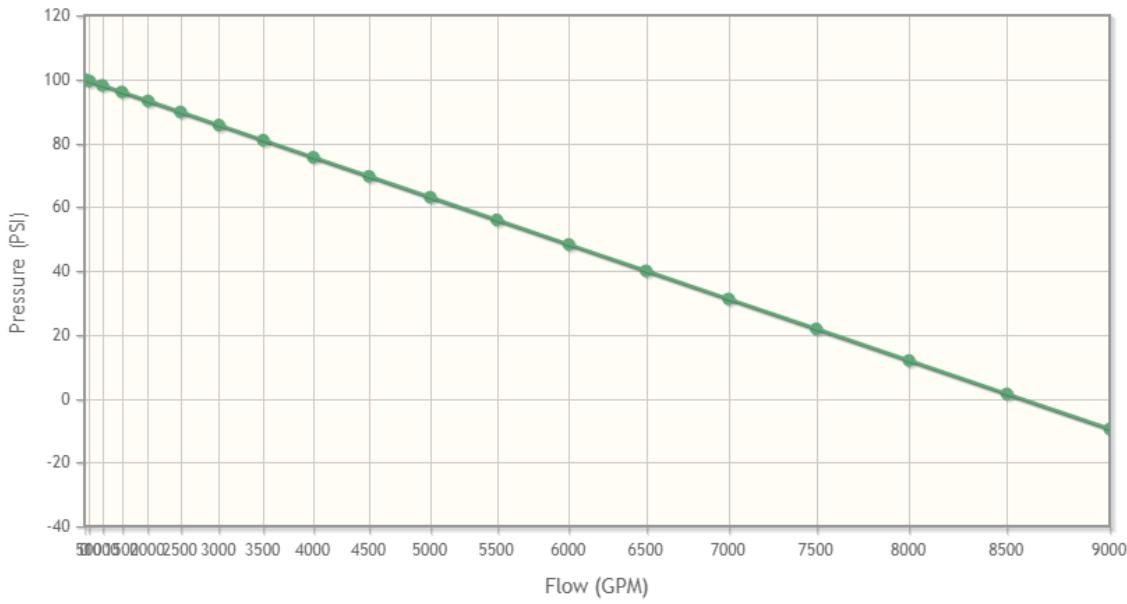

Arizona Flow Testing LLC

HYDRANT FLOW TEST REPORT

Project Name: Scottsdale Collective-Maya
Project Address: Buckboard Ave. & Shoeman (NEC), Scottsdale, Arizona, 85251
Client Project No.: Not Provided
Arizona Flow Testing Project No.: 20137B
Flow Test Permit No.: C61869
Date and time flow test conducted: April 13, 2020 at 7:05 AM
Data is current and reliable until: October 13, 2020
Conducted by: Floyd Vaughan - Arizona Flow Testing, LLC (480-250-8154)
Coordinated by: Ray Padilla -City of Scottsdale-Inspector (602-541-0586)

Raw Test Data

Static Pressure: **102.0 PSI**
(Measured in pounds per square inch)

Residual Pressure: **84.0 PSI**
(Measured in pounds per square inch)

Pitot Pressure: **37.0 PSI**
(Measured in pounds per square inch)

Diffuser Orifice Diameter: One 4-inch Pollard Diffuser
(Measured in inches)

Coefficient of Diffuser: 0.9

Flowing GPM: **2,614 GPM**
(Measured in gallons per minute)

GPM @ 20 PSI: **5,928 GPM**

Data with 30 PSI Safety Factor

Static Pressure: **72.0 PSI**
(Measured in pounds per square inch)

Residual Pressure: **54.0 PSI**
(Measured in pounds per square inch)

Distance between hydrants: Approx.: 340 feet


Main size: Not Provided

Flowing GPM: **2,614 GPM**

GPM @ 20 PSI: **4,635 GPM**

Flow Test Location

North ↑

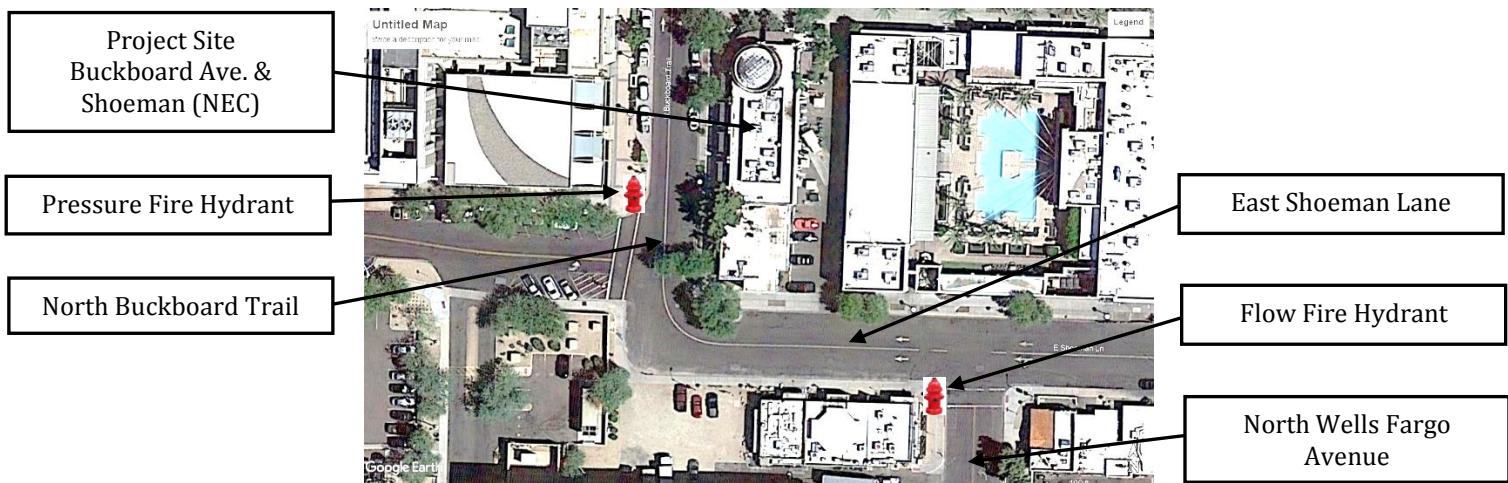

FH Test for The Maya at Buckboard Avenue and Shoeman Lane



| PACKAGED ENCLOSURES | PUMPS | APPS | BLOG | CONTACT



Logarithmic Graph of Water Supply

Summary: This app provides a N^{1.85} logarithmic graph based on NFPA 291 recommendations. We also offer a blank PDF logarithmic flow test sheet.


Graph Points

- 102 Static Pressure
- 84 Residual Pressure
- 2614 Residual Flow

Data Points

- | Flow | Pressure |
|----------|----------|
| 3444.323 | 72 |

Flow Test

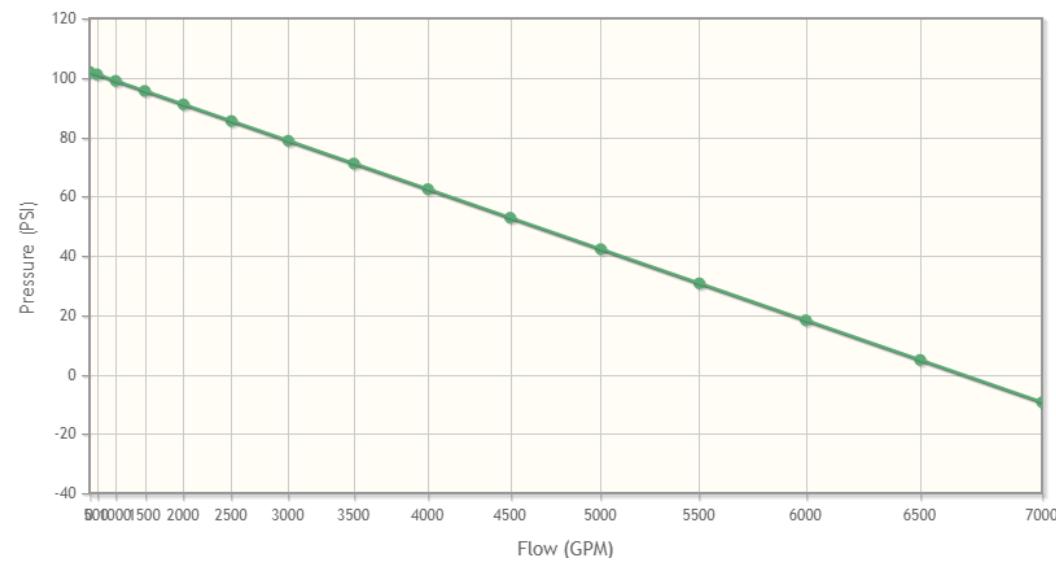

Arizona Flow Testing LLC

HYDRANT FLOW TEST REPORT

Project Name: Scottsdale Collective-Mint
Project Address: Civic Center Plaza & Indian Plaza (NWC), Scottsdale, Arizona 85251
Client Project No.: Not Provided
Arizona Flow Testing Project No.: 20137C
Flow Test Permit No.: C61870
Date and time flow test conducted: April 13, 2020 at 7:15 AM
Data is current and reliable until: October 13, 2020
Conducted by: Floyd Vaughan - Arizona Flow Testing, LLC (480-250-8154)
Coordinated by: Ray Padilla -City of Scottsdale-Inspector (602-541-0586)

Raw Test Data

Static Pressure: **104.0 PSI**
(Measured in pounds per square inch)

Residual Pressure: **80.0 PSI**
(Measured in pounds per square inch)

Pitot Pressure: **34.0 PSI**
(Measured in pounds per square inch)

Diffuser Orifice Diameter: One 4-inch Pollard Diffuser
(Measured in inches)

Coefficient of Diffuser: 0.9

Flowing GPM: **2,506 GPM**
(Measured in gallons per minute)

GPM @ 20 PSI: **4,928 GPM**

Data with 32 PSI Safety Factor

Static Pressure: **72.0 PSI**
(Measured in pounds per square inch)

Residual Pressure: **48.0 PSI**
(Measured in pounds per square inch)

Distance between hydrants: Approx.: 290 feet


Main size: Not Provided

Flowing GPM: **2,506 GPM**

GPM @ 20 PSI: **3,804 GPM**

Flow Test Location

North ↑

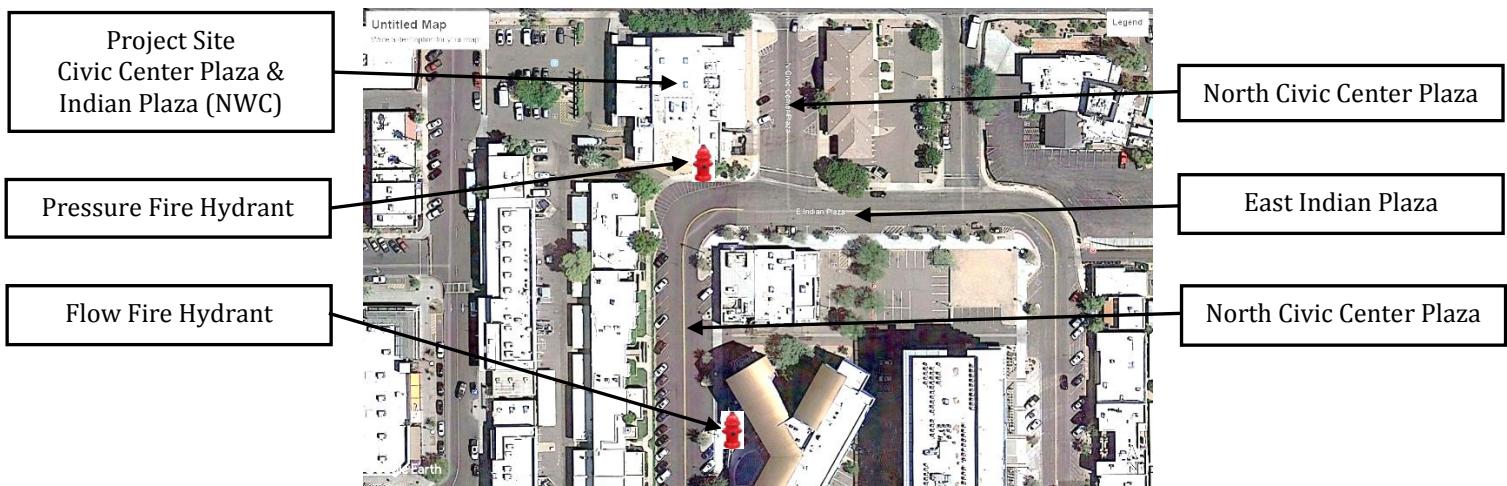

FH Test for The Mint at Civic Center Plaza and Indian Plaza



| PACKAGED ENCLOSURES | PUMPS | APPS | BLOG | CONTACT



Logarithmic Graph of Water Supply

Summary: This app provides a $N^{1.85}$ logarithmic graph based on NFPA 291 recommendations. We also offer a blank PDF logarithmic flow test sheet.


Graph Points

- 104 Static Pressure
- 80 Residual Pressure
- 2506 Residual Flow

Data Points

Flow	Pressure
2927.170	72

Flow Test

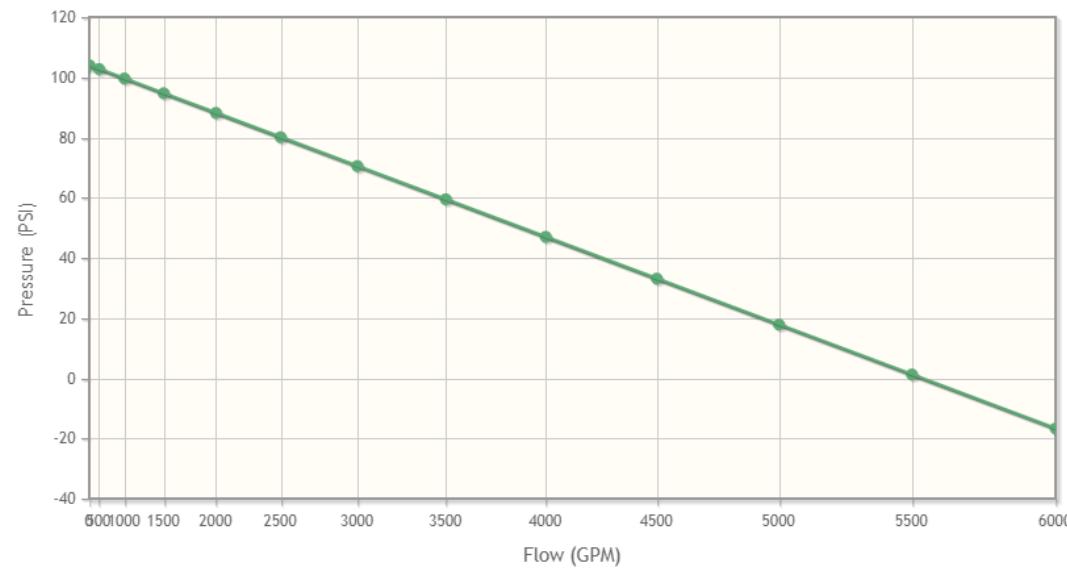


WATER RESOURCES: SEG PROVIDED THIS REVISED SHEET ON 9/10/2020. ANY PREVIOUS COMMENT NOT ADDRESSED ARE STILL APPLICABLE. WATER RESOURCES HAS ADDED ADDITIONAL COMMENTS.


OVERALL UTILITY EXHIBIT & KEY MAP

**PRELIMINARY
NOT FOR
CONSTRUCTION**

SHEET 1

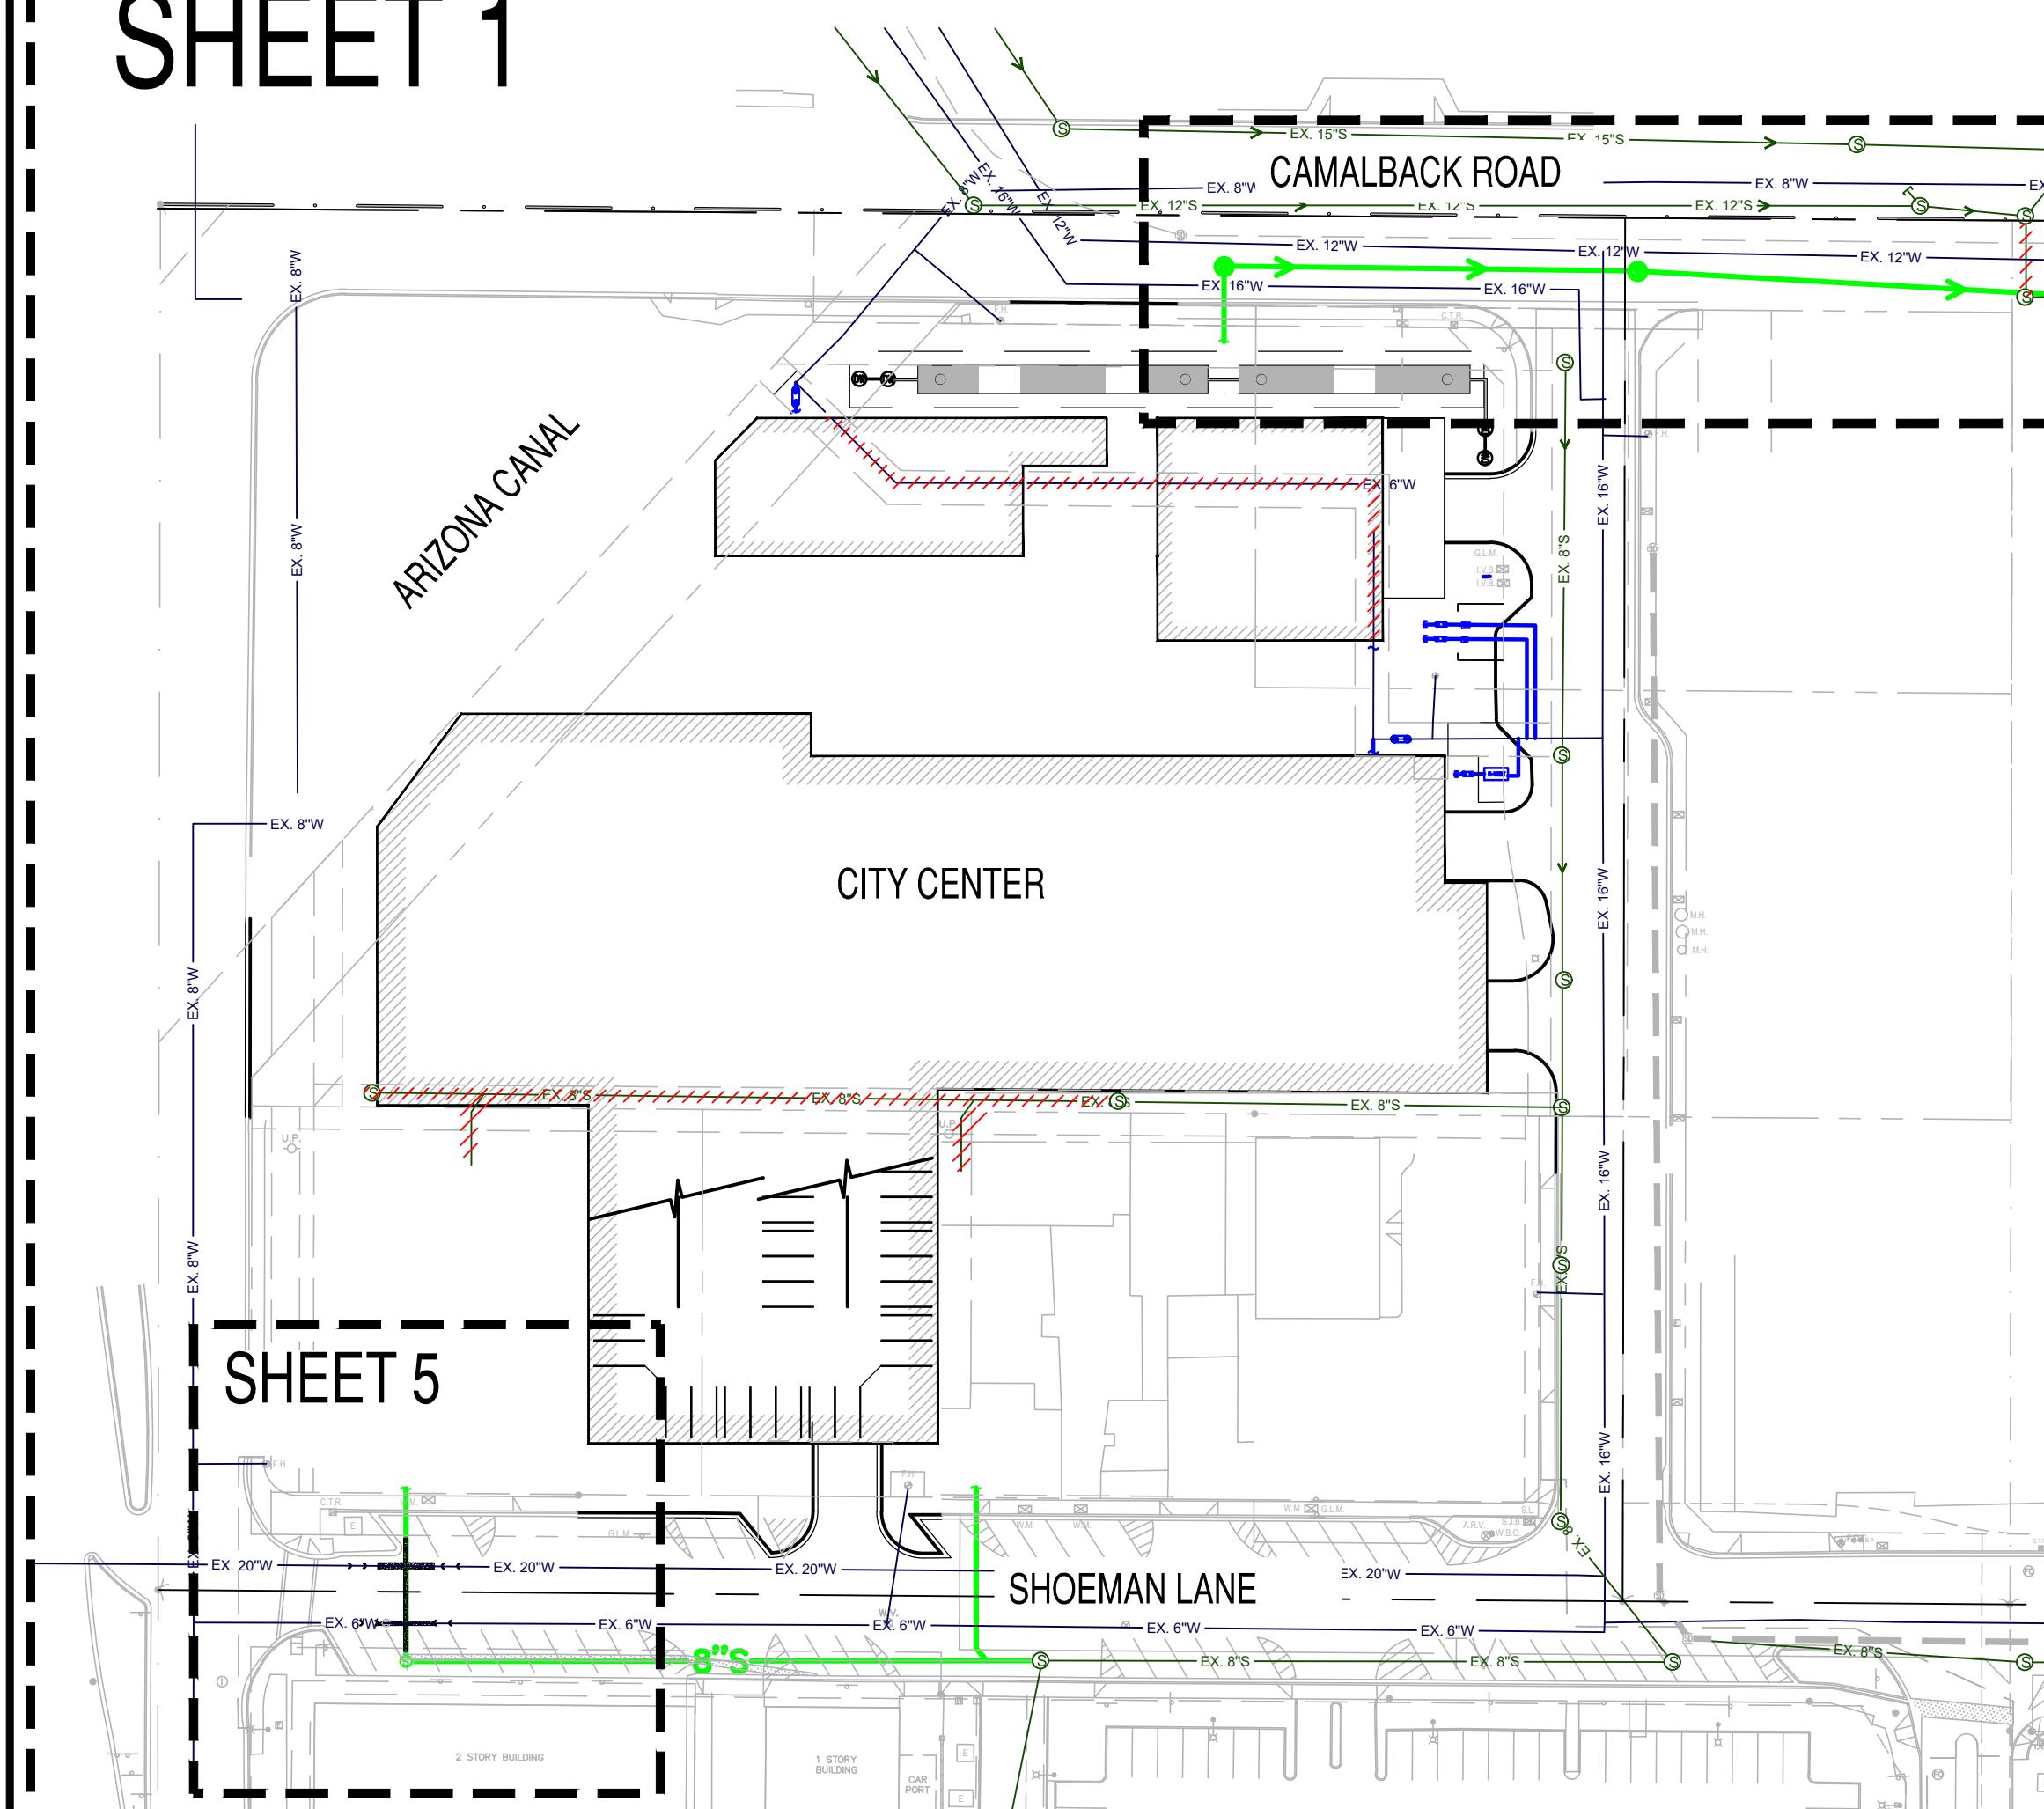


SHEET 2

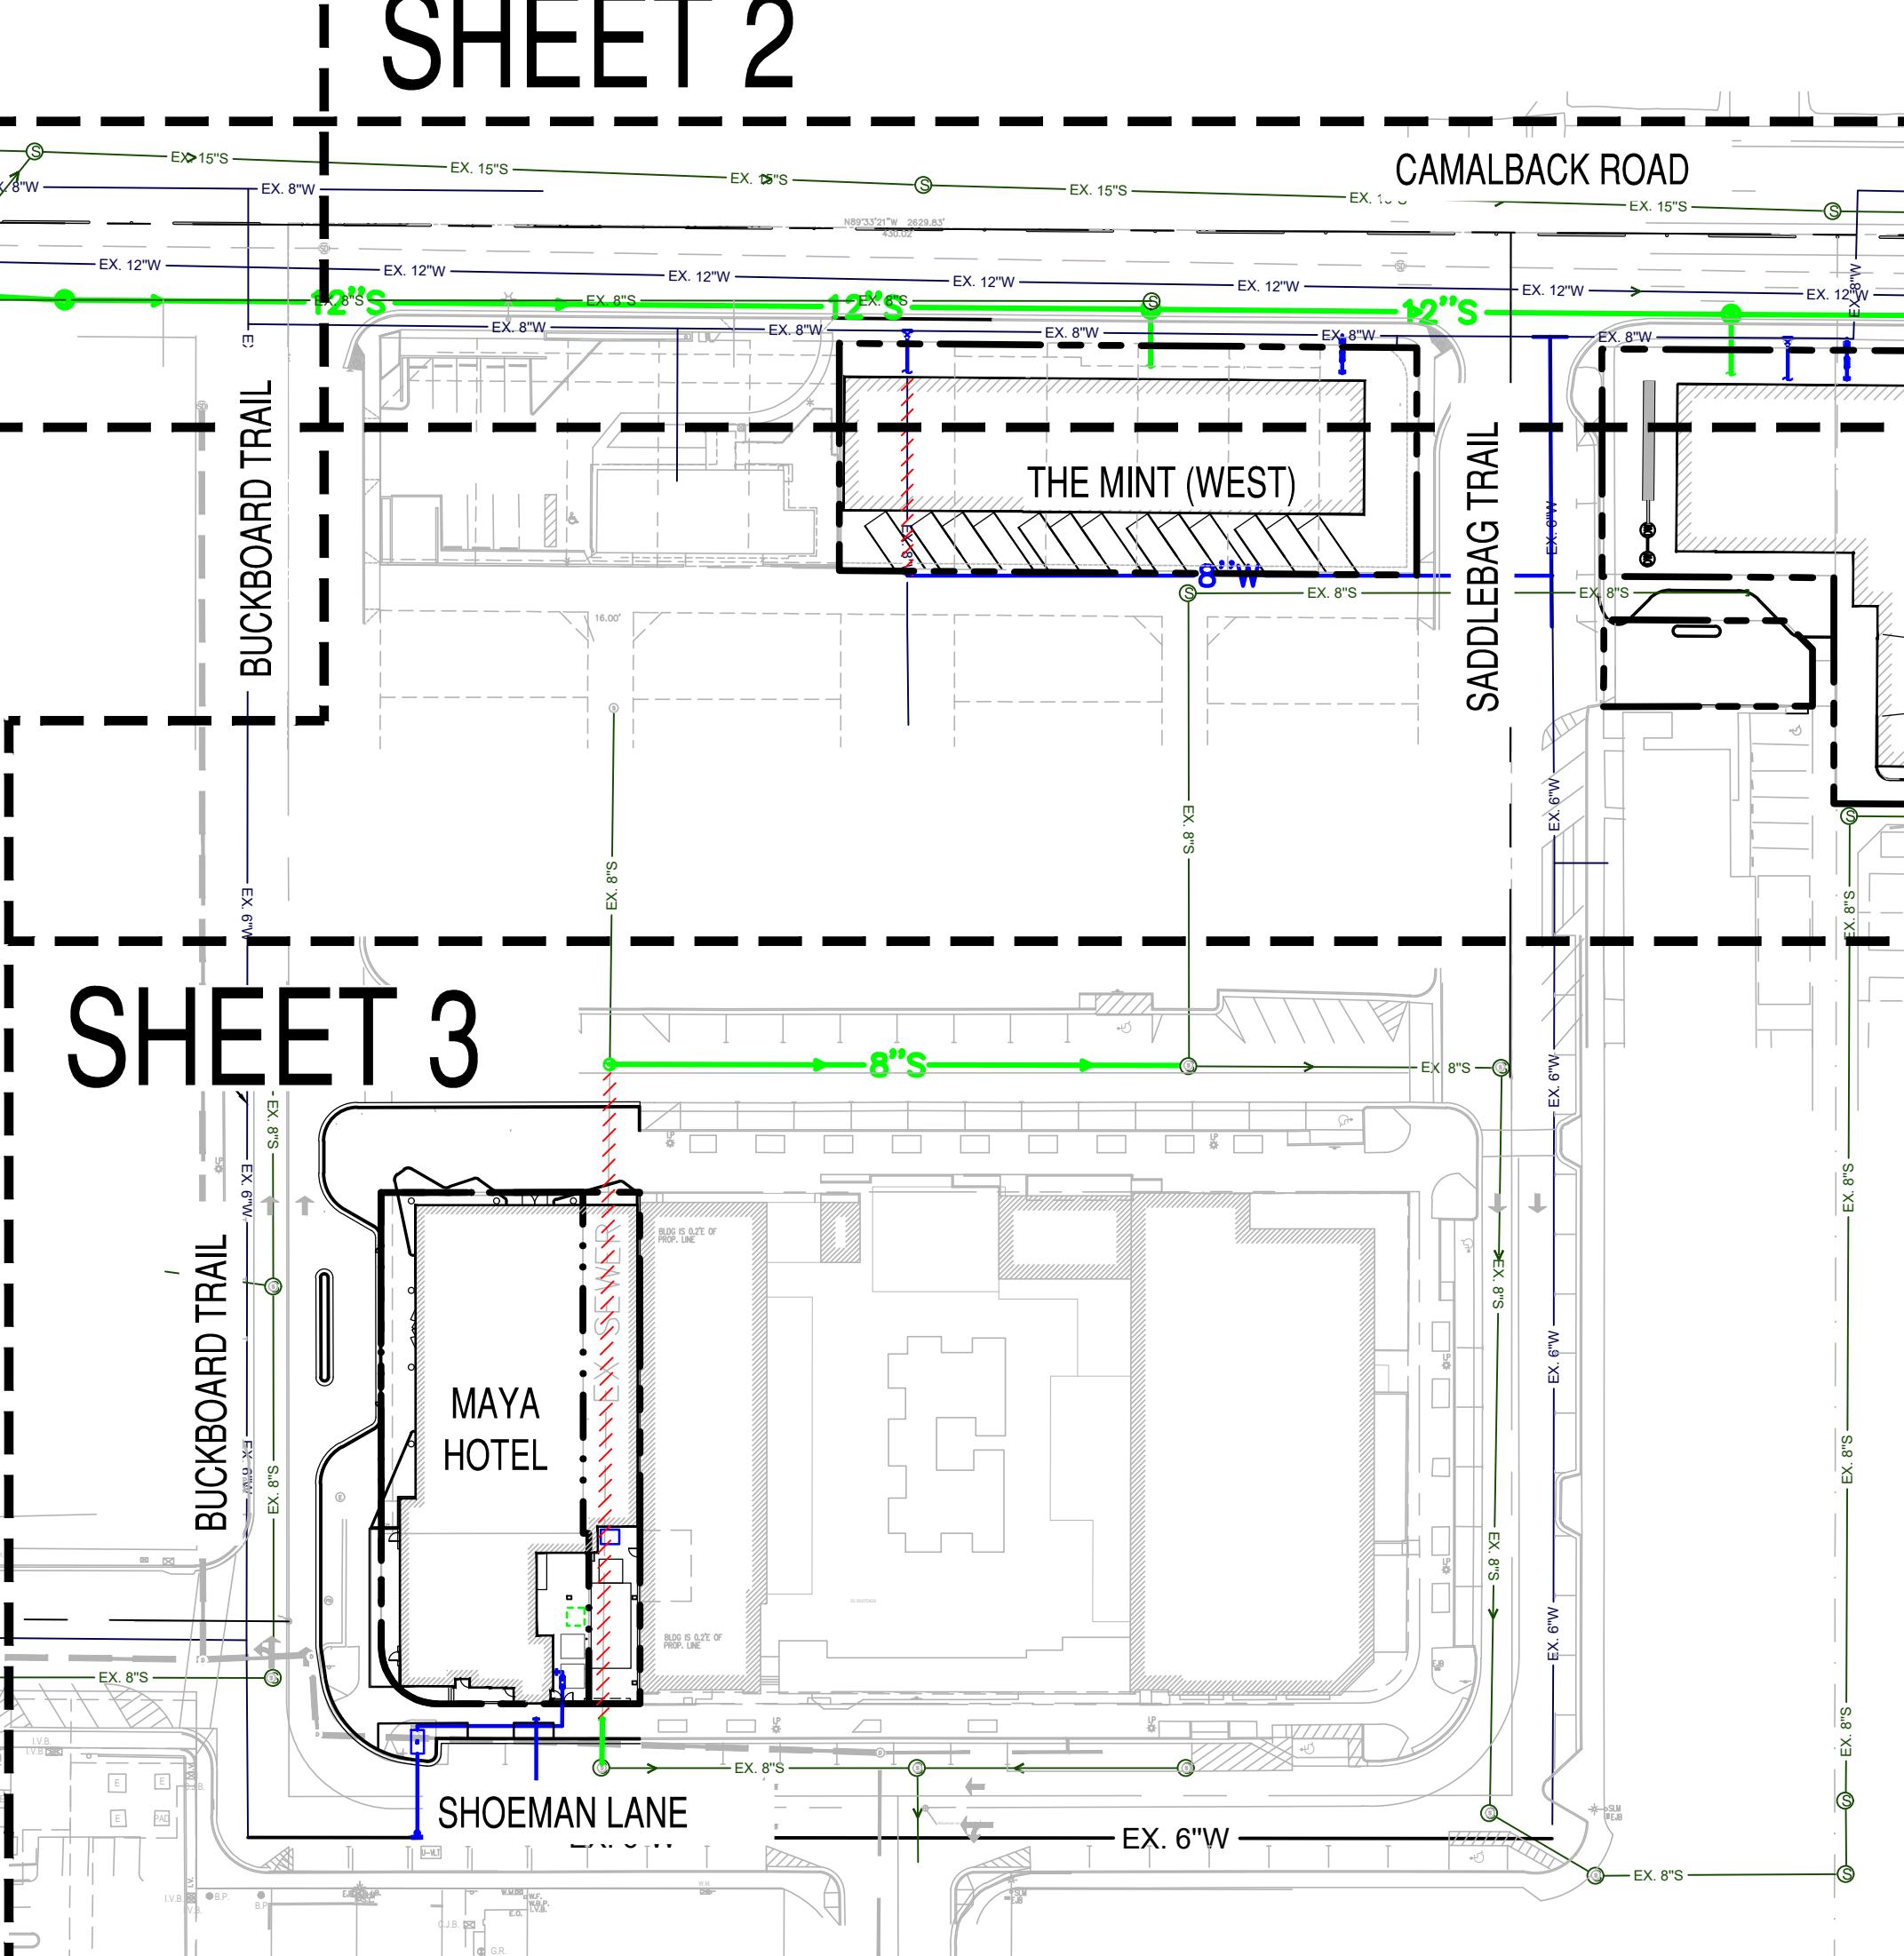

SHEET 4

SEWER PLAN & PROFILE

SEWER PLAN & PROFILE

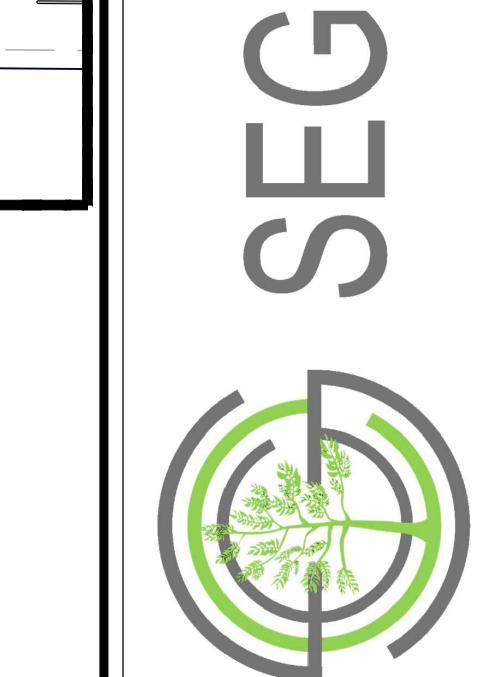

THESE DOCUMENTS ARE FOR YOUR USE ONLY AND ARE NOT TO BE PUBLISHED OR REPRODUCED EXCEPT AS PROVIDED IN THE AGREEMENT.

THIS DRAWING IS AN INSTRUMENT OF SERVICE AND THE PROPERTY OF SUSTAINABILITY ENGINEERING GROUP, AND SHALL REMAIN THEIR PROPERTY. THE USE OF THIS DRAWING SHALL BE RESTRICTED TO THE ORIGINAL SITE FOR WHICH IT IS PREPARED AND PUBLICATION THEREOF IS EXPRESSLY LIMITED TO SUCH USE.

NOTE:


1. MANHOLES 1 AND 2 RIMS HAS BEEN SET BASED ON THE SURVEY RECEIVED FROM MLC SERVICES,LLC.
 2. MANHOLES 3 THROUGH 7 RIMS HAS BEEN SET BASED ON QUARTER SECTION MAP.
 3. EXISTING MANHOLE AT THE CONNECTION POINT INVERTS AND RIM WAS SET BASED ON QUARTER SECTION MAP

EXISTING | FGFND


—	EX. S	SEWER LINE
—	EX. W	WATER LINE
—	IRR	IRRIGATION LINE
■ ■ ■ ■		STORM DRAIN LINE
CB		CATCH BASIN
(S)		SEWER MANHOLE
(D)		STORM MANHOLE
⊗	WV	WATER VALVE
►►	WMB	WATER METER BOX
□	FCB	ELECTRIC CABINET

PROPOSED LEGEND

	PROPERTY LINE
	WATER LINE
	SEWER LINE
	WATER METER
	GATE VALVE
	T.S.V.B.&C.
	BACK FLOW PREVENTER
	CAP
	SEWER MANHOLE
	WATER/SEWER LINE ABANDONM

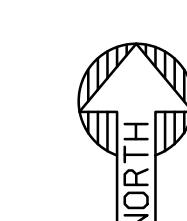

OVERALL UTILITY EXHIBIT & KEY MAP

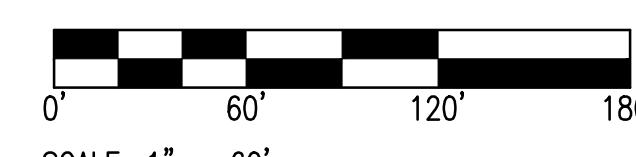


SCALE 1" = 60'

PROJECT	SCOTTSDALE COLLECTIVE		
DRAWN	_____	KA	04
DESIGNED	_____	KA	04
QC	_____	SC	
QA	_____	AF	
PROJ. MGR.	_____	AF	
DATE:			
08/07/2020			
ISSUED FOR:			
ZONING			
REVISION NO.:			D
 1			
 2			
 3			
 4			
JOB NO.:		200226	
SHEET TITLE:			
UTILITY EXHIBIT KEY MAP			
SHEET NO.:			

8280 E. GELDING DRIVE SUITE 101, SCOTTSDALE, ARIZONA 85260
ATE
4/28
4/28

WATER RESOURCES: SEG PROVIDED THIS REVISED SHEET ON 9/10/2020. ANY PREVIOUS COMMENT NOT ADDRESSED ARE STILL APPLICABLE. WATER RESOURCES HAS ADDED ADDITIONAL COMMENTS.

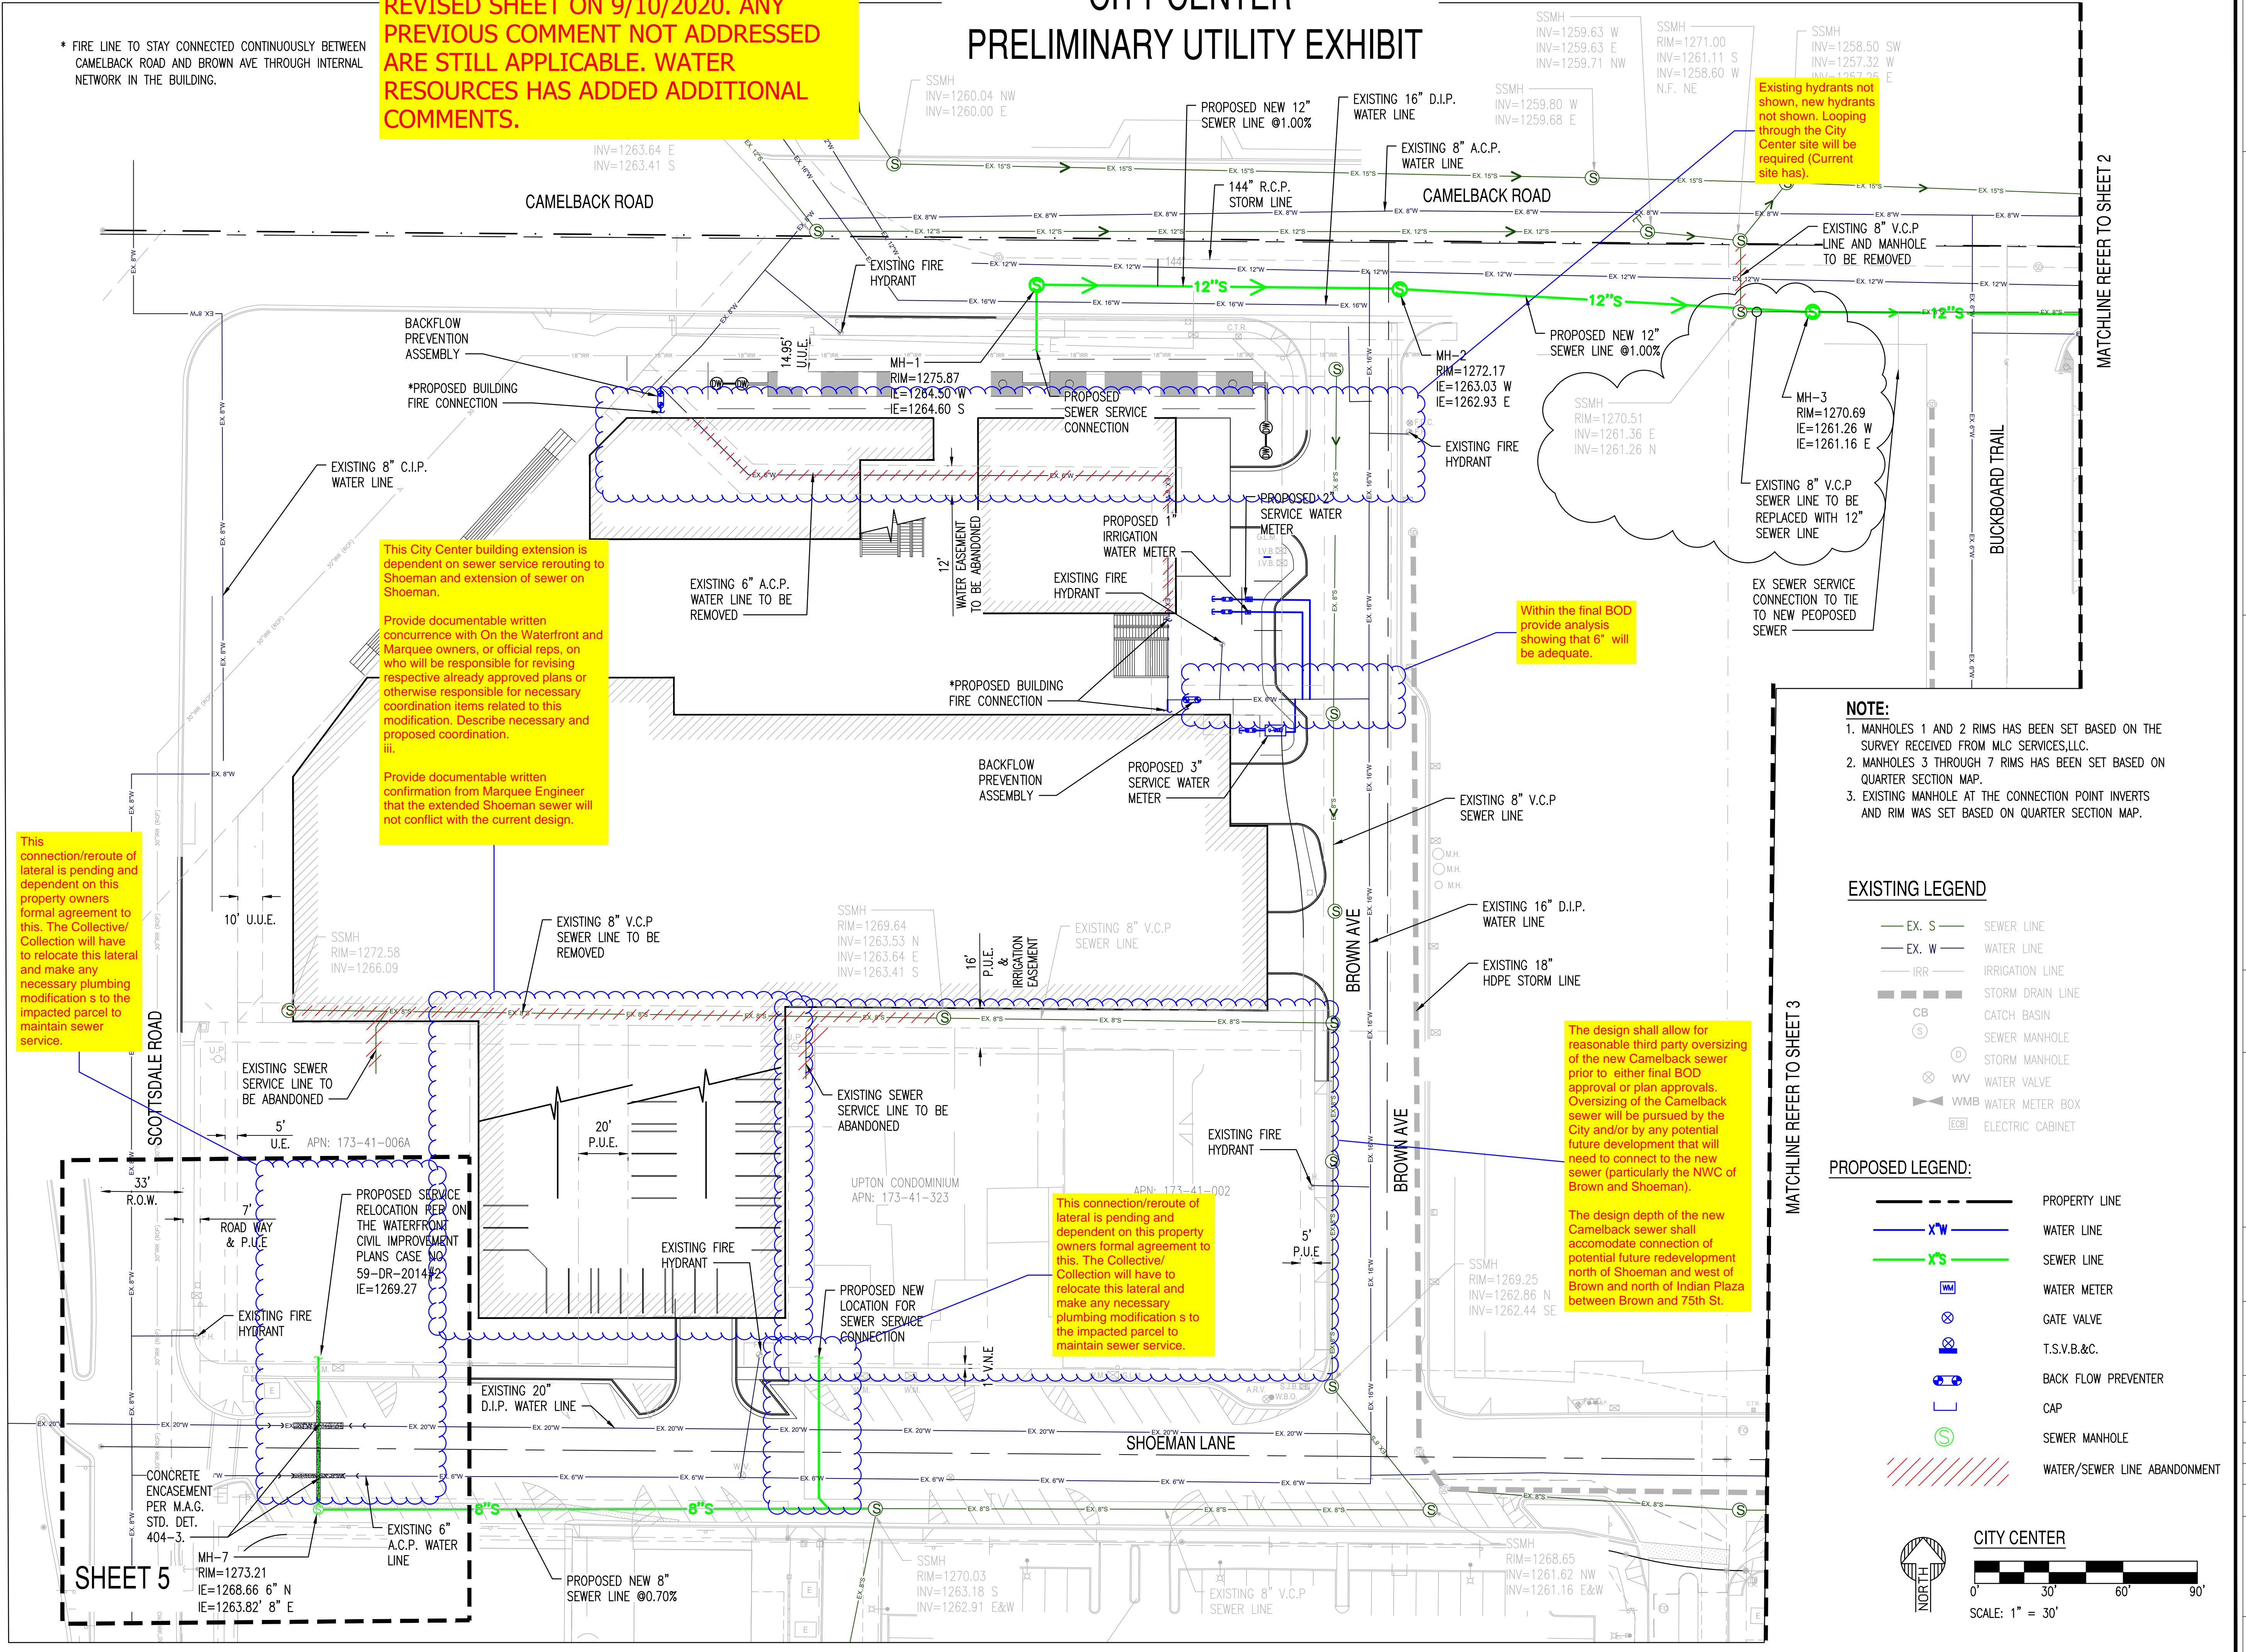

PRELIMINARY
NOT FOR
CONSTRUCTION

SUSTAINABILITY
ENGINEERING
GROUP



820 E. GELDING DRIVE SUITE 101 SCOTTSDALE ARIZONA 85260

WWW.AZSEG.COM TEL: 480.388.7226 FAX: 480.389.3534

THIS DRAWING IS AN INSTRUMENT OF SERVICE AND THE PROPERTY OF SUSTAINABILITY ENGINEERING GROUP, AND SHALL REMAIN THEIR PROPERTY. THE USE OF THIS DRAWING SHALL BE RESTRICTED TO THE ORIGINAL SITE FOR WHICH IT IS PREPARED AND PUBLICATION THEREOF IS EXPRESSLY LIMITED TO SUCH USE.

CITY CENTER PRELIMINARY UTILITY EXHIBIT

SSMH
INV=1259.63 W
INV=1259.63 E
INV=1259.71 NW

SSMH
RIM=1271.00
INV=1261.11 S
INV=1257.25 E

SSMH
INV=1258.50 SW
INV=1257.32 W
INV=1257.25 E

Existing hydrants not shown, new hydrants not shown. Looping through the City Center site will be required (Current site has).

MATCHLINE REFER TO SHEET 2

- NOTE:**
1. MANHOLES 1 AND 2 RIMS HAS BEEN SET BASED ON THE SURVEY RECEIVED FROM MLC SERVICES,LLC.
 2. MANHOLES 3 THROUGH 7 RIMS HAS BEEN SET BASED ON QUARTER SECTION MAP.
 3. EXISTING MANHOLE AT THE CONNECTION POINT INVERTS AND RIM WAS SET BASED ON QUARTER SECTION MAP.

EXISTING LEGEND

EX. S	SEWER LINE
EX. W	WATER LINE
IRR	IRRIGATION LINE
CB	STORM DRAIN LINE
(S)	CATCH BASIN
D	SEWER MANHOLE
WV	STORM MANHOLE
WMB	WATER VALVE
ECB	WATER METER BOX
ECB	ELECTRIC CABINET

PROPOSED LEGEND:

PROPERTY LINE	---
WATER LINE	X" W
SEWER LINE	X" S
WATER METER	WM
GATE VALVE	GV
T.S.V.B.&C.	T.S.V.B.&C.
BACK FLOW PREVENTER	BP
CAP	CAP
SEWER MANHOLE	(S)
WATER/SEWER LINE ABANDONMENT	---

CITY CENTER

0' 30' 60' 90'
SCALE: 1" = 30'



PROJECT	CITY CENTER	LOCATION
DRAWN	KA	04/28/2020
DESIGNED	KA	04/28/2020
QC	SC	
QA	AF	
PROJ. MGR.	AF	
DATE:		08/07/2020
ISSUED FOR:		PRELIMINARY REVIEW
REVISION NO.:		
JOB NO.:		200226
SHEET TITLE:		UTILITY EXHIBIT
SHEET NO.:		

WATER RESOURCES: SEG PROVIDED THIS REVISED SHEET ON 9/10/2020. ANY PREVIOUS COMMENT NOT ADDRESSED ARE STILL APPLICABLE. WATER RESOURCES HAS ADDED ADDITIONAL COMMENTS.



THE MINT PRELIMINARY UTILITY EXHIBIT

PRELIMINARY
NOT FOR
CONSTRUCTION

SUSTAINABILITY
ENGINEERING
GROUP

820 E. GELDING DRIVE SUITE 101 SCOTTSDALE ARIZONA 85260
WWW.AZSEG.COM TEL: 480.389.7226 FAX: 480.389.3534

THIS DRAWING IS AN INSTRUMENT OF SERVICE AND THE PROPERTY OF SUSTAINABILITY ENGINEERING GROUP, AND SHALL REMAIN THEIR PROPERTY. THE USE OF THIS DRAWING SHALL BE RESTRICTED TO THE ORIGINAL SITE FOR WHICH IT IS PREPARED AND PUBLICATION THEREOF IS EXPRESSLY LIMITED TO SUCH USE.

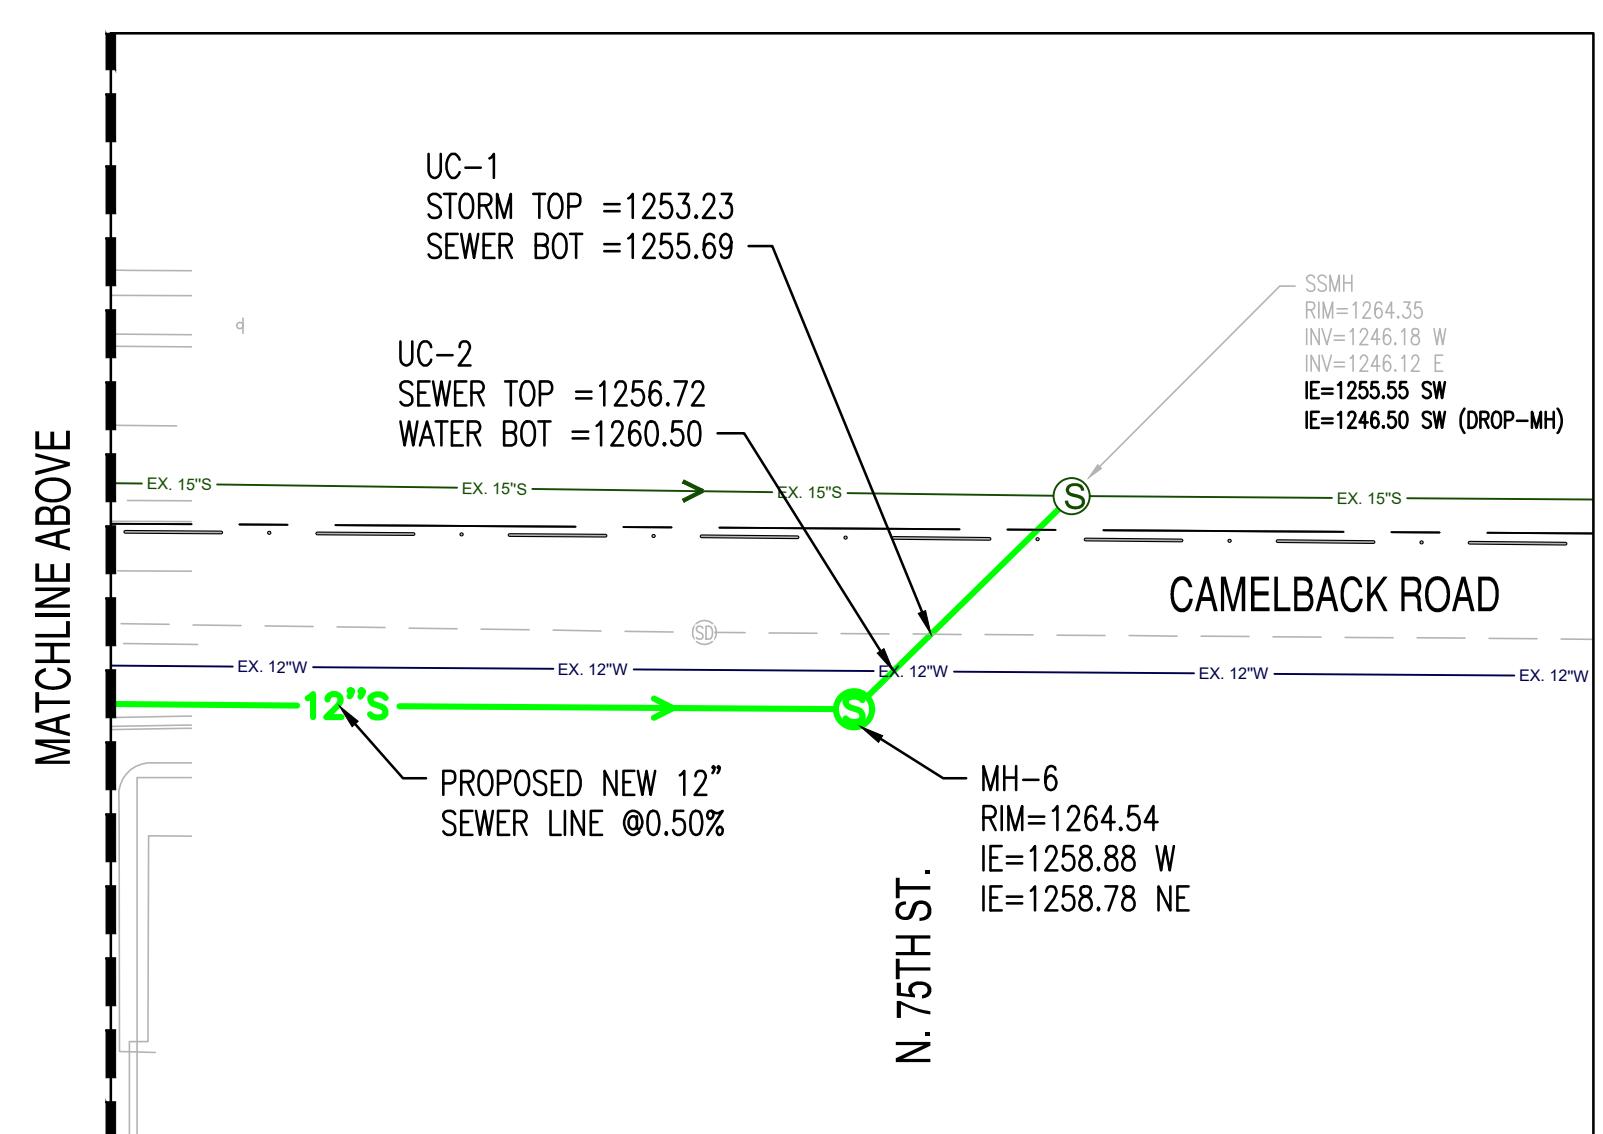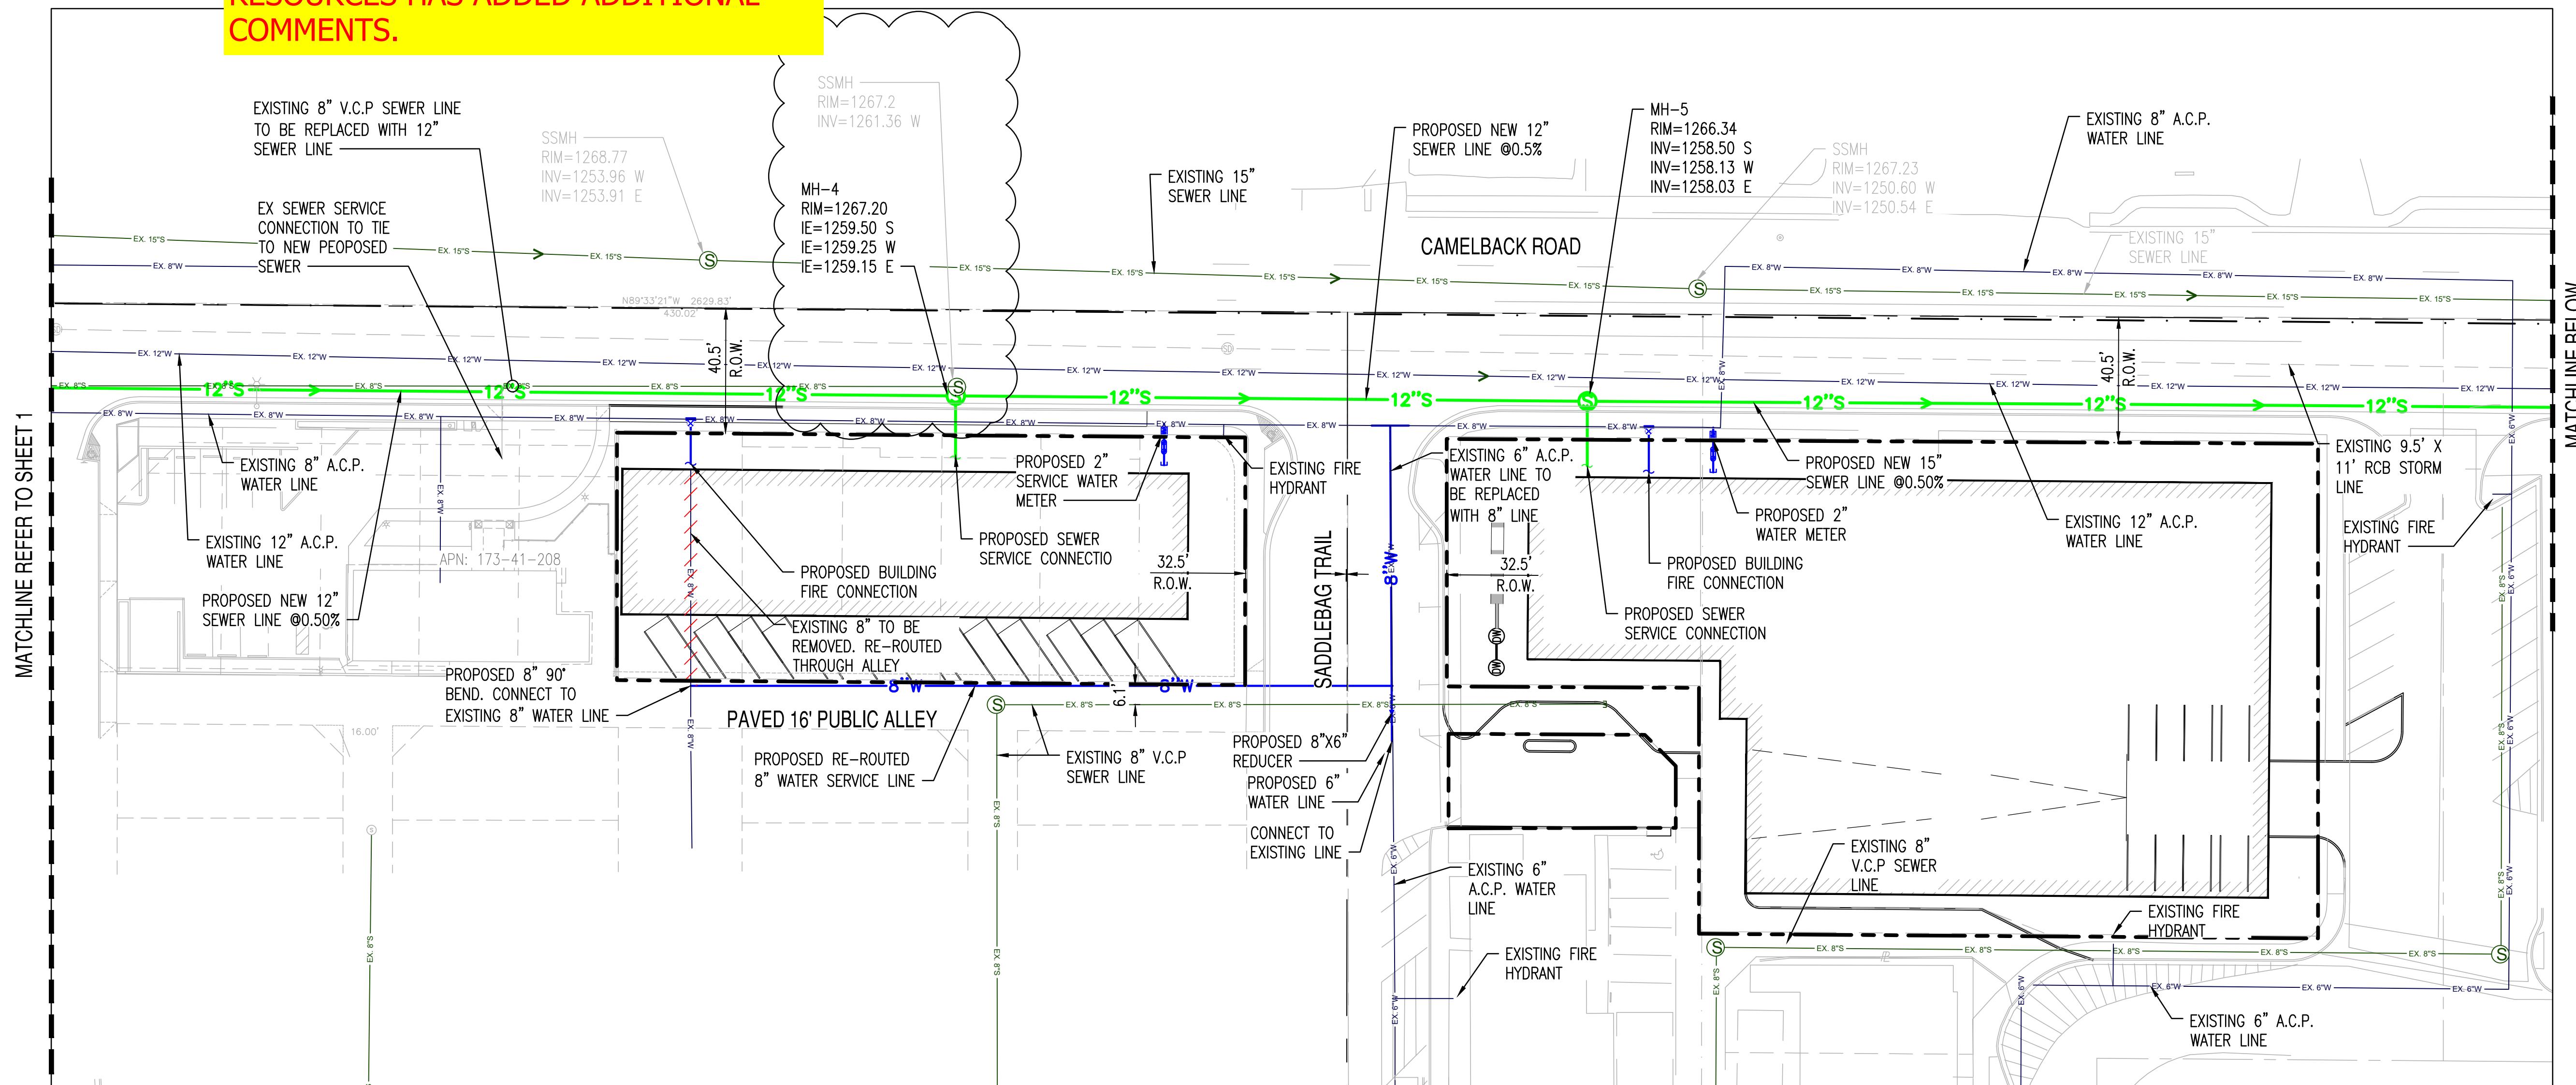

NOTE:


- MANHOLES 1 AND 2 RIMS HAS BEEN SET BASED ON THE SURVEY RECEIVED FROM MLC SERVICES,LLC.
- MANHOLES 3 THROUGH 7 RIMS HAS BEEN SET BASED ON QUARTER SECTION MAP.
- EXISTING MANHOLE AT THE CONNECTION POINT INVERTS AND RIM WAS SET BASED ON QUARTER SECTION MAP.

EXISTING LEGEND

EX. S	SEWER LINE
EX. W	WATER LINE
IRR	IRRIGATION LINE
CB	STORM DRAIN LINE
(CB) S	CATCH BASIN
(CB) D	SEWER MANHOLE
(CB) WV	STORM MANHOLE
(CB) WMB	WATER VALVE
(CB) ECB	WATER METER BOX
(CB) EC	ELECTRIC CABINET

PROPOSED LEGEND:

XW	PROPERTY LINE
XS	WATER LINE
WM	SEWER LINE
⊗	WATER METER
⊗	GATE VALVE
⊗	T.S.V.B.&C.
⊗	BACK FLOW PREVENTER
⊗	CAP
⊗	SEWER MANHOLE
⊗	WATER/SEWER LINE ABANDONMENT

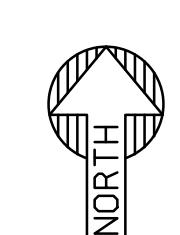

THE MINT
NORTH
SCALE: 1" = 30'

Call at least two full working days before you have an emergency.
ARIZONA 80
Arizona Blue Streak, Inc.
8-1-1 or 1-800-STAKE IT (825-3348)
In Maricopa County: (602) 255-1100

PROJECT:
THE MINT
LOCATION:
CAMELBACK RD & SADDLEBAG TRAIL

DRAWN: KA 04/28/2020
DESIGNED: SC 04/28/2020
QC: AF
QA: AF
PROJ. MGR: AF

DATE: 08/07/2020
ISSUED FOR: PRELIMINARY REVIEW

REVISION NO.: DATE:

JOB NO.: 200226
SHEET TITLE: UTILITY EXHIBIT

SHEET NO.: 2

WATER RESOURCES: SEG PROVIDED THIS REVISED SHEET ON 9/10/2020. ANY PREVIOUS COMMENT NOT ADDRESSED ARE STILL APPLICABLE. WATER RESOURCES HAS ADDED ADDITIONAL COMMENTS.

MAYA HOTEL PRELIMINARY UTILITY EXHIBIT


PRELIMINARY
NOT FOR
CONSTRUCTION

SUSTAINABILITY
ENGINEERING
GROUP



820 E. GELDING DRIVE SUITE 101 SCOTTSDALE ARIZONA 85260
WWW.AZSEG.COM TEL: 480.388.7226 FAX: 480.389.3534

THIS DRAWING IS AN INSTRUMENT OF SERVICE AND THE PROPERTY OF SUSTAINABILITY ENGINEERING GROUP, AND SHALL REMAIN THEIR PROPERTY. THE USE OF THIS DRAWING SHALL BE RESTRICTED TO THE ORIGINAL SITE FOR WHICH IT IS PREPARED AND PUBLICATION THEREOF IS EXPRESSLY LIMITED TO SUCH USE.

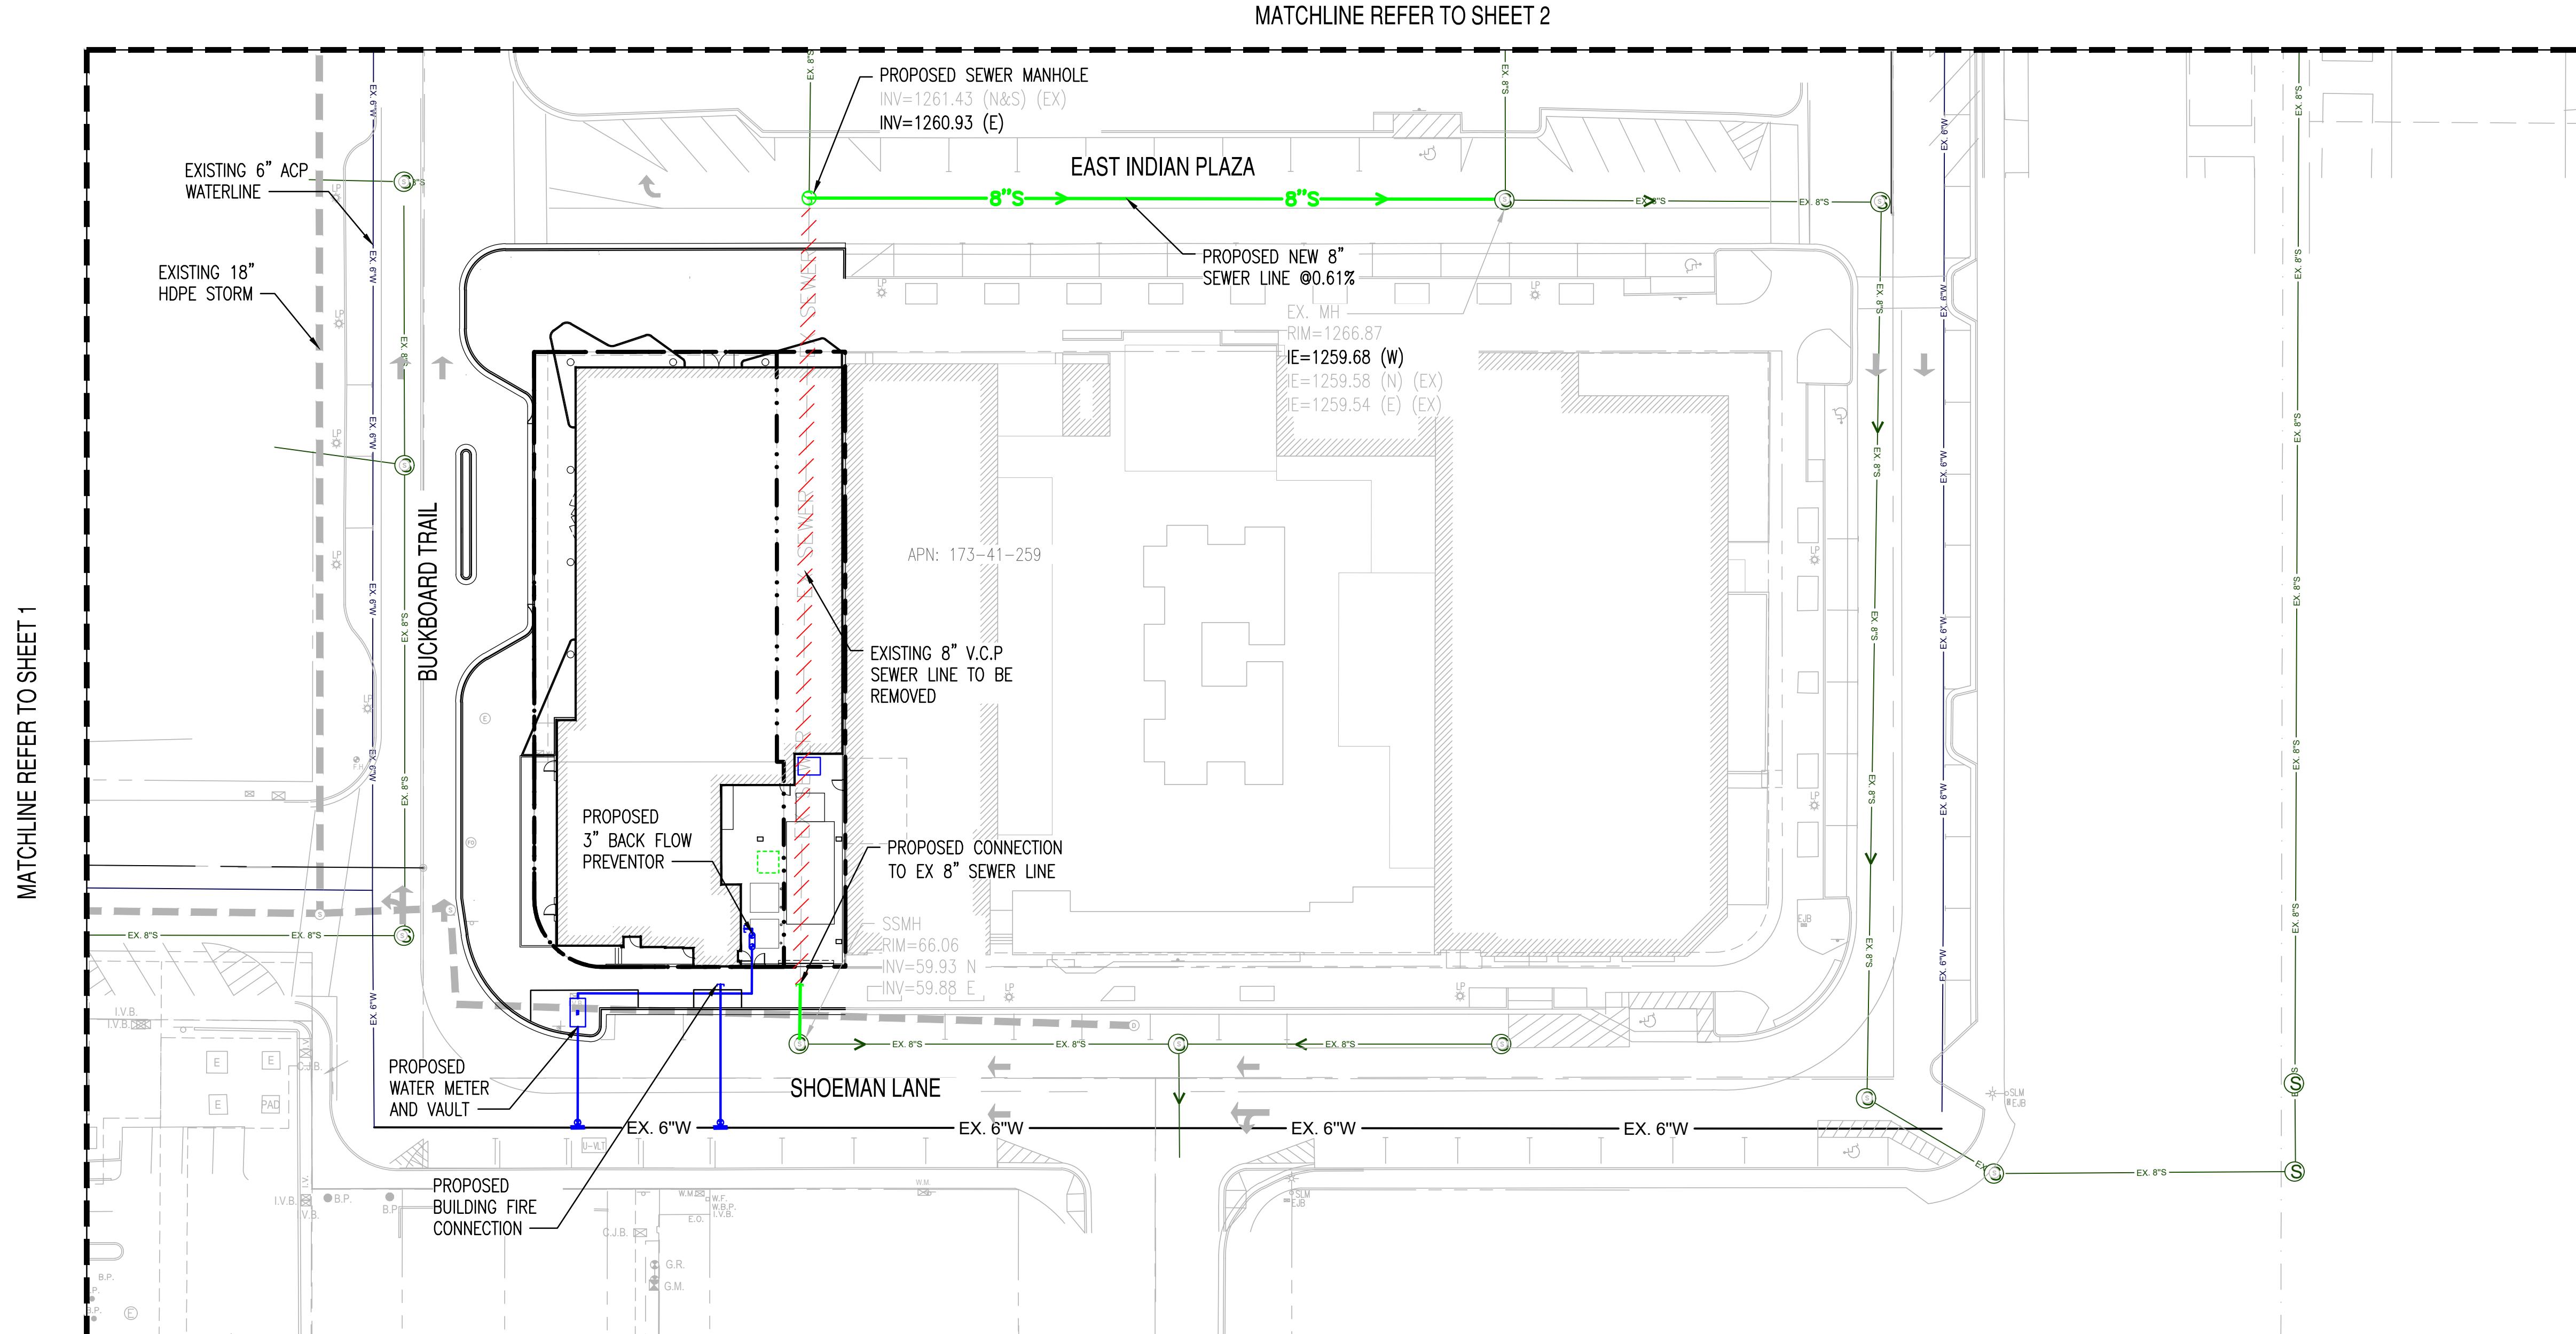

EXISTING LEGEND

- EX. S — SEWER LINE
- EX. W — WATER LINE
- IRR — IRRIGATION LINE
- CB — CATCH BASIN
- D — SEWER MANHOLE
- WV — STORM MANHOLE
- WMB — WATER VALVE
- WMB — WATER METER BOX
- ECB — ELECTRIC CABINET


PROPOSED LEGEND:

- PROPERTY LINE —
- XW — WATER LINE
- XS — SEWER LINE
- WM — WATER METER
- GV — GATE VALVE
- TSVB&C. — T.S.V.B.&C.
- BFP — BACK FLOW PREVENTER
- CAP — CAP
- SM — SEWER MANHOLE
- / / — WATER/SEWER LINE ABANDONMENT

NOTE:

1. MANHOLES 1 AND 2 RIMS HAS BEEN SET BASED ON THE SURVEY RECEIVED FROM MLC SERVICES,LLC.
2. MANHOLES 3 THROUGH 7 RIMS HAS BEEN SET BASED ON QUARTER SECTION MAP.
3. EXISTING MANHOLE AT THE CONNECTION POINT INVERTS AND RIM WAS SET BASED ON QUARTER SECTION MAP.

MAYA HOTEL

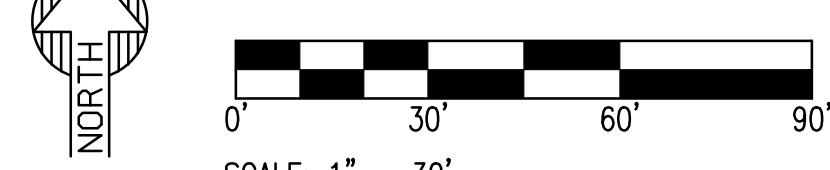

Call at least two full working days before you begin excavation.
ARIZONA 811
Arizona Blue Books, Inc.
8-1-1 1-800-STAKE IT (782-3348)
In Maricopa County: (602) 255-1100

PROJECT
MAYA HOTEL

LOCATION
NW. EAST INDIAN PLAZA
& BUCKBOARD TRAIL

DRAWN — KA 04/28/2020
DESIGNED — SC 04/28/2020
QC — AF
QA — AF
PROJ. MGR. — AF

DATE: 08/07/2020
ISSUED FOR: PRELIMINARY REVIEW

REVISION NO.: DATE:

JOB NO.: 200226

SHEET TITLE: UTILITY EXHIBIT

SHEET NO.: 3




WATER RESOURCES: SEG PROVIDED THIS REVISED SHEET ON 9/10/2020. ANY PREVIOUS COMMENT NOT ADDRESSED ARE STILL APPLICABLE. WATER RESOURCES HAS ADDED ADDITIONAL COMMENTS.

PRELIMINARY
NOT FOR
CONSTRUCTION
**SUSTAINABILITY
ENGINEERING
GROUP**




820 E. GELDING DRIVE SUITE 101 SCOTTSDALE, ARIZONA 85260
WWW.AZSEG.COM TEL: 480.389.7226 FAX: 480.389.3534



THIS DRAWING IS AN INSTRUMENT OF SERVICE AND THE PROPERTY OF SUSTAINABILITY ENGINEERING GROUP, AND SHALL REMAIN THEIR PROPERTY. THE USE OF THIS DRAWING SHALL BE RESTRICTED TO THE ORIGINAL SITE FOR WHICH IT IS PREPARED AND PUBLICATION THEREOF IS EXPRESSLY LIMITED TO SUCH USE.

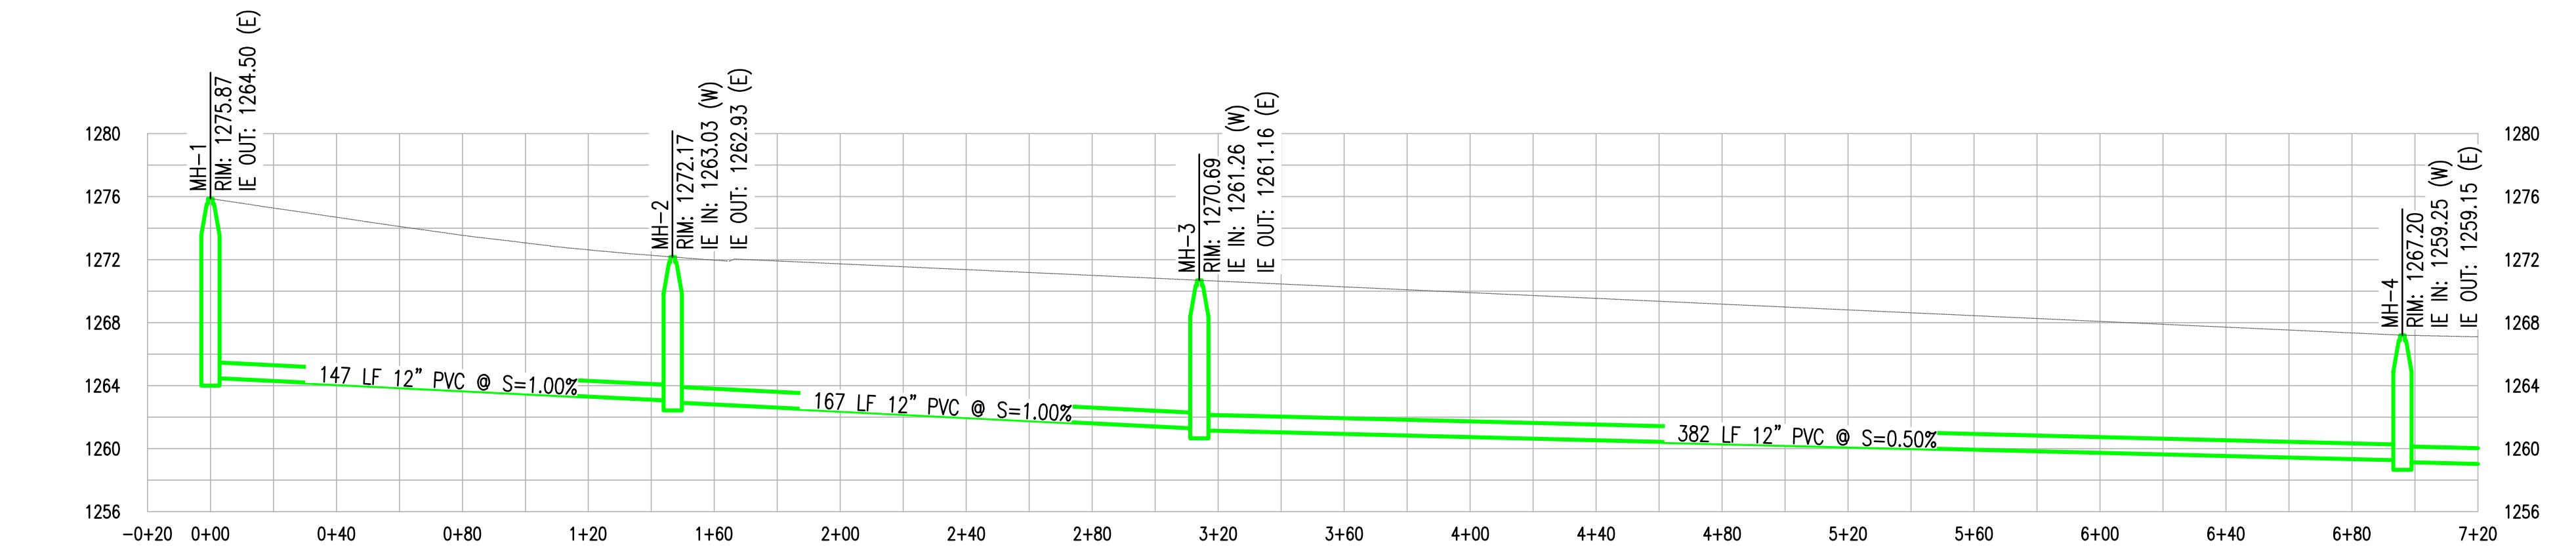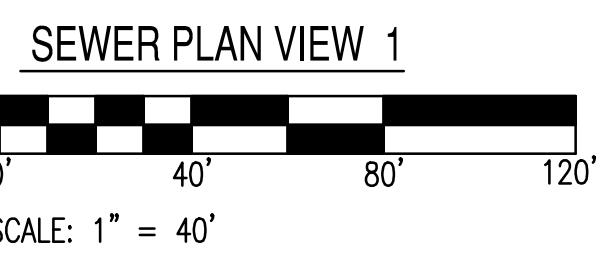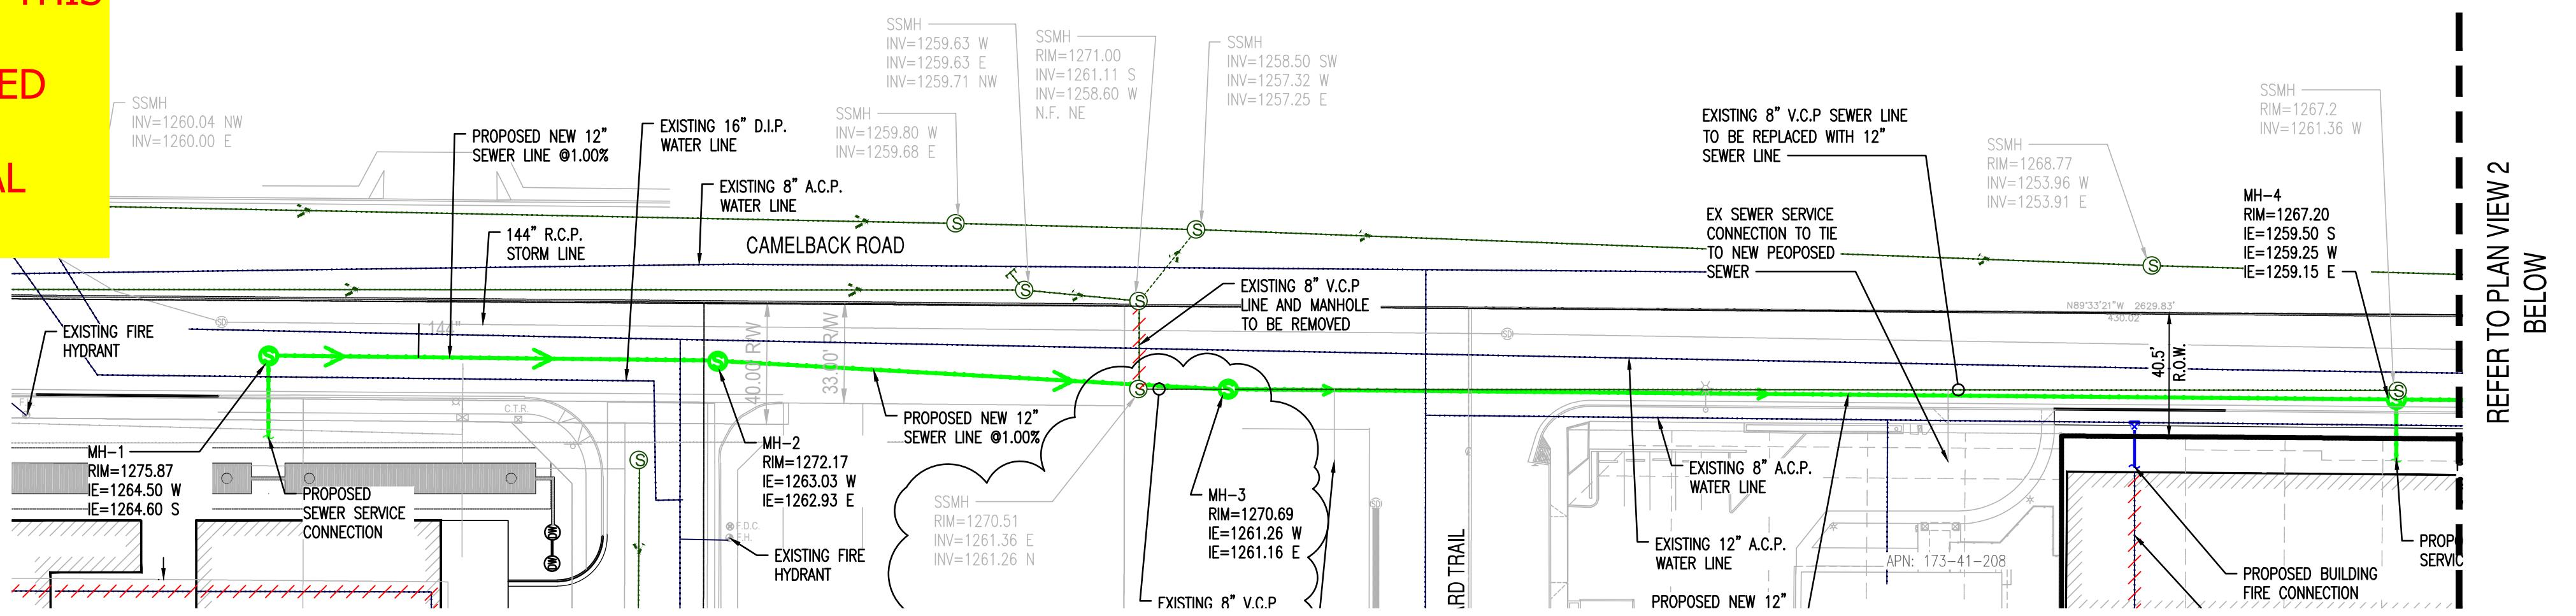

SEWER PROFILE VIEW 1
HORIZONTAL SCALE: 1" = 40'
VERTICAL SCALE: 1" = 4'

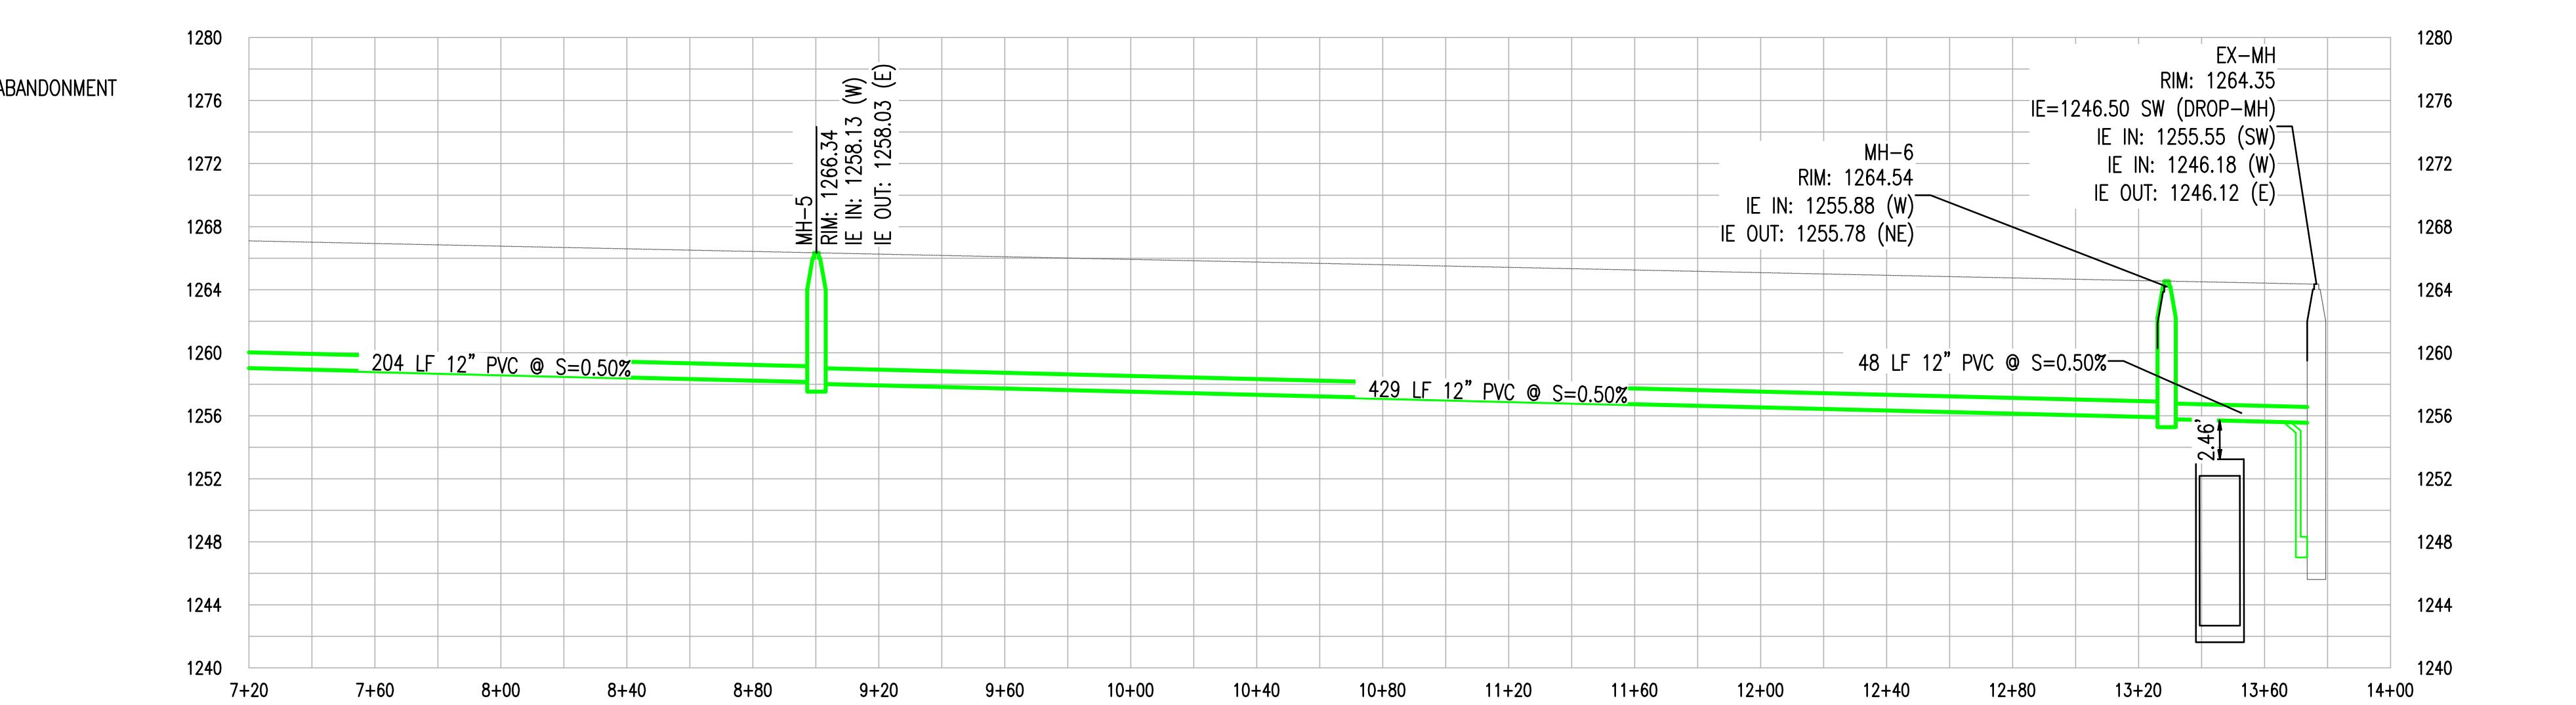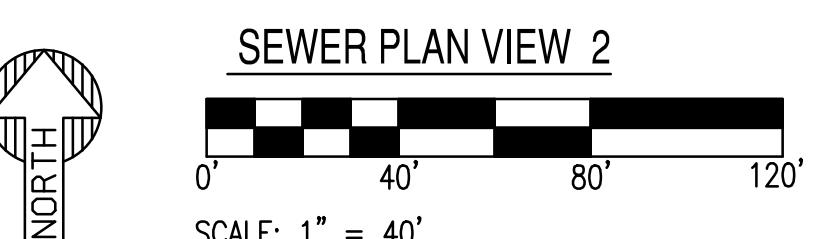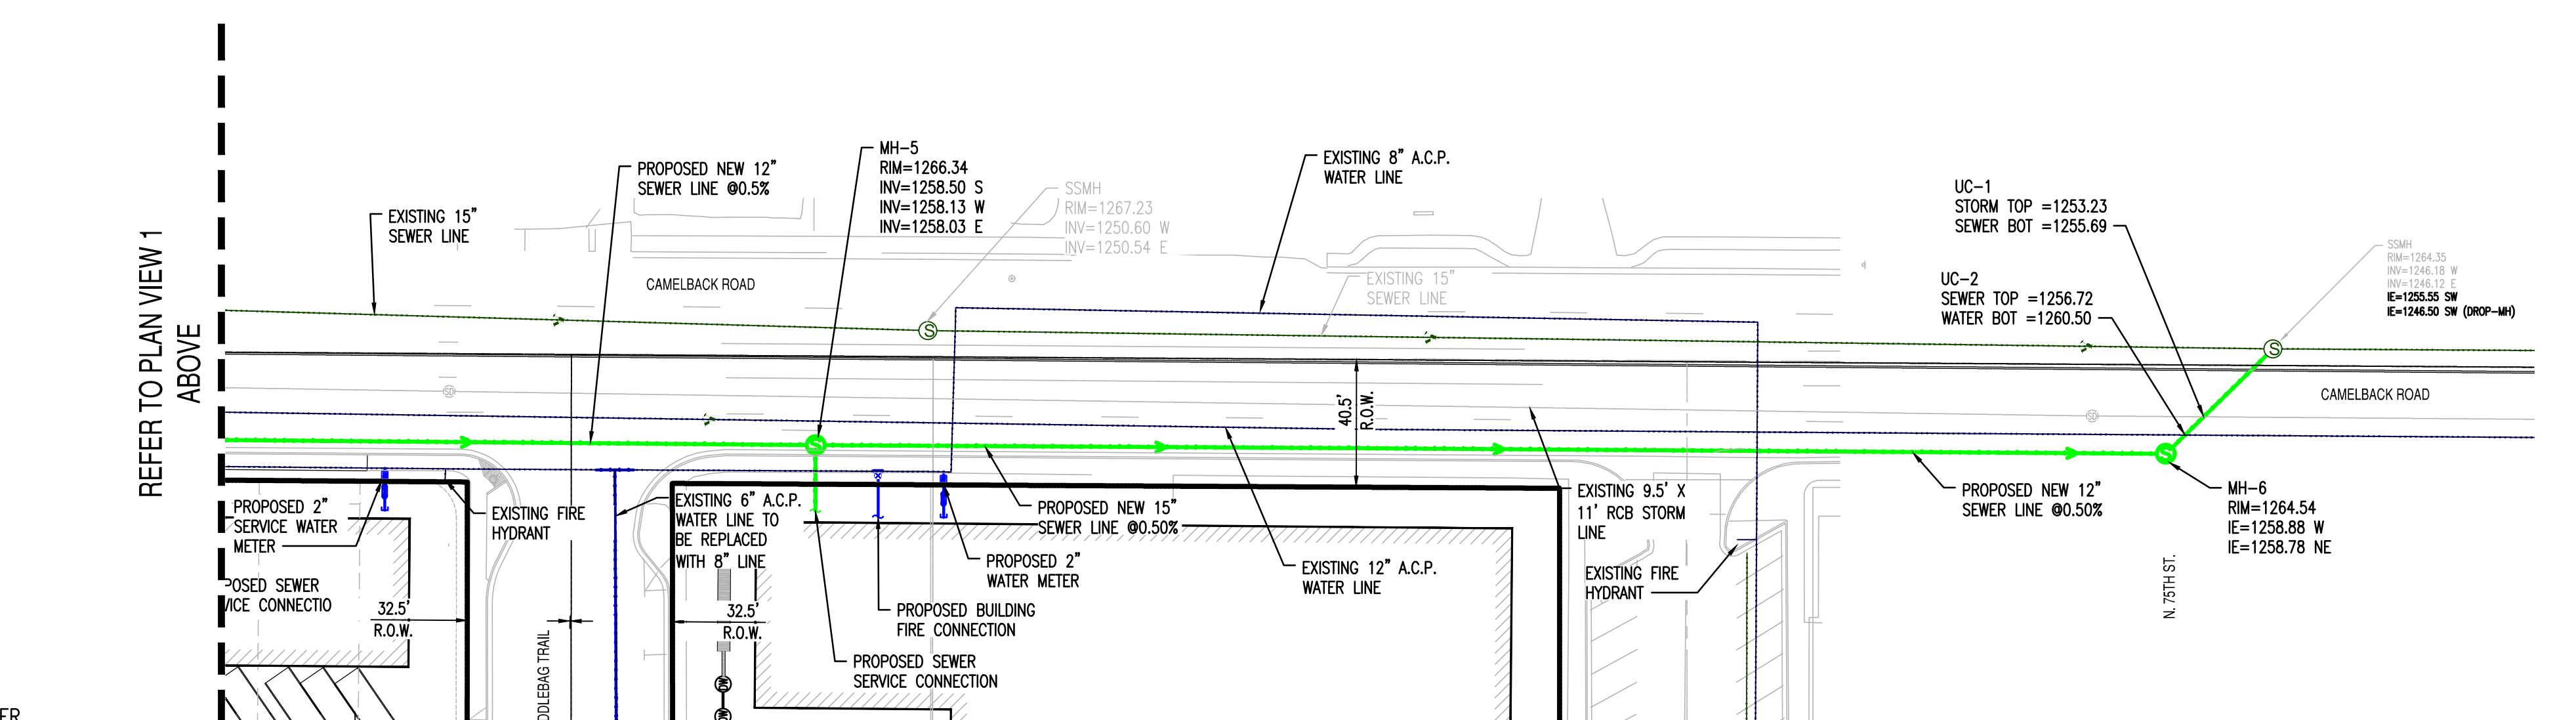



SEWER PROFILE VIEW 2
HORIZONTAL SCALE: 1" = 40'
VERTICAL SCALE: 1" = 4'



Call at least two full working days before you begin excavation.
Arizona 811
8-1-1 or 1-800-STAKE IT (824-3848)
In Maricopa County: (602) 255-1100

PROJECT NAME	LOCATION
MAYA HOTEL	NWC EAST INDIAN PLAZA & BUCKBOARD TRAIL
DRAWN _____ KA 04/28/2020	DESIGNED _____ KA 04/28/2020
QC _____ SC	QA _____ AF
PROJ. MGR. _____ AF	
DATE: 08/07/2020	
ISSUED FOR: PRELIMINARY REVIEW	
REVISION NO.: <input type="checkbox"/> <input type="checkbox"/> <input type="checkbox"/>	DATE:
JOB NO.: 200226	SHEET TITLE: PROPOSED SEWER PLAN & PROFILE
SHEET NO.: 4	

WATER RESOURCES: SEG PROVIDED THIS REVISED SHEET ON 9/10/2020. ANY PREVIOUS COMMENT NOT ADDRESSED ARE STILL APPLICABLE. WATER RESOURCES HAS ADDED ADDITIONAL COMMENTS.

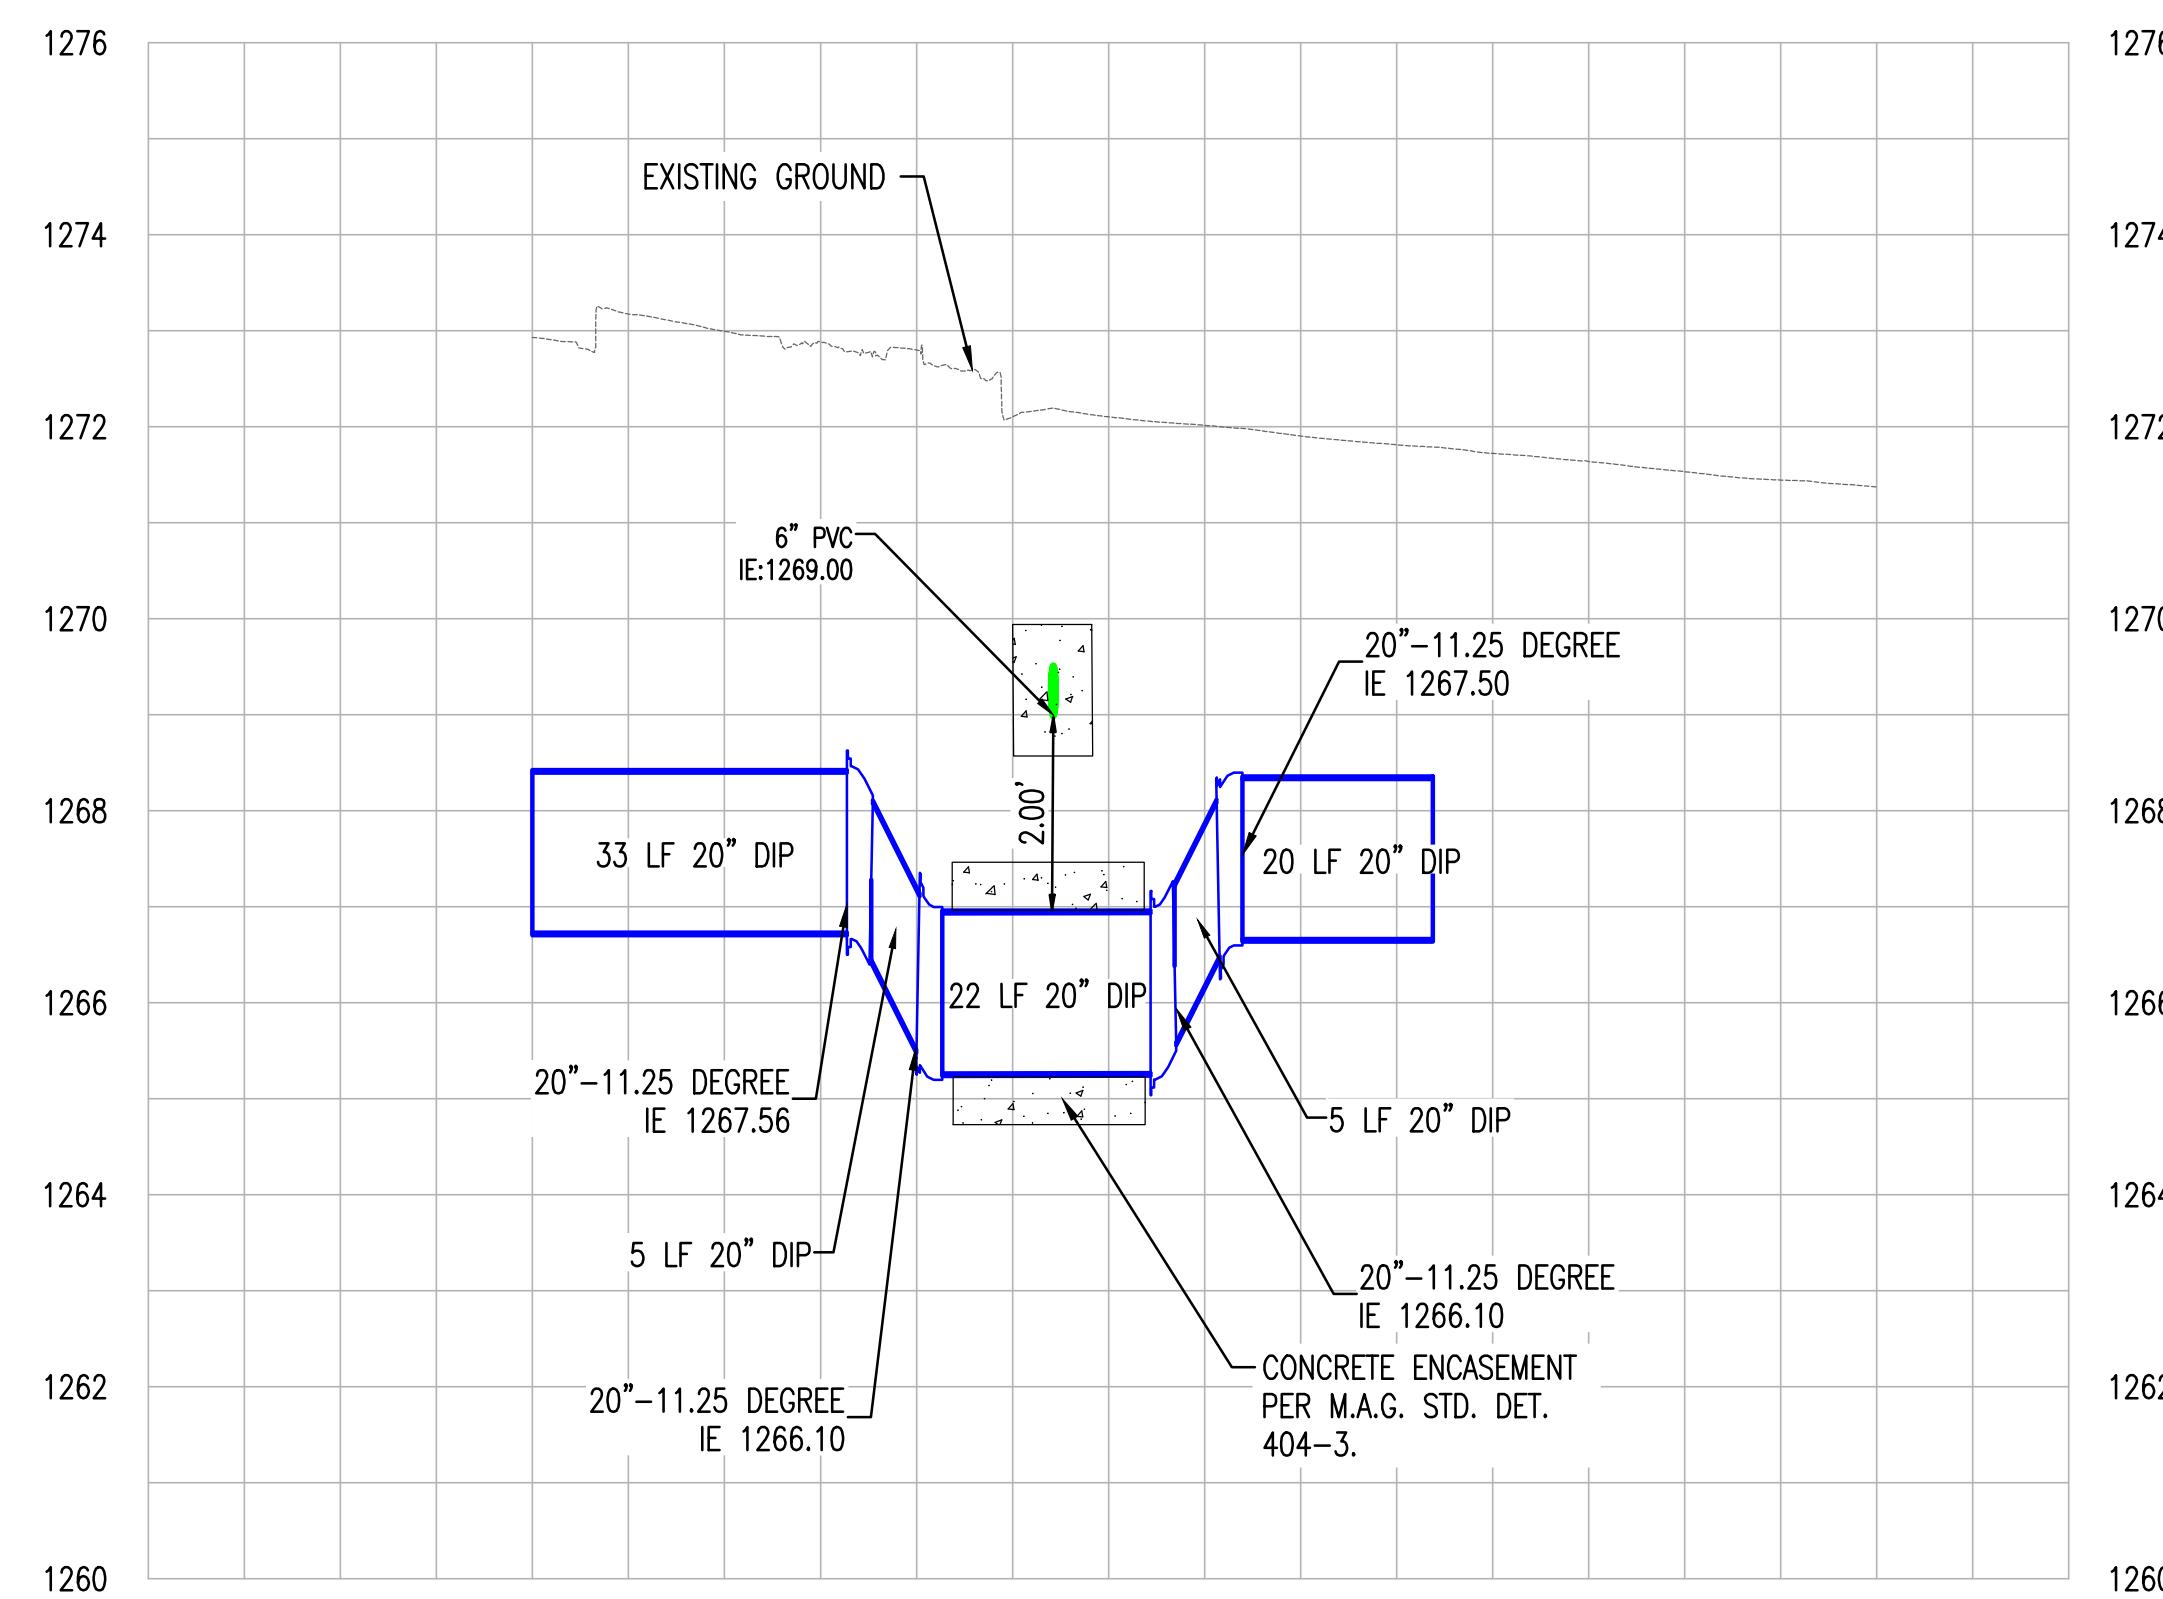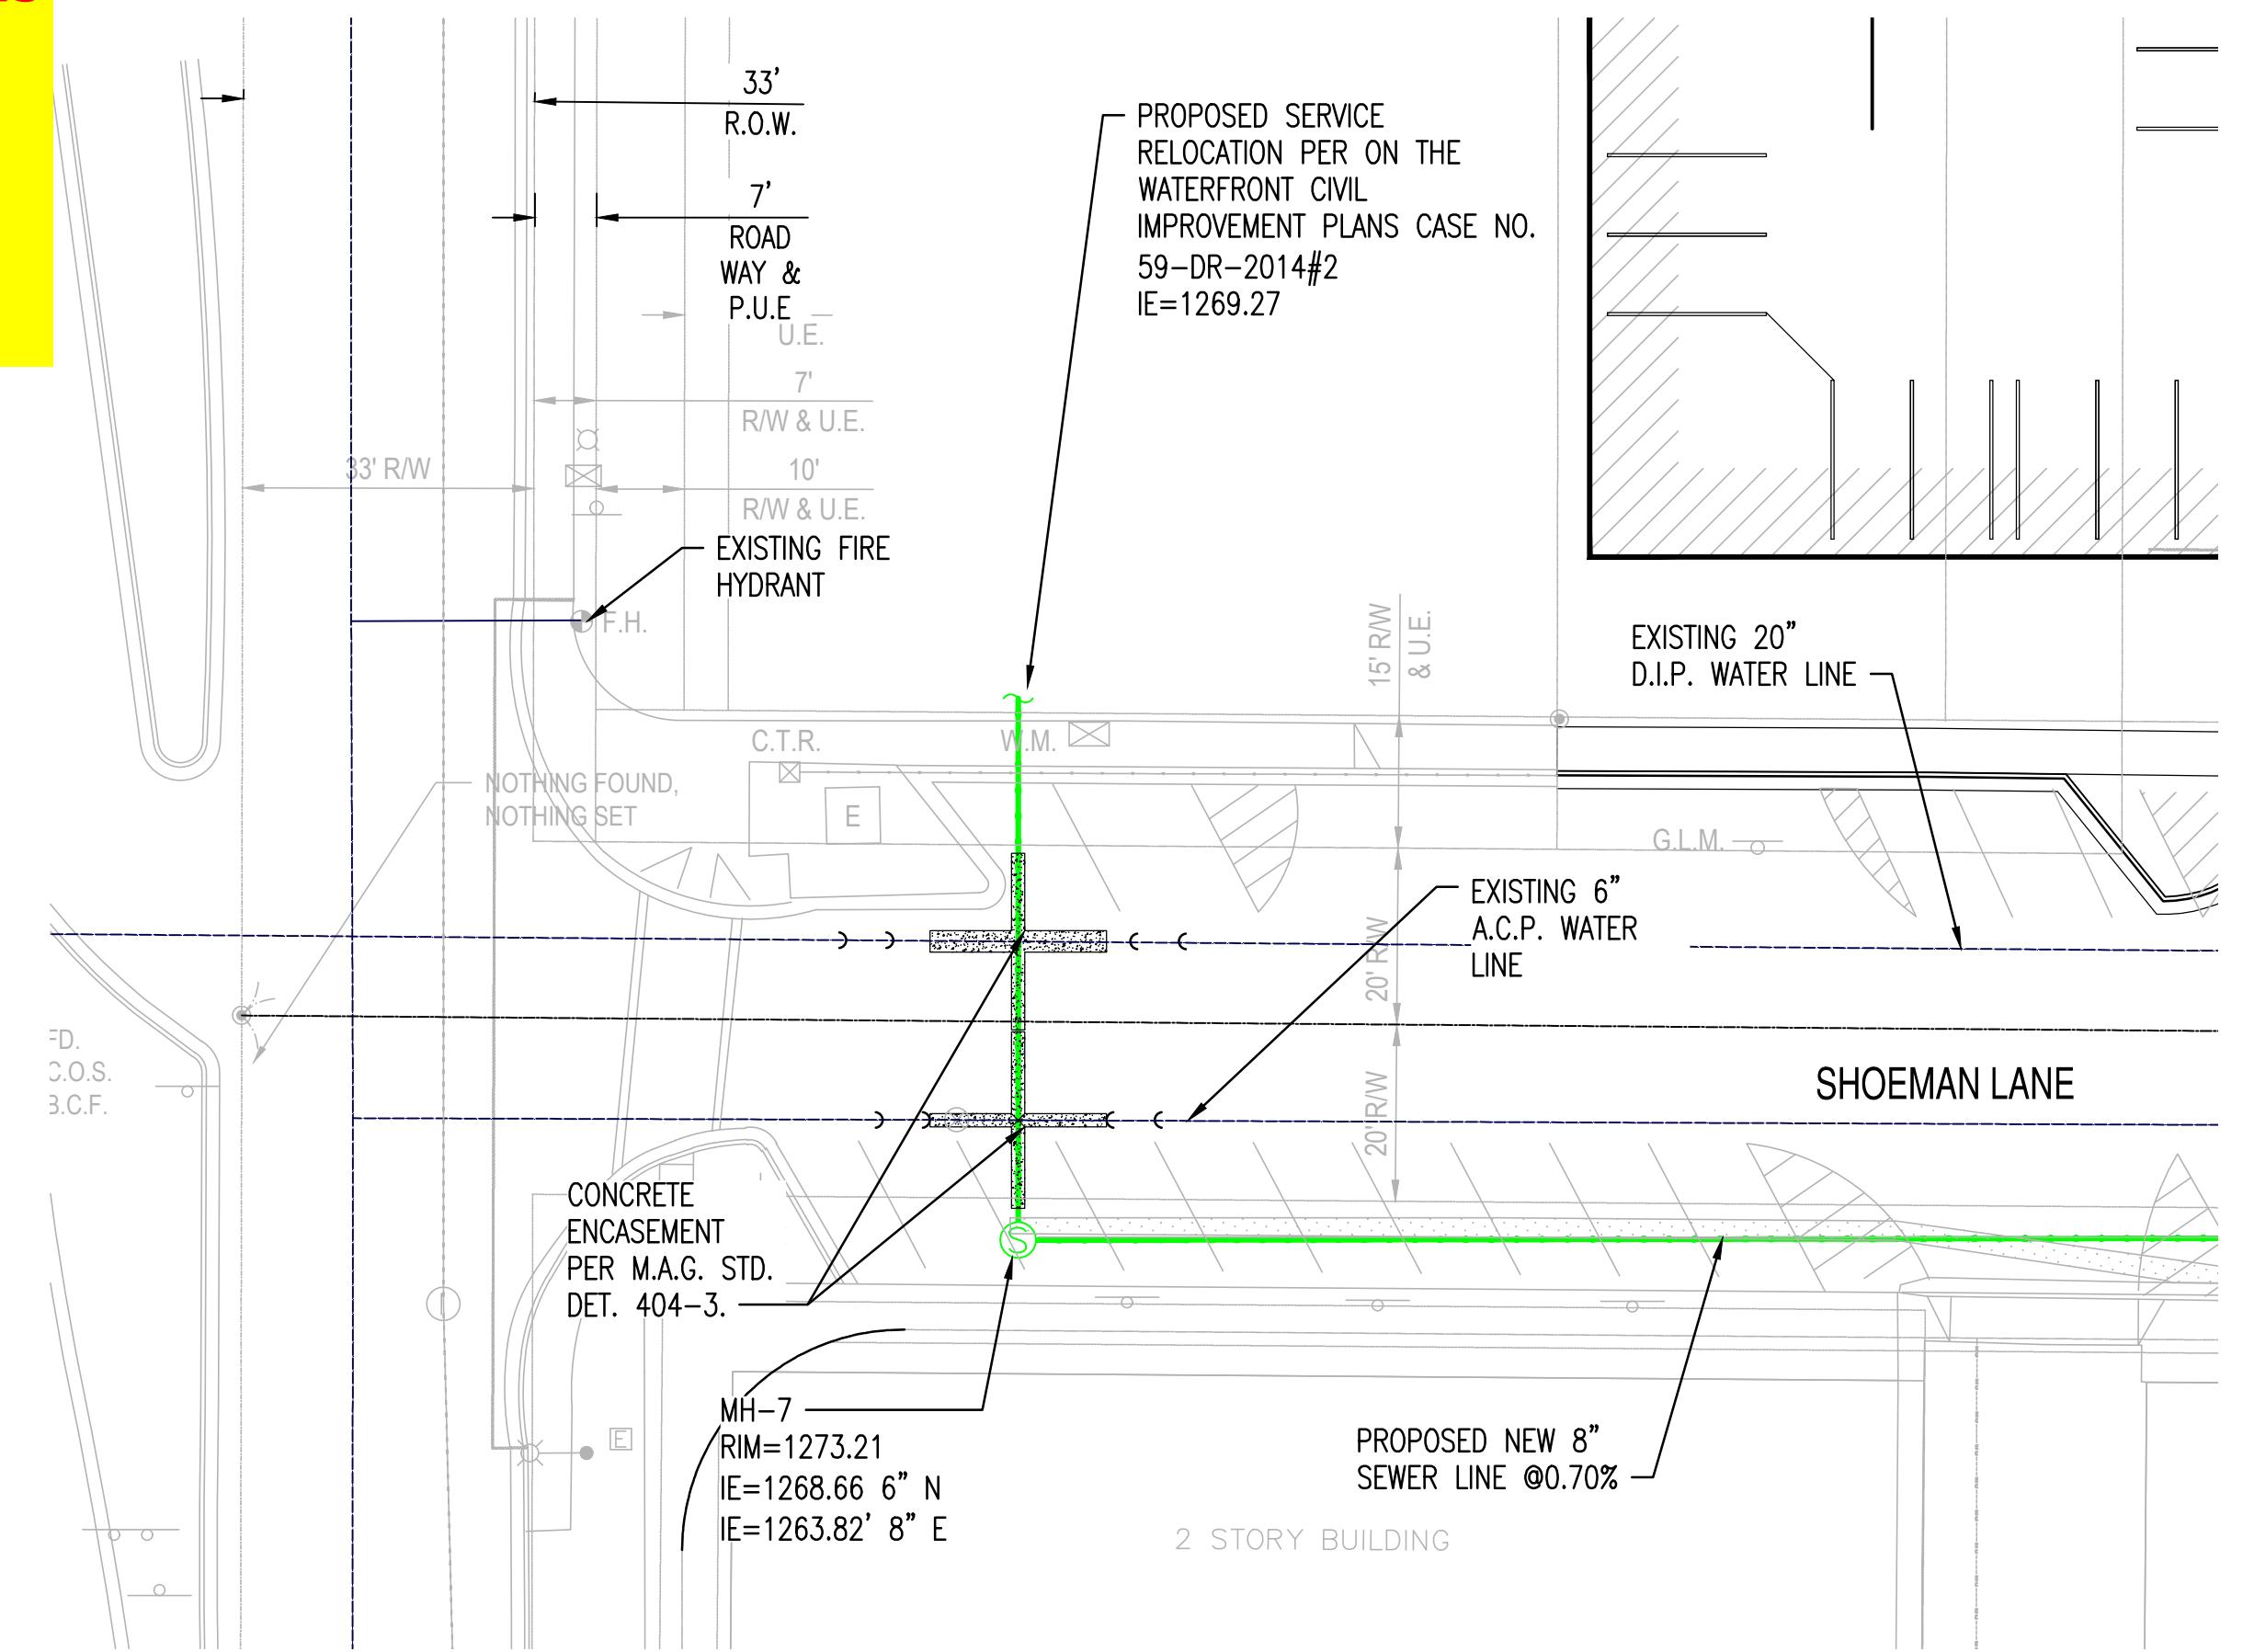

HORIZONTAL SCALE: 1" = 20'
VERTICAL SCALE: 1" = 2'

PRELIMINARY
NOT FOR
CONSTRUCTION

SUSTAINABILITY
ENGINEERING
GROUP



8280 E. GELDING DRIVE SUITE 101 SCOTSDALE, ARIZONA 85260
WWW.ZSEG.COM TEL: 480.388.7226 FAX: 480.389.3534

THIS DRAWING IS AN INSTRUMENT OF SERVICE AND THE PROPERTY OF SUSTAINABILITY ENGINEERING GROUP, AND SHALL REMAIN THEIR PROPERTY. THE USE OF THIS DRAWING SHALL BE RESTRICTED TO THE ORIGINAL SITE FOR WHICH IT IS PREPARED AND PUBLICATION THEREOF IS EXPRESSLY LIMITED TO SUCH USE.



PROJECT MAYA HOTEL	LOCATION NW. EAST INDIAN PLAZA & BUCKBOARD TRAIL
DRAWN	KA 04/28/2020
DESIGNED	KA 04/28/2020
QC	SC
QA	AF
PROJ. MGR.	AF
DATE: 08/07/2020	
ISSUED FOR: PRELIMINARY REVIEW	
REVISION NO.:	DATE:
△	
△	
△	
△	
JOB NO.: 200226	
SHEET TITLE: WATER CROSSING	
SHEET NO.: 5	