## **DEVELOPMENT REVIEW BOARD**

# REPORT



Meeting Date: October 21, 2021 General Plan Element: Character and Design

General Plan Goal: Foster quality design that enhances Scottsdale as a unique

southwestern desert community.

#### **ACTION**

Water Resources North/Keep Scottsdale Beautiful Public Art Project 2-DR-2021 Request for approval of the proposed location of public art enhancements, including structural monoliths, pavers, sandblasted pavement, metal attachments to bridge railing, and mural on the face of the Water Resources building.

#### **SUMMARY**

#### **Staff Recommendation**

Approve, subject to the attached stipulations (Attachment #5)

#### **Key Issues**

• None

#### **Items for Consideration**

- Conformance with Development Review Board Criteria staff confirms
- Final Concept Design was approved by the Public Art Advisory Board on 6-10-2020
- No community input received as of the date of this report

#### BACKGROUND

**Location:** 16800 N Greenway-Hayden Loop

Zoning: The site is zoned Open Space (OS). The site primarily

operates as TPC Scottsdale golf courses, but also houses a

City Public Works (water facility) building.

#### **Adjacent Uses**

North: R1-5 PCD, Crown Point II residential

East: Open Space, TPC golf Course South: C-4 & I-1, Auto Dealer and Bank West: Open Space, TPC golf Course



City of Scottsdale, Central Arizona Project

(Bureau of Reclamation)

#### **Applicant**


Kim Boganey (480) 874-4670

## Architect/Designer

Flying Carpet

#### Engineer

**KMO Engineering** 

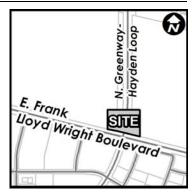

#### **DEVELOPMENT PROPOSAL**

The applicant seeks Development Review Board approval for location of the public artwork and associated hardscape, landscaping, and lighting improvements.

#### **Development Review Board Criteria**

Staff confirms that the development proposal generally meets the applicable Development Review Board Criteria. For a detailed analysis of the Criteria, please see Attachment #4.

#### STAFF RECOMMENDED ACTION

Staff recommends that the Development Review Board approve the Water Resources North/KSB Public Art development proposal per the attached stipulations, finding that the Development Review Criteria have been met.

RESPONSIBLE DEPARTMENTS	STAFF CONTACTS	
Planning and Development Services Current Planning Services	Casey Steinke Planner 480-312-2611 csteinke@Sco	ttsdaleAZ.gov
APPROVED BY		
Stein		10/7/21
Casey Steinke, Report Author		Date
Bul Com		10/7/2021
Brad Carr, AICP, LEED-AP, Planning & Develo	ppment Area Manager	Date
Development Review Board Liaison		
Phone: 480-312-7713 Email: bcarr@	scottsdaleaz.gov	
		10/13/2021
Randy Grant, Executive Director		Date
Planning, Economic Development, and To	purism	
Phone: 480-312-2664 Email: rgrant@	9scottsdaleaz.gov	

#### **ATTACHMENTS**

- 1. Context Aerial
- 2. Close-up Aerial
- 3. Applicant's Narrative
- 4. Development Review Board Criteria Analysis
- 5. Stipulations / Zoning Ordinance Requirements
- 6. Site Plan
- 7. Landscape Plan
- 8. Hardscape Plan
- 9. Artwork Renderings
- 10. Zoning Map
- 11. Community Involvement





#### Narrative

#### **Intersection Beautification Public Art Project**

#### Background Information:

Scottsdale Public Art (SPA) and Keep Scottsdale Beautiful (KSB) have joined together to spearhead a Public Art project with an educational component at the prestigious north intersection of Frank Lloyd Wright Boulevard and Greenway-Hayden Loop (north Hayden Road). The goal is to turn a destitute-looking intersection into a point-of-pride for Scottsdale.

The high-traffic, northern section of this intersection is an eyesore. It is clearly visible to 65,000 drivers that traverse Frank Lloyd Wright or Hayden Road every day. Each of the pilots and passengers of the 165,000+ planes that fly in and out of the Scottsdale airport look down on this barren intersection. Many of the people who attend the Waste Management Phoenix Open Golf Tournament are exposed to it.

The project will pair public artists, Patrick Renner & Kelly O'Brien of Flying Carpet Creative Studio out of Houston, with a local team of university students to include Jessica Arnold (NAU Interior Design), Rigoberto Berber-Arias and Alan Estrada Sanchez (both ASU School of Architecture). All were selected through a public competition.

Flying Carpet Creative will produce public art for the site and collaborate with the Student Team who will add to the art project by intertwining with the theme, materials, shapes, and colors to create a cohesive look for the intersection. The students will greatly enhance their experience by working jointly with the artists and participating in the art project from start to finish.

The design team's objective is for the project to add visual interest to augment the intersection with enhancements that mesh with and highlight the unique character of the natural and urban elements that make up Scottsdale. As such, the design guidelines will be followed in terms of the city's Design Standards and Policies Manual and Sensitive Design Guidelines, as well as the MAG Supplements.

For almost four years, KSB and SPA have been working behind the scenes to bring on the partners needed to ensure the project's approval and success. Collaboration has occurred and will continue to occur with The Bureau of Reclamation, Central Arizona Project, City of Scottsdale, and the Arizona Chapter of American Society of Landscape Architects.

The project will positively impact Scottsdale residents and visitors for generations to come.

#### Site Details:

The site includes land from curb to canal berm on both the northeast and northwest sides of the intersection. In addition, the site has many unique uses and constraints to include:

- The water facility walls, walkways and pedestrian bridges offer opportunities for art
- The area is in a highly visible area, so the art should require minimal maintenance
- Ingress/egress areas must be maintained for equipment used during canal maintenance
- Many utility boxes are on the site
- Terrain varies greatly to include several drop-offs

#### **Design Concept:**

The Central Arizona Canal runs through the middle of the site. This unique waterway inspired the artists and students. Their design concept is – *Water is essential for life. In the desert, this is magnified. The cholla cactus skeleton is a perfect indicator of the dichotomy between the presence and absence of water.* 

The design incorporates many facets to include sculptural monoliths, a mural, pavers and sidewalk etching, bridge design and landscaping. Each reiterates the theme of water, fluidity and the cholla skeleton.

#### Monoliths:

The Flying Carpet Creative have designed Monoliths that are inspired by the cholla skeleton. The 5 Monolith sculptures vary in heights from one another, with max height of 16'-0". The sculpture's fabrication will consist of reinforced concrete with aggregate no more than weight 1" width. Green glass will be imbedded into one side of the monoliths, tying into the color theme used throughout. Uplighting will be used to illuminate each structure at an angle to not cause light pollution, color temperature range 2700K-3000K. The illumination and size of the Monoliths will not interfere with air traffic regulations.

#### Mural:

The Mural Design will be placed on the southwest and southeast sides of both levels of Water Facility building, facing the canal. The design reflects the cholla skeleton flowing in a diagonal direction. Greens and blues have been specified as the color scheme. The building will be primed and will include a protective coat to ensure longevity of the Mural, with recommended touch-ups per muralist recommendations. Mural design reached approximately 29' in height just 1'-6" lower than roof of building. walls

#### Pavers, Pedestrian Bridge and Sidewalk:

The Paver, Bridge and Sidewalk design also reflect the voids of the cholla skeleton which is presented within both the Monoliths and the Mural. The fabrication of the Pavers will consist of concrete aggregate. Pavers vary in size with maximum length not to exceed 4'-6". Finish of Pavers will include finely crushed recycled green glass. The land under each Paver will be reinforced and consist of appropriate gravel for soil support. The Pavers will be fabricated using molds for shape and size consistency.

The flow continues across the Pedestrian Bridge which is a mix of sandblasted etching on the lower portion and stainless steel panels on the upper. The cholla voids drop onto the Sidewalks and allow for a continued flow of the art and also providing vehicle access onto the site. The Sidewalk design is sandblasted etchings. The depth of the etching will not exceed 1/8" per safety regulations and has been used successfully in other Scottsdale Public Art projects.

#### Landscape:

The Landscape Design uses minimal native vegetation with placement based on CAP requirements. The total of 4 CAP drives and other space that will be required for parking restricts the number of plants that can be located throughout the site. The southeast and southwest corners of Frank Lloyd Wright allow for additional Landscaping. Smaller groupings of plants will be placed per Planting Plan with

required 5'-0" spacing of thorny plants from sidewalk edge. The Landscaping will significantly alter the feel of the site and bring the site design a holistic feel while remaining small scale.

#### DEVELOPMENT REVIEW BOARD CRITERIA ANALYSIS

Per Section 1.904. of the Zoning Ordinance, in considering any application for development, the Development Review Board shall be guided by the following criteria:

#### **Artwork Location**

The location of artwork provided in accordance with the Cultural Improvement Program or Public Art Program shall address the following criteria:

- a. Accessibility to the public;
  - The proposed location of the artwork and ground improvements are accessible to the public on a pedestrian and vehicular level. The artwork will be primarily seen from north and west-bound traffic along Frank Lloyd Wright Blvd and N. Greenway-Harden Loop.
- b. Location near pedestrian circulation routes consistent with existing or future development or natural features;
  - The mural will be visible along the southern water facility façade, with landscape and hardscape improvements along existing sidewalks along the CAP Canal.
- c. Location near the primary pedestrian or vehicular entrance of a development;
  - The artwork will be located along the southern water facility façade near the Frank Lloyd Wright and N. Greenway-Hayden Loop intersection which functions as the main entrance into the TPC and water facility site.
- d. Location in conformance with the Design Standards and Policies Manual for locations affecting existing utilities, public utility easements, and vehicular sight distance requirements;
  - City staff have reviewed the artwork location and have verified that the location complies with the Design Standards and Policies Manual.
  - Site improvements vis-à-vis PUEs and SDE protections have been reviewed to the satisfaction of staff.
- e. Location in conformance to standards for public safety;
  - Staff has reviewed the site improvement areas which appear to comply with the applicable public safety requirements. The hardscape, landscape, and guard rail modifications will also undergo a final plan review by city departments prior to permitting.

#### **Associated Improvements**

The site includes land from the curb to the canal berms northeast and northwest of the site's intersection. Aside from the headline mural, the project includes five monolith structures inspired by the cholla cactus skeleton. Those influences can also be seen in the new sandblasted pavers which transcend from the sidewalk up to the bridge guardrail along the canal. There will also be associated uplighting of the monoliths. There will also be landscaping touchups based on City and CAP requirements.

## Stipulations for the

## **Development Review Board Application:**

## Water Resources North/Keep Scottsdale Beautiful Public Art Project

Case Number: 2-DR-2021

These stipulations are intended to protect the public health, safety, welfare, and the City of Scottsdale.

#### **APPLICABLE DOCUMENTS AND PLANS:**

- 1. Except as required by the Scottsdale Revised Code (SRC), the Design Standards and Policies Manual (DSPM), and the other stipulations herein, the site design and construction shall substantially conform to the following documents:
  - a. Architectural elements, including dimensions, materials, form, color, and texture shall be constructed to be consistent with the building elevations submitted by the KSB and SPA mural design team, with a city staff date of 8/6/21.
  - b. The location and configuration of all site improvements shall be consistent with the site plan submitted by KSB, with a city staff date of 8/6/21.
  - c. Landscape improvements, including quantity, size, and location shall be installed to be consistent with the preliminary landscape plan submitted by KSB, with a city staff date of 8/6/21.

#### **SITE DESIGN:**

#### **DRB Stipulations**

2. Prior to issuance of any building permit for the development project, the property owner shall submit documentation authorizing project infrastructure's location on Bureau of Reclamation land, as applicable.

#### **LANDSCAPE DESIGN:**

#### **Ordinance**

A. If applicable, the property owner shall obtain approval of a Salvage/Native Plant Plan Application, and obtain a permit to remove any Native plants.

#### **EXTRIOR LIGHTING:**

#### **Ordinance**

- B. No exterior luminaire shall have a total initial lumen output of greater than 3050 lumens.
- C. All exterior up-lit luminaires shall be directed towards the monolith structures to mitigate light pollution.

#### **STREET INFRASTRUCTURE:**

#### **Ordinance**

- D. All street infrastructure improvements shall be constructed in accordance with this City of Scottsdale (COS) Supplement to MAG Specifications and Details, and the Design Standards and Policies Manual.
- E. Prior to the issuance of any building permit for the development project, the property owner shall submit and obtain approval of civil construction documents to construct the project.

#### **DRB Stipulations**

3. All curb ramps for public and pedestrian sidewalks that intersect public and private streets, or driveways that intersect public and private streets, shall have truncated domes that are colored to match Frazee Western Reserve (8617N) color, or Sherman Williams (SW7055) Enduring Bronze (246-C7).

STRUCTURAL DESIGN CRITERIA:

DESIGN CODE: 2015 INTERNATIONAL BUILDING CODE

WATER SHALL NOT BE ADDED AT THE JOB SITE. IT IS THE RESPONSIBILITY OF THE CONTRACTOR TO ENSURE THAT THE MIX SUPPLIED IS WORKABLE WITHOUT ADDING WATER AT THE SITE.

CAPACITY = 1,500PSF. ASSUMED FRICTION COEFFICIENT = 0.25". SITE SOIL REGISTERED ENGINEER. SHALL BE COMPACTED TO A BEARING CAPACITY OF 1,500PSF.

GEOTECHNICAL REPORT IS NOT AVAILABLE. ASSUMED ALLOWABLE BEARING CONCRETE MIX DESIGN SHALL BE COMPLETED BY A QUALIFIED LAB AND

ULTIMATE WIND SPEED, VULT = 115 MPH NOMINAL WIND SPEED, VASD = 89.1 MPH

RISK CATEGORY "II" WIND EXPOSURE "C"

FREESTANDING WALL PRESSURE: 38PSF

**CONCRETE & REINFORCEMENT NOTES:** 

**MATERIAL STANDARDS:** 

**CONCRETE:** NORMAL WEIGHT AGGREGATE – ASTM C33

F'C = 4,500 PSI

MAX W/CM RATIO = 0.45

TO ASTM C260

OF TABLE 4.3.1 OF ACI 318-11. CEMENT SHALL CONFORM TO ASTM C150

CALCIUM CHLORIDE ADMIXTURE SHALL NOT BE USED

AND OBTAIN DESIRED CONCRETE STRENGTH.

**CURING:** 

HARD CONCRETE. THIS CAN BE OBTAINED BY COVERING THE SURFACE WITH NON-SHRINK, NON-METALLIC GROUT SHALL BE USED IN GROUT TUBES AND "VISQUEEN" PLASTIC IMMEDIATELY AFTER THE CONCRETE HAS HARDENED. GROUT BED BELOW WALL. DRY PACK GROUT UNDER WALL AFTER ERECTION. LEAVE PLASTIC IN PLACE FOR A MINIMUM OF 7 DAYS.

DO NOT ALLOW SURFACE TO DRY BEFORE APPLYING "VISQUEEN" PLASTIC OR OTHER CURING MEDIUM. FOLLOW RECOMMENDATION OF ACI DOCUMENT 306 TITLED "COLD WEATHER CONCRETING". DO NOT ALLOW CONCRETE TO FREEZE FOR AT LEAST 7 DAYS.

**HOT WEATHER:** 

AFTER CONCRETE HAS SET. FOLLOW RECOMMENDATIONS OF ACI DOCUMENT 305 TITLED "HOT WEATHER CONCRETING".

**REINFORCING:** 

REBAR – ASTM A615, GRADE 60 (FY = 60 KSI MIN.) WELDED WIRE – ASTM A1064 (FY = 65 KSI MIN.)

DETAILED REINFORCING TO COMPLY WITH ACI 315 "MANUAL OF STANDARD PRACTICE FOR DETAILING REINFORCING CONCRETE STRUCTURES" AND THE CONCRETE REINFORCING STEEL INSTITUTE (CRSI) RECOMMENDATIONS.

MINIMUM CLEAR CONCRETE COVER FOR REINFORCEMENT SHALL BE AS FOLLOWS UNLESS NOTED OTHERWISE:

CONCRETE CAST DIRECTLY AGAINST AND PERMANENTLY EXPOSED TO EARTH

**CONCRETE EXPOSED TO WEATHER OR EARTH:** 


#5 BARS OR SMALLER – 1 ½" #6 BARS OR LARGER – 2"


AIR CONTENT FOR EXPOSURES F1-F3 MUST MEET THE REQUIREMENTS OF LAP SPLICE LENGTHS (UNLESS OTHERWISE NOTED) SHALL BE 54X BAR TABLE 4.4.1 OF ACI 318-11. AIR-ENTRAINING ADMIXTURES SHALL CONFORM DIAMETERS FOR #6 BARS AND SMALLER. 67X BAR DIAMETERS FOR #7 BARS AND GREATER.


THE CEMENT TYPE FOR EXPOSURES S1-S3 MUST MEET THE REQUIREMENTS USE CHAIRS OR OTHER SUPPORT DEVICES AS REQUIRED FOR PROPER CLEARANCE

WELDING OF REBAR IS NOT ALLOWED. ALL EMBEDMENTS, REINFORCING, AND DOWELS SHALL BE SECURELY TIED TO FRAMEWORK OR TO ADJACENT PROPER INSTALLATION OF CONCRETE IS IMPORTANT TO MINIMIZE CRACKS REINFORCING PRIOR TO PLACEMENT OF THE CONCRETE. TACK WELDING OF REBAR IS NOT ALLOWED.

GROUT TUBE SHALL BE SIZED TO ACCOMMODATE INSTALLATION A MINIMUM AMOUNT OF CURING IS RECOMMENDED TO OBTAIN A DURABLE TOLERANCES WHILE MAINTAINING PROPER CONCRETE CLEARANCES. 5,000PSI

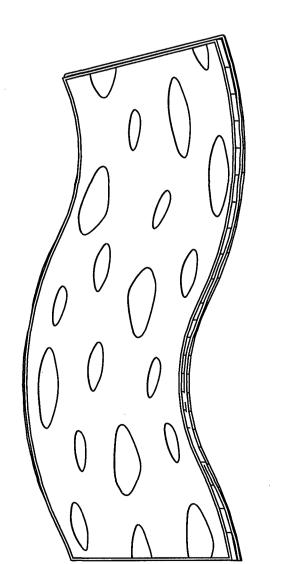


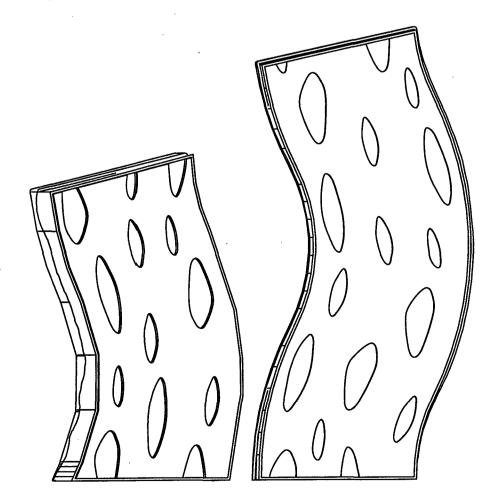

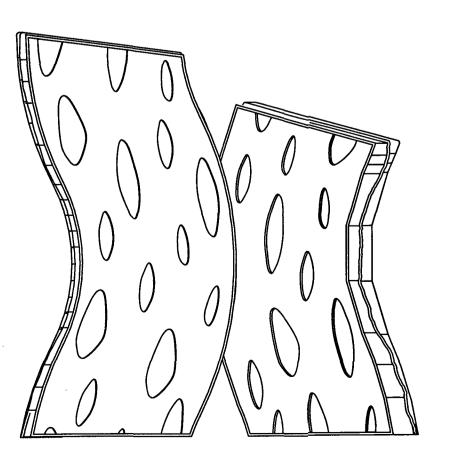

ISO - MONOLITHS Scale 1/4" = 1'-0"

**Attachment #6** 

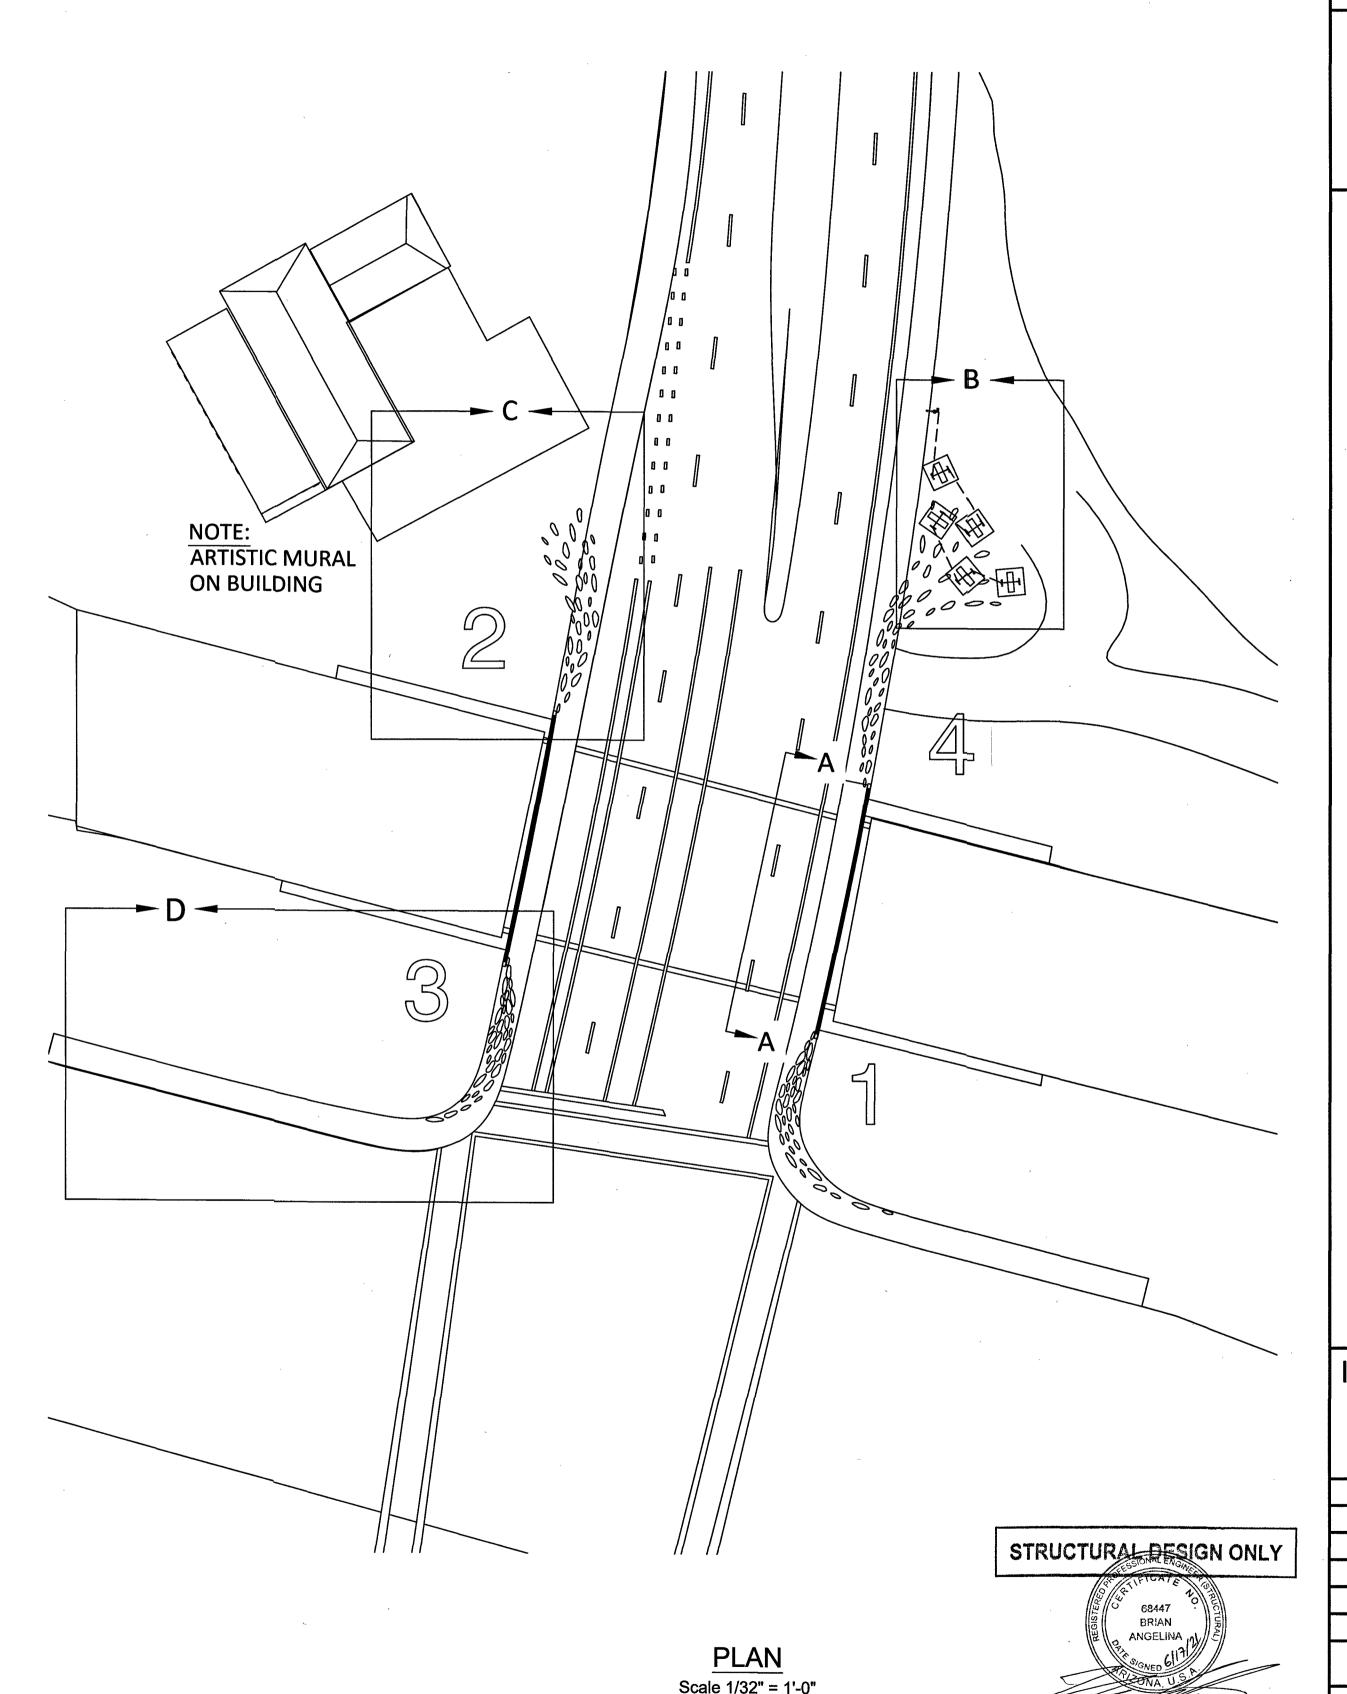

SC

**ISSUE DATE:** 12-06-19

REV 1 12-06-19 REV 2 03-26-20 REV 3 10-04-20 10-21-20 REV 4 11-15-20 REV 5 05-18-21 PROJECT # 019-FC1


**DRAWING NAME: FOUNDATION** 

AND FORM

Gary K. Munkelt &
Associates, LLC
Structural Consulting Engineers
1180 Welsh Rd, Suite 190
North Wales, PA 19454 Phone 215-855-8713 Fax 215-855-8714


DESIGN OF CONCRETE WALL AND FOOTING STRUCTURE ONLY


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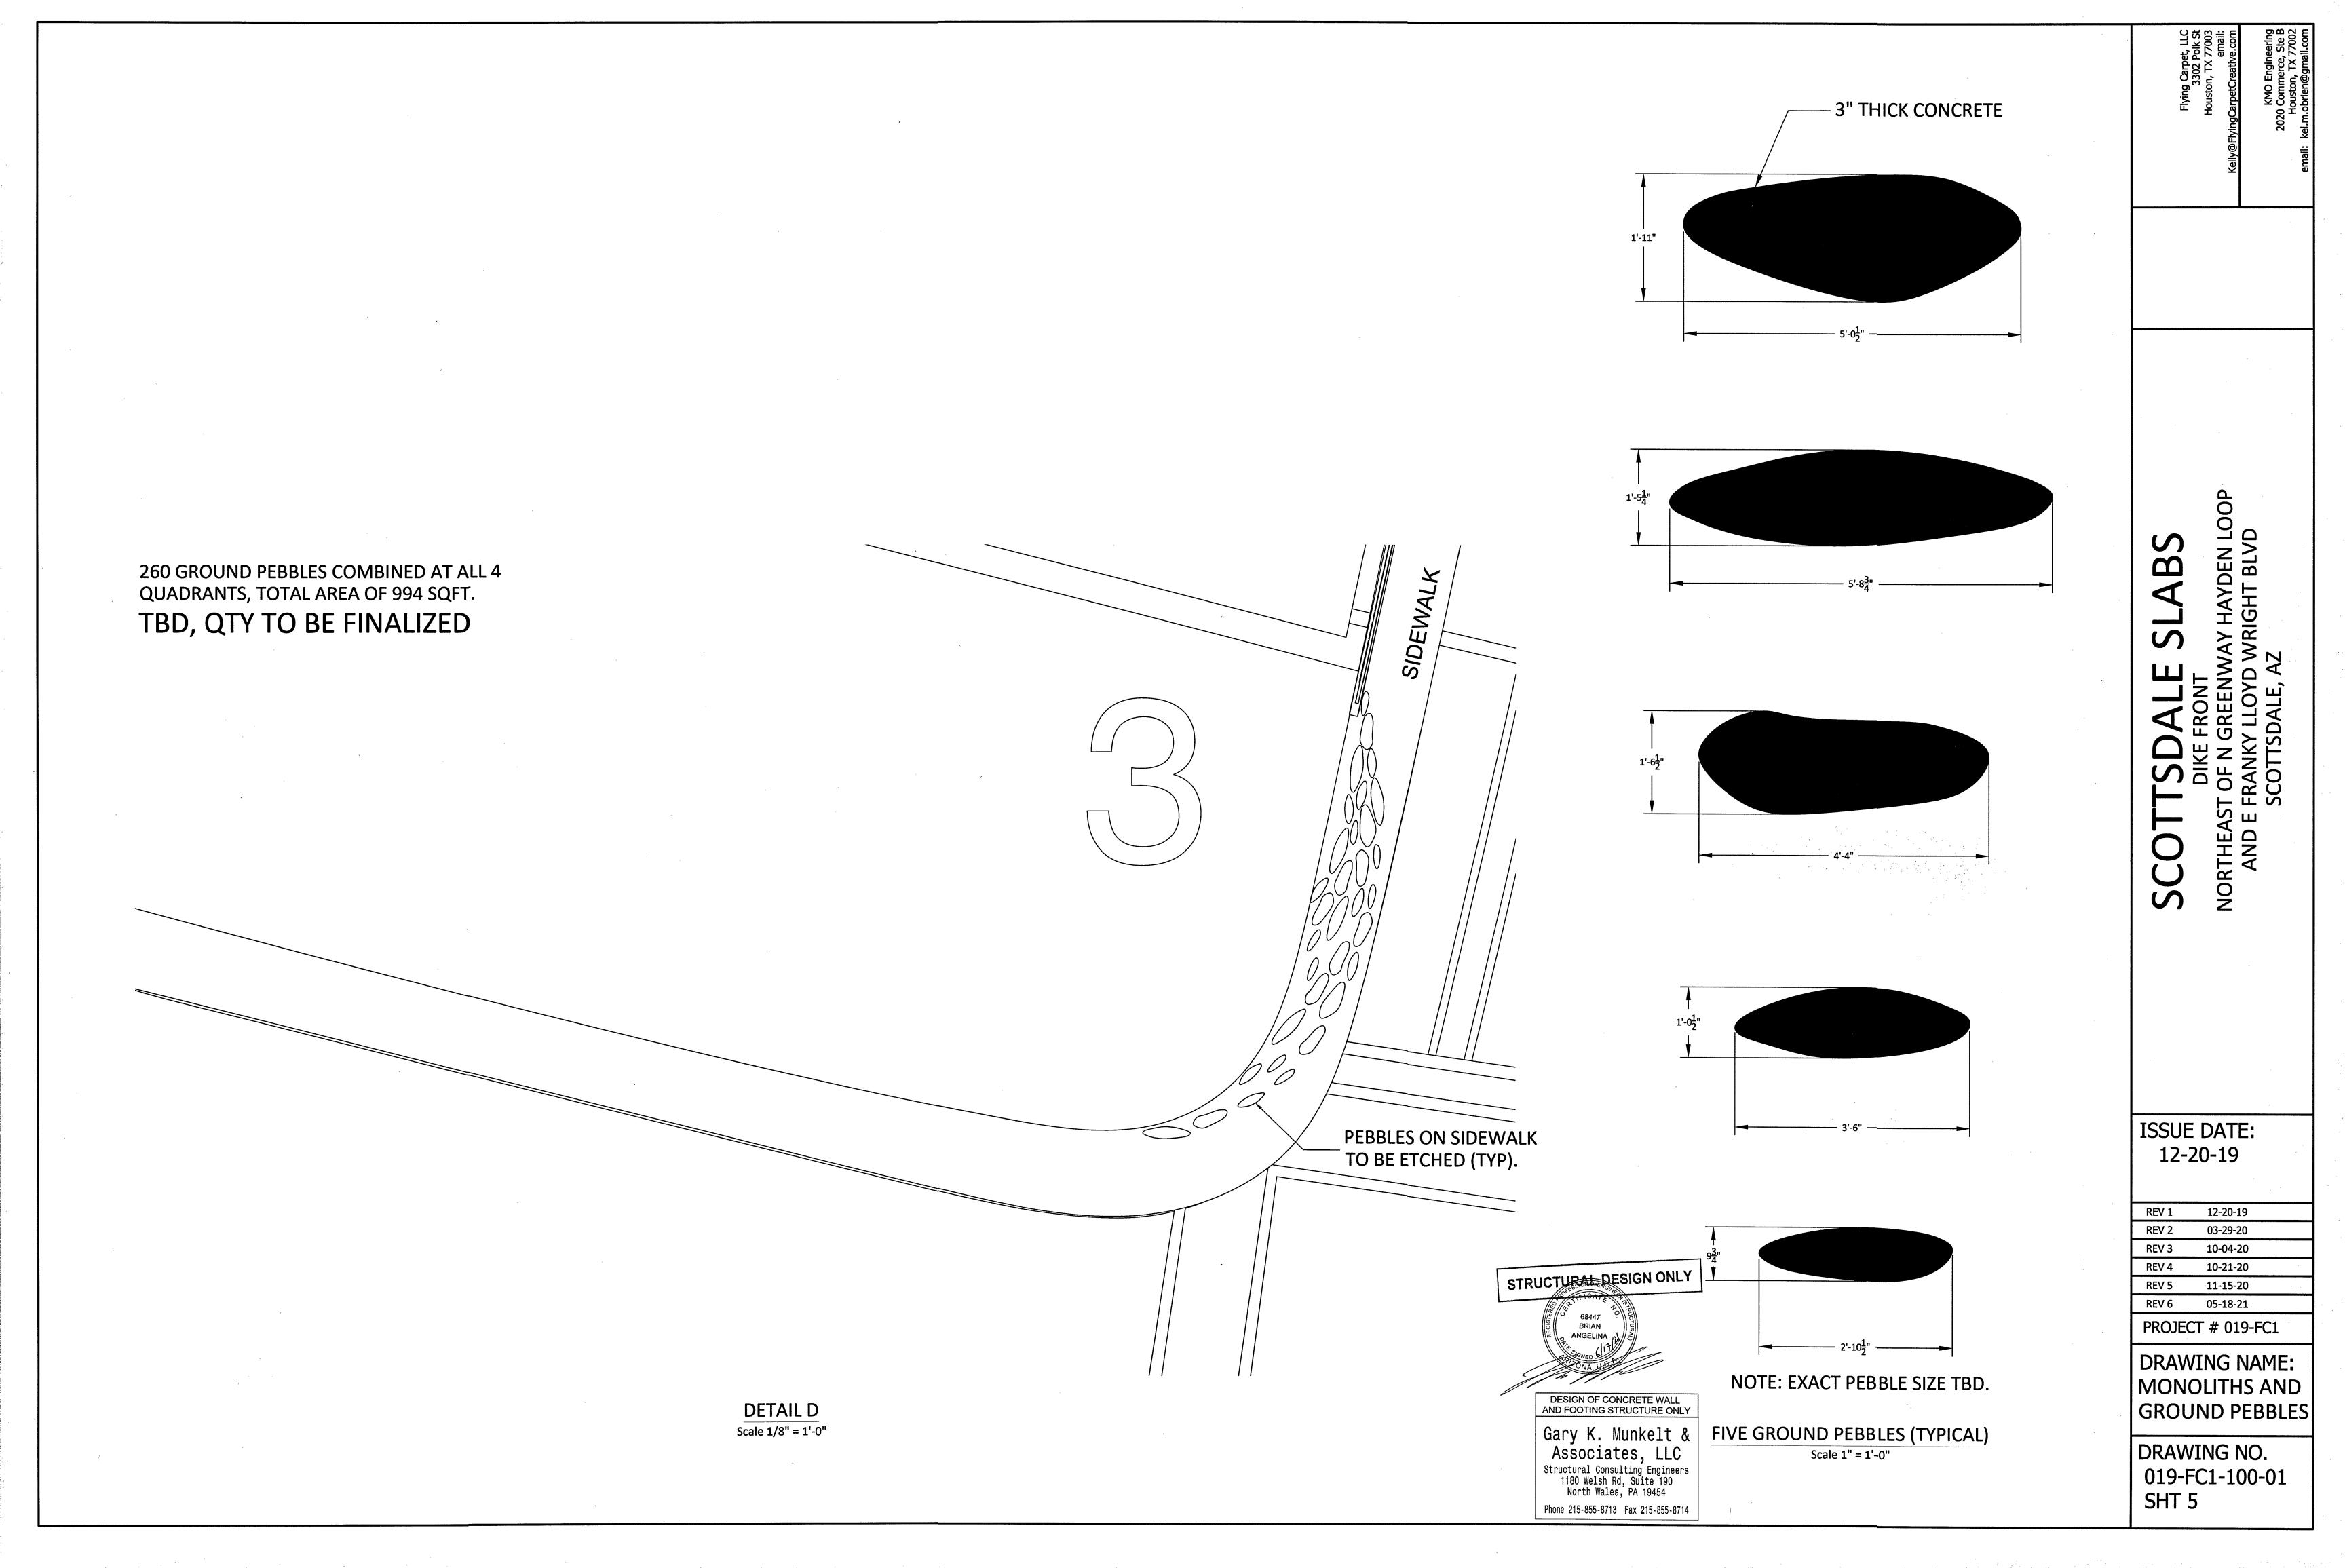


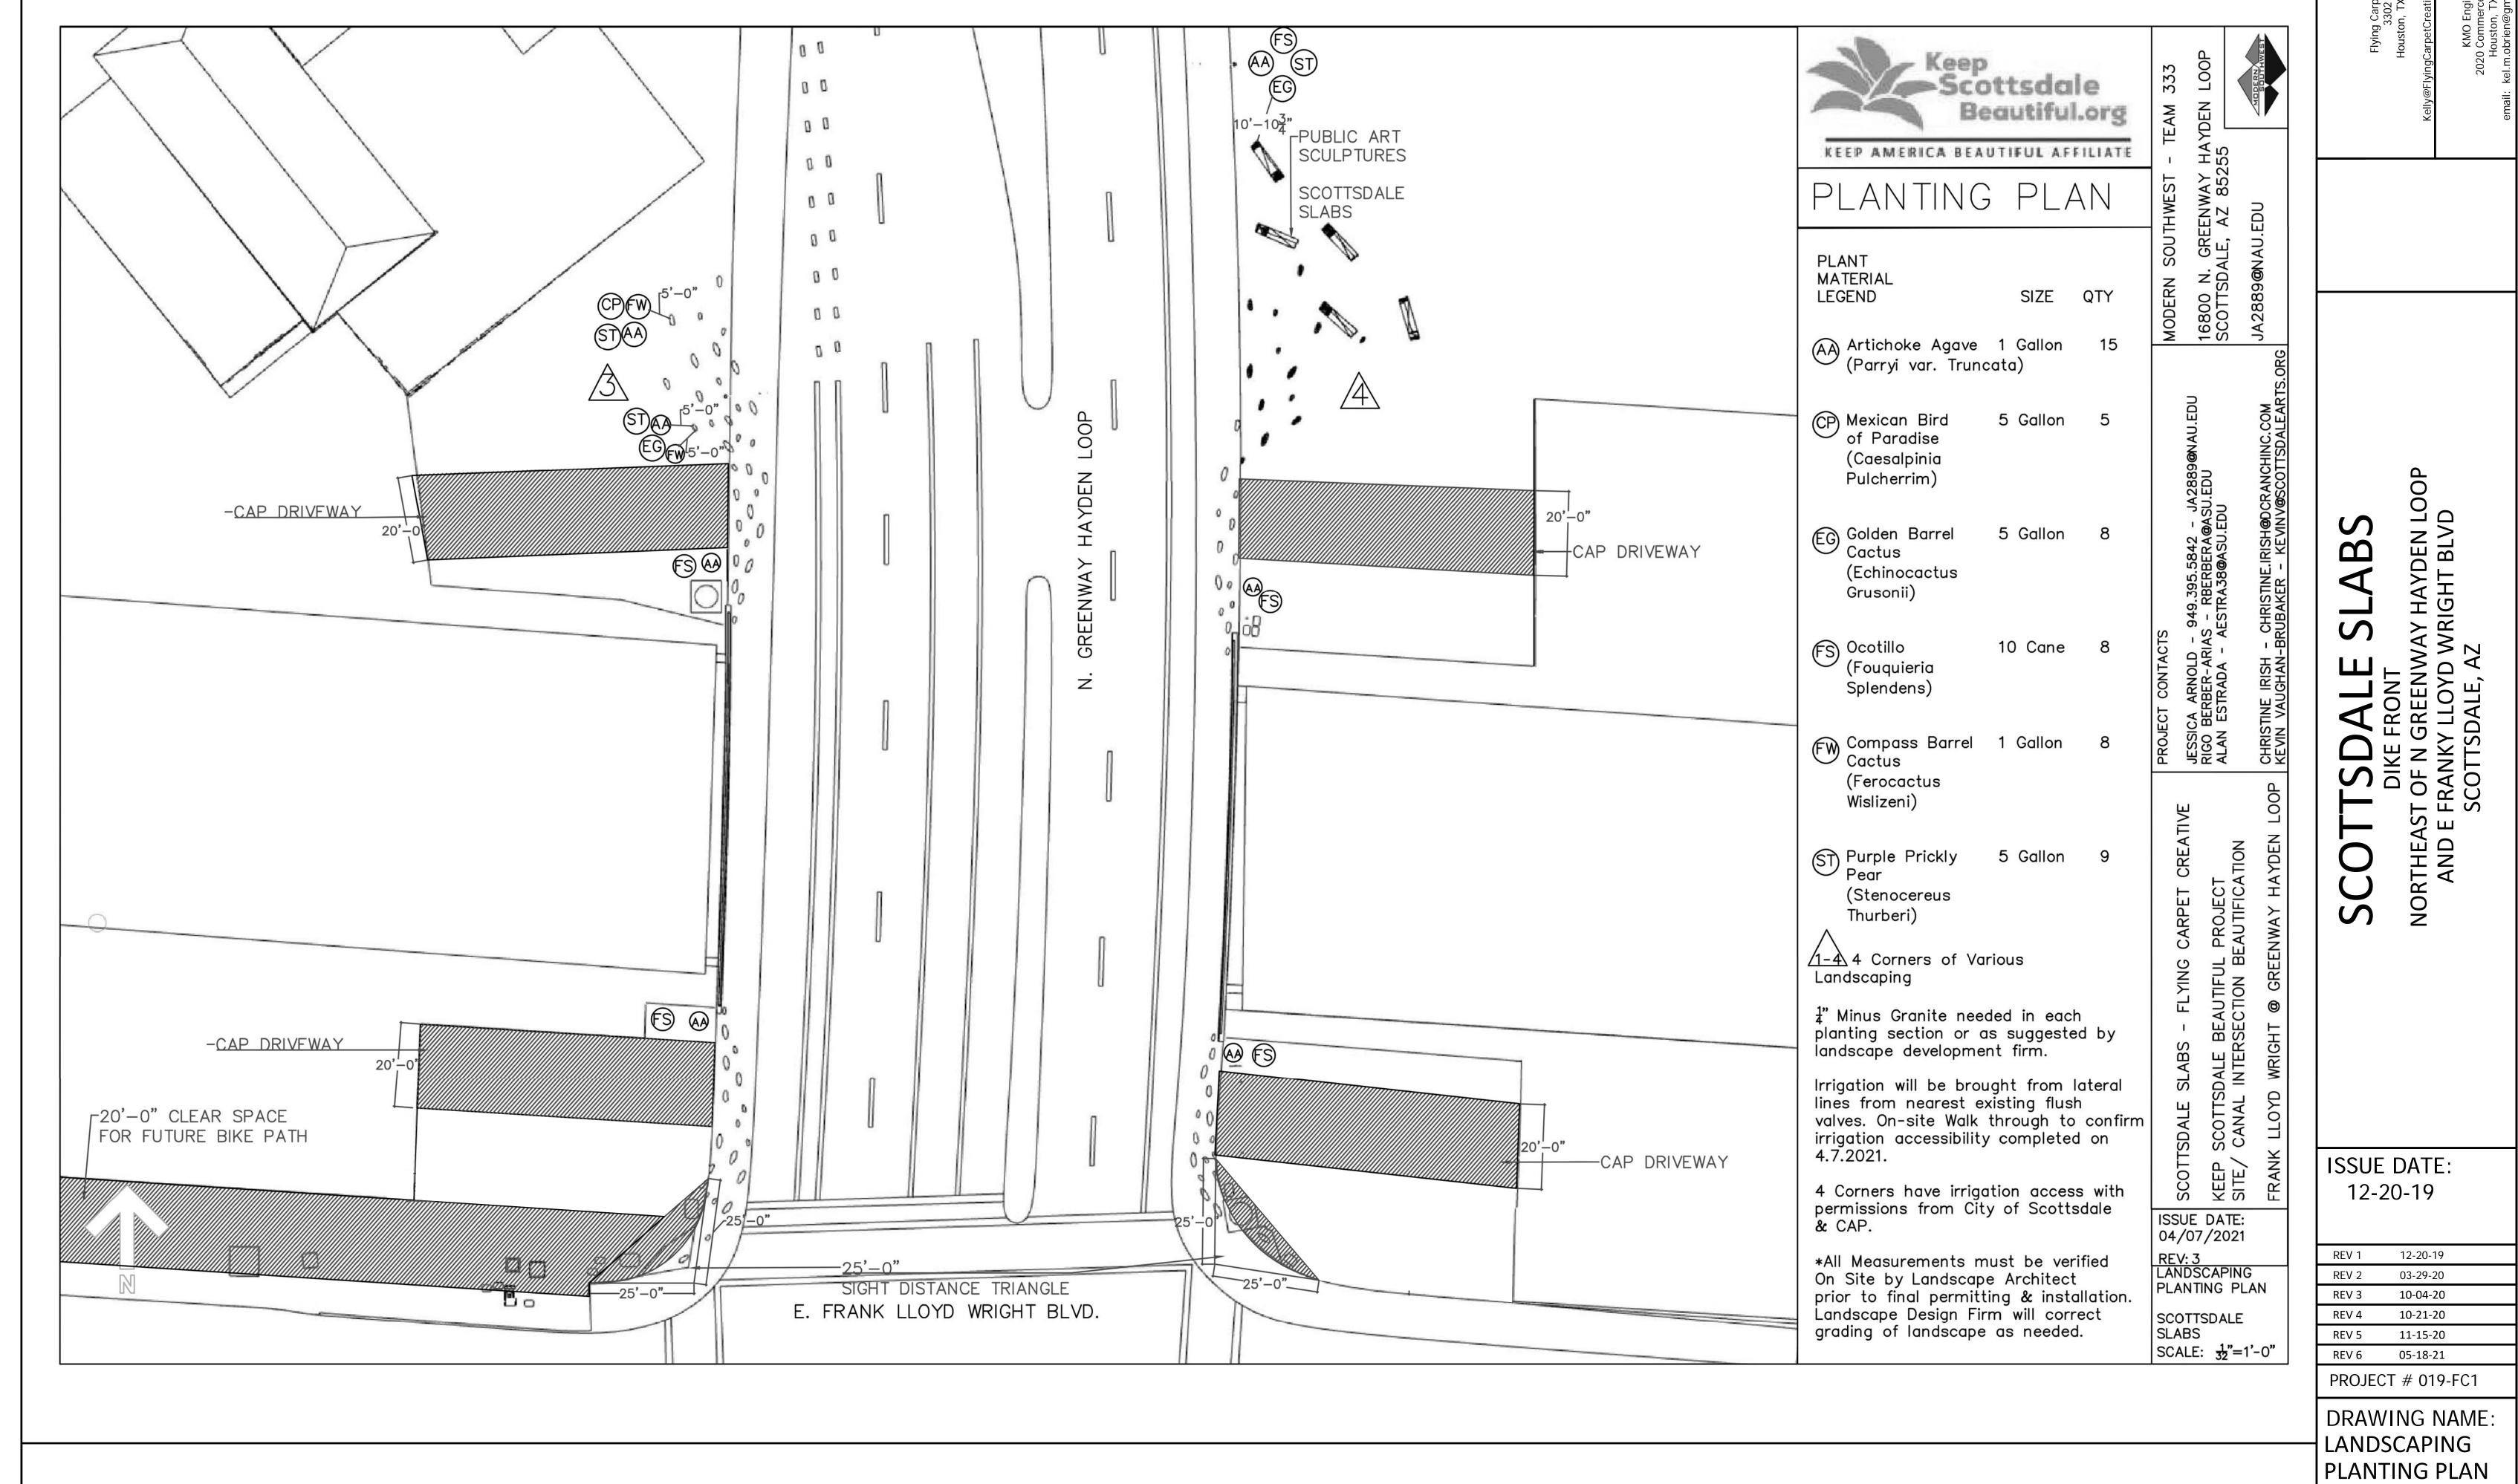
**Attachment #7** 

DRAWING NO. 019-FC1-100-01 SHT 7



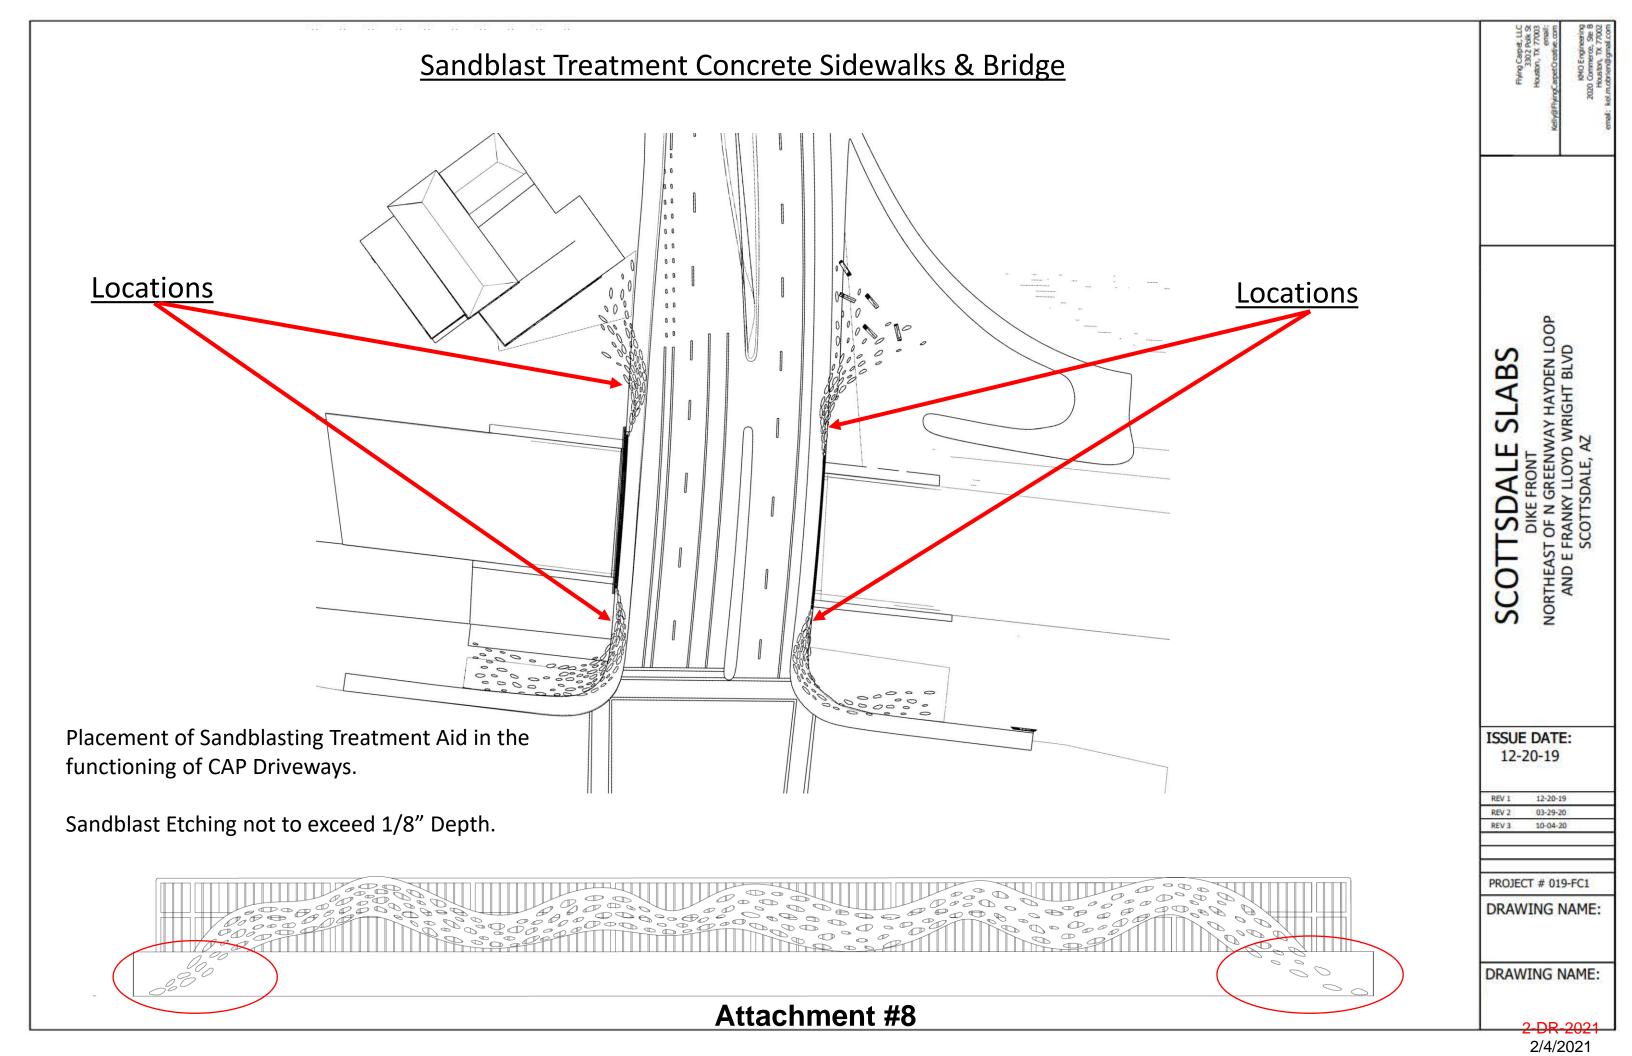

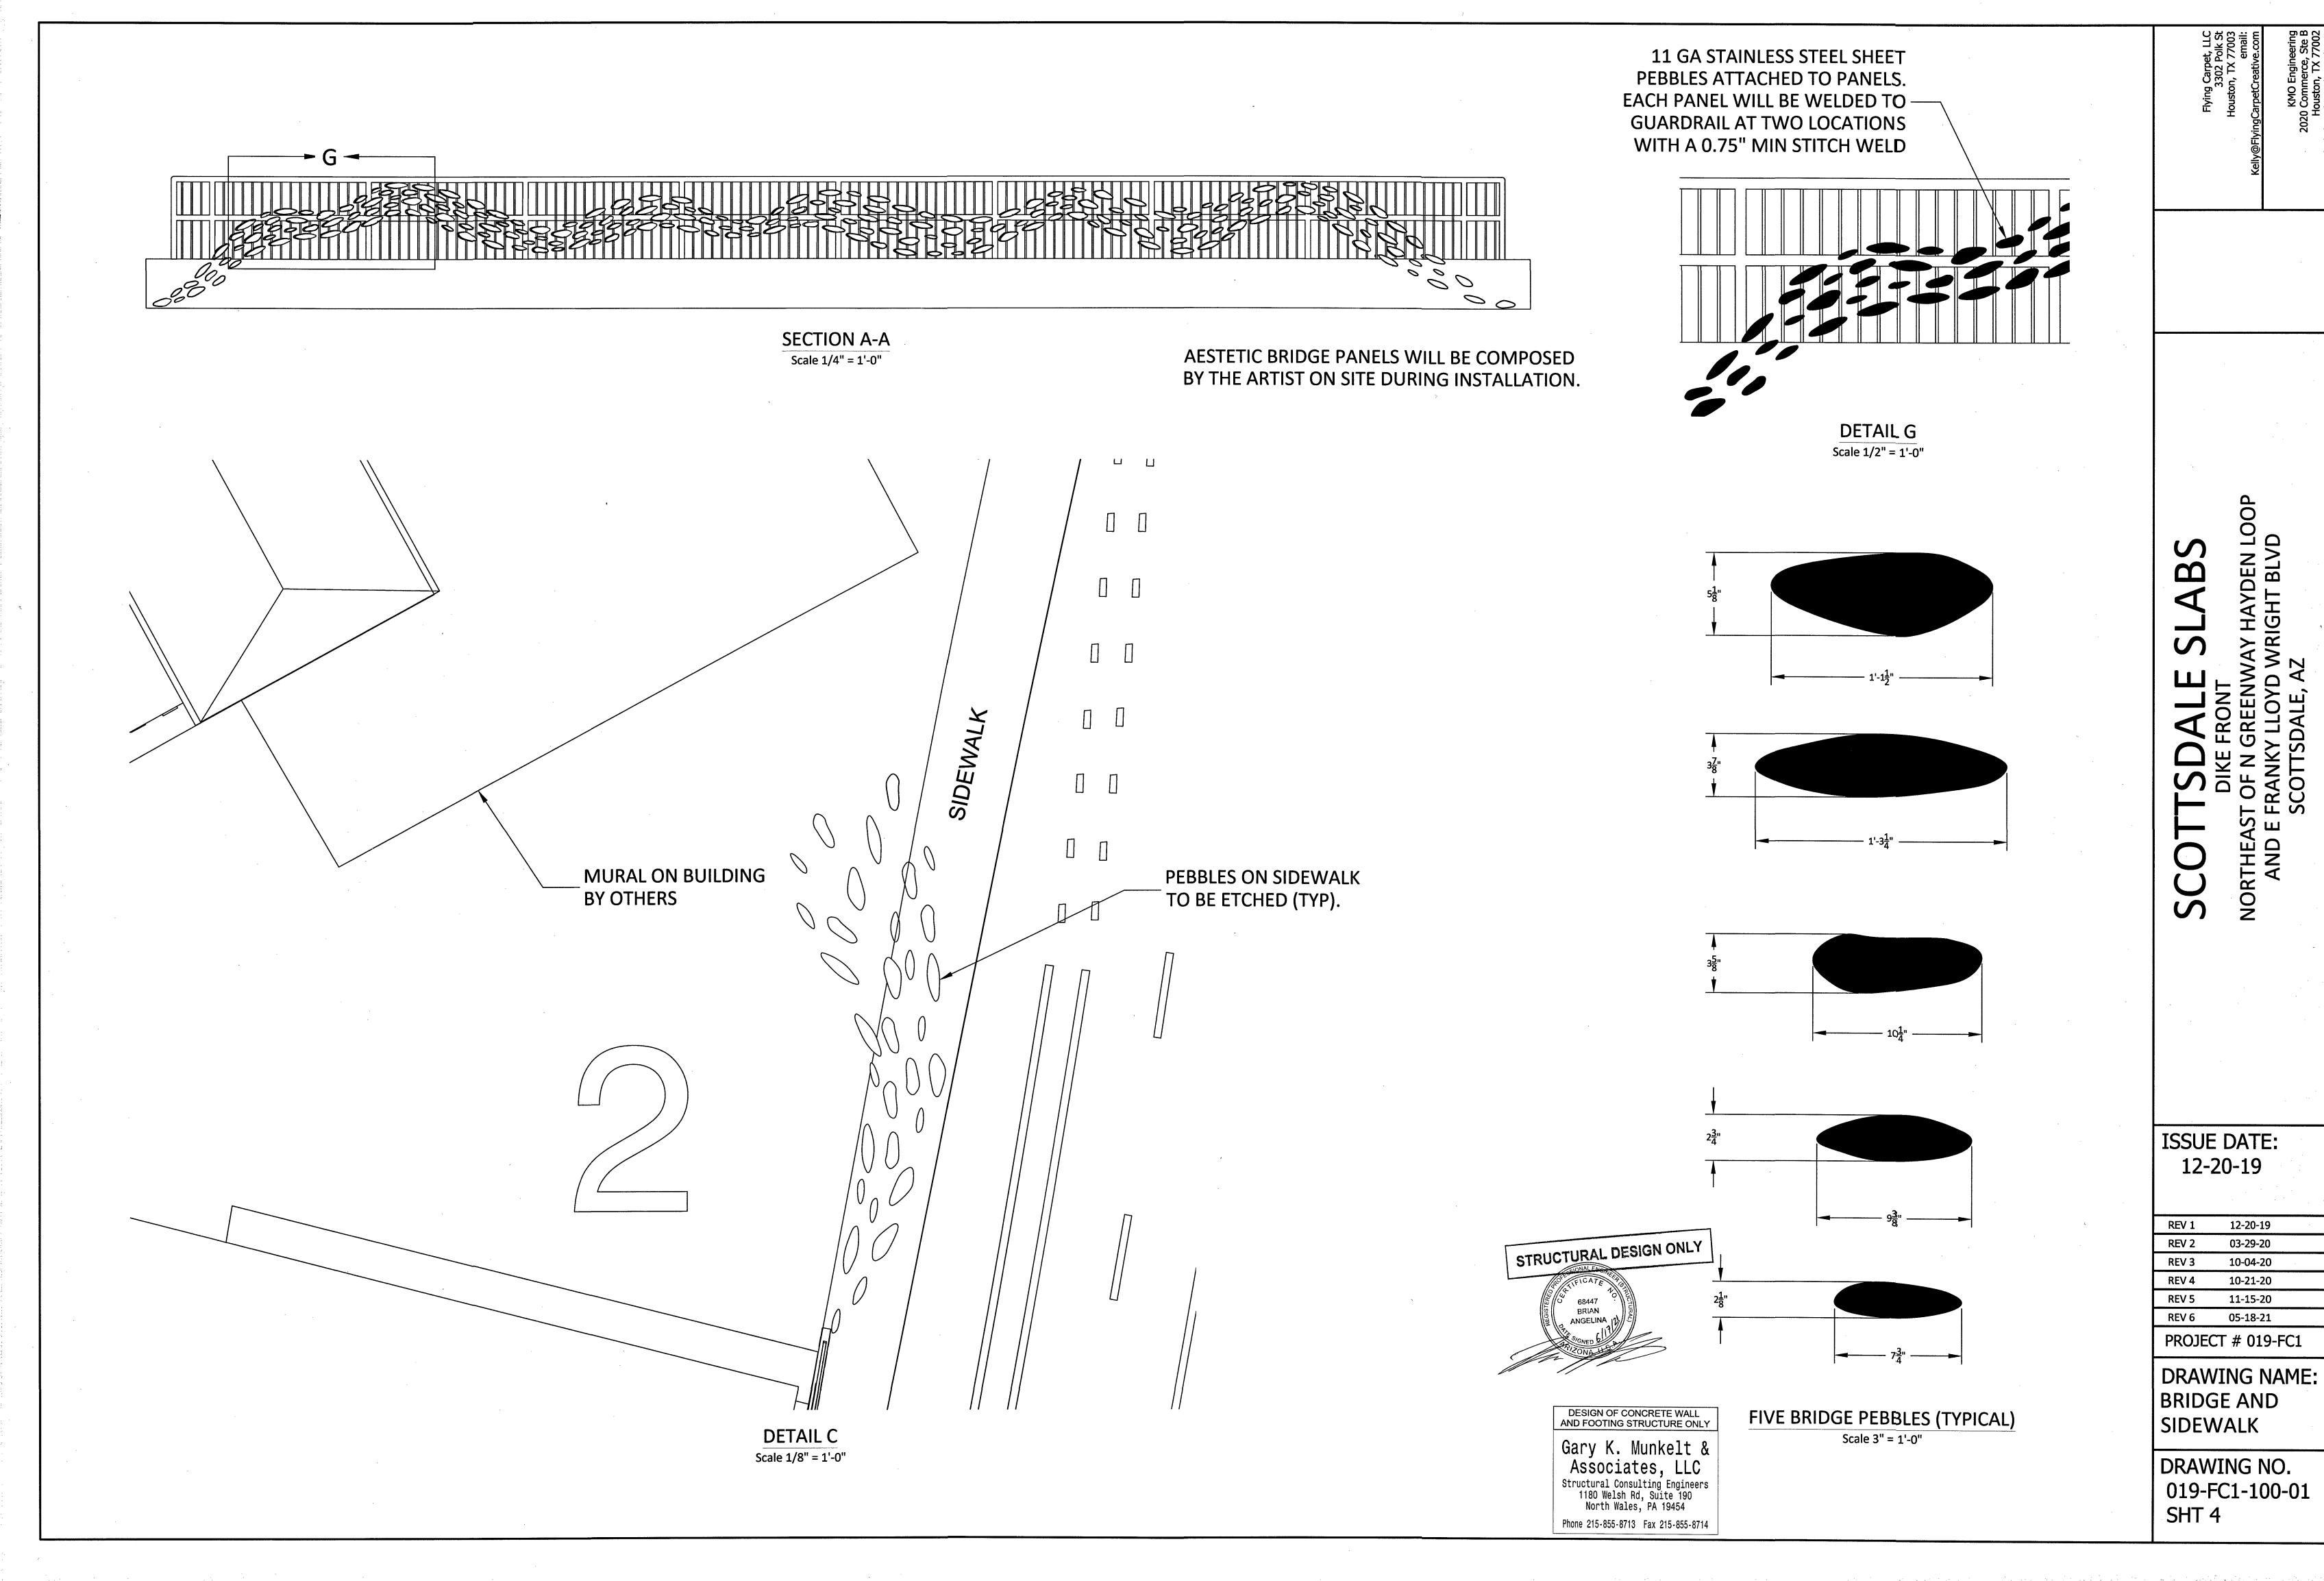

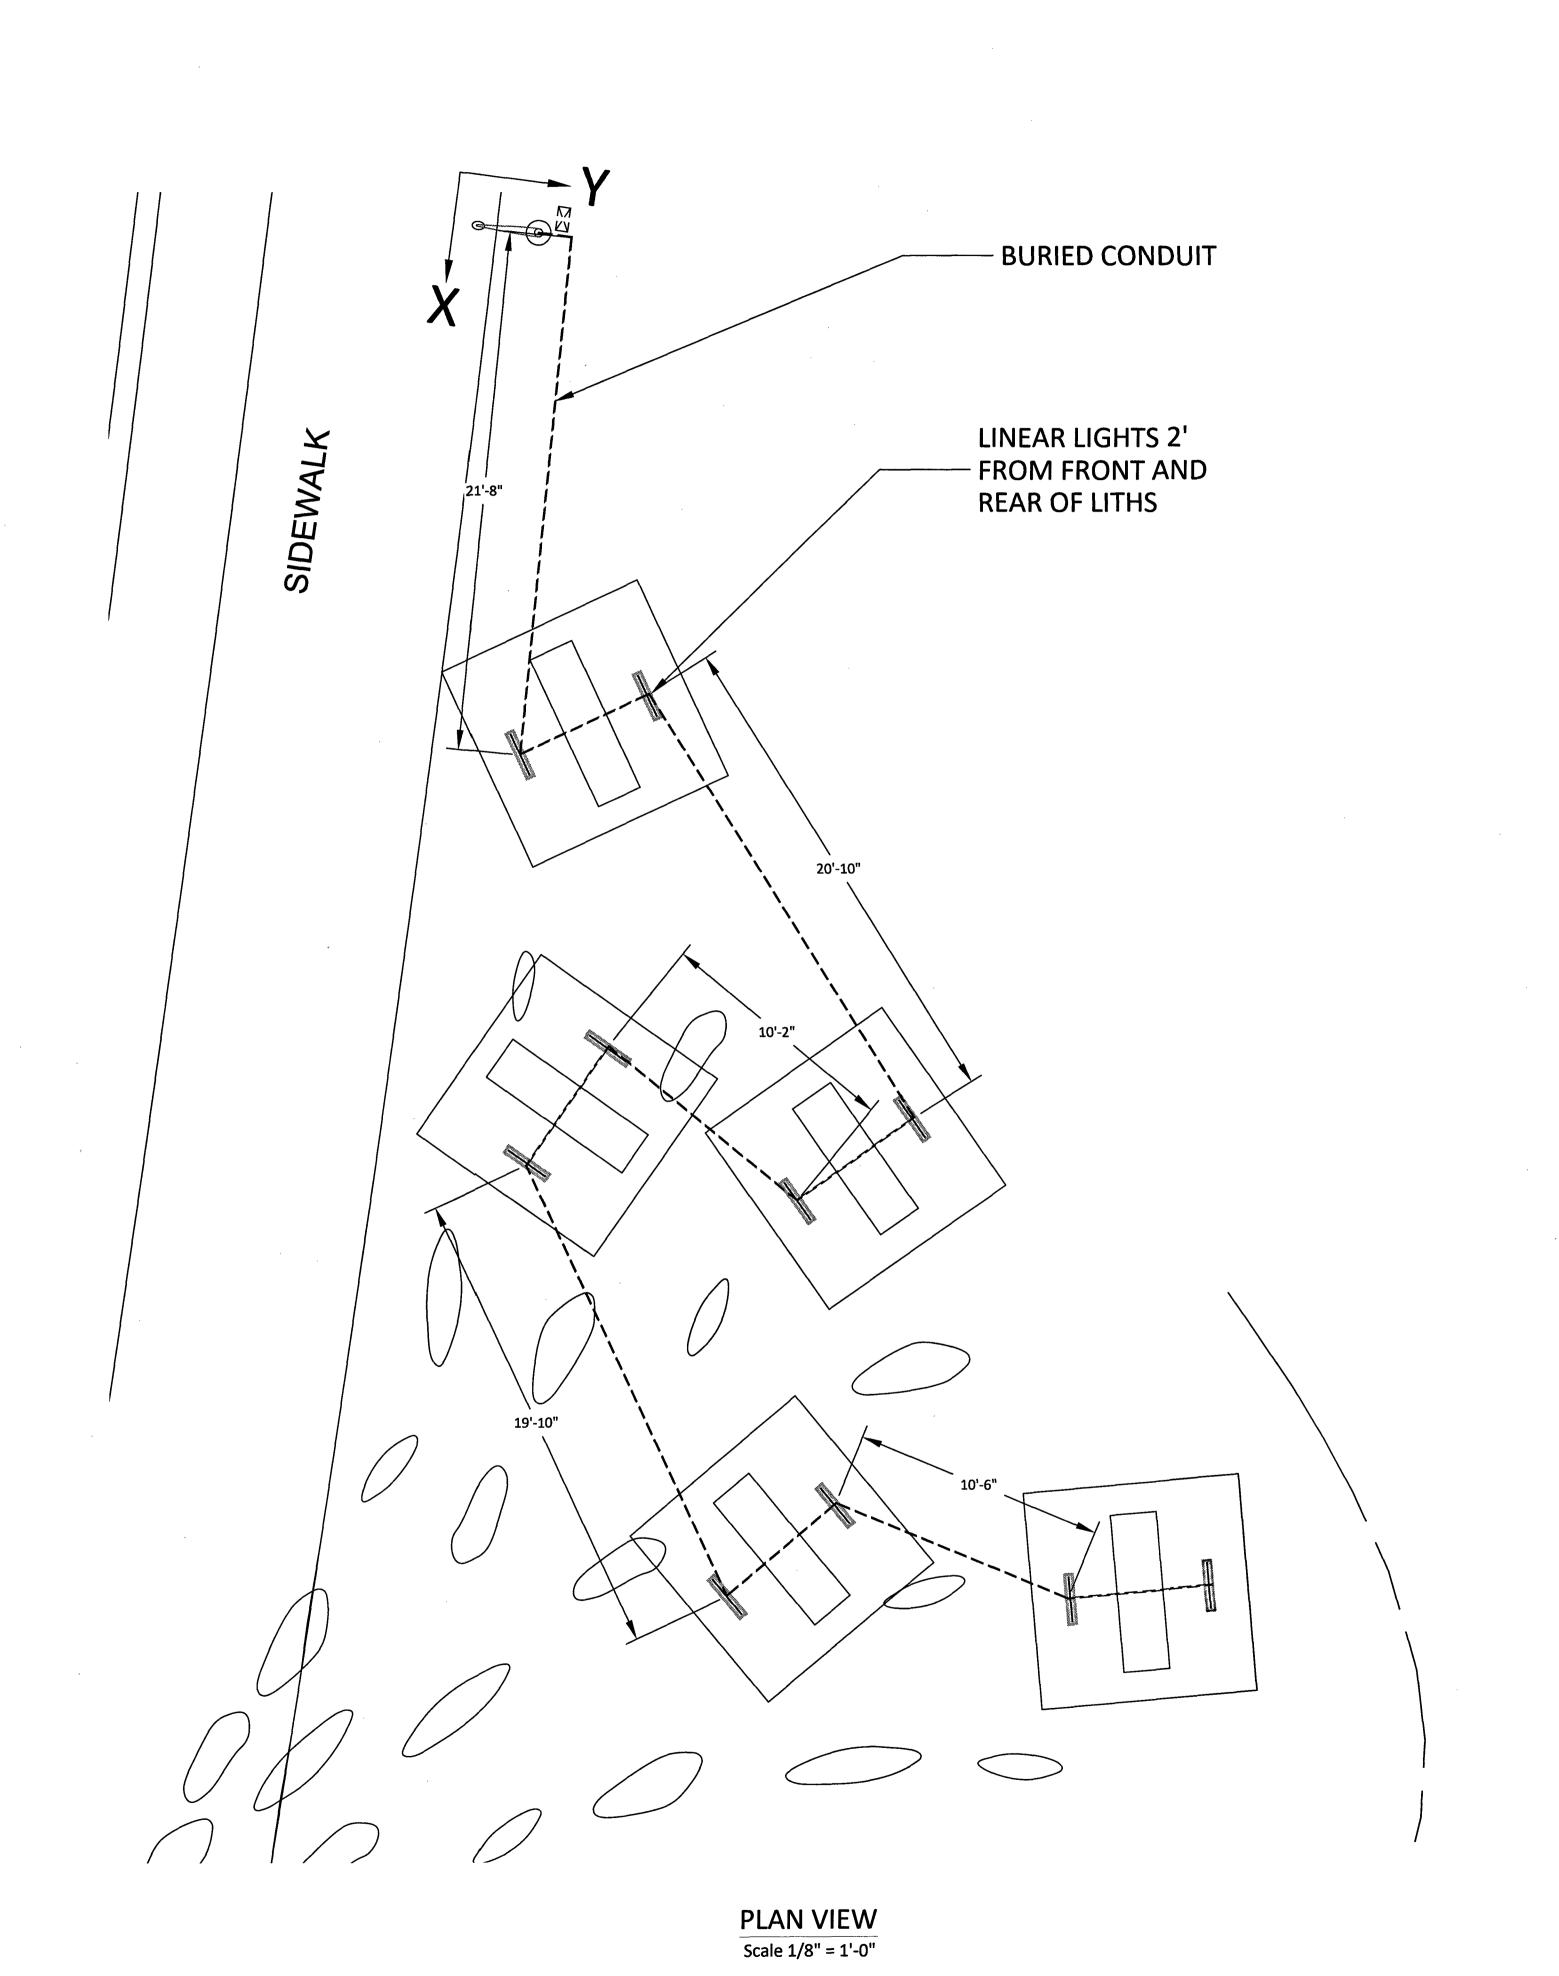


PERFORMANCE: 1200 LM (20W)
POWER INPUT: 120V - 277V

PROTECTION: IP67 - RATED

**EXTERIOR WET LOCATIONS** 

FCD7000 LINEAR
FLOOD LIGHT
Scale 3" = 1'-0"

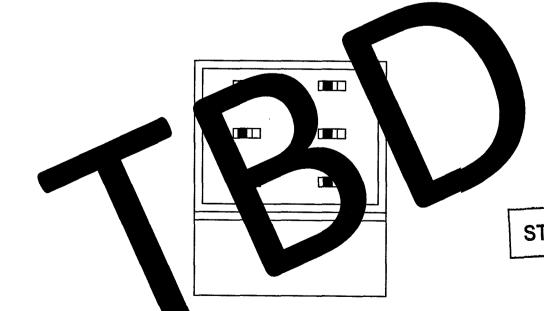

CONTROL PANEL
Scale 1/4" = 1'-0"

STRUCTURAL DESIGN ONLY

68447

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DESIGN OF CONCRETE WALL AND FOOTING STRUCTURE ONLY

Gary K. Munkelt &

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Associates, LLC
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Phone 215-855-8713 Fax 215-855-8714

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ISSUE DATE: 12-20-19

REV 1	12-20-19
REV 2	03-29-20
REV 3	10-04-20
REV 4	10-21-20
REV 5	11-15-20
REV 6	05-18-21
PROJEC	T # 019-FC1

DRAWING NAME: ELECTRICAL AND LIGHTING DETAILS

DRAWING NO. 019-FC1-100-01 SHT 6

	M
ORIGIN AT EDGE OF SIDEWALK INFRONT OF LIGHTPOLE	
Y 1'-9"	
NOTE	: EL
FOOT BOTT	ING
SIDEWA	
60'	
$\frac{2}{3}$	
SPREAD FOOTING	
— MONOLITH	
DETAIL B  Scale 1/4" = 1'-0"	

MONOLITH POSITIONS					
MONOLITH	LEFT FRONT X POS	LEFT FRONT Y POS	RIGHT FRONT X POS	RIGHT FRONT Y POS	
1	17'-7"	3'-10"	23'-4"	7'-6"	
2	35'	4'-4"	38'-2"	10'-6"	
3	34'-8"	17'-2"	39'-4"	21'-7"	
4	51'-4"	16'-2"	55'-9"	21'	
5	49'-7"	32'-7"	56'	34'-1"	

NOTE: ELEVATION OF TOP OF ANY FOOTING SHALL NOT BE LOWER THAN BOTTOM OF ANY ADJACENT FOOTING.

SCOTTSDALE SLABS

DIKE FRONT

NORTHFAST OF N GREENWAY HAVDEN LOCK

NORTHFAST OF N GREENWAY HAVEN LOCK

NORTHFAST OF N GREENWAY HAVEN

ISSUE DATE: 12-20-19

REV 1 12-20-19

REV 2 03-29-20

REV 3 10-04-20

REV 4 10-21-20

REV 5 11-15-20

REV 6 05-18-21

PROJECT # 019-FC1

MONOLITH

POSITIONS


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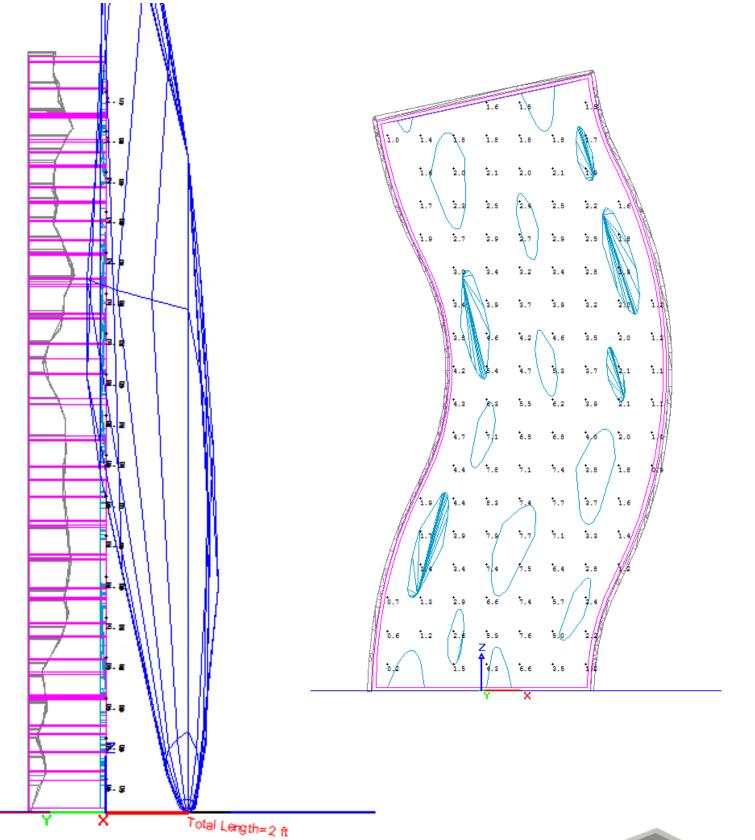
DESIGN OF CONCRETE WALL AND FOOTING STRUCTURE ONLY

STRUCTURAL DESIGN ONLY

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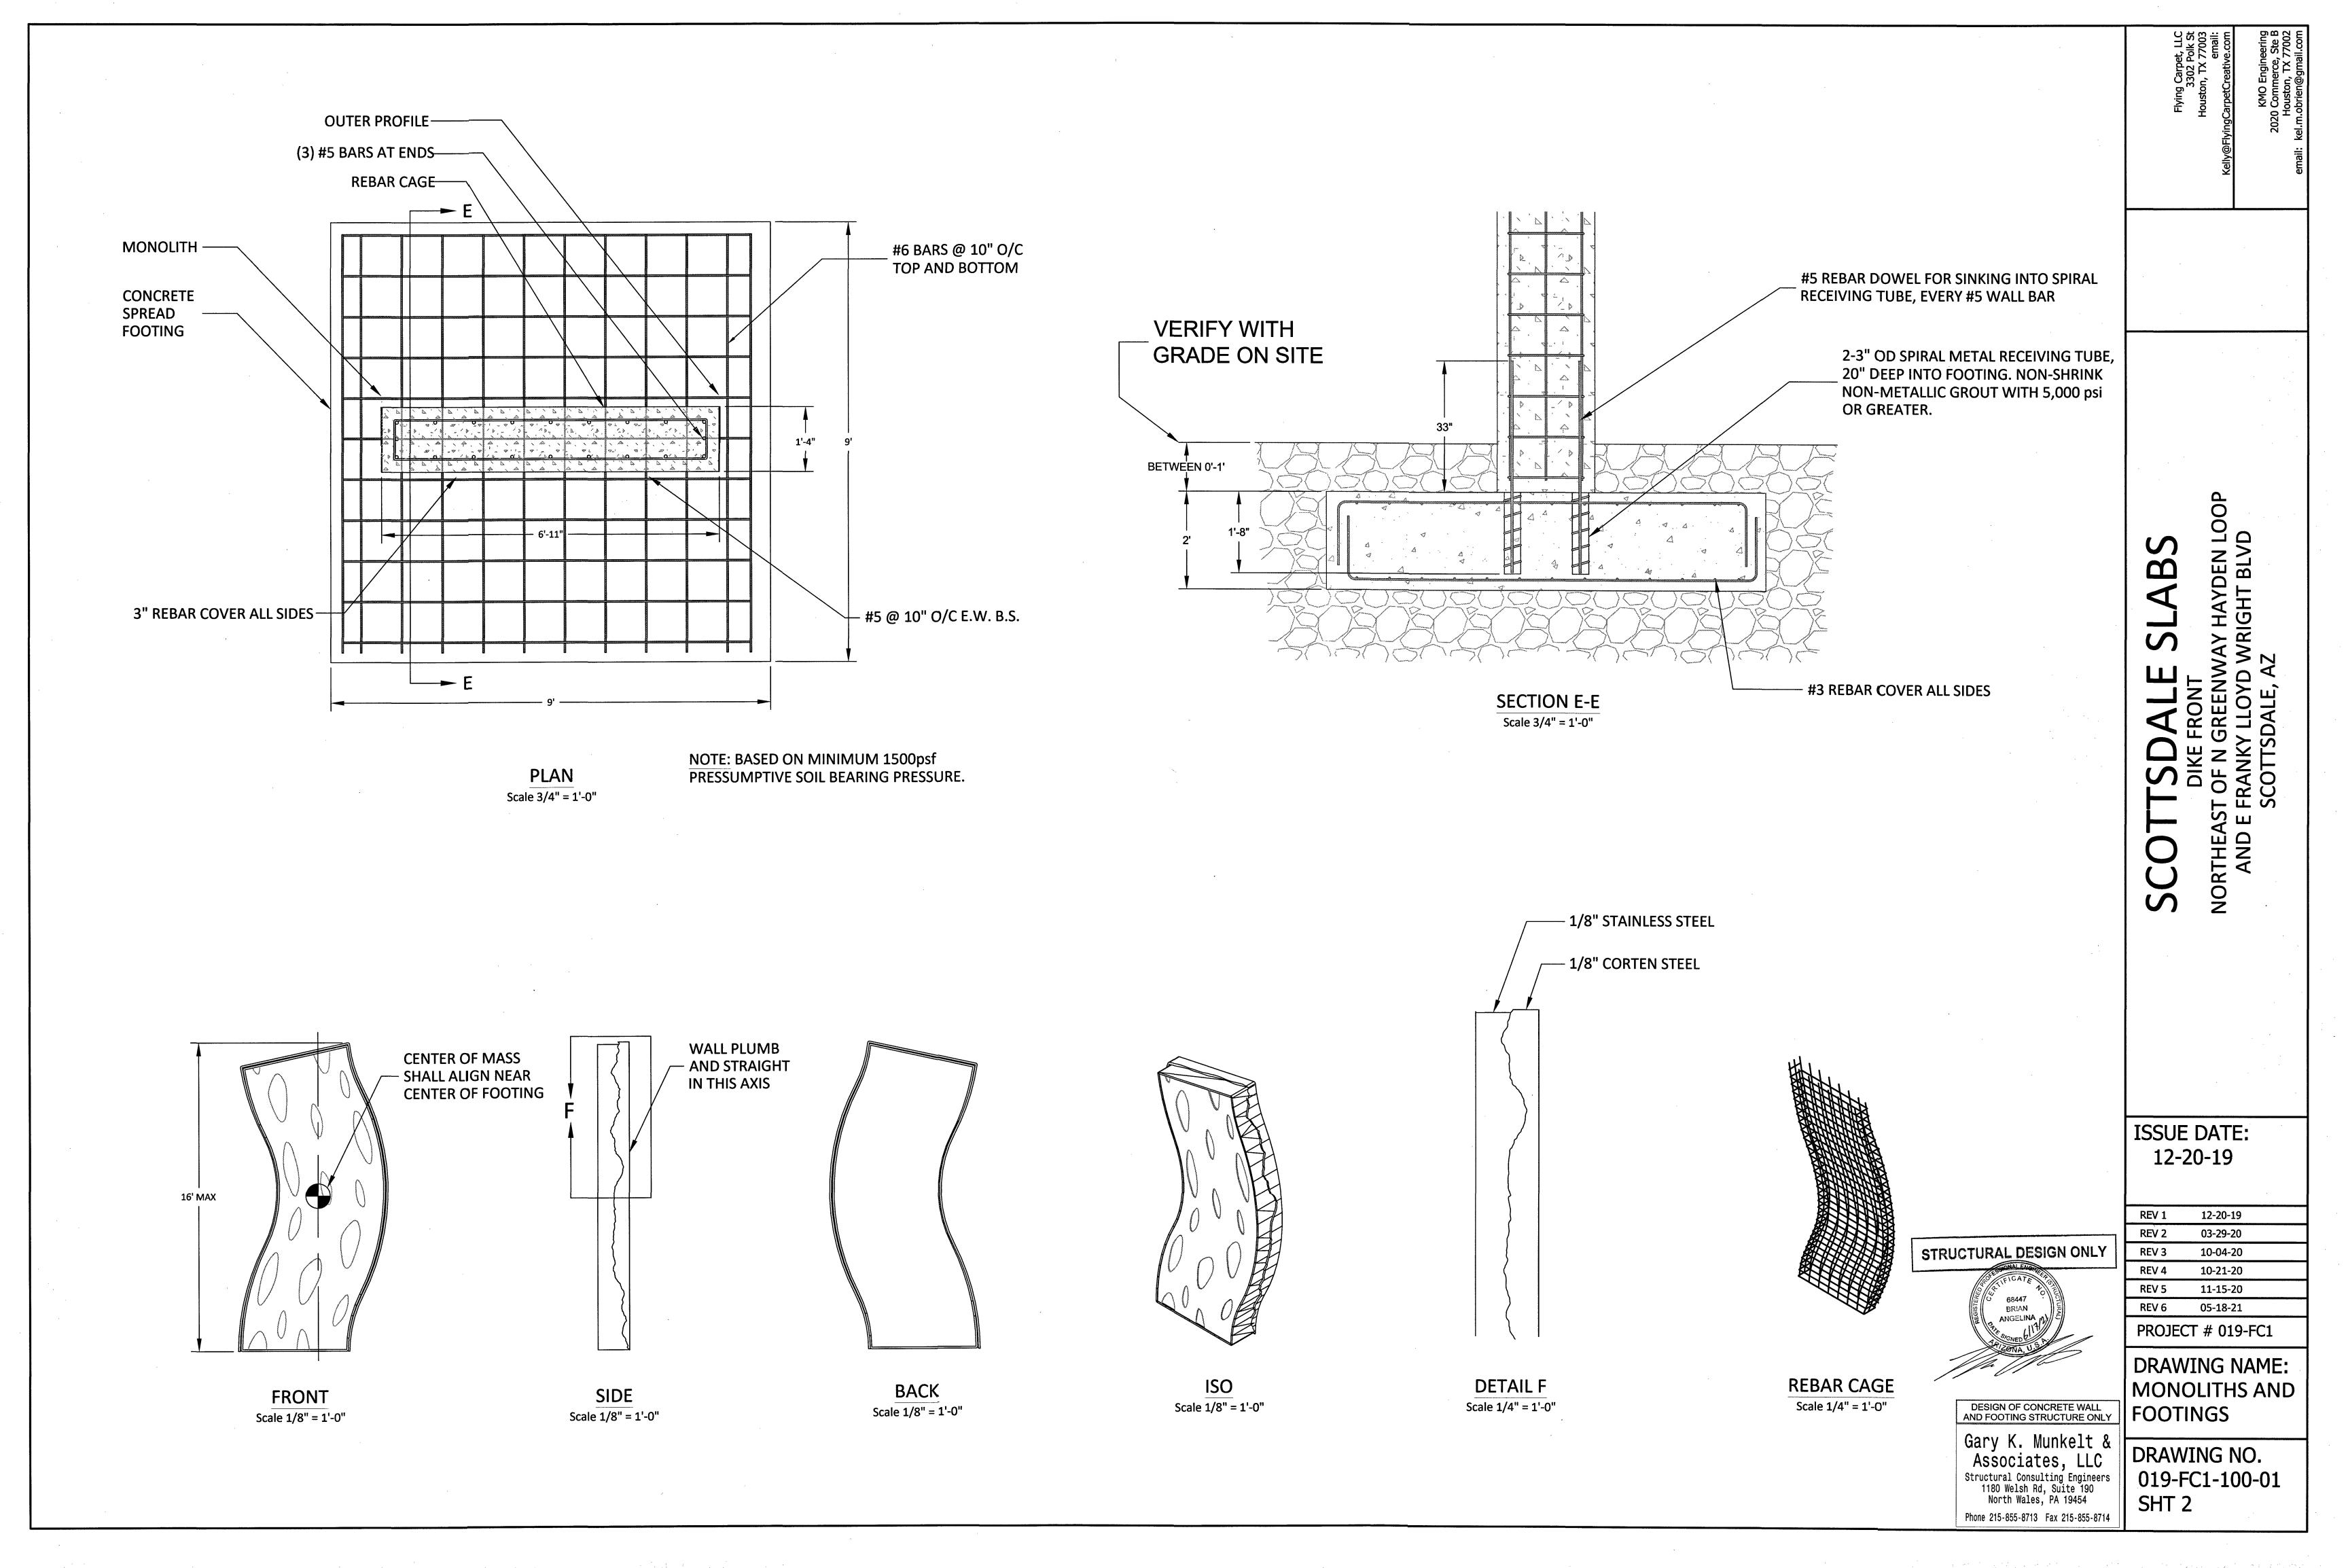
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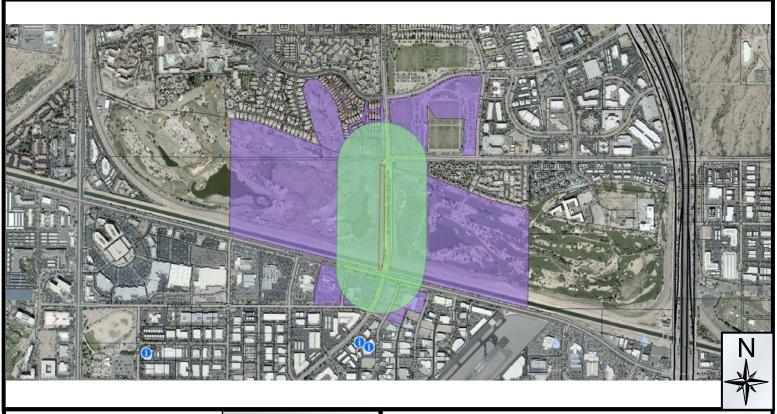


https://www.fclighting.com/wp-content/uploads/2016/03/FCD7000.pdf



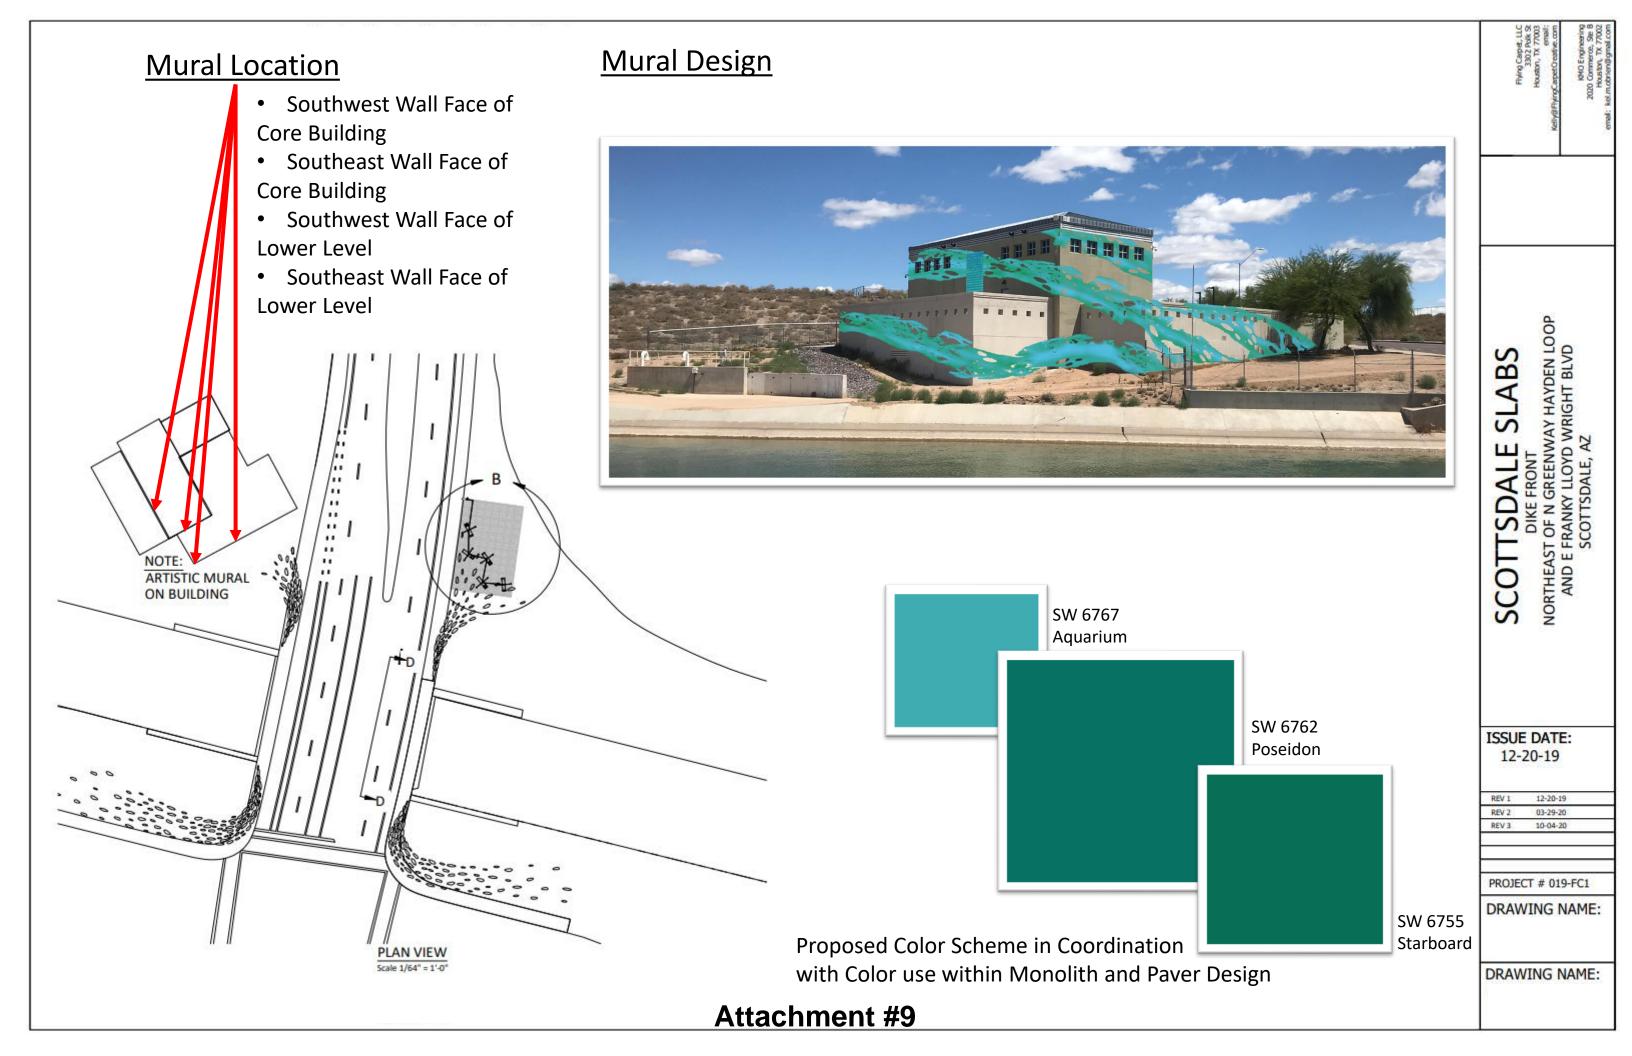

## City Notifications – Mailing List Selection Map Shoeman Lane




#### **Additional Notifications:**

Interested Parties List
Adjacent HOA's
P&Z E-Newsletter
Facebook
Nextdoor.com
City Website-Projects in the hearing process

Pulled Labels February 8, 2021

### Map Legend:

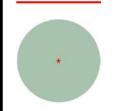

Site Boundary

Properties within 750-feet

Postcards:

72

2-DR-2021