

DEMOLITION NOTES

- A. THE EXISTING CONDITIONS SHOWN WERE TAKEN FROM AVAILABLE RECORD INFORMATION. FIELD VERIFY ALL CONDITIONS THAT MAY AFFECT CONSTRUCTION. IF ANY DISCREPANCIES ARE DISCOVERED, NOTIFY THE ENGINEER IN WRITING AND REQUEST DIRECTION PRIOR TO COMMENCING WORK.
- B. EXISTING LIGHT FIXTURES SHALL BE CAREFULLY REMOVED (DO NOT DAMAGE) AND RETURNED TO THE OWNER.
- C. ANY AND ALL EQUIPMENT HAVING ELECTRICAL CONNECTIONS THAT REQUIRE DISCONNECTING AND/OR RE-CONNECTING AS A RESULT OF CONSTRUCTION SHALL BE INCLUDED AS A PART OF THIS CONTRACT.
- D. THE EXISTING ELECTRICAL DEVICES, CONDUIT, AND/OR EQUIPMENT THAT FOR ANY REASON OBSTRUCTS CONSTRUCTION SHALL BE RELOCATED UNLESS OTHERWISE NOTED. LOCATION IS TO BE AS CLOSE AS POSSIBLE TO THE ORIGINAL LOCATION.
- E. ALL CIRCUITS, CONDUIT AND WIRE THAT ARE NOT TO REMAIN IN SERVICE SHALL BE REMOVED BACK TO THE FIRST ACCESSIBLE JUNCTION BOX WHERE IT SHALL BE TIED OFF AND LABELED AS SPARE WITH CIRCUIT NUMBER INDICATED.
- F. REMOVE ALL ABANDONED WIRE AND CABLING.

GENERAL NOTES

- 1. SYMBOLS LEGENDS ARE PROVIDED FOR REFERENCE PURPOSES ONLY. THE SYMBOLS REPRESENT THE TYPE OF DEVICES THAT MAY BE REQUIRED IN THE WORK; QUANTITIES AND LOCATIONS ARE AS SHOWN ON THE PLAN SHEETS.
- 2. PROVIDE 3/4" CONDUIT & #12 CONDUCTORS UNLESS NOTED OTHERWISE. PROVIDE ONE NEUTRAL CONDUCTOR FOR EACH UNGROUNDED CONDUCTOR OF SINGLE PHASE LINE-NEUTRAL BRANCH CIRCUITS. DO NOT SHARE NEUTRAL CONDUCTORS.
- 3. EACH FEEDER AND BRANCH CIRCUIT CONDUIT SHALL HAVE AN EQUIPMENT GROUNDING CONDUCTOR SIZED IN ACCORDANCE WITH NFPA 70, ARTICLE 250.
- 4. ALL ELECTRICAL EQUIPMENT IN PORTIONS OF THE BUILDING NOT BEING REMODELED SHALL BE LEFT IN WORKING CONDITION. RESTORE ANY CIRCUITS INTERRUPTED.
- 5. ALL NEW LIGHT FIXTURES AND FIXTURES IN AREAS ADJACENT DEMOLITION & CONSTRUCTION AREAS ARE TO BE THOROUGHLY CLEANED IMMEDIATELY PRIOR TO NOTICE OF SUBSTANTIAL COMPLETION.
- 6. THE FOLLOWING IS PART OF THIS PROJECT AND ALL COSTS PERTAINING THERETO SHALL BE INCLUDED IN THE BASE BID:
 - A. NEW ELECTRICAL EQUIPMENT AND APPARATUS SHALL BE COORDINATED AND CONNECTED INTO THE EXISTING SYSTEM AS REQUIRED.
 - B. POWER WIRING AND CABLE INSTALLATIONS SHALL BE CONCEALED ABOVE ACCESSIBLE CEILINGS AND IN WALLS. EXPOSED WIRING SHALL BE INSTALLED IN APPROVED SURFACE METAL RACEWAY WHERE INDICATED.
 - C. WHERE EXISTING CONDUITS ARE INDICATED FOR REUSE, FIELD VERIFY INTEGRITY OF REUSED RACEWAYS PRIOR TO INSTALLATION OF CONDUCTORS. PROVIDE NEW RACEWAYS WHERE EXISTING ARE UNUSABLE.
 - D. LOCATIONS OF ALL WALL MOUNTED DEVICES SUCH AS SWITCHES, RECEPTACLES, AND OUTLETS ARE SHOWN DIAGRAMMATICALLY. DETERMINE EXACT DEVICE LOCATIONS IN FIELD, COORDINATE INSTALLATIONS WITH FIXED CASEWORK, DOORS AND RELITES.
 - E. PROVIDE PENETRATIONS THROUGH WALLS, FLOORS, AND CEILINGS AS REQUIRED. PROVIDE SUITABLE FIRE RATED MATERIALS AND SEAL ALL CEILING, FLOOR, AND WALL PENETRATIONS TO MATCH FIRE RATING OF SURFACES PENETRATED.

LIGHTING AND RECEPTACLE NOTES

- 1. LIGHTING SYSTEMS SHALL BE PROVIDED WITH CONTROLS AS ZONED ON THE LIGHTING PLANS. SWITCHING AND DIMMING ZONES ARE INDICATED ADJACENT TO EACH FIXTURE.
- 2. MANUAL CONTROLS SHALL ALLOW OCCUPANTS TO UNIFORMLY REDUCE ILLUMINATION LEVELS AT LEAST 50%. EXCEPTION: CORRIDORS, RESTROOMS, LOBBIES, MECHANICAL, ELECTRICAL, AND INFORMATION TECHNOLOGY (IDF) ROOMS CONTROLLED BY OCCUPANCY SENSORS.
- 3. EACH AREA THAT IS REQUIRED TO HAVE A MANUAL CONTROL SHALL ALSO HAVE AUTOMATIC TIME SWITCH CONTROL. PROVIDE TIMED OVERRIDE SWITCHES THAT WILL SERVE A MAXIMUM AREA OF 2500 SF IN LOCATIONS SHOWN ON PLANS. EXCEPTIONS:
 - A. EMERGENCY EGRESS LIGHTING CONTROLLED BY OCCUPANCY SENSORS.
 - B. LIGHTING IN SPACES CONTROLLED BY OCCUPANCY SENSORS.
- 4. LUMINAIRES PROVIDING MEANS OF EGRESS ILLUMINATION AND HAVING BOTH NORMAL AND EMERGENCY POWER SOURCES SHALL BE CONTROLLED BY A COMBINATION OF U.L. 924 LISTED EMERGENCY RELAYS AND OCCUPANCY SENSORS THAT ENABLES THE LIGHTING TO BE SHUT OFF WHEN THE AREAS SERVED ARE UNOCCUPIED AND AUTOMATICALLY ILLUMINATES IN THE EVENT OF NORMAL POWER SOURCE FAILURE.
- 5. THE MAXIMUM LIGHTING POWER THAT MAY BE CONTROLLED FROM A SINGLE SWITCH OR AUTOMATIC CONTROL SHALL NOT EXCEED THAT WHICH IS PROVIDED BY A 20 AMPERE CIRCUIT LOADED TO NOT MORE THAN 80 PERCENT.
- 6. PROVIDE FUNCTIONAL TESTING OF AUTOMATIC LIGHTING CONTROLS. SUBMIT WRITTEN PROCEDURES FOR FUNCTIONAL TESTING OF ALL AUTOMATIC CONTROLS WITH DESCRIPTION OF THE EXPECTED SYSTEM RESPONSE.

STRUCTURED CABLE SYSTEM PATHWAY NOTES

- 1. SYSTEM CABLING PATHWAYS SHALL BE INSTALLED IN ACCORDANCE WITH THE MOST CURRENT VERSION OF TIA-569.
- 2. CABLE SUPPORTS SHALL NOT BE PLACED MORE THAN 5' APART.
- 3. CABLE "SAG" BETWEEN SUPPORTS SHALL NOT EXCEED 12".
- 4. CABLE LENGTHS SHALL NOT EXCEED 295', INCLUDING PATCH CORD LENGTHS AT COMM ROOMS AND WORKSTATIONS. IF A CABLE LENGTH WILL EXCEED 295', INFORM THE ICT ENGINEER IMMEDIATELY BEFORE INSTALLATION.
- 5. CABLE MINIMUM BEND RADIUS AND MAXIMUM PULLING TENSION SHALL NOT BE EXCEED. REFER TO MANUFACTURER'S REQUIREMENTS AND REFERENCE DOCUMENTS.
- 6. CABLES SHALL BE INSTALLED IN CONTINUOUS LENGTHS FROM ORIGIN TO DESTINATION (NO SPLICES).
- 7. CABLES SHALL BE INSTALLED ABOVE FIRE-SPRINKLER SYSTEMS AND SUPPORTED INDEPENDENTLY OF SPRINKLER PIPING OR ANY ANCILLARY EQUIPMENT OR HARDWARE. THE CABLE SYSTEM AND SUPPORT HARDWARE SHALL BE INSTALLED SO THAT IT DOES NOT OBSCURE ANY VALVES, FIRE ALARM CONDUIT, BOXES, OR OTHER CONTROLLED DEVICES.
- 8. CABLES SHALL NOT BE ATTACHED TO CEILING GRID OR LIGHTING FIXTURE WIRES.
- 9. AT NO POINT SHALL CABLES REST ON ACOUSTIC CEILING GRIDS OR PANELS, OR BE ATTACHED TO ANY PORTION OF THE BUILDING MECHANICAL OR PIPING SYSTEMS. PROVIDE COMPLETE CABLE SUPPORT PATHWAYS CONSISTING OF CONDUIT, RACEWAY, LADDER RACK, CABLE TRAY, J-HOOKS OR BRIDAL RINGS.
- 10. ANY CABLE DAMAGED DURING INSTALLATION OR EXCEEDING RECOMMENDED INSTALLATION PARAMETERS SHALL BE REPLACED PRIOR TO FINAL ACCEPTANCE AT NO ADDITIONAL COST TO THE OWNER.
- 11. CABLES AND PATHWAYS SHALL BE CLEARLY LABELED IN ACCORDANCE WITH TIA-606-C.
- 12. PROVIDE "VELCRO" TYPE (HOOK AND LOOP) TIE WRAPS FOR BUNDLING / MANAGING HORIZONTAL AND BACKBONE CABLING. PLACE EVERY 5' FOR CABLE RUNS IN CEILING AND EVERY 18" AFTER ENTERING TELECOMMUNICATIONS ROOM. PLASTIC "ZIP-TIES" SHALL NOT BE PERMITTED WITHIN THE STRUCTURED CABLING SYSTEM.
- 13. HORIZONTAL UTP PAIR TWIST AT THE TERMINATION SHALL NOT EXCEED 0.5".
- 14. PROVIDE (1) 2" CONDUIT SLEEVE WITH INSULATED BUSHINGS FOR PENETRATION INTO OFFICES, EXAM ROOMS, ETC, AS REQUIRED TO FACILITATE CABLE ROUTING WHETHER SHOWN ON DRAWINGS OR NOT.
- 15. ALL PENETRATIONS MUST BE FIRE-STOPPED IN ACCORDANCE OF THE NFPA, NEC AND TO THE SATISFACTION OF THE AHI.
- 16. ALL TELECOMMUNICATION ROOMS AND PATHWAYS SHALL ADHERE TO TIA-569-D.
- 17. ALL TELECOMMUNICATION BONDING AND GROUNDING SHALL ADHERE TO TIA-607-D.
- 18. NOT ALL PARTS SHOWN. ENSURE A COMPLETE WORKING INSTALLATION INCLUDING MISCELLANEOUS INSTALLATION MATERIALS, CONNECTORS, CONSUMABLES, AND APPURTENANCES.
- 19. PROVIDE NETWORK/TELEPHONY CABLES TO THE FOLLOWING LOCATIONS FROM THE NEAREST COMMUNICATIONS ROOM, UNLESS OTHERWISE NOTED.
 - A. ELEVATOR CONTROL PANELS/ENCLOSURES
 - B. BUILDING SYSTEM MANAGEMENT PANELS/ENCLOSURES
 - C. ENERGY SYSTEM MANAGEMENT PANELS/ENCLOSURES
 - D. FIRE ALARM CONTROL SYSTEM PANELS/ENCLOSURES
 - E. ACCESS CONTROL SYSTEM PANELS/ENCLOSURES
 - F. TWO-WAY EMERGENCY COMMUNICATIONS SYSTEMS PANELS/ENCLOSURES

ABBREVIATIONS

| | | | |
|----------|--|-----------|---|
| @ | AT | MAG | MAGNETIC |
| A/C | AIR CONDITIONING(ER) | MAN | MANUAL |
| A (AMP) | AMPERE | MAT | MATERIAL |
| AC | ABOVE COUNTER, ALTERNATING CURRENT | MAX | MAXIMUM |
| ADJ | ADJUSTABLE | MCA | MINIMUM CIRCUIT AMPACITY |
| ADJT | ADJACENT | MCB | MAIN CIRCUIT BREAKER |
| AFF | ABOVE FINISHED FLOOR | MECH | MECHANICAL |
| AHJ | AUTHORITY HAVING JURISDICTION | MEZZ | MEZZANINE |
| AIC | AMPERE INTERRUPTING CAPACITY | MG | MOTOR GENERATOR |
| ALT | ALTERNATE | MIN | MINIMUM |
| ANN | ANNUNCIATOR | MISC | MISCELLANEOUS |
| ARCH | ARCHITECT; ARCHITECTURAL | MLO | MAIN LUG ONLY |
| ATS | AUTOMATIC TRANSFER SWITCH | MOCB | MAXIMUM OVERCURRENT PROTECTION |
| AUTO | AUTOMATIC | MS | MAGNETIC STARTER |
| AUX | AUXILIARY | MTD | MOUNTED |
| AWG | AMERICAN WIRE GAUGE | MTG | MOUNTING |
| | | MTR | MOTOR |
| BKBD | BACKBOARD | N | NORTH; NEUTRAL |
| BKR | BREAKER | N/A | NOT APPLICABLE |
| BLDG | BUILDING | NC | NORMALLY CLOSED |
| | | NEG | NATIONAL ELECTRICAL CODE |
| C | CONDUIT | NEMA | NATIONAL ELECTRICAL MANUFACTURERS ASSOCIATION |
| CAP | CAPACITY | NESC | NATIONAL ELECTRICAL SAFETY CODE |
| CB | CIRCUIT BREAKER | NEUT | NEUTRAL |
| CKT | CIRCUIT | NFPA | NATIONAL FIRE PROTECTION ASSOC. |
| CLG | CEILING | NIC | NOT IN CONTRACT |
| CLR | CLEAR | NO | NORMALLY OPEN |
| COL | COLUMN | NTS | NOT TO SCALE |
| COM | COMMUNICATION | | |
| CPS | CYCLES PER SECOND | OC | ON CENTER |
| CT | CURRENT TRANSFORMER | OFCI | OWNER FURNISHED CONTRACTOR |
| CTL | CONTROL | INSTALLED | INSTALLED |
| CU | COPPER | OFOI | OWNER FURNISHED OWNER INSTALLED |
| DC | DIRECT CURRENT | OL | OVERLOAD |
| DISC SW | DISCONNECT SWITCH | OS | OPTIONAL STANDBY |
| DISC | DISCONNECT | | |
| DN | DOWN | P | PRIMARY |
| DWG | DRAWING | PA | PUBLIC ADDRESS |
| | | PAR | PARALLEL |
| E | EXIST, EAST | PB | PULL BOX |
| EDH | ELECTRIC DUCT HEATER | PE | PHOTO ELECTRIC |
| EF | EXHAUST FAN | PF | POWER FACTOR |
| EGC | EQUIPMENT GROUNDING CONDUCTOR | PH | PHASE |
| EL | ELEVATION | PIV | POST INDICATOR VALVE |
| ELEC | ELECTRIC(AL) | PNL | PANEL |
| ELEV | ELEVATOR | POC | POINT OF CONNECTION |
| EM | EMERGENCY | PWR | POWER |
| EMT | ELECTRICAL METALLIC TUBING | | |
| ENCL | ENCLOSURE | QTY | QUANTITY |
| ENTR | ENTRANCE | | |
| EP | EXPLOSION PROOF | R (R) | RELOCATE (D) |
| EPO | EMERGENCY POWER OFF | RAD | RADIUS |
| EQUIPEOP | EQUIPMENT | RECPT | RECEPTACLE |
| EW | ELECTRIC WATER COOLER | REF | REFRIGERATOR |
| EWH | ELECTRIC WATER HEATER | RLA | RATED LOAD AMPS |
| EXH | EXHAUST | RPM | REVOLUTIONS PER MINUTE |
| EXT | EXTERIOR | | |
| EXIST | EXISTING | S | SOUTH |
| | | SC | SECURITY |
| F | FAHRENHEIT/FUSE | SD | SMOKE DETECTOR |
| FA | FIRE ALARM | SECT | SECTION |
| FAA | FIRE ALARM ANNUNCIATOR | SF | SUPPLY FAN |
| FAP | FIRE ALARM PANEL | SHT | SHEET |
| FC | FOOTCANDLE | SPEC | SPECIFICATION |
| FCU | FAN COIL UNIT | SPL | SPECIAL |
| FD | FIRE DAMPER | SQ | SQUARE |
| FDR | FEEDER | STOR | STORAGE |
| FIXT | FIXTURE | SPD | SURGE PROTECTION DEVICE |
| FLA | FULL LOAD AMPS | SW | SWITCH |
| FSD | FIRE/SMOKE DAMPER | SWBD | SWITCHBOARD |
| | | SYM | SYMMETRICAL |
| GEC | GROUNDING ELECTRODE CONDUCTOR | SYS | SYSTEM |
| GEN | GENERATOR | | |
| GFI | GROUND FAULT CIRCUIT INTERRUPTER | T | THERMOSTAT |
| GFR | GROUND FAULT RELAY | TB | TERMINAL BOX |
| | | TC | TIME CLOCK |
| H | HEIGHT | TEL | TELEPHONE |
| HOA | HAND OFF AUTOMATIC | TV | TELEVISION |
| HOR | HORIZONTAL | TYP | TYPICAL |
| HP | HORSEPOWER | | |
| HR | HOUR | UFC | UNIFORM FIRE CODE |
| HT | HEIGHT | UG | UNDERGROUND |
| HW | HOT WATER | UH | UNIT HEATER |
| HZ | HERTZ | UL | UNDERWRITERS LABORATORIES |
| | | UON | UNLESS OTHERWISE NOTED |
| | | UV | UNIT VENTILATOR |
| IBC | INTERNATIONAL BUILDING CODE | | |
| IC | INTERCOM | V | VOLT |
| IES | ILLUMINATING ENGINEERING SOCIETY | VAV | VARIABLE AIR VOLUME |
| IEEE | INSTITUTE OF ELECTRICAL AND ELECTRONIC ENGINEERS | VEL | VELOCITY |
| IG | ISOLATED GROUND | VM | VOLTMETER |
| IMC | INTERMEDIATE METAL CONDUIT | VOL | VOLUME |
| IN | INCH | | |
| | | W | WATT, WEST |
| JB | JUNCTION BOX | W | WITH |
| | | WO | WITHOUT |
| KCMIL | THOUSAND CIRCULAR MILLS | WH | WATER HEATER |
| KVA | KILOVOLT AMPERES | WHM | WATT HOUR METER |
| KVAR | KILOVOLT AMPERES REACTIVE | WP | WEATHERPROOF |
| KW | KILOWATT | | |
| KWH | KILOWATT HOUR | X | REACTANCE |
| | | XFMR | TRANSFORMER |
| LBS | POUNDS | XMTR | TRANSMITTER |
| LF | LINEAR FEET (FEET) | | |
| LRA | LOCKED ROTOR AMPS | Z | IMPEDANCE |
| LS | LIFE SAFETY | | |
| LT | LIGHT | & | AND |
| LTG | LIGHTING | IE: | THAT IS |
| LV | LOW VOLTAGE | | |

| ELECTRICAL SHEET INDEX SITE | |
|-----------------------------|--|
| E0.03 | PHOTOMETRIC PLAN |
| E0.00 | GENERAL NOTES, ABBREVIATIONS AND SHEET INDEX |
| E0.02 | ELECTRICAL - SITE PLAN |
| E2.00 | LIGHTING SCHEDULE AND CUT-SHEETS |

WESTERN TECHNOLOGIES WAREHOUSE

1395 N Hayden Rd
Scottsdale, AZ 85257

Registration:



Project No: 1398
Date: 4/22/2022
Drawn By: JWN
Reviewed By: Checker

| No. | Revision | Date |
|-----|---------------|------------|
| 1 | City Comments | 04/22/2022 |

SÄZÄN
GROUP

311 E. Veterans Way, Ste. 102
Tempe, AZ 85281

Tel 480.530.9101
Fax 480.530.9130

SAZAN# 882-22002

Sheet Title:
GENERAL NOTES, ABBREVIATIONS AND SHEET INDEX



JAMMON STUDIOS
Architecture | Interiors | Development Management
7486 E Osborn Rd #3, Scottsdale, AZ 85251
Jammon@JammonStudios.com
602.888.5552

| SYMBOLS LEGEND - GENERAL | |
|--------------------------|--|
| SYMBOL | DESCRIPTION |
| | DRAWING CONSTRUCTION ("FLAG") NOTE |
| | EQUIPMENT IDENTIFIER |
| | MATCHLINE |
| | REVISION CLOUD (ENCIRCLES DRAWING CHANGES MADE SINCE THE PREVIOUS RELEASE) |
| | REVISION REFERENCE |
| | EXISTING TO BE REMOVED (HATCH) |
| | HEAVY LINEWEIGHT INDICATES NEW WORK |
| | LIGHT LINEWEIGHT INDICATES EXISTING INFORMATION |
| | POINT OF CONNECTION |
| | DETAIL REFERENCE DETAIL IDENTIFICATION NUMBER SHEET WHERE DETAIL IS DRAWN |
| | ELEVATION REFERENCE ELEVATION IDENTIFICATION NUMBER SHEET WHERE ELEVATION IS DRAWN |
| | SECTION REFERENCE SECTION IDENTIFICATION NUMBER SHEET WHERE SECTION IS DRAWN |
| | NORTH REFERENCE |

| SYMBOLS LEGEND - POWER | |
|------------------------|--|
| SYMBOL | DESCRIPTION |
| | TRANSFORMER |
| | POLE-MOUNTED TRANSFORMER |
| | POLE |
| | DELTA |
| | WYE |
| | MEDIUM VOLTAGE CABLE TERMINATOR |
| | LIGHTNING ARRESTORS |
| | SURGE ARRESTORS |
| | NEUTRAL GROUNDING RESISTOR |
| | METER |
| | MICROPROCESSOR CONTROLLED MONITOR REFER TO SPECIFICATIONS FOR METERING VALUES AND PROTECTIVE FUNCTIONS |
| | CURRENT TRANSFORMER |
| | POTENTIAL TRANSFORMER |
| | INDICATING INSTRUMENT AM-AMMETER, VM-VOLTMETER, FM-FREQUENCY METER, KVAR-KILOVAR METER, KWH-KILOWATT HOUR METER, KWH-KILOWATT HOUR DEMAND METER |
| | INSTRUMENT SWITCH AS-AMMETER SWITCH, VS-VOLTMETER SWITCH, SS-SYNCHRONIZING SWITCH, SV-SUPERVISORY (LOCAL-REMOTE) SWITCH |
| | SEPARABLE CONNECTOR |
| | DRAWOUT AC TYPE POWER CIRCUIT BREAKER |

| SYMBOLS LEGEND - POWER | |
|------------------------|--|
| SYMBOL | DESCRIPTION |
| | CIRCUIT BREAKER ST - INDICATES SHUNT TRIP |
| | ENCLOSED CIRCUIT BREAKER (PLAN VIEW) xxxAXP - AMPS/POLES |
| | ENCLOSED CIRCUIT BREAKER (ONE-LINE DIAGRAM) xxxAXP - AMPS/POLES |
| | BREAKER WITH EXTERNAL GROUND FAULT RELAY AND CT |
| | CIRCUIT BREAKER WITH INTEGRAL GROUND FAULT PROTECTION |
| | MOTOR-OPERATED CIRCUIT BREAKER |
| | SWITCH WITH EXTERNAL GROUND FAULT RELAY AND CT |
| | MOV SURGE PROTECTION |
| | RESISTOR |
| | MOTOR THERMAL OVERLOADS - (3) UNLESS OTHERWISE NOTED |
| | NORMALLY OPEN CONTACT |
| | NORMALLY CLOSED CONTACT |
| | SOLENOID VALVE |
| | MOTOR-OPERATED VALVE |
| | THERMOSTAT |
| | TERMINAL BLOCK |
| | INDICATING LIGHT - TYPE AS NOTED A-AMBER, B-BLUE, G-GREEN, R-RED, W-WHITE |
| | BATTERY |

| SYMBOLS LEGEND - POWER | |
|------------------------|---|
| SYMBOL | DESCRIPTION |
| | 2-POSITION SELECTOR SWITCH |
| | 3-POSITION SELECTOR SWITCH HAND-OFF-AUTOMATIC |
| | ON-OFF SELECTOR SWITCH |
| | 2-CIRCUIT PUSHBUTTON |
| | PUSHBUTTON SWITCH MOMENTARY CONTACT |
| | EQUIPMENT CONNECTION |
| | GENERATOR |
| | MOTOR CONNECTION |
| | SMOKE DAMPER |
| | FIRE SMOKE DAMPER |
| | STARTER 3-POLE, NEMA SIZE 1 MINIMUM UNLESS NOTED OTHERWISE COMBINATION STARTER HP RATED, 3-POLE, NEMA SIZE 1 MINIMUM, UNLESS NOTED OTHERWISE - OVERCURRENT PROTECTION AS REQUIRED BY EQUIPMENT MANUFACTURER OR AS NOTED |
| | DISCONNECT SWITCH 3-POLE UNLESS NOTED OTHERWISE |
| | FUSED DISCONNECT SWITCH 3-POLE UNLESS NOTED OTHERWISE |
| | CONTACTOR |
| | RELAY COIL CR-CONTROL RELAY, TD-TIME DELAY RELAY, UV-UNDERVOLTAGE RELAY, MM-MOTOR CONTACTOR |
| | MOTOR-RATED SWITCH - SIZE O/L PER MOTOR REQUIREMENTS |
| | EQUIPMENT EMERGENCY SHUTDOWN SWITCH |

| SYMBOLS LEGEND - SECURITY | |
|---------------------------|--|
| SYMBOL | DESCRIPTION |
| | CARD READER (KP = KEYPAD) (WP = WEATHERPROOF) |
| | DOOR/WINDOW CONTACT |
| | ELECTRIC STRIKE |
| | REQUEST TO EXIT PUSHBUTTON |
| | REQUEST TO EXIT SENSOR |
| | CCTV CAMERA - CEILING MOUNTED (WP = WEATHERPROOF) (° = ANGLE OF CAMERA VIEW (IE. 180°, 270°, 360°; PTZ)) |
| | CCTV CAMERA - WALL MOUNTED (WP = WEATHERPROOF) (° = ANGLE OF CAMERA VIEW (IE. 180°, 270°, 360°; PTZ)) |
| | PANIC / DURESS BUTTON |
| | INTERCOM OUTLET (D = DESK MOUNTED) (W = WALL MOUNTED @ +48" AFF) |
| | KEYPAD - ALARM PANEL |
| | MOTION DETECTOR - INFRARED TYPE UNLESS OTHERWISE NOTED |
| | BREAK GLASS SENSOR |
| | ALARM BELL |

| SYMBOLS LEGEND - GENERAL | |
|--------------------------|--|
| SYMBOL | DESCRIPTION |
| | CONDUIT CONCEALED IN CEILING SPACE OR IN WALL. PROVIDE MINIMUM 3/4" WITH #12 AWG CONDUCTORS AND DEDICATED NEUTRAL EACH CIRCUIT UNLESS OTHERWISE NOTED ON PLAN. PROVIDE EQUIPMENT GROUNDING CONDUCTORS SIZED PER NFPA 70. |
| | FLEXIBLE METAL CONDUIT |
| | CONDUIT - CONCEALED IN OR UNDER FLOOR |
| | CONDUIT - ROUTED UNDERGROUND |
| | LOW-VOLTAGE WIRING (CLASS B) |
| | CONDUIT OR CABLE VERTICAL DOWN |
| | CONDUIT OR CABLE VERTICAL UP |
| | CONDUIT STUB - TERMINATE WITH BUSHING OR CAP IF UNDERGROUND |
| | BREAK LINE |
| | CONDUIT SEAL |
| | EXPANSION FITTING |
| | CABLE TRAY |
| | BRANCH CIRCUIT NUMBERS |
| | PANEL DESIGNATION |
| | HOME RUN TO SOURCE OF SUPPLY |
| | CONDUCTORS - CONNECTED |
| | CONDUCTORS - NOT CONNECTED |
| | JUNCTION BOX |
| | PULLBOX - SIZE AS INDICATED OR AS REQUIRED BY CODE |
| | HANDHOLE |
| | MANHOLE |


| SYMBOLS LEGEND - POWER | |
|------------------------|---|
| SYMBOL | DESCRIPTION |
| | 480Y/277V, 3Ø, 4W PANELBOARD |
| | 208Y/120V, 3Ø, 4W PANELBOARD |
| | EQUIPMENT CABINET - TYPE AS NOTED |
| | PANELBOARD |
| | TRANSFER SWITCH (AUTO) |
| | AMPERES SHORT CIRCUIT AVAILABLE (SYMMETRICAL) |
| | FEEDER TAG - REFER TO FEEDER SCHEDULE |

| SYMBOLS LEGEND - GROUNDING | |
|----------------------------|-------------------|
| SYMBOL | DESCRIPTION |
| | GROUND CONNECTION |
| | GROUND ROD |
| | GROUND WELL |
| | AIR TERMINAL |

| SYMBOLS LEGEND - WIRING DEVICES | |
|---------------------------------|---|
| SYMBOL | DESCRIPTION |
| | SINGLE-POLE WALL SWITCH MOUNT SWITCHES AT 48" AFF. TO TOP, UON. |
| | WALL SWITCH - SUBSCRIPT 2 = 2-POLE LV = LOW-VOLTAGE 3 = 3-WAY OS = OCCUPANCY SENSOR TYPE 4 = 4-WAY OP = OCCUPANCY/PHOTOELECTRIC TYPE K = KEYED WP = WEATHERPROOF LOWER CASE LETTER INDICATES SWITCHING GROUP MOUNT SWITCHES AT 48" AFF. TO TOP, UON. ANY COMBINATION OF SWITCH TYPES CAN BE USED (IE. 3K = 3-WAY KEYED SWITCH) SPECIAL PURPOSE RECEPTACLE TYPE AS SHOWN ON PLANS |
| | SINGLE SERVICE OR COMBINATION FLUSH MOUNTED FLOOR BOX. REFER TO FLOOR PLANS FOR DEVICES. |
| | SINGLE SERVICE OR COMBINATION FLUSH FLOOR POKE THRU. REFER TO FLOOR PLANS FOR DEVICES. |
| | POWER/COMM POLE - FLOOR TO CEILING. |
| | SURFACE MOUNTED FLOOR BOX (PEDESTAL TYPE), PUSH BUTTON |
| | SIMPLEX RECEPTACLE NEMA 5-20R, +18" AFF UON |
| | NEMA 5-20R, +18" AFF UON |
| | TAMPER RESISTANT, NEMA 5-20R, +18" AFF UON |
| | SWITCHED RECEPTACLE, NEMA 5-20R, +18" AFF UON |
| | ISOLATED GROUND, NEMA 5-20R, +18" AFF UON |
| | NEMA 5-20R W/ GROUND FAULT CIRCUIT INTERRUPTER, +18" AFF UON |
| | SPLIT WIRED, NEMA 5-20R, +18" AFF UON |
| | CONTROLLED, NEMA 5-20R, +18" AFF UON |
| | NEMA 5-20R, ABOVE COUNTER. COORDINATE WITH CASEWORK SHOP DRAWINGS AND ARCHITECTURAL DRAWINGS. |
| | NEMA 5-20R WITH GROUND FAULT CIRCUIT INTERRUPTER, ABOVE COUNTER. COORDINATE WITH CASEWORK SHOP DRAWINGS AND ARCHITECTURAL DRAWINGS. |
| | TAMPER RESISTANT, NEMA 5-20R WITH GROUND FAULT CIRCUIT INTERRUPTER, ABOVE COUNTER. COORDINATE WITH CASEWORK SHOP DRAWINGS AND ARCHITECTURAL DRAWINGS. |
| | NEMA 5-20R, CONNECTED TO EMERGENCY CIRCUIT, +18" AFF UON |
| | NEMA 5-20R ON EMERGENCY CIRCUIT MOUNTED ABOVE COUNTER. COORDINATE WITH CASEWORK SHOP DRAWINGS AND ARCHITECTURAL DRAWINGS. |
| | CEILING-MOUNTED, NEMA 5-20R |
| | NEMA 5-20R WITH USB CHARGER - (2) TYPE A USB PORTS |
| | TAMPER RESISTANT, NEMA 5-20R WITH USB CHARGER - (2) TYPE A USB PORTS |

| SYMBOLS LEGEND - LIGHTING | |
|---------------------------|---|
| SYMBOL | DESCRIPTION |
| | LIGHT FIXTURE IDENTIFIER - REFER TO LUMINAIRE SCHEDULE A-1 Z-XXX-1 EM |
| | SHADING INDICATES LUMINAIRE ON EMERGENCY CIRCUIT OR WITH BATTERY BACKUP |
| | 2x4 LUMINAIRE |
| | 1x4 LUMINAIRE |
| | 2x2 LUMINAIRE |
| | LINEAR LUMINAIRE |
| | WALL WASH LUMINAIRE |
| | WALL MOUNTED LUMINAIRE |
| | UNDER-CABINET LUMINAIRE |
| | STRIP LUMINAIRE |
| | DOWNLIGHT |
| | WALL WASH DOWNLIGHT LUMINAIRE |
| | WALL MOUNTED LUMINAIRE |
| | WALL MOUNTED DIRECTIONAL LUMINAIRE |
| | PENDANT MOUNTED LUMINAIRE |
| | TRACK LIGHT - LENGTH AS INDICATED ON PLANS NUMBER OF LUMINAIRES AS SHOWN |
| | POLE-MOUNTED LUMINAIRE - NUMBER OF LUMINAIRES AS SHOWN ON PLANS |
| | STREET LIGHT |
| | IN-GROUND LANDSCAPE LUMINAIRE |
| | ILLUMINATED EXIT SIGN - SINGLE FACE ARROW INDICATES DIRECTION OF EGRESS, UNIVERSAL MOUNT |
| | ILLUMINATED EXIT SIGN - DOUBLE FACE ARROW INDICATES DIRECTION OF EGRESS, UNIVERSAL MOUNT |
| | BATTERY-POWERED EMERGENCY WALLPACK |
| | COMBINATION BATTERY POWERED EMERGENCY WALLPACK AND ILLUMINATED EXIT SIGN |
| | TIME CLOCK - TYPE AS NOTED |
| | LIGHTING CONTROL SYSTEM POWER PACK |
| | SWITCH BYPASS DEVICE |
| | ILLUMINATION CONTROL STATION |
| | OCCUPANCY SENSOR CEILING MOUNTED WITH POWER PACK - DUAL TECHNOLOGY TYPE UNLESS NOTED: U = ULTRASONIC P = PASSIVE INFRARED |
| | OCCUPANCY SENSOR WALL MOUNTED |
| | PHOTOELECTRIC CONTROL CEILING MOUNTED |
| | PHOTOELECTRIC CONTROL WALL MOUNTED |

| SYMBOLS LEGEND - FIRE ALARM | |
|-----------------------------|---|
| SYMBOL | DESCRIPTION |
| | FIRE ALARM SYSTEM CONTROL PANEL ESR - ELEVATOR STATUS/RECALL FAC - FIRE ALARM COMMUNICATOR FACP - FIRE ALARM CONTROL PANEL FAA OR FARA - FIRE ALARM ANNUNCIATOR HVA - HVAC OR EXHAUST STAIRWELL PRESSURIZATION LCD - FIRE ALARM LCD ANNUNCIATOR |
| | FIRE ALARM FLOW SWITCH |
| | HI/LO AIR PRESSURE SWITCH |
| | VALVE SUPERVISORY SWITCH |
| | POST INDICATOR VALVE SUPERVISORY SWITCH |
| | FIRE ALARM PULL STATION |
| | FIRE/SMOKE DAMPER |
| | SMOKE DAMPER |
| | FIRE ALARM HORN ONLY |
| | FIRE ALARM HORN STROBE, XX = CANDELA RATING |
| | FIRE ALARM SPEAKER ONLY |
| | FIRE ALARM SPEAKER STROBE, XX = CANDELA RATING |
| | FIRE ALARM STROBE ONLY - WALL, XX = CANDELA RATING |
| | FIRE ALARM STROBE ONLY - CEILING, XX = CANDELA RATING |
| | FIRE ALARM BELL |
| | FIRE FIGHTER PHONE JACK |
| | HEAT DETECTOR, RATE OF RISE AND FIXED TEMPERATURE UON F - FIXED TEMPERATURE R - RATE OF RISE ONLY R/C - RATE COMPENSATION |
| | SMOKE DETECTOR, PHOTOELECTRIC UON BT - BEAM TRANSMITTER BR - BEAM RECEIVER I - IONIZATION |
| | FIRE ALARM DUCT SMOKE DETECTOR WITH SAMPLING TUBE |
| | FLAME DETECTOR |
| | GAS DETECTOR |
| | ADDRESSABLE INPUT MODULE |
| | ADDRESSABLE OUTPUT MODULE |
| | ISOLATION MODULE |
| | FIRE ALARM EQUIPMENT CONNECTION |
| | RELAY BLOCK |

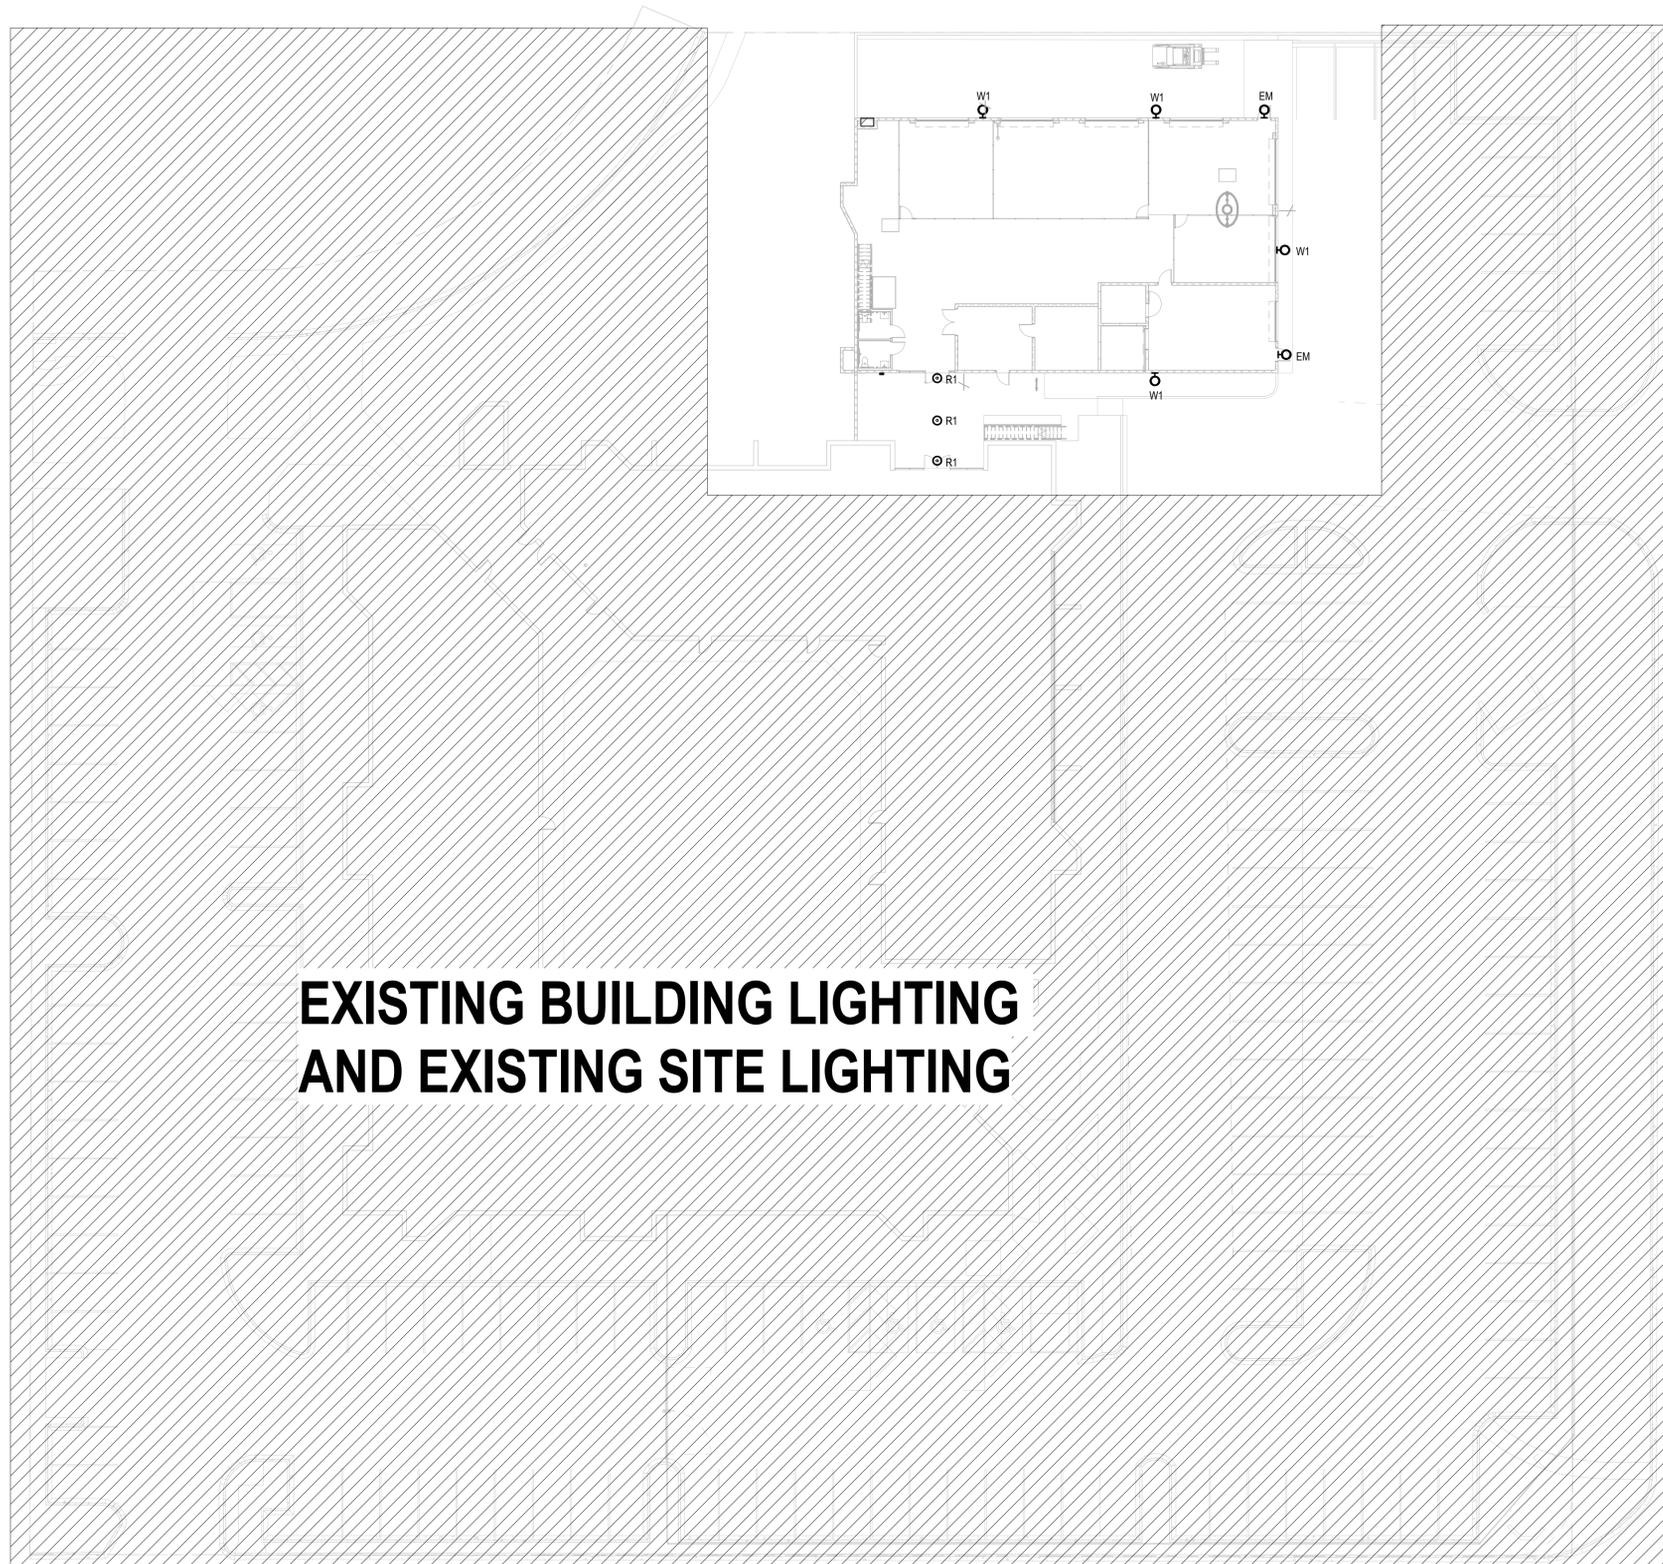

**EXISTING BUILDING LIGHTING
AND EXISTING SITE LIGHTING**

ELECTRICAL - SITE PLAN
1" = 20'-0"

SÄZÄN
GROUP
311 E. Veterans Way, Ste. 102
Tempe, AZ 85281
Tel 480.530.9101
Fax 480.530.9130
SAZAN# 882-22002

WESTERN TECHNOLOGIES WAREHOUSE

1395 N Hayden Rd
Scottsdale, AZ 85257

Registration:



Project No: 1395
Date: 4/22/2022
Drawn By: JWN
Reviewed By: Checker

| No. | Revision | Date |
|-----|----------|------|
|-----|----------|------|


| | | |
|---|---------------|------------|
| 1 | City Comments | 04/22/2022 |
|---|---------------|------------|

Sheet Title:
ELECTRICAL - SITE PLAN

Sheet No.:

E0.02

JAMMON STUDIOS
Architecture | Interiors | Development Management
746 E Osborn Rd #3, Scottsdale, AZ 85251
Jammon@JammonStudios.com
602.889.8552

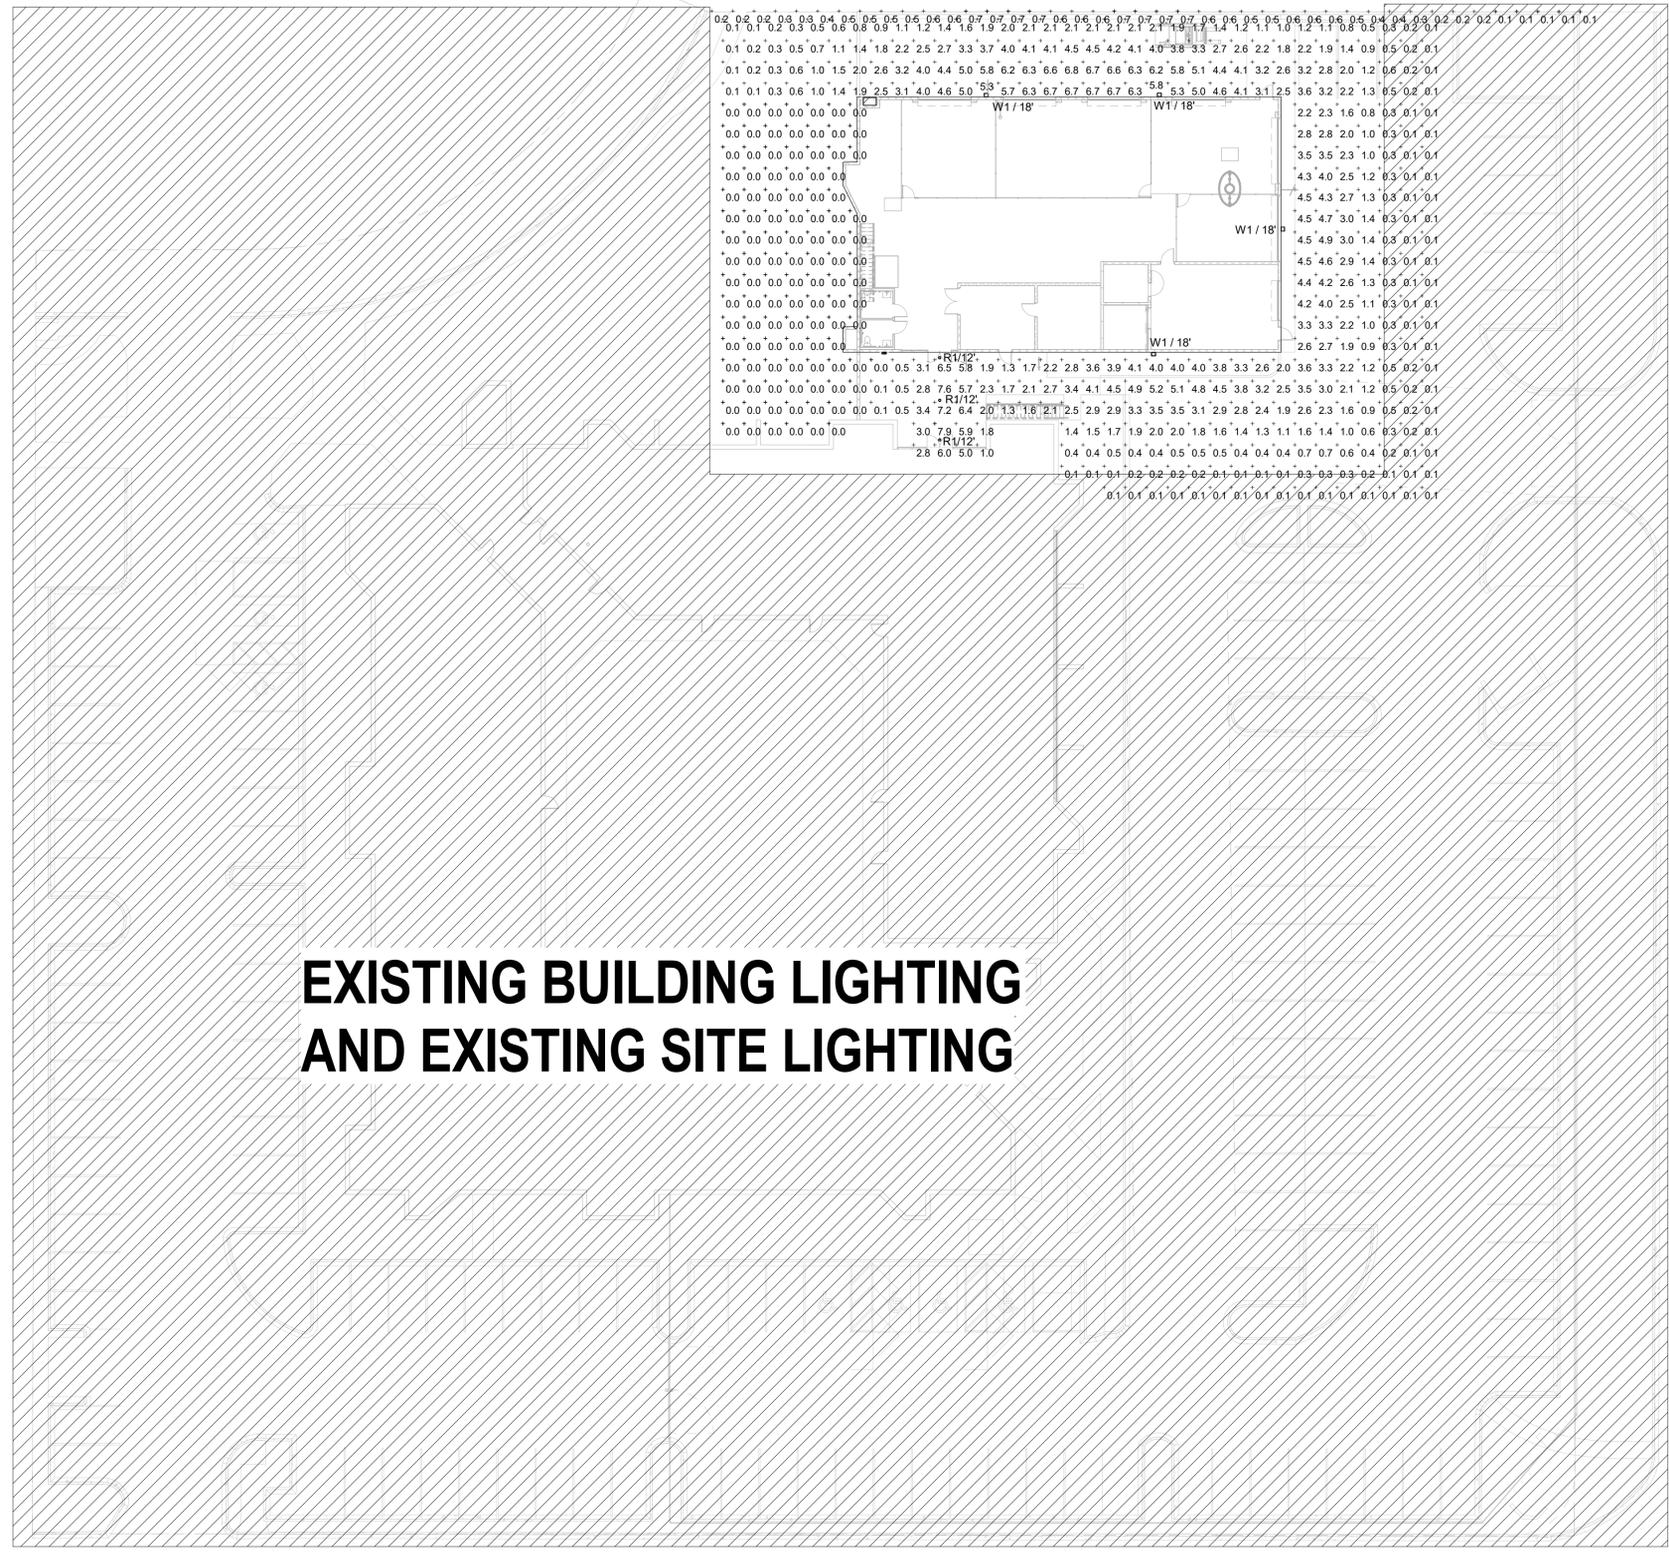

EXISTING BUILDING LIGHTING AND EXISTING SITE LIGHTING

| Symbol | Label | Manufacturer | Catalog Number | Description | Number Lamps | Lumens Per Lamp | Light Loss Factor | Wattage |
|--------|-------|-------------------|---------------------------|---|--------------|-----------------|-------------------|---------|
| □ | W1 | Lithonia Lighting | DSX1 LED P1 30K T1S MVOLT | DSX1 LED P1 30K T1S MVOLT | 1 | 6457 | 1 | 54 |
| ○ | R1 | Lithonia Lighting | LDN6 30/10 L06AR LSS | 6IN LDN, 3000K, 1000LM, CLEAR, SEMI-SPECULAR REFLECTOR, CRI80 | 1 | 938 | 0.9 | 10.44 |

| Description | Symbol | Avg | Max | Min | Max/Min | Avg/Min |
|---------------|--------|--------|--------|--------|---------|---------|
| Calc Zone #1 | + | 1.6 fc | 7.9 fc | 0.0 fc | N/A | N/A |
| Property line | + | 0.5 fc | 0.7 fc | 0.1 fc | 7.0:1 | 5.0:1 |



| | |
|-------------------|------------|
| Project No: | 1395 |
| Date: | 4/22/2022 |
| Drawn By: | JWN |
| Reviewed By: | Checker |
| No. Revision | Date |
| 1 City Comments | 04/22/2022 |



| | | |
|----------------|---------------|------------|
| Project No: | 1398 | |
| Date: | 4/22/2022 | |
| Drawn By: | JWN | |
| Reviewed By: | Checker | |
| No. Revision | Date | |
| 1 | City Comments | 04/22/2022 |

Sheet Title:
LIGHTING SCHEDULE AND CUT-SHEETS

Sheet No:
E2.00

| TYPE MARK | DESCRIPTION | FIXTURE WATTAGE | VOLTAGE | MANUFACTURER |
|-----------|---|-----------------|---------|---|
| EM | WALL MOUNTED EMERGENCY LIGHT FIXTURE AT 9'-0" | 5 W | 120 V | LITHONIA LIGHTING *AFF PEL UVOLT SDRT WT * |
| R1 | 6" DOWNLIGHT AT 12'-0" | 10 W | 120 V | LITHONIA LIGHTING - LDN6-30/10-LOGAR-LSS |
| W1 | WALL MOUNTED AT 18'-0" | 54 W | 120 V | LITHONIA LIGHTING - DSX1 LED P1 30K T15 MVOLT WBA |

EM



FEATURES & SPECIFICATIONS
INTENDED USE — Ideal for applications requiring low profile, attractive emergency lighting with optional normally-off or normally-on with photocell control. Provides a minimum of 90 minutes of illumination both indoors and outdoors upon loss of AC power. **Certain airborne contaminants can diminish the integrity of acrylic and/or polycarbonate. Click here for acrylic/polycarbonate compatibility table for suitable uses.**

CONSTRUCTION — Compact, low-profile, architectural design with die-cast aluminum housing. Finish on textured powder coat paint for dark bronze, white, black and non-textured for natural aluminum. Test switch indicator light and remote enable are located on the bottom of the housing and are easily accessible and visible from the floor.

OPTICS — LED with 7,000-55,000 hours. Delivers 65 lumens per Watt. Normal (On) and Emergency operation. Optional field configurable for wide and forward throw distribution (US Patent Pending). Outdoor wide throw distribution: 70° (3 path of egress) at a 7.5' mounting height with 1FC Average, 4,000K correlated color temperature (CCT), 70 CRI.

ELECTRICAL — UVOLT (120 thru 347V, 50/60Hz). Current limiting charger maximizes battery life and minimizes energy consumption to provide low operating costs. Small battery chargers Certified in the CA Title 20 Appliance Efficiency Database. Short-circuit protection — current limiting charger circuitry protects printed circuit board from shorts. Regulated charge voltage maintains a stable charge voltage over a wide range of line voltages. Prevents overcharging that shortens battery life and reduces capacity. Filtered charger input minimizes charge voltage ripple and extends battery life. Photocell option (PEL) for normally on product in order to discontinue illumination during periods when ambient light is present. Remote units (DLR) are normally off. Emergency only functionality with DC power from an external battery.

BATTERY — Sealed, maintenance-free Lithium Iron Phosphate battery. **SELF-DIAGNOSTICS AND REMOTE TEST (SDRT OPTION):** Automatic 24-hour recharge after a 90-minute discharge. Advanced electrical design provides constant light output throughout the entire discharge period for non-CW batteries. For cold weather and cold temperature applications, the light may dim through the discharge cycle. Brownout protection is automatically switched to emergency mode when supply voltage drops below approximately 80 percent normal of 120, 220, 277 or 347. Other input voltages may vary. AC/DC line-to-line/battery connection before AC power is applied and prevents battery damage from deep discharge.

Self-Diagnostics: Continuously monitors AC functionality. Standard derangement monitoring will indicate disconnected battery, charger failure and displays green flashing indicator light while in emergency mode. Single multi-chromatic LED indicator to display two-state charging, test activation and three-state self-diagnostics. **Self-diagnostic testing:** Five minutes every 30 days and 90 minutes annually. Diagnostic evaluation of lamp, AC to DC transfer, battery charging and condition of microprocessor. Automatic test is easily postponed for eight hours by activating manual test switch or use of remote tester (RTKT accessory). **Manual testing:** Test switch and remote tester (RTKT) accessory provides manual activation of 60-second diagnostic testing for ease of demand visual inspection. 90-minute manual testing can be enabled by pressing the test switch again while in test mode.

INSTALLATION — Wall mount: typically meets 7.5' to 14' mounting height from ground or floor. Power supplied by either mounting directly to a 4" square or 4" octagon y-box (wall mount) and accepts rigid or flex conduit. **LISTINGS** — UL wet location listed standard at 32-122°F (0-59°C). Unit with CW (battery/field weather) listed for -22°F to 122°F (-8°F to 50°C). Remote listed for -40°F to 122°F (-40°F to 50°C). Meets or exceeds all applicable requirements for UL 924, NFPA 101 (current IFC safety code), NFPA 70 (NEC), NOM (Norma Oficial Mexicana), California Energy Commission Title 20 section 1605.3 (RHV), FCC Title 47, Part 15, Subpart E and OSHA. List and labeled to comply with Canadian Standards C22.2 No. 149-03. Meets City of Chicago Code. **WARRANTY** — 5-year limited warranty. Complete warranty terms located at: www.lithonia.com/resources/customer-support/warranty-terms-and-conditions. **Notes:** Actual performance may differ as a result of end-user environment and application. All values are design or typical values, measured under laboratory conditions at 25°C. Specifications subject to change without notice.

1 Small Battery Chargers Certified in the CA Title 20 Appliance Efficiency Database.


| | |
|----------------|--|
| Catalog Number | |
| Notes | |
| Type | |

AFFINITY®
Premium Die-Cast Architectural Emergency Light

AFF




MOUNTING
All dimensions are inches (centimeters).
Shipping weight: 3.5 lbs. (1.59 kg).

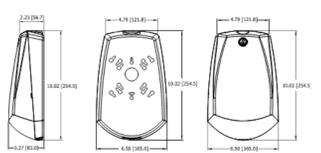

W1



D-Series Size 2 LED Area Luminaire

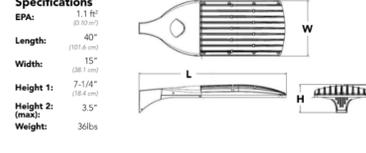

Specifications
EPA: 1.1 ft² (0.10 m²)
Length: 40" (101.6 cm)
Width: 15" (38.1 cm)
Height 1: 7.1/4" (18.4 cm)
Height 2: 3.5"
Weight: 36lbs

INTRODUCTION
The modern styling of the D-Series is striking yet unobtrusive - making a bold, progressive statement even as it blends seamlessly with its environment. The D-Series distills the benefits of the latest in LED technology into a high performance, high efficacy, long-life luminaire. The outstanding photometric performance results in sites with excellent uniformity, greater pole spacing and lower power density. The Size 2 is ideal for replacing 400-1000W metal halide in area lighting applications with energy savings of up to 80% and expected service life of over 100,000 hours.

CONSTRUCTION — Galvanized steel mounting/plaster frame; galvanized steel junction box with bottom-hinged access covers and spring latches. Reflectors are retained by tension springs. Vertically adjustable mounting brackets with commercial bar hangers provide 3-1/4" total adjustment. Two combination 1" x 3/4" and four 1/2" knockouts for straight through conduit runs. Capacity: 4 in, 4 out. No. 12 AWG conductors, rated for 90°C. Accommodates 12" x 24" joint spacing. Passive cooling thermal management for 25°C standard, high ambient (40°C) option available. Light engine and drivers are accessible from above or below ceiling. Max ceiling thickness 1-1/2". **OPTICS** — LED on-board to a 3-way SDCM, 80 CRI minimum, 90 CRI optional. LED light source concealed with diffusing optical lens. General illumination lighting with 1.0 S/M and 35° cutoff for sources and source image. Self-flange angled reflectors in specular, semi-specular, or matte diffuse finishes. Also available in white and black painted reflectors. 0-10V dimming fixture requires two (2) additional low-voltage wires to be pulled. 70% lumen maintenance at 50,000 hours. **LISTINGS** — Certified to US and Canadian safety standards. Wet location standard (covered ceiling). IP55 rated. ENERGY STAR certified product. **BUY AMERICAN** — Product with the BAA option is assembled in the USA and meets the Buy American government procurement requirements under FAR, DFARS and DOT. Please refer to www.lithonia.com/usa-buy-american for additional information. **WARRANTY** — 5-year limited warranty. Complete warranty terms located at: www.lithonia.com/resources/customer-support/warranty-terms-and-conditions. **Notes:** Actual performance may differ as a result of end-user environment and application. All values are design or typical values, measured under laboratory conditions at 25°C. Specifications subject to change without notice.

| Series | LEDs | Color temperature | Distribution | Voltage | Mounting | |
|----------|--|--|---|---|--|--|
| DSX2 LED | Forward optics P1 P5 ¹ P2 P6 P3 P7 ¹ P4 P8 ¹ P9 ¹ P13 ¹ P11 ¹ P14 ¹ P12 ¹ | 30K 3000 K 40K 4000 K 50K 5000 K | T1S Type I Short (Automotive) T2S Type II Short T3M Type III Medium T4M Type IV Medium T5M Type V Short T6M Type VI Medium | TSVS Type V Very Short ¹ TSS Type V Short ¹ TSM Type V Medium ¹ TSW Type V Wide ¹ LCCO Left corner cutoff ¹ RCCO Right corner cutoff ¹ | MVOLT ¹ XVOLT (077V-480V) ^{1,2} 120* 240* 277* 347* 480* | Shipped included SPA Square pole mounting RPA Round pole mounting ¹ WBA Wall bracket ¹ SPRUBA Square pole universal mounting adaptor ¹ RPRUBA Round pole universal mounting adaptor ¹ |

| Control options | Driver options | Finish options |
|--|--|--|
| Shipped installed N2AR2 nLight AIR generation 2 enabled ¹ FRON Network, 0-10V dimming/ambient sensor ¹ PER NEMA basic lock receptacle only (no controls) ¹ PER5 Five-wire receptacle only (no controls) ^{1,2} PER7 Seven-wire receptacle only (no controls) ^{1,2} DMAG 0-10V dimming external out back of housing for external control (no controls) ¹ DS Dual switching ^{1,3} | DLR Remote, 0-10V dimming/ambient sensor, 15-30' mounting height, ambient sensor enabled at 16" ⁴ PRHFCV High/Low, motion/ambient sensor, 15-30' mounting height, ambient sensor enabled at 16" ⁴ FAO Field Adjustable Output ¹ | DOBX Dark bronze DLR0 Black DNAD Natural aluminum DNWD White DOBTD Textured dark bronze DLRDX Textured black DNADZ Textured natural aluminum DNWGD Textured white ES External glare shield |

Shipped separately
KMA8 DOBX D Mount arm mounting bracket adaptor (specify finish)⁵

Notes
1 Overall height varies based on lumen package; refer to dimensional chart on page 1.
2 Not available with fixtures.
3 Not available with emergency options.
4 Most specify voltage 120V or 277V.
5 Available with clear diffuser only.
6 12.5" of plenum depth or top access required for battery pack maintenance.
7 Specify voltage: 0V for use with generator supply (0W power); 0W requires emergency hot lead and normal hot lead.
8 Fixture begins at 80% light level. Must be specified with NPSBZE or NPSBZE ER. Only available with E210 and E21 drivers.

Accessories: Order as separate catalog number.
P5055XP FMC Power Sentry battery pack, T20 compliant, field installable, 10w constant power
E21-SS20-125 Compact interchangeable emergency AC power system
E21-SS20-125 Compact interchangeable emergency AC power system
GR48A-EZ Over-sized trim ring with 8" outside diameter
SC46 Sloped Ceiling Adapter. Degree of slope must be specified (50, 100, 150, 200, 250, 300). Ex: SC46 100

One Lithonia Way • Corvys, Georgia 30012 • Phone: 1-800-705-SERV (7378) • www.lithonia.com
© 2011-2021 Acuity Brands Lighting, Inc. All rights reserved.

| | |
|----------------|--|
| Catalog Number | |
| Notes | |
| Type | |

R1

LITHONIA LIGHTING

FEATURES & SPECIFICATIONS
INTENDED USE — Typical applications include corridors, lobbies, conference rooms and private offices. **CONSTRUCTION** — Galvanized steel mounting/plaster frame; galvanized steel junction box with bottom-hinged access covers and spring latches. Reflectors are retained by tension springs. Vertically adjustable mounting brackets with commercial bar hangers provide 3-1/4" total adjustment. Two combination 1" x 3/4" and four 1/2" knockouts for straight through conduit runs. Capacity: 4 in, 4 out. No. 12 AWG conductors, rated for 90°C. Accommodates 12" x 24" joint spacing. Passive cooling thermal management for 25°C standard, high ambient (40°C) option available. Light engine and drivers are accessible from above or below ceiling. Max ceiling thickness 1-1/2". **OPTICS** — LED on-board to a 3-way SDCM, 80 CRI minimum, 90 CRI optional. LED light source concealed with diffusing optical lens. General illumination lighting with 1.0 S/M and 35° cutoff for sources and source image. Self-flange angled reflectors in specular, semi-specular, or matte diffuse finishes. Also available in white and black painted reflectors. 0-10V dimming fixture requires two (2) additional low-voltage wires to be pulled. 70% lumen maintenance at 50,000 hours. **LISTINGS** — Certified to US and Canadian safety standards. Wet location standard (covered ceiling). IP55 rated. ENERGY STAR certified product. **BUY AMERICAN** — Product with the BAA option is assembled in the USA and meets the Buy American government procurement requirements under FAR, DFARS and DOT. Please refer to www.lithonia.com/usa-buy-american for additional information. **WARRANTY** — 5-year limited warranty. Complete warranty terms located at: www.lithonia.com/resources/customer-support/warranty-terms-and-conditions. **Notes:** Actual performance may differ as a result of end-user environment and application. All values are design or typical values, measured under laboratory conditions at 25°C. Specifications subject to change without notice.

| Series | Color temperature | Lumens ¹ | Aperture/Trim Color | Finish | Voltage |
|---------------|---|--|-------------------------------|----------------------------------|--|
| LDN6 6" round | 27/ 2700K 30/ 3000K 35/ 3500K 40/ 4000K 50/ 5000K | 05 500 lumens 07 750 lumens 10 1000 lumens 15 1500 lumens 20 2000 lumens | LD6 Downlight LW6 Wallwash | AR Clear WR White BR Black | LSS Semi-specular LD Matte diffuser LS Specular MVOLT Multi-volt 120 120V 277 277V 347 ¹ 347V |

ORDERING INFORMATION Lead times will vary depending on options selected. Consult with your sales representative. **Example:** LDN6 35/15 LOGAR LSS MVOLT E210

| Series | Color temperature | Lumens ¹ | Aperture/Trim Color | Finish | Voltage |
|---------------|---|--|-------------------------------|----------------------------------|--|
| LDN6 6" round | 27/ 2700K 30/ 3000K 35/ 3500K 40/ 4000K 50/ 5000K | 05 500 lumens 07 750 lumens 10 1000 lumens 15 1500 lumens 20 2000 lumens | LD6 Downlight LW6 Wallwash | AR Clear WR White BR Black | LSS Semi-specular LD Matte diffuser LS Specular MVOLT Multi-volt 120 120V 277 277V 347 ¹ 347V |

| Driver | Options |
|--|--|
| G210 0-10V driver dims to 10% | SF ¹ Single fuse TRW ¹ White painted range TBL L Black painted range |
| G21 0-10V driver dims to 1% | EL ¹ Emergency battery pack with integral test switch, 10W Constant Power, Not Certified in CA Title 20 MAEDBS |
| D10 Minimum dimming 10% driver for use with JOT | EL* Emergency battery pack with remote test switch, 10W Constant Power, Not Certified in CA Title 20 MAEDBS |
| E210 0-10V e80LED driver with smooth and flicker-free deep dimming performance down to 10% | ELSD ¹ Emergency battery pack with self-diagnostics, integral test switch, 10W Constant Power, Not Certified in CA Title 20 MAEDBS E10WCP ¹ Emergency battery pack, 10W Constant Power with integral test switch. Certified in CA Title 20 MAEDBS |
| E21 0-10V e80LED driver with smooth and flicker-free deep dimming performance down to 1% | E10WCP* Emergency battery pack, 10W Constant Power with remote test switch. Certified in CA Title 20 MAEDBS |
| EMAB e80LED DALI S0LDDIVE dim to dark | NPP160ER ¹ nLight™ network power/relay pack with 0-10V dimming for non-e80LED drivers (G210, G21). ER controls features on emergency circuit. NPP160ER* nLight™ network power/relay pack with 0-10V dimming for non-e80LED drivers (G210, G21). ER controls features on emergency circuit. |

Notes
1 Overall height varies based on lumen package; refer to dimensional chart on page 1.
2 Not available with fixtures.
3 Not available with emergency options.
4 Most specify voltage 120V or 277V.
5 Available with clear diffuser only.
6 12.5" of plenum depth or top access required for battery pack maintenance.
7 Specify voltage: 0V for use with generator supply (0W power); 0W requires emergency hot lead and normal hot lead.
8 Fixture begins at 80% light level. Must be specified with NPSBZE or NPSBZE ER. Only available with E210 and E21 drivers.

Accessories: Order as separate catalog number.
P5055XP FMC Power Sentry battery pack, T20 compliant, field installable, 10w constant power
E21-SS20-125 Compact interchangeable emergency AC power system
E21-SS20-125 Compact interchangeable emergency AC power system
GR48A-EZ Over-sized trim ring with 8" outside diameter
SC46 Sloped Ceiling Adapter. Degree of slope must be specified (50, 100, 150, 200, 250, 300). Ex: SC46 100

One Lithonia Way • Corvys, Georgia 30012 • Phone: 1-800-705-SERV (7378) • www.lithonia.com
© 2011-2021 Acuity Brands Lighting, Inc. All rights reserved.

SÄZÄN GROUP

311 E. Veterans Way, Ste. 102
Tempe, AZ 85281

Tel 480.530.9101
Fax 480.530.9130

SAZAN# 882-22002