# NOTRE DAME PREPARATORY HIGH SCHOOL

# 849.58 KW DC PHOTOVOLTAIC GENERATING FACILITY

SCOTTSDALE, ARIZONA

E BELL RD

#### **GENERAL NOTES**

- THE CONTRACTOR SHALL VISIT SITE TO VERIFY EXISTING CONDITIONS UNDER WHICH HE WILL BE OBLIGATED TO PERFORM THIS WORK. EXAMINE AND VERIFY LOCATIONS / ARRANGEMENTS OF EXISTING EQUIPMENT, STRUCTURES, ETC THAT MAY AFFECT THIS WORK. THE DRAWINGS ARE GENERALLY DIAGRAMMATIC AND INDICATE THE GENERAL ARRANGEMENT OF EQUIPMENT AND WIRING. REVIEW THE DRAWINGS OF OTHER TRADES TO AVOID CONFLICTS AND DETERMINE ROUGH IN LOCATIONS SO THAT EACH PIECE OF EQUIPMENT IS INSTALLED TO FUNCTION PER THE MANUFACTURERS SPECIFICATIONS.
- ALL MATERIALS PROVIDED BY THE CONTRACTOR SHALL BE NEW. REMOVED OR DAMAGED MATERIAL SHALL NOT BE REUSED FOR RELOCATED.
- WHERE THE WORD "OWNER" IS USED IT SHALL BE UNDERSTOOD TO REFER TO THE OWNER, ENGINEER, OR DESIGNATED REPRESENTATIVE.
- CONTRACTOR SHALL BE RESPONSIBLE FOR RETAINING THE CURRENT PROJECT DOCUMENTS AND SPECIFICATIONS ON SITE AT ALL TIMES DURING THIS CONSTRUCTION EFFORT.
- EXISTING EQUIPMENT NOT EXPLICITLY SHOWN ON THE DRAWINGS IS INTENDED TO BE "EXISTING TO REMAIN UNCHANGED, UNLESS OTHERWISE NOTED.
- VERIFY ALL EQUIPMENT LOAD CHARACTERISTICS, EXACT LOCATIONS AND ALL ROUGH-IN REQUIREMENTS PRIOR TO INSTALL.
- 7. THESE DRAWINGS ARE BASED ON INFORMATION OBTAINED FROM EXISTING DRAWINGS, FIELD INVESTIGATIONS, AND INFORMATION PROVIDED BY THE OWNER. CONCEALED WORK OR ENERGIZED EQUIPMENT MAY NOT HAVE BEEN PHYSICALLY VERIFIED BUT IS BELIEVED TO BE ACCURATE, MINOR DEVIATIONS SHOULD BE ANTICIPATED. DURING THE COURSE OF CONSTRUCTION, CONTRACTOR SHALL VERIFY ALL EXISTING CONDITIONS AND NOTIFY THE OWNER OF ANY DISCREPANCIES.
- 8. NOT USED.
- PV CONSTRUCTION DOCUMENTS ARE NOT CONSIDERED TO BE FOR CONSTRUCTION UNTIL REVIEWED AND APPROVED BY BOTH THE AUTHORITY HAVING JURISDICTION AND THE SERVING ELECTRICAL UTILITY
- 10. ALL WORK SHALL BE PERFORMED IN ACCORDANCE WITH THE LAWS AND REGULATIONS ADOPTED BY THE AUTHORITY HAVING JURISDICTION.
- 11. BEFORE THE WORK WILL BE CONSIDERED COMPLETE AND ON A DAILY BASIS DURING CONSTRUCTION, ALL RUBBISH AND UNUSED MATERIALS MUST BE REMOVED AND THE PREMISES LEFT IN A CONDITION SATISFACTORY TO THE OWNER. ANY PROPERTY DISTURBED OR DAMAGED MUST BE RESTORED TO THEIR FORMER CONDITION WITHOUT COST TO THE OWNER.
- 12. RETURN TO THE OWNER (1) SET OF REPRODUCIBLE AS-BUILT ELECTRICAL DRAWINGS WITHIN ONE WEEK OF COMPLETION OF WORK.

# - NOTRE DAME -PREPARATORY HIGH SCHOOL E MCDOWELL MOUNTAIN RANCH RD SCALE: N.T.S. **NORTH**

#### UTILITY CO. REP

POWER CO. APS renewables@aps.com (602)-328-1924

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#### SCOPE OF WORK

WORK INCLUDED UNDER THIS CONTRACT INCLUDES FURNISHING ALL MATERIALS, LABOR, AND EQUIPMENT TO INSTALL AND PUT IN OPERATION A COMPLETE PHOTOVOLTAIC SYSTEM AS INDICATED ON THESE DRAWINGS. PROVIDE ALL PRODUCTS NOT INDICATED BUT NECESSARY AND REQUIRED FOR THE COMPLETION OF THIS WORK.

MODIFICATION OF EXISTING EQUIPMENT AND STRUCTURES AS SHOWN AND REQUIRED TO ACCOMMODATE THE NEW PHOTOVOLTAIC SYSTEM

CONTRACTOR TO ACQUIRE AND POST ALL NECESSARY PERMITS.



PROJECT DATA

PROJECT NAME: NOTRE DAME PREPARATORY HIGH SCHOOL

795.01 KW DC / 653.00 KW AC PHOTOVOLTAIC SYSTEM

9701 E BELL RD, SCOTTSDALE, AZ 85260

PROJECT DESCRIPTION.

THIS PROJECT CONSISTS OF THE INSTALLATION OF THREE PHOTOVOLTAIC SYSTEMS. THIS SYSTEMS ARE CONSIDERED GRID INTERACTIVE WHICH WILL INTERCONNECT WITH THE ELECTRIC DISTRIBUTION GRID AT NOTRE DAME PREPARATORY HIGH

THE PHOTOVOLTAIC SYSTEMS CONSISTS OF (1,588) 535 WATT PHOTOVOLTAIC MODULES, (3) 23.00 KW, (4) 36.00KW, (4) 50.00KW AND (4) 60.00KW UTILITY INTERACTIVE INVERTERS, SYSTEMS TO BE MOUNTED ON PARKING CARPORT STRUCTURE AT THE PARKING LOT AREA AND SHADE STRUCTURES AT EXISTING BLEACHERS AND LANDSCAPE AREAS.

#### SYSTEM #1

DC SYSTEM SIZE: 220,420 WATTS AC SYSTEM SIZE: 183,000 WATTS

**SOLAR MODULES:** (412) CANADIAN SOLAR 535 WATT SOLAR MODULES **INVERTERS:** 

(1) SOLECTRIA PVI23TL 23kW INVERTER (2)SOLECTRIA PVI50TL 50kW INVERTER (1)SOLECTRIA PVI60TL 60kW INVERTER

#### SYSTEM #2

DC SYSTEM SIZE: 592,780 WATTS AC SYSTEM SIZE: 447,000 WATTS

**SOLAR MODULES:** (1,108) CANADIAN SOLAR 535 WATT SOLAR MODULES

(1)SOLECTRIA PVI23TL 23kW INVERTER (4) SOLECTRIA PVI36TL 36kW INVERTER (2) SOLECTRIA PVI50TL 50kW INVERTER

(3)SOLECTRIA PVI60TL 60kW INVERTER

### SYSTEM #3

**INVERTERS:** 

DC SYSTEM SIZE: 36,380 WATTS 23.000 WATTS AC SYSTEM SIZE:

(68) CANADIAN SOLAR 535 WATT SOLAR MODULES **SOLAR MODULES: INVERTERS:** (1) SOLECTRIA PVI23TL 23kW INVERTER

SOLAR RACKING: STRUCTURE SYSTEM (PROVIDED BY SCOUT SOLAR LLC)

#### CONTRACTOR INFORMATION

SCOUT SOLAR AZ LLC 1865 E 3rd St, Suite A Tempe, AZ 85281 (2) 288-3650 (815) 301-3164 FAX WWW.SCOUTSOLAR.COM

#### OWNER INFORMATION

NOTRE DAME PREPARATORY CATHOLIC HIGH SCHOOL 9701 E BELL RD, SCOTTSDALE 85260

WEB ndpsaints.org

(480) 634-8200

## **BUILDING CODES**

ALL CONSTRUCTION SHALL COMPLY WITH THE FOLLOWING CODES AND STANDARDS.

INTERNATIONAL BUILDING CODE, 2018 EDITION (IBC), AS AMENDED INTERNATIONAL ENERGY CONSERVATION CODE, 2018 EDITION (IECC), AS AMENDED INTERNATIONAL FIRE CODE, 2018 EDITION (IFC), AS AMENDED INTERNATIONAL MECHANICAL CODE, 2018 EDITION (IMC), AS AMENDED INTERNATIONAL PLUMBING CODE, 2018 EDITION (IPC), AS AMENDED NATIONAL ELECTRIC CODE, 2017 EDITION (NEC), AS AMENDED

#### DESIGN PROFESSIONALS

**ELECTRICAL: STEPHEN K YOUNGER** DESERT SKY ENGINEERING 8344 W. BAJADA RD. PEORIA AZ 85383

623.297.4806

STRUCTURAL: ADAM BRONNENKANT P.E. APB CONSULTING ENGINEERING, PLLC 23650 N. 84TH PLACE

602.904.5748

SCOTTSDALE AZ 85255

**BUILDING DATA** 

9701 E BELL RD, SCOTTSDALE, AZ 85260

PARCEL# 217-14-989



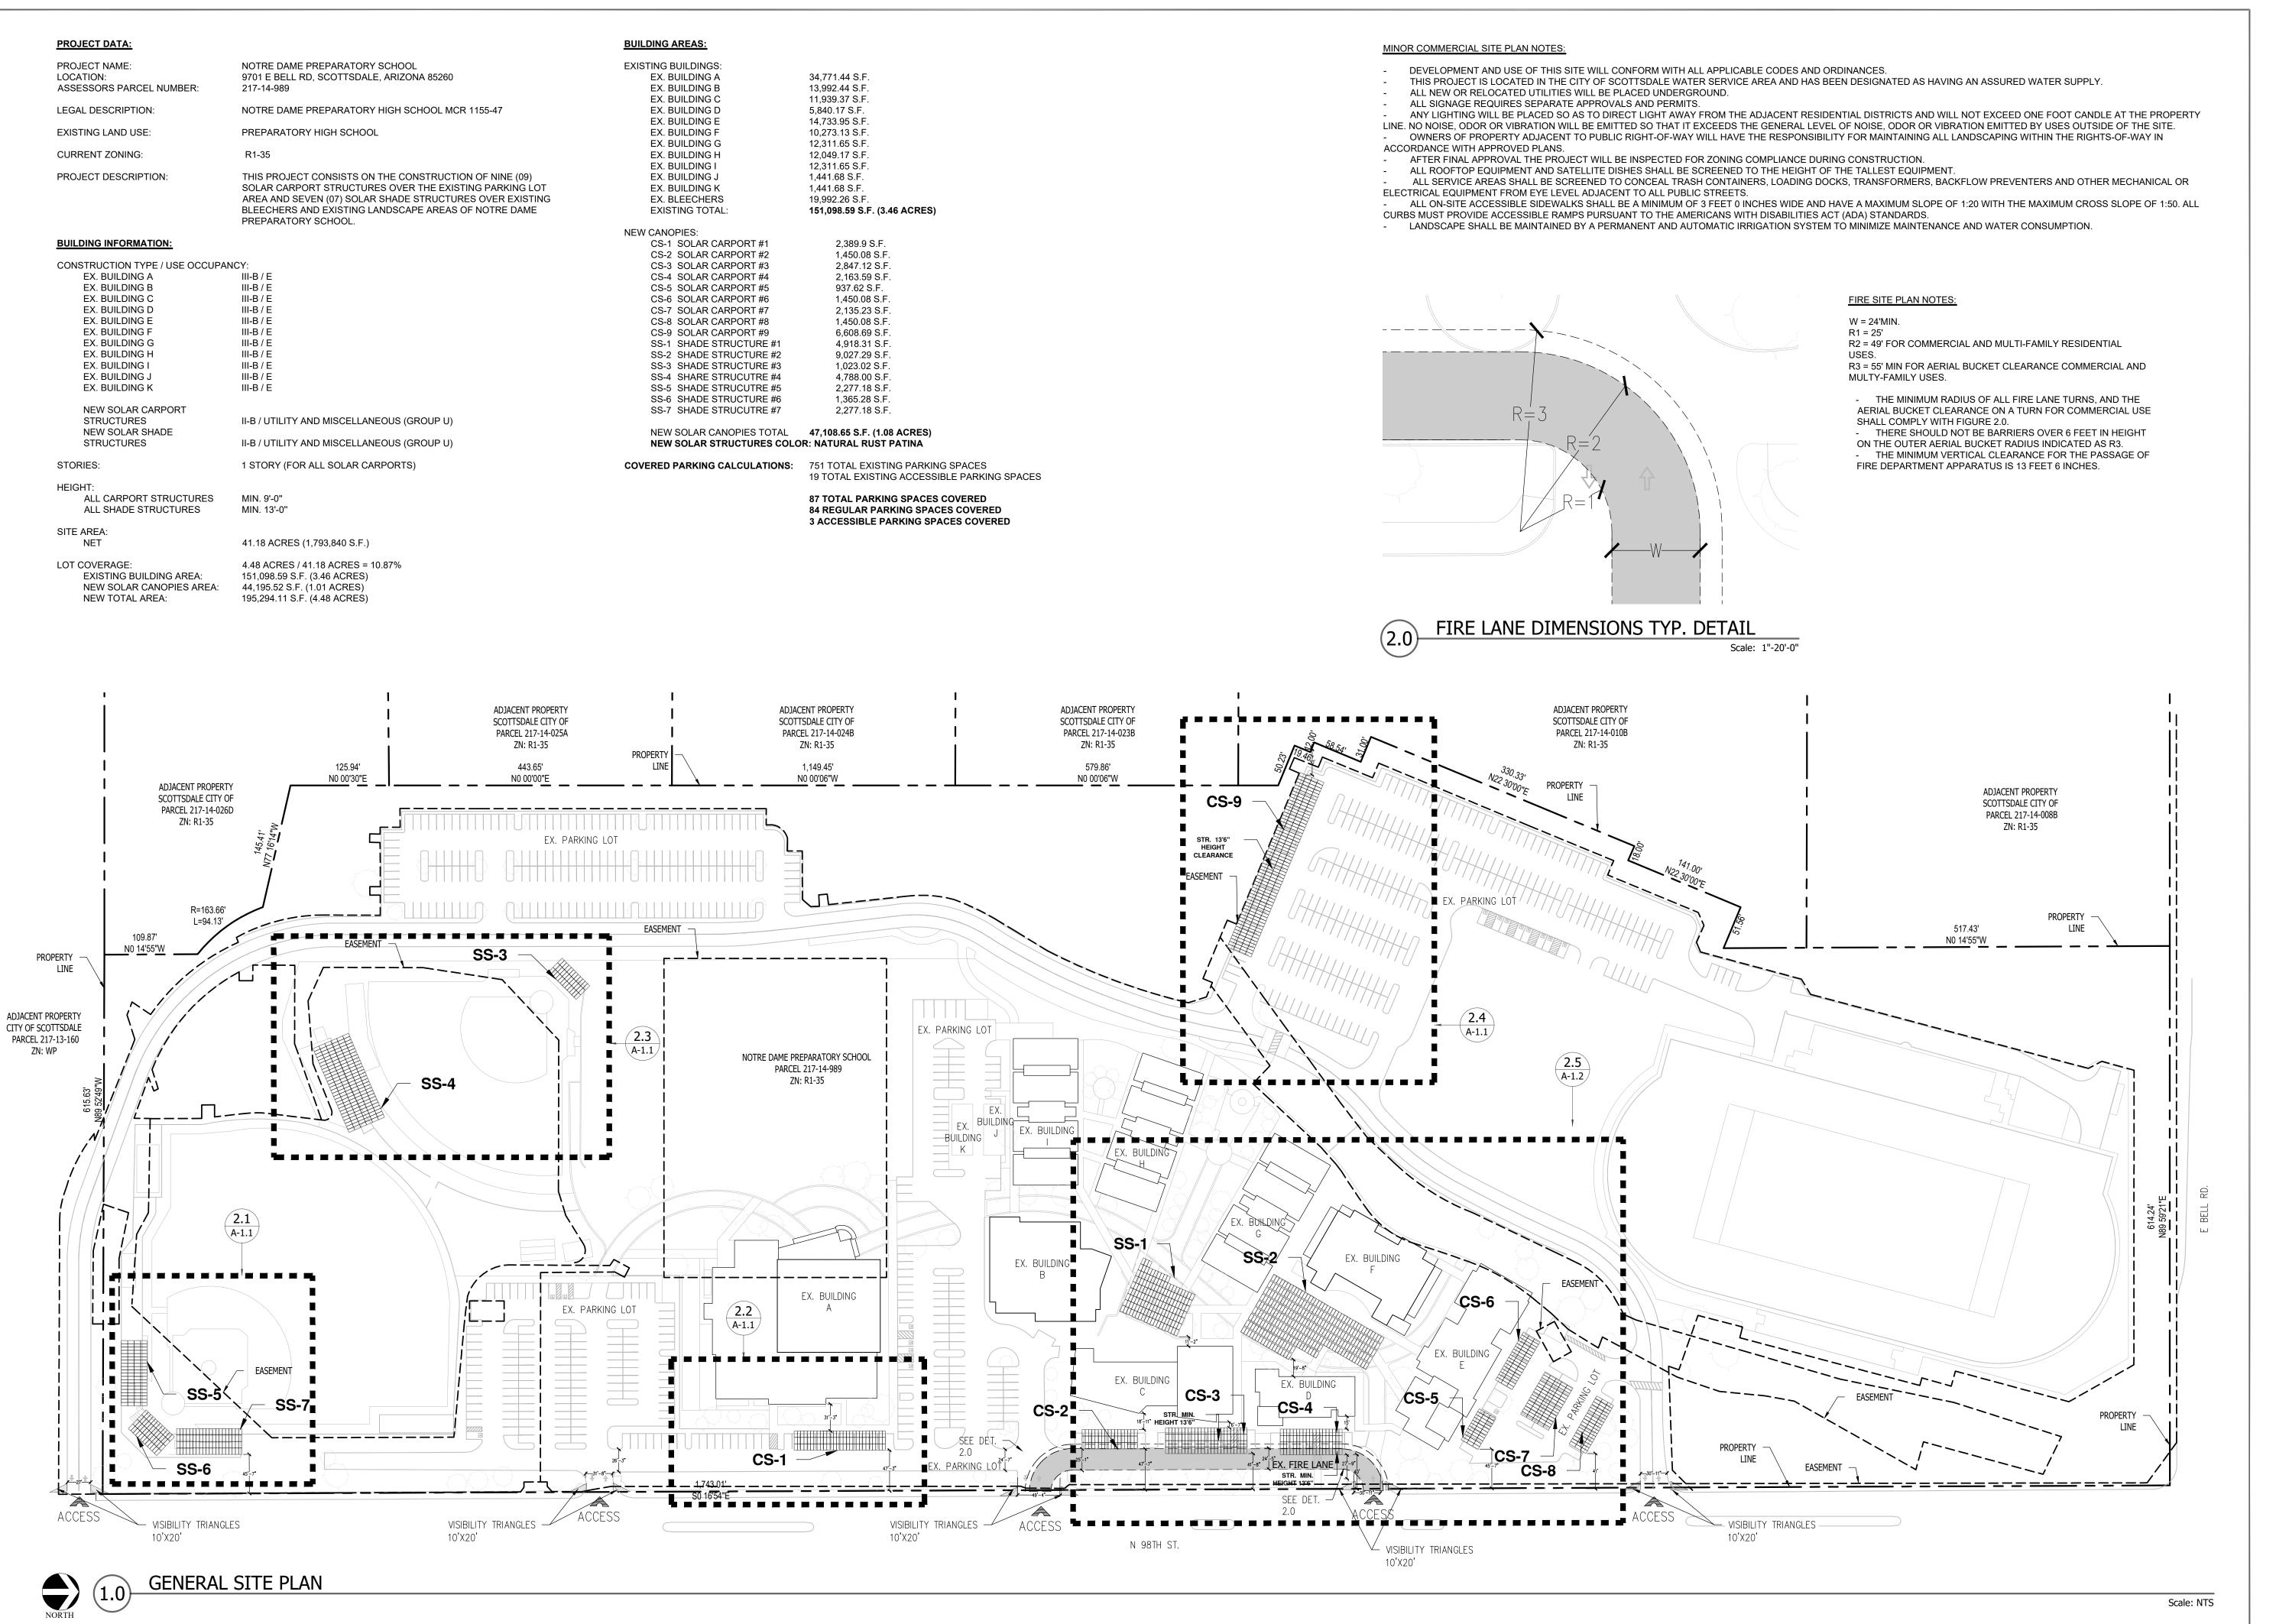
A. GRIJAI VA DESIGNED BY: DATE: 11/11/2022 COMMENTS/CHANGES AG 01.05.2023 PER UTILITY

FOR P.E./ARCHITECT USE

FOR AUTHORITY HAVING JURISDICTION USE AHJ: SCOTTSDALE

SHEET No. **NOTES AND** SPECIFICATIONS

PROJECT#: 22-112-1110



DESIGNED BY:

SONO SOLAR

1865 E 3RD ST SUITE B
TEMPE, AZ 85281

(602) 499-8557 (OFFICE)

WWW.SONORASOLAR.NET

SE DAME PREPARATORY HIGH SCHOOL

TOVOLTAIC SYSTEM, 849.58 KW DC/ 653.00 KW AC

S. 9701 E BELL RD, SCOTTSDALE, AZ 85260

NOTRE DAME PREPARATORY CATHOLIC HIGH SCHOOL

MER INFORMATION:

DUT SOLAR LLC

RD ST SUITE A

AZ 85281

DESIGNED BY:

A. GRIJALVA

REVIEWED BY:

DATE:

11/11/2022

REV BY DATE

COMMENTS/CHANGES

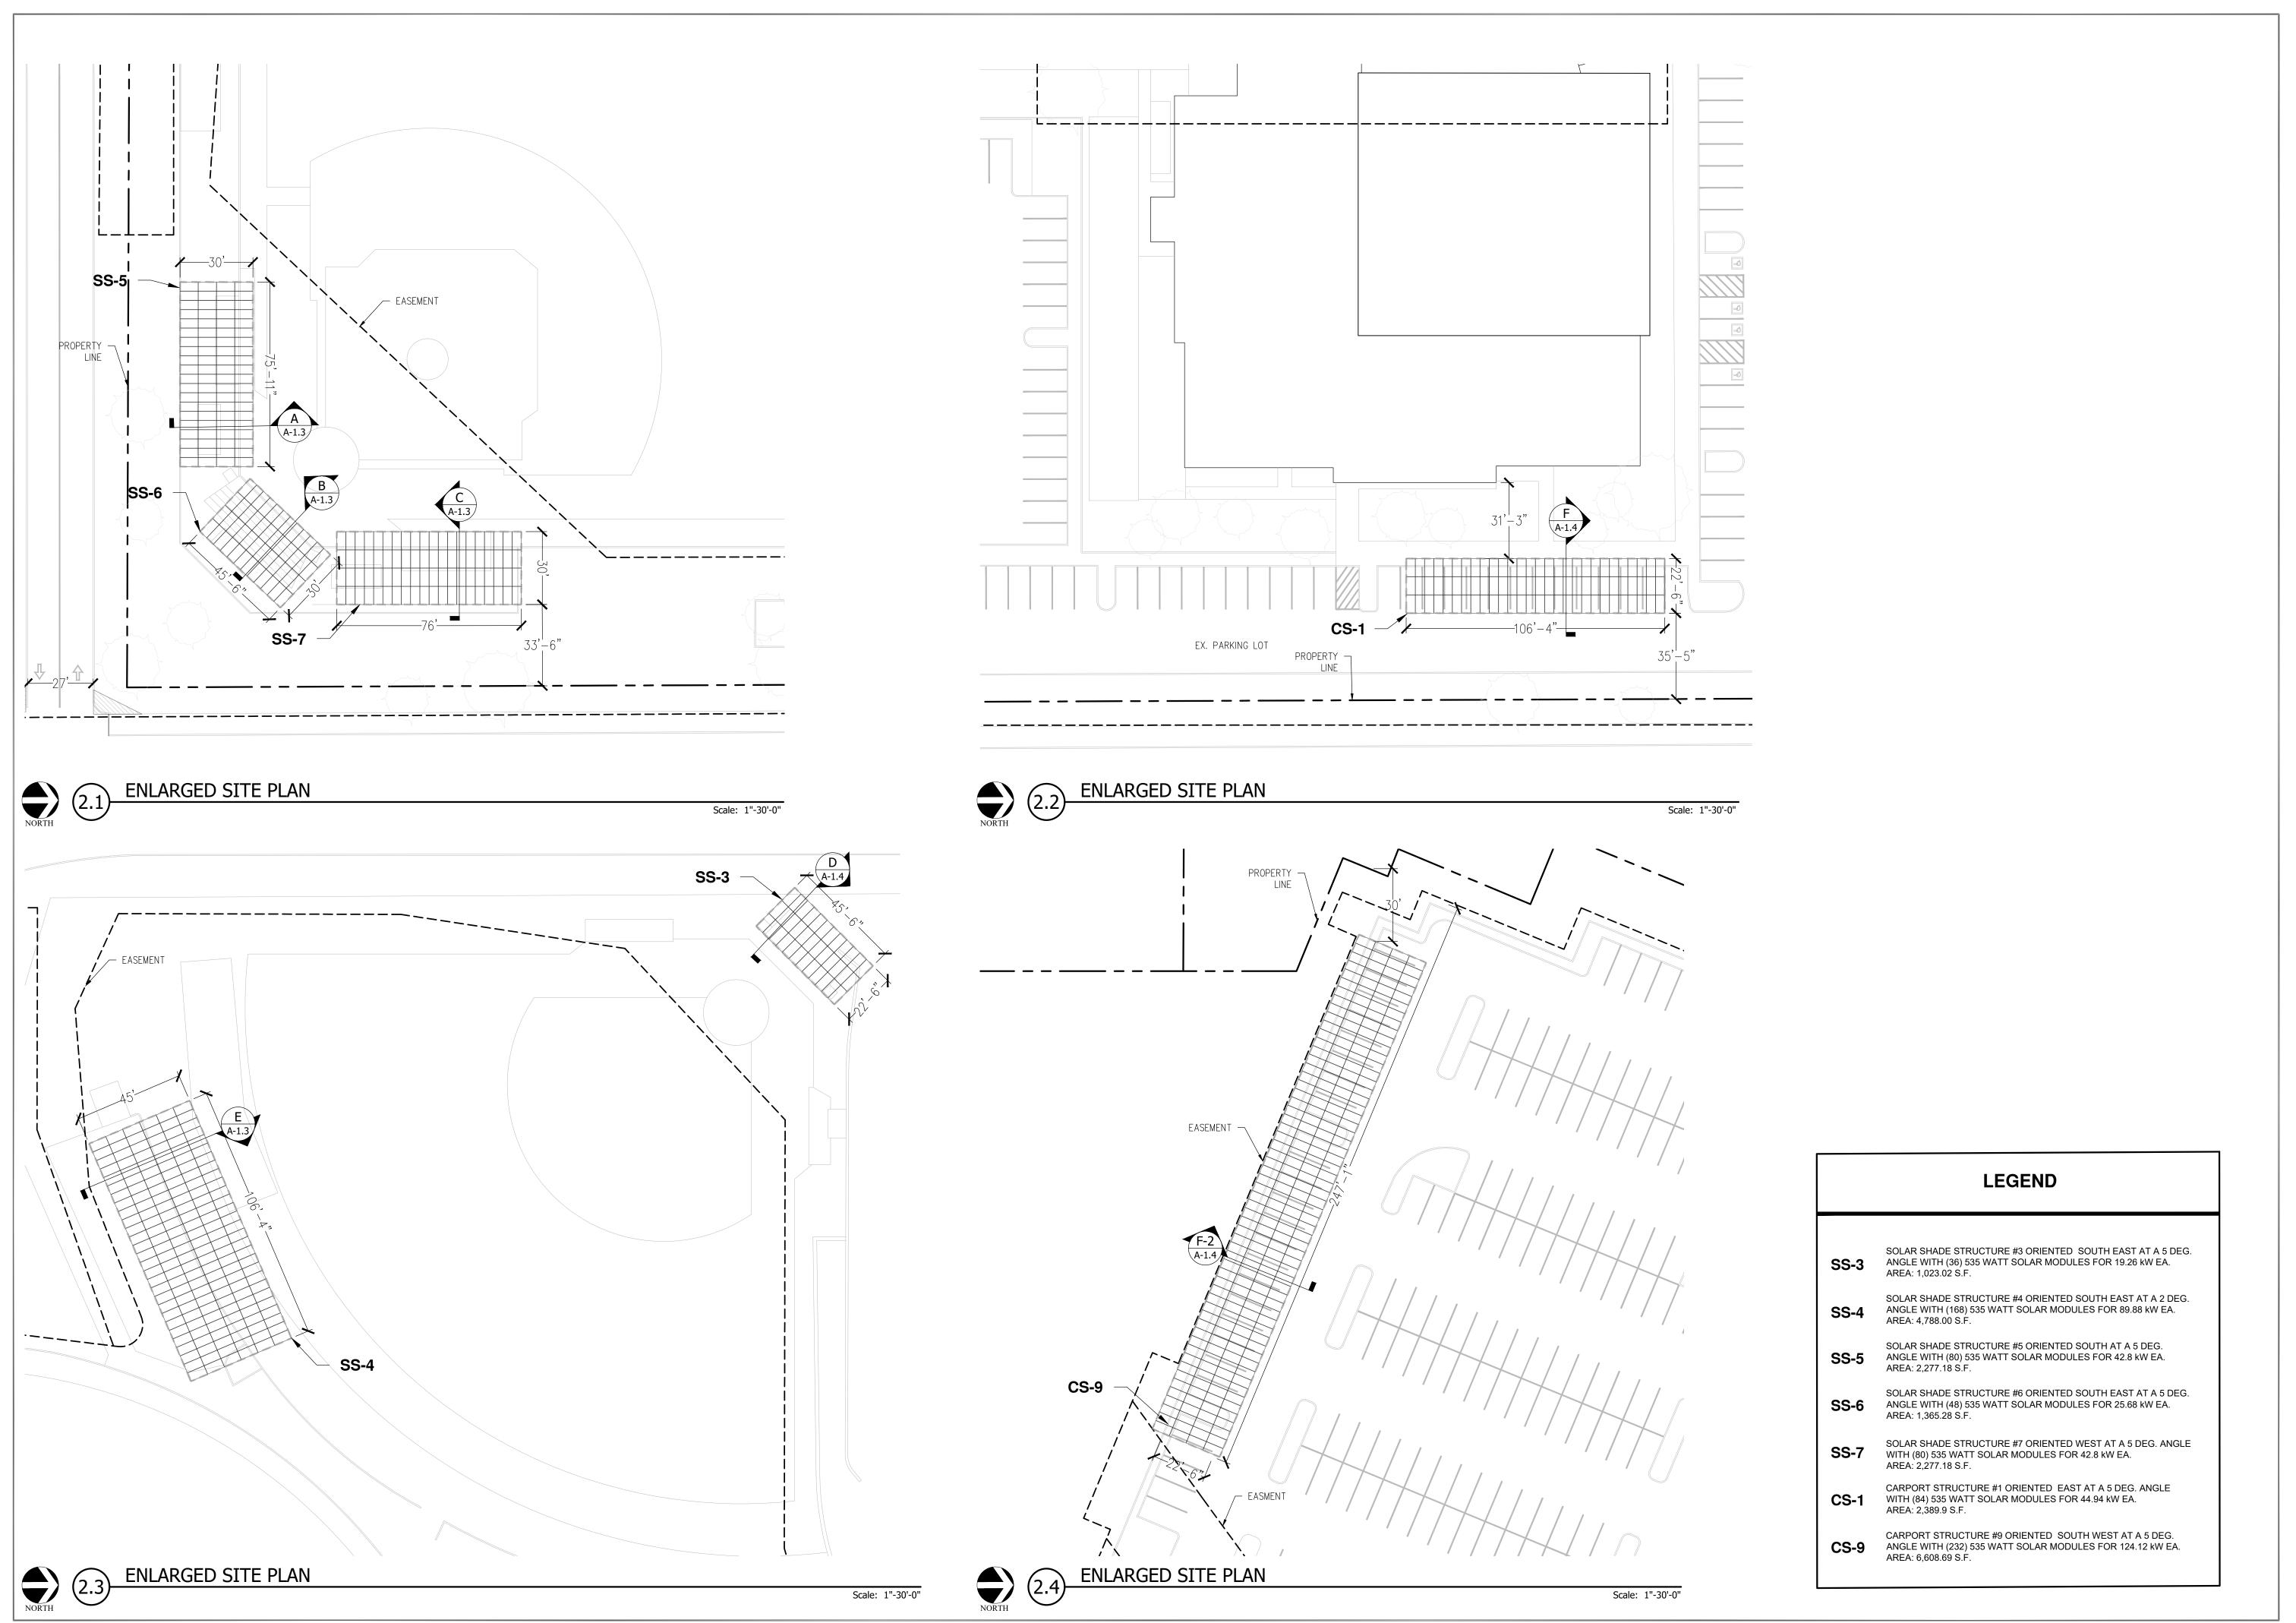
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PER UTILITY

FOR P.E./ARCHITECT USE

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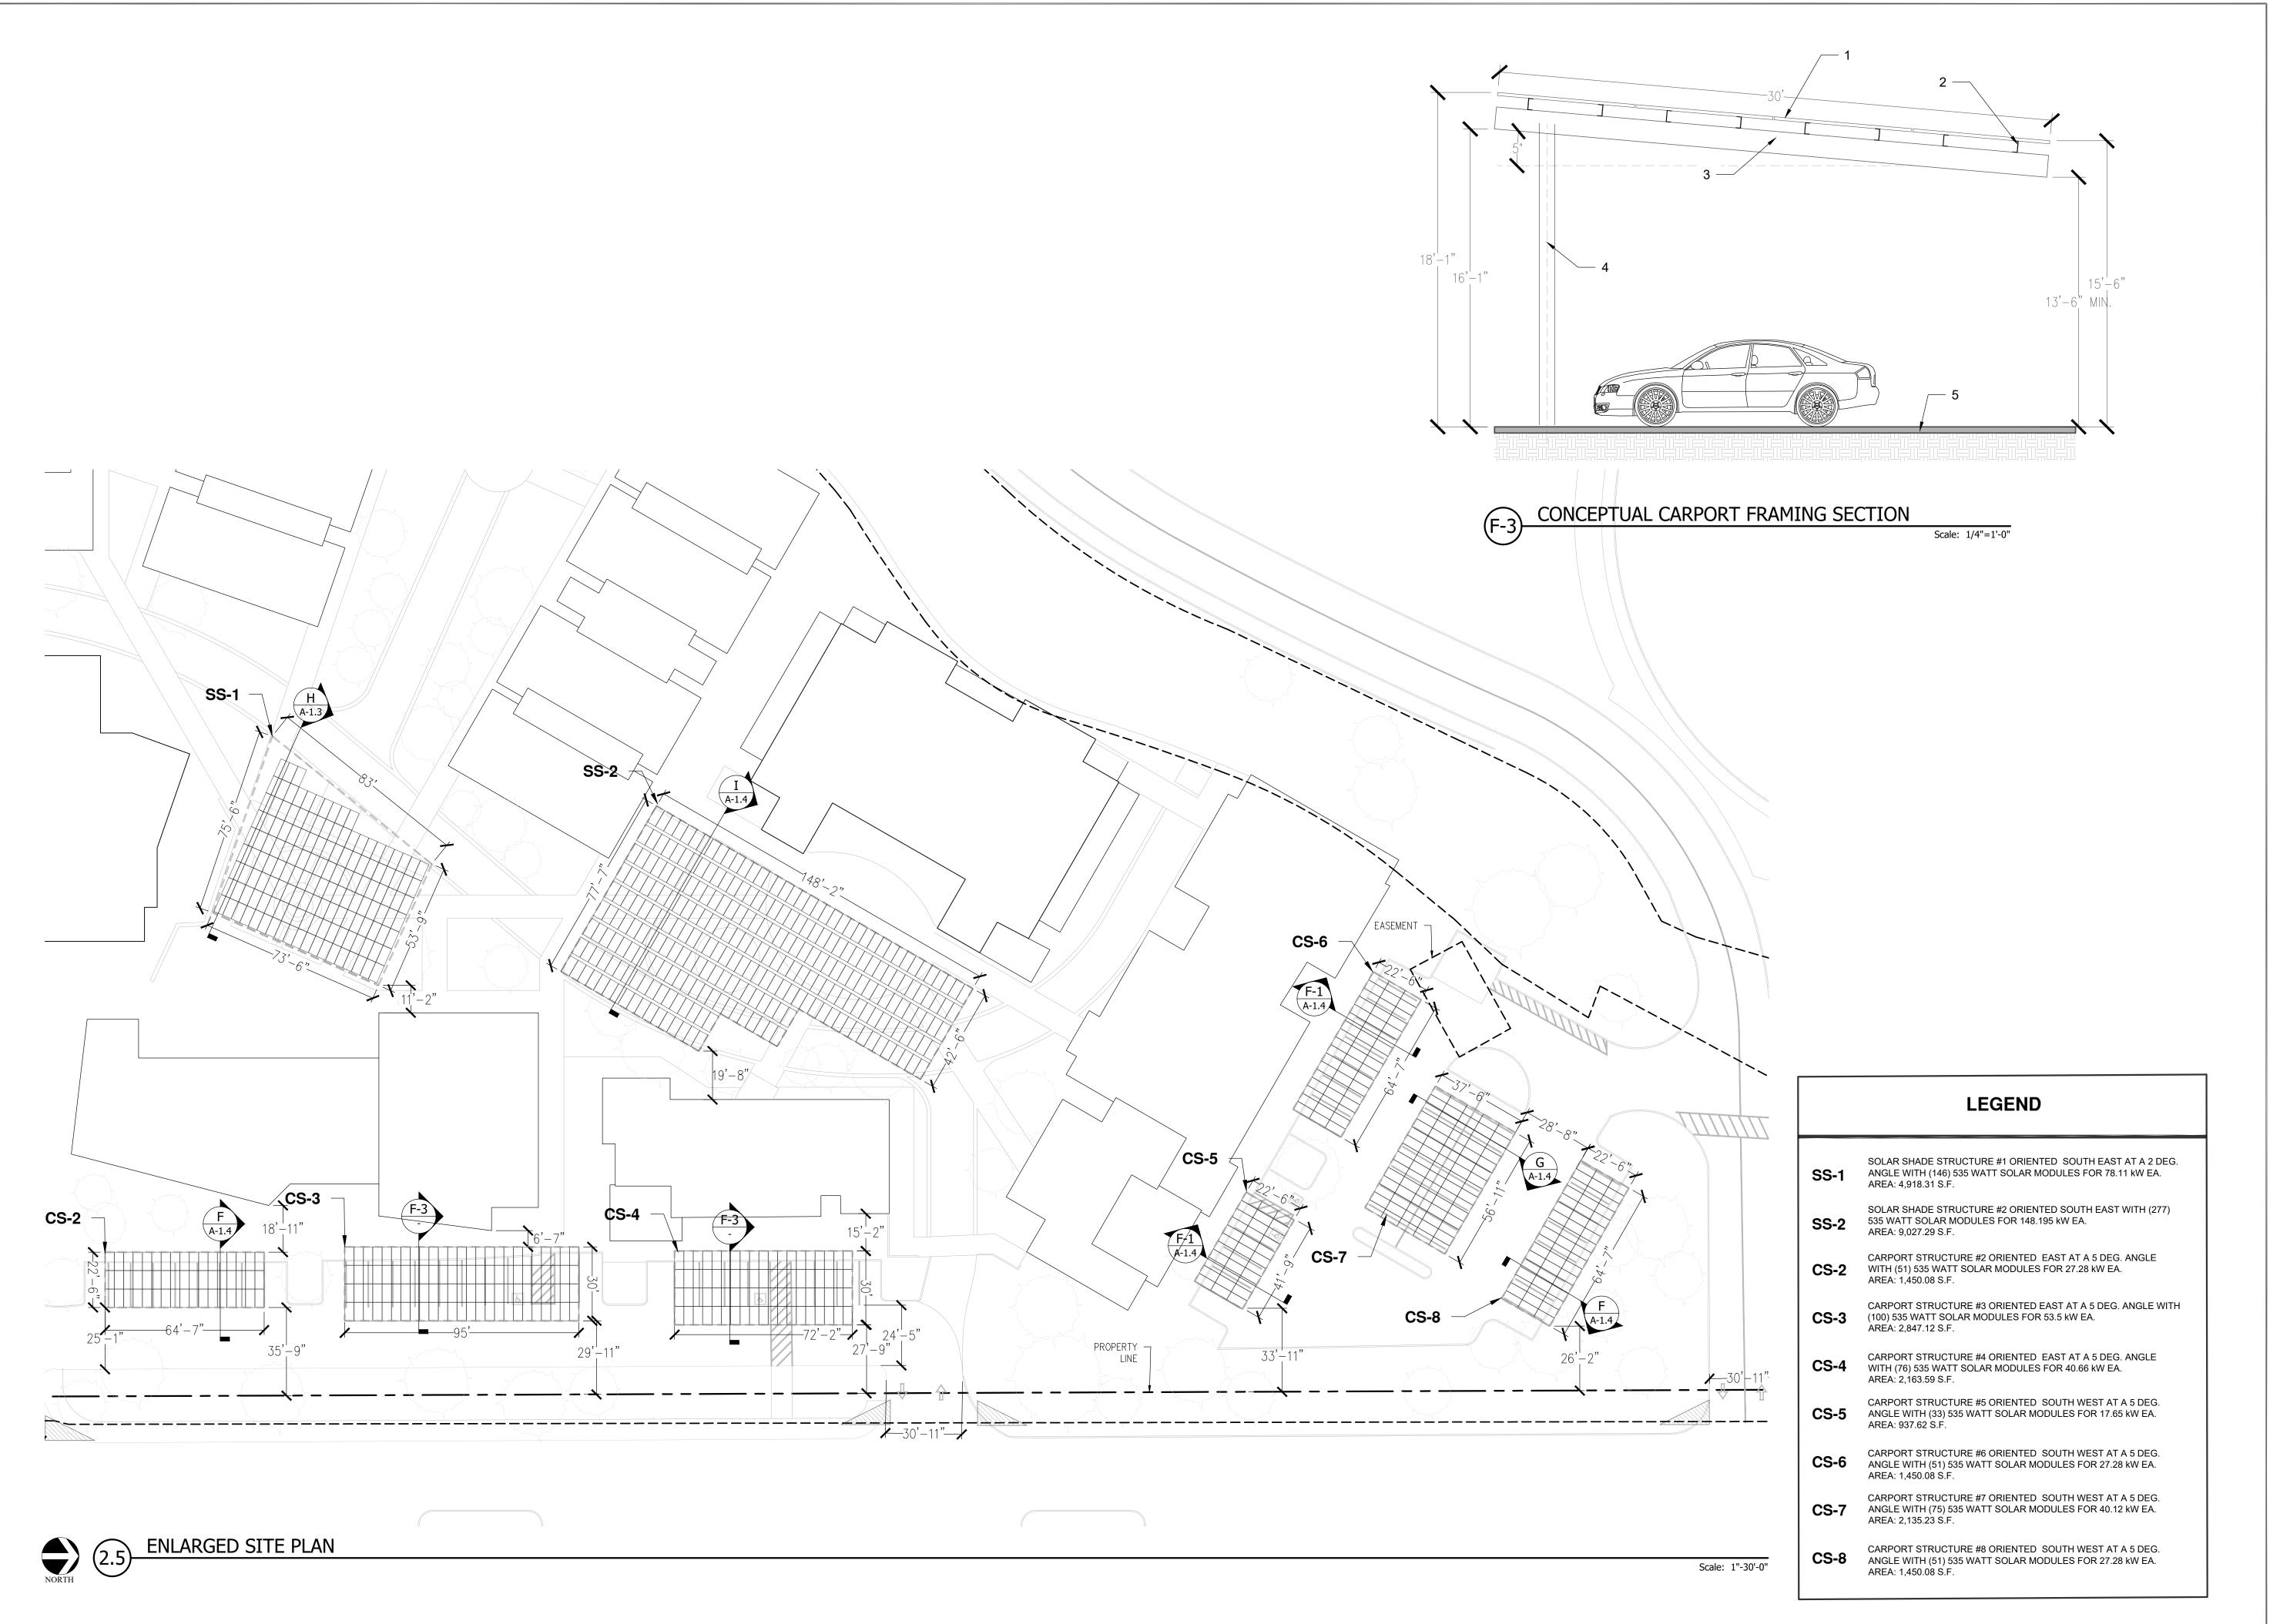
COMMENTS/CHANGES 1 AG 01.05.2023

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**ENLARGED** SITE PLAN

PROJECT#: 22-112-1110





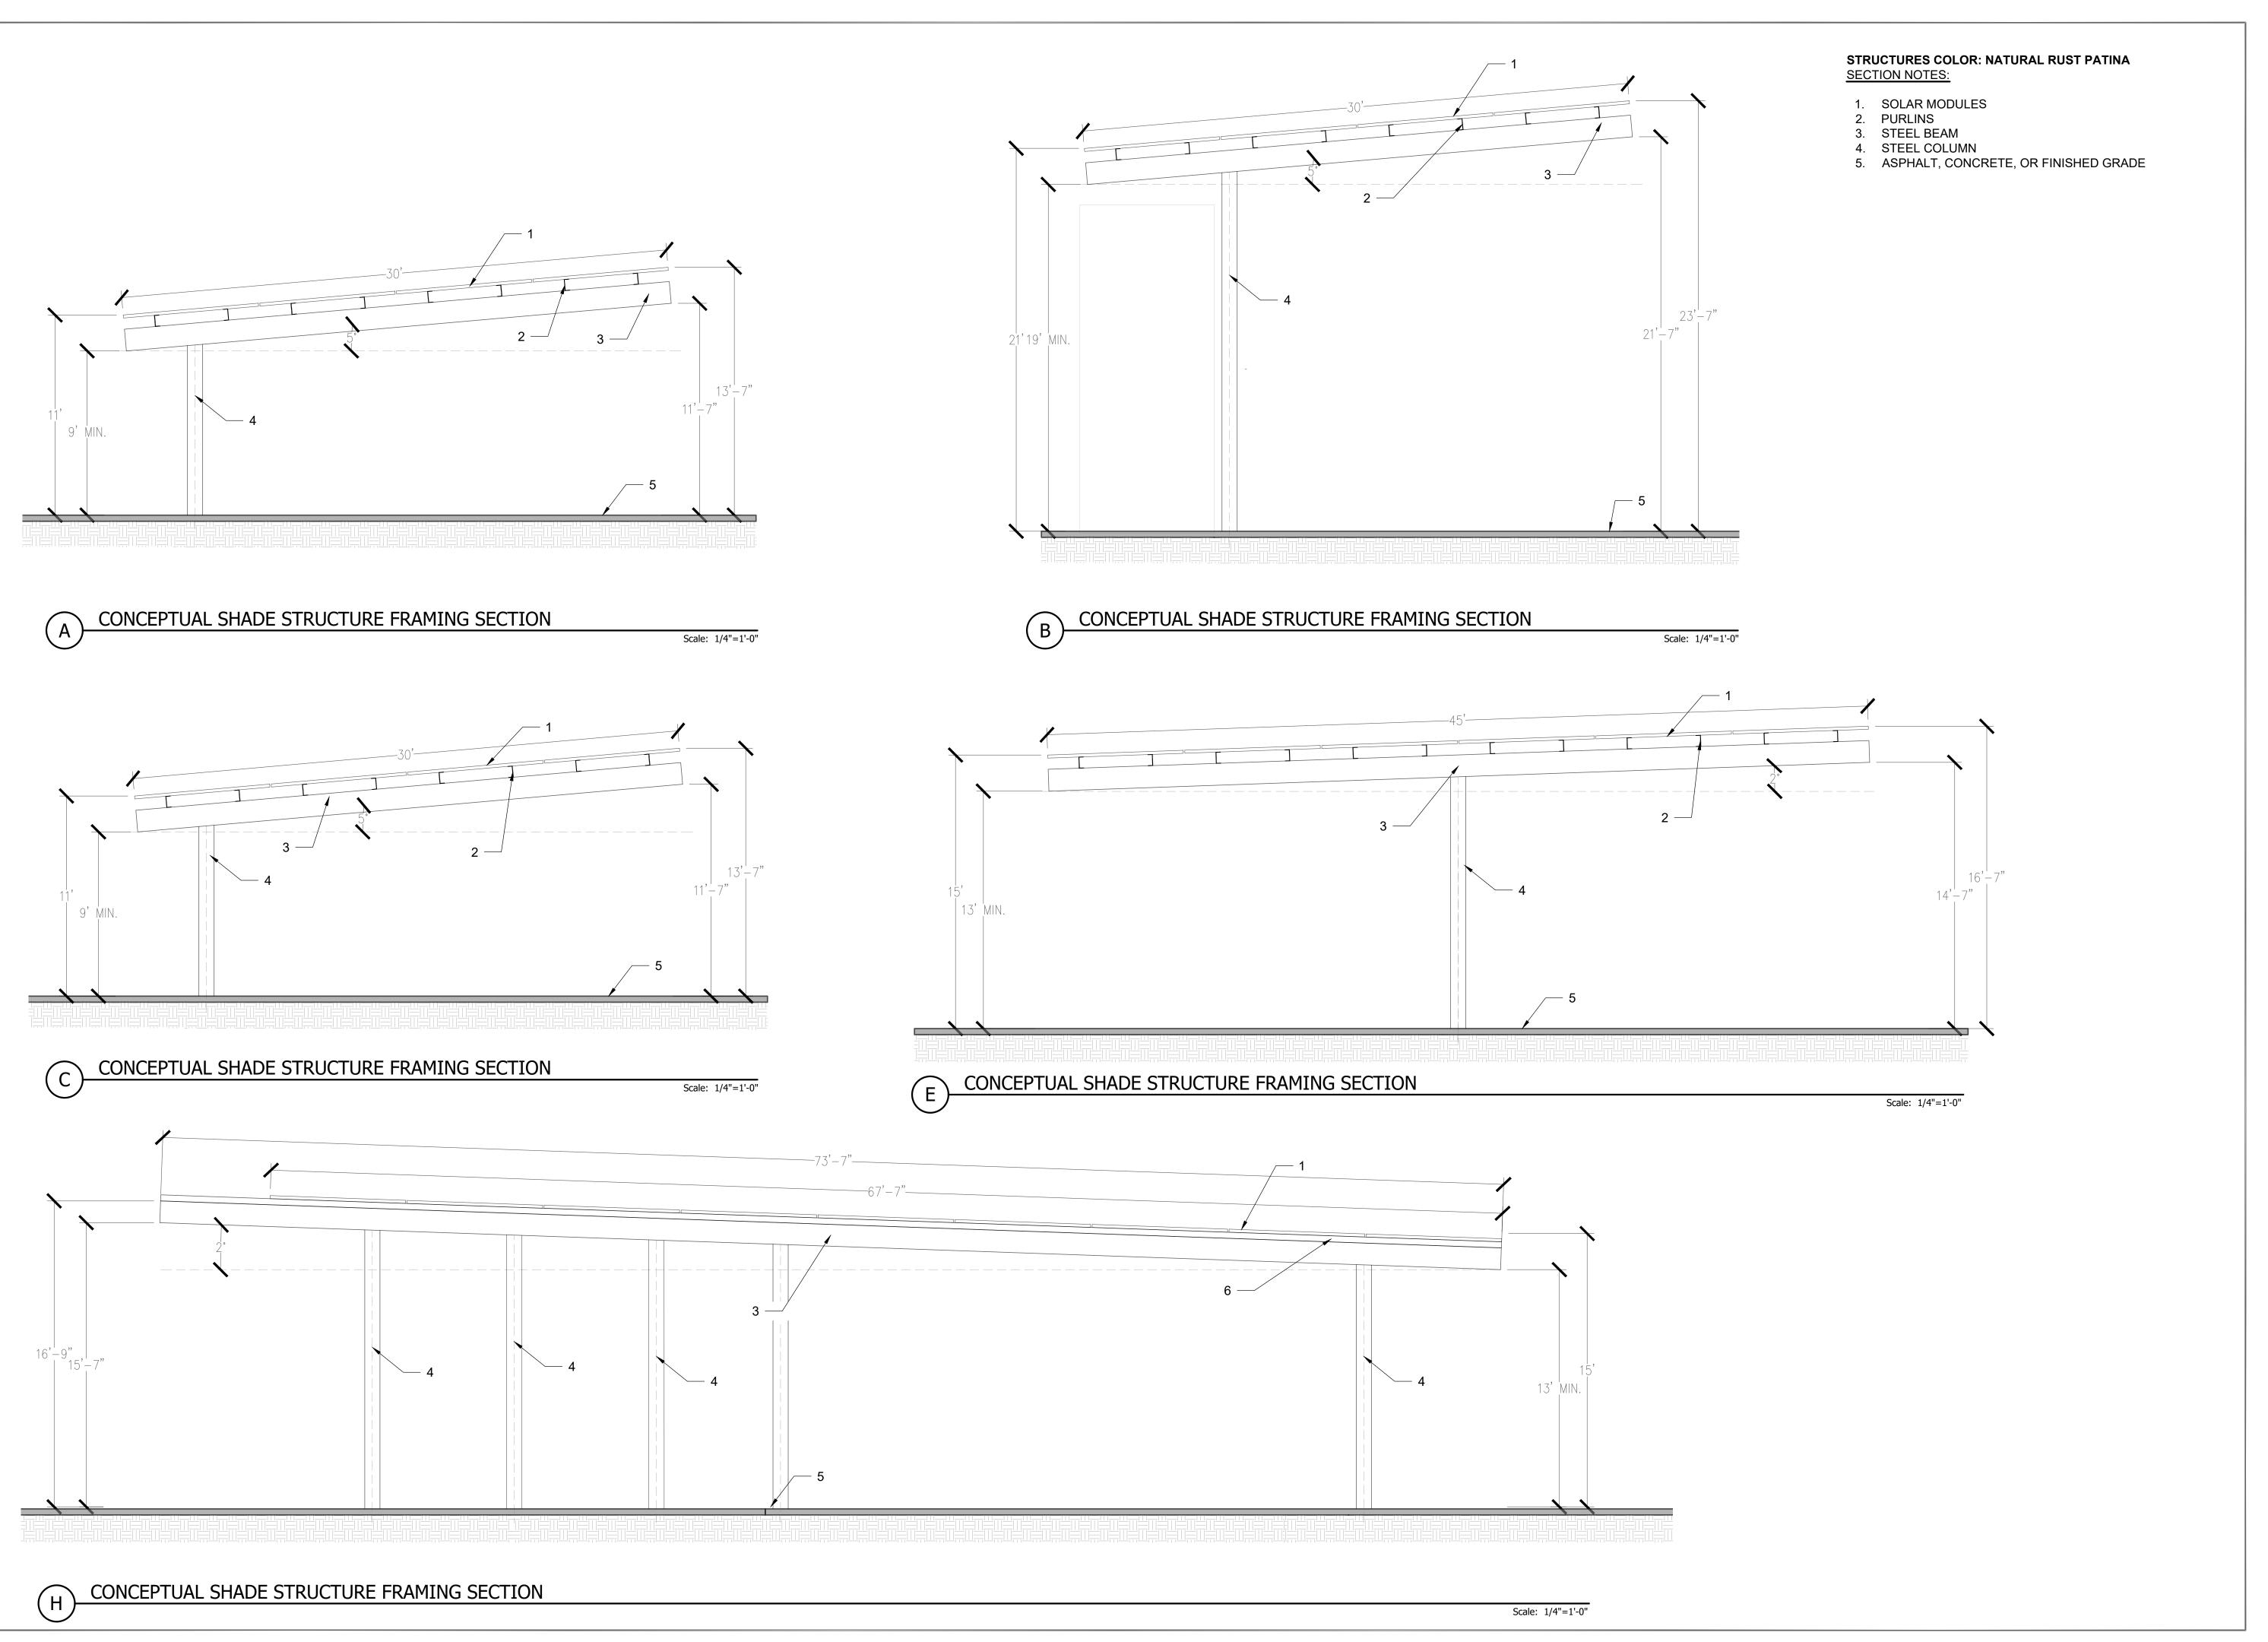
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**ENLARGED** SITE PLAN

PROJECT#: 22 - 112 - 1110





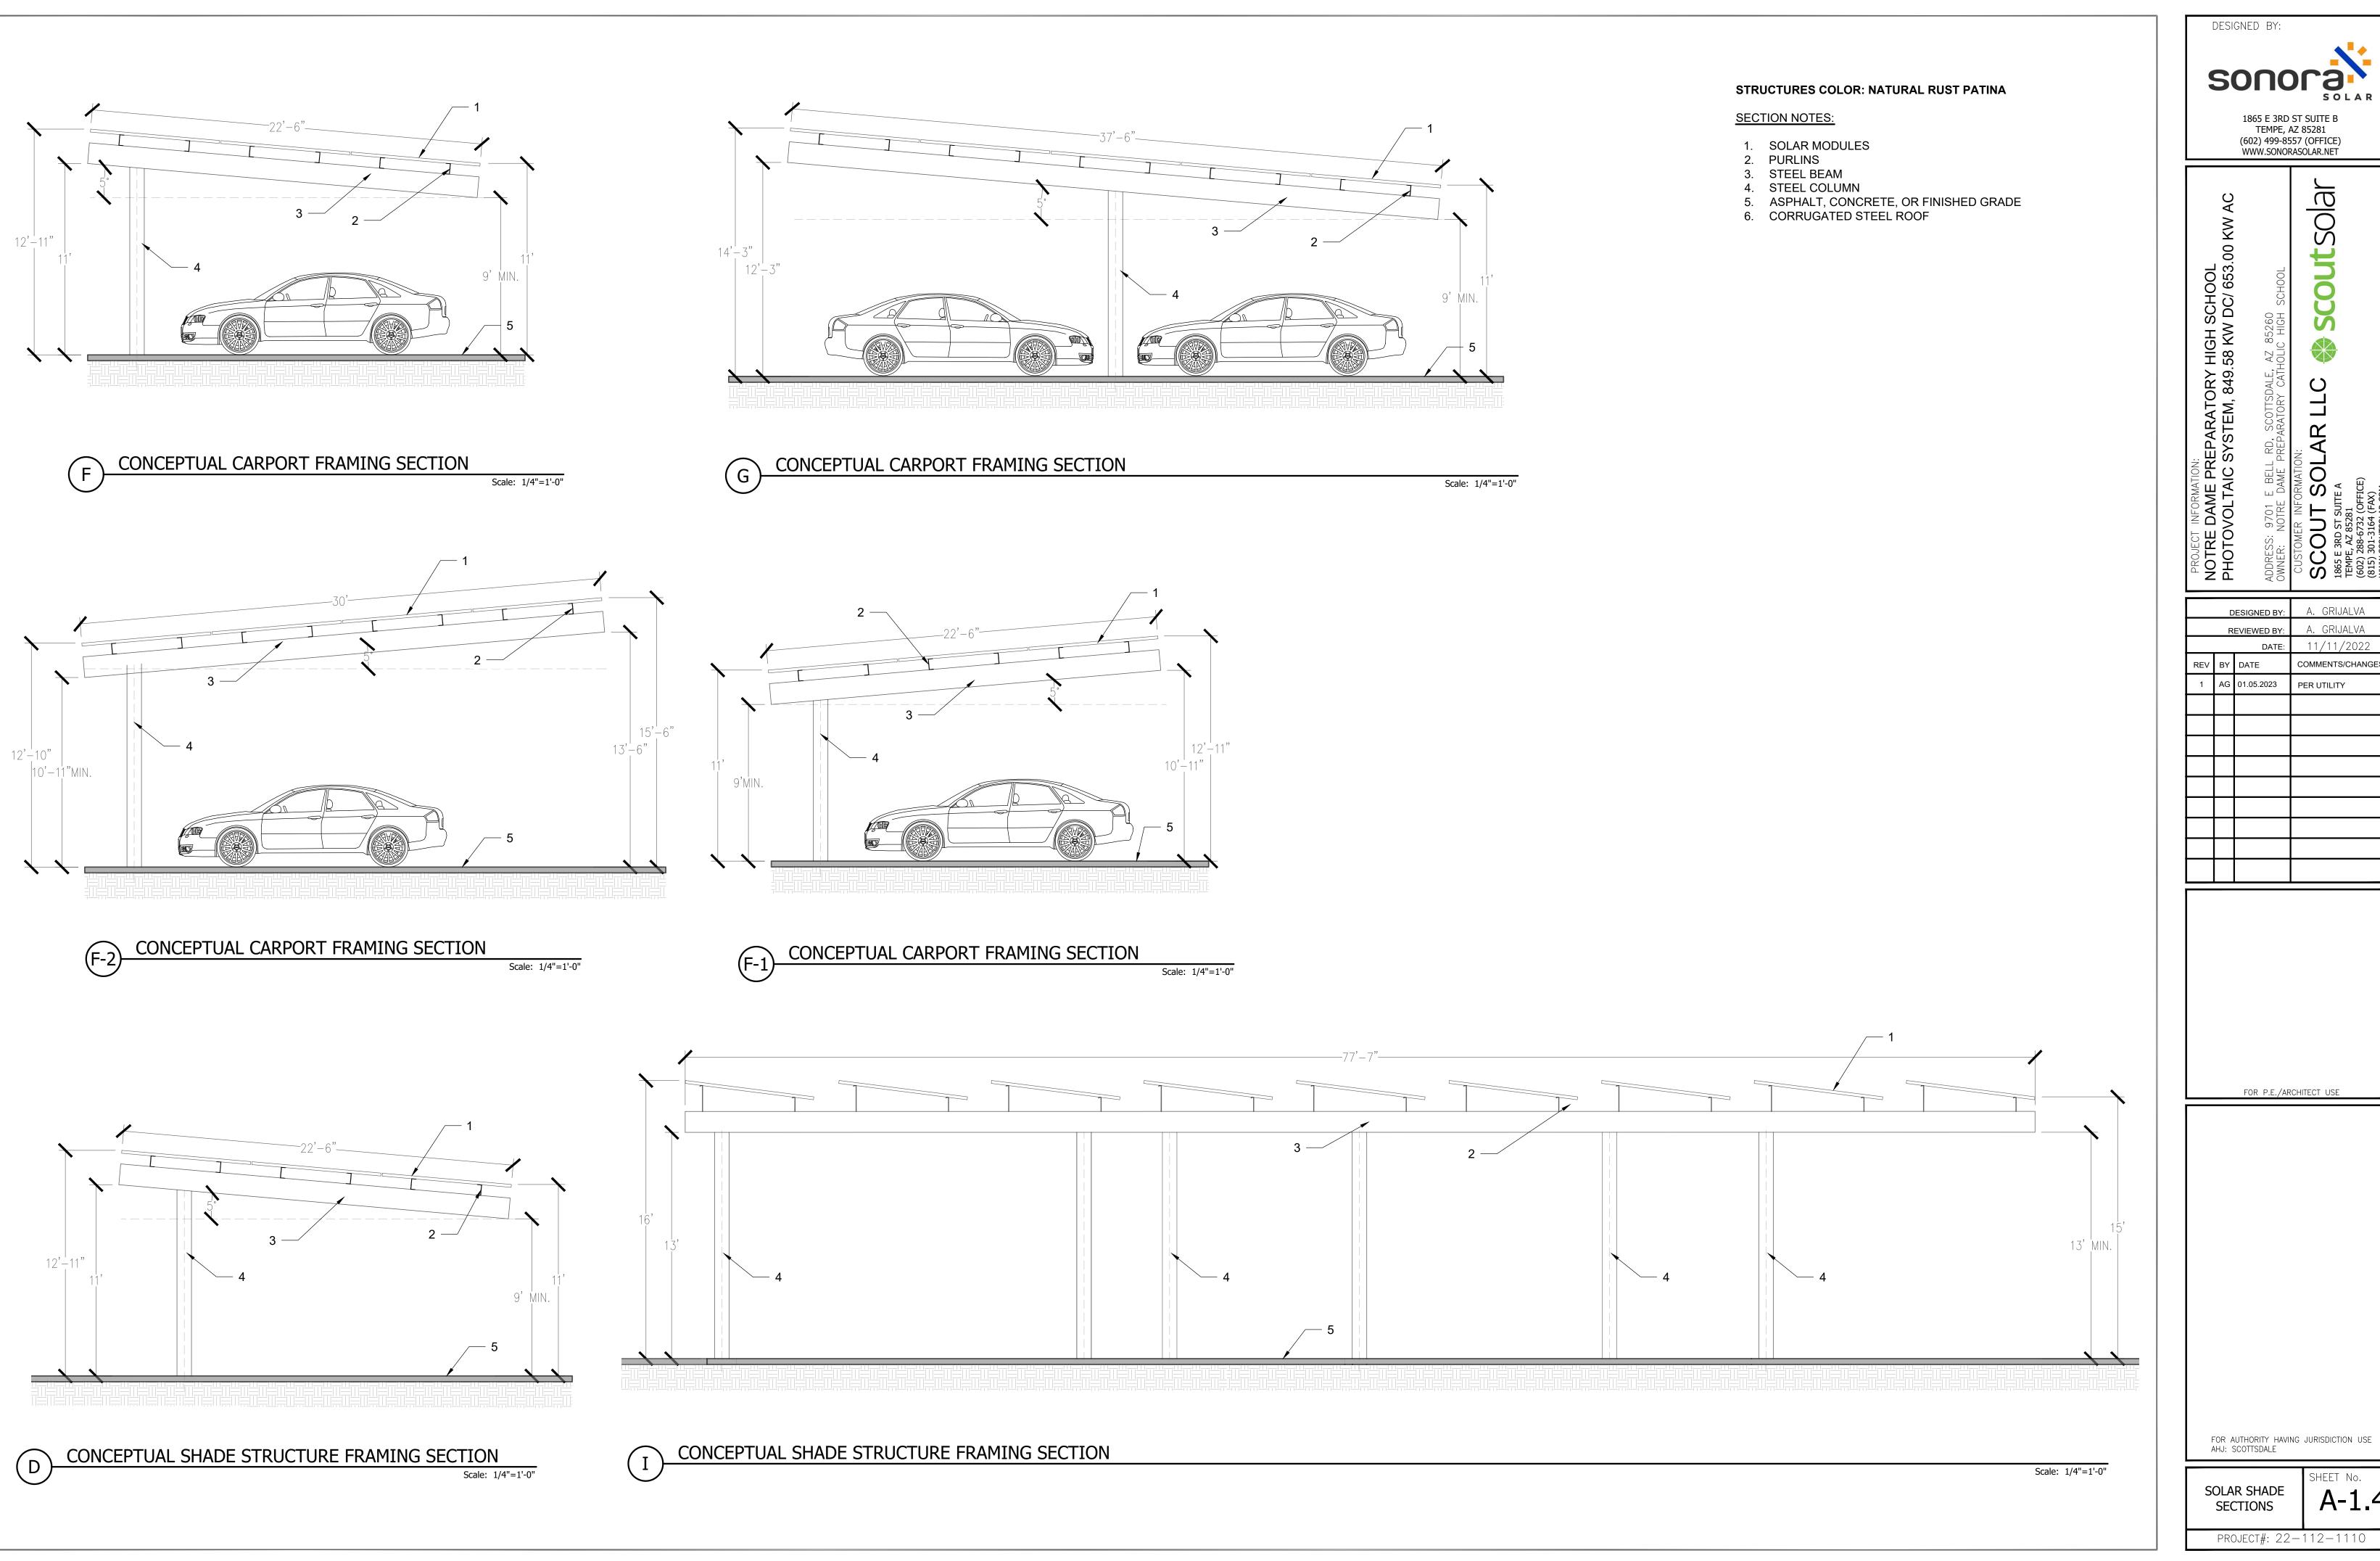
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SOLAR SHADE SECTIONS A-1.3

PROJECT#: 22-112-1110





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SOLAR SHADE SECTIONS