PRELIMINARY WATER REPORT FOR

Marshall Way Mixed Use

PREPARED FOR
SYNECTIC DESIGN
1111 WEST UNIVERSITY DRIVE
SUITE 104
TEMPE, AZ 85281

PREPARED BY


R.B. Williams & Associates, Inc. 1921 S. Alma School Road, Suite 101 Mesa, AZ 85210 (480) 424-2352

RBW #22048



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1.0 INTRODUCTION

1.1 SCOPE

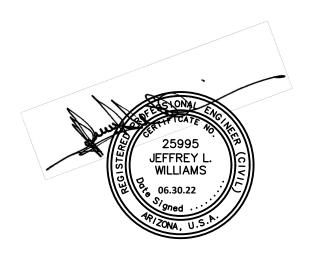The scope of this Basis of Design is to provide a basis of design analysis for the Marshall Way Mixed Use project. This new development is a mixed-use project which includes one 4-story building with 13,717 sf of commercial use on the first floor, 60 residential units on the 2nd, 3rd, and 4th floors and underground parking in the basement. The area of the site is approximately 38,189 square feet.

This report will discuss the concepts for the domestic water distribution system analysis relating to this project. This report will follow the design procedures outlined by the City of Scottsdale's Design Standards & Policies Manual.

1.2 LOCATION

The proposed project lies in the City of Scottsdale at the Southeast corner of N. Marshall Way and E. 3rd Avenue. This project is in Section 22, Township 2 North, Range 4 East of the Gila and Salt River Base and Meridian, Maricopa County. The approximate gross area of the site is 57,337 square feet. The site is surrounded by E. 3rd Avenue on the North, N. Marshall Way on the West, existing commercial development on the South, and an alley on the East.

See Figure 1-Vicinity Map in Appendix A.

1.3 EXISTING CONDITIONS

The site currently consists of an existing single-story commercial building, and an asphalt parking lot.

There are existing City of Scottsdale water distribution mains available in N. Marshall Way and E. 3rd Avenue. There is a 6" ACP main in N. Marshall Way and another 6" ACP main in E. 3rd Avenue. The city's as-builts indicate that there are two existing water meters serving the site, one from the main in N. Marshall Way and one from the main in E. 3rd Avenue. There also appear to be three existing fire hydrants surrounding the property.

2.0 PROPOSED IMPROVEMENTS

The new development consists of one 4-story, mixed use structure. The first floor will contain 13,717 square feet of commercial space. The 2nd, 3rd, and 4th floors will consist of 60 residential units with parking provided in a basement parking garage.

The project is designed to use the existing water services for domestic water with additional taps for the fire sprinkler system.

3.0 DESIGN CRITERIA

City of Scottsdale requires the following criteria for this project:

- 1. Fire Flow Required is 1500 gpm for commercial, industrial, and multi-family residential project.
- 2. Minimum of 30 psi with a max static pressure of 120 psi and residual pressure of 50 psi

4.0 DESIGN DEMAND

The post-construction onsite demands were calculated using the City of Scottsdale Design Standards & Policies Manual and the 2018 IFC.

Per City of Scottsdale, the average daily consumption for this project will be Gallons/Day/Unit. See Tables 1 & 2 below for domestic water calculations.

Table 1: 13,717 sf Commercial

Building ID	Area (sf)	Design Flow (gal/day/sf)	Average Day Demand (gpm)	Peak Hour Demand (gpm)
First Floor Commercial	13,717	0.8	7.6	27


Table 2: 60 Residential Units

Building ID	Number of Units	Design Flow (gal/day/unit)	Average Day Demand (gpm)	Peak Hour Demand (gpm)
Residential Units	60	185.3	7.7	27

A hydrant flow test has not been performed as of this date.

APPENDIX A

VICINITY MAP & PROPOSED LAYOUT

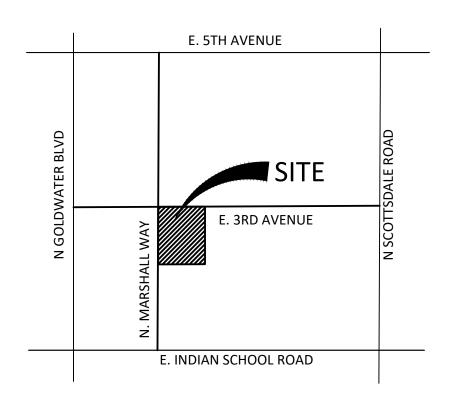

VICINITY MAP

T2N, R4E, S 22 (N.T.S.)

R.B. WILLIAMS & ASSOCIATES, INC.

CONSULTING ENGINEERS


1921 S. ALMA SCHOOL ROAD, SUITE 101 PHONE: (480) 424-2352 MESA, ARIZONA 85210 FAX: (480) 424-2353




PRELIMINARY UTILITY PLAN

MARSHALL AVENUE MIXED USE DEVELOPMENT

4151 N. MARSHALL AVENUE SCOTTSDALE, AZ 85251

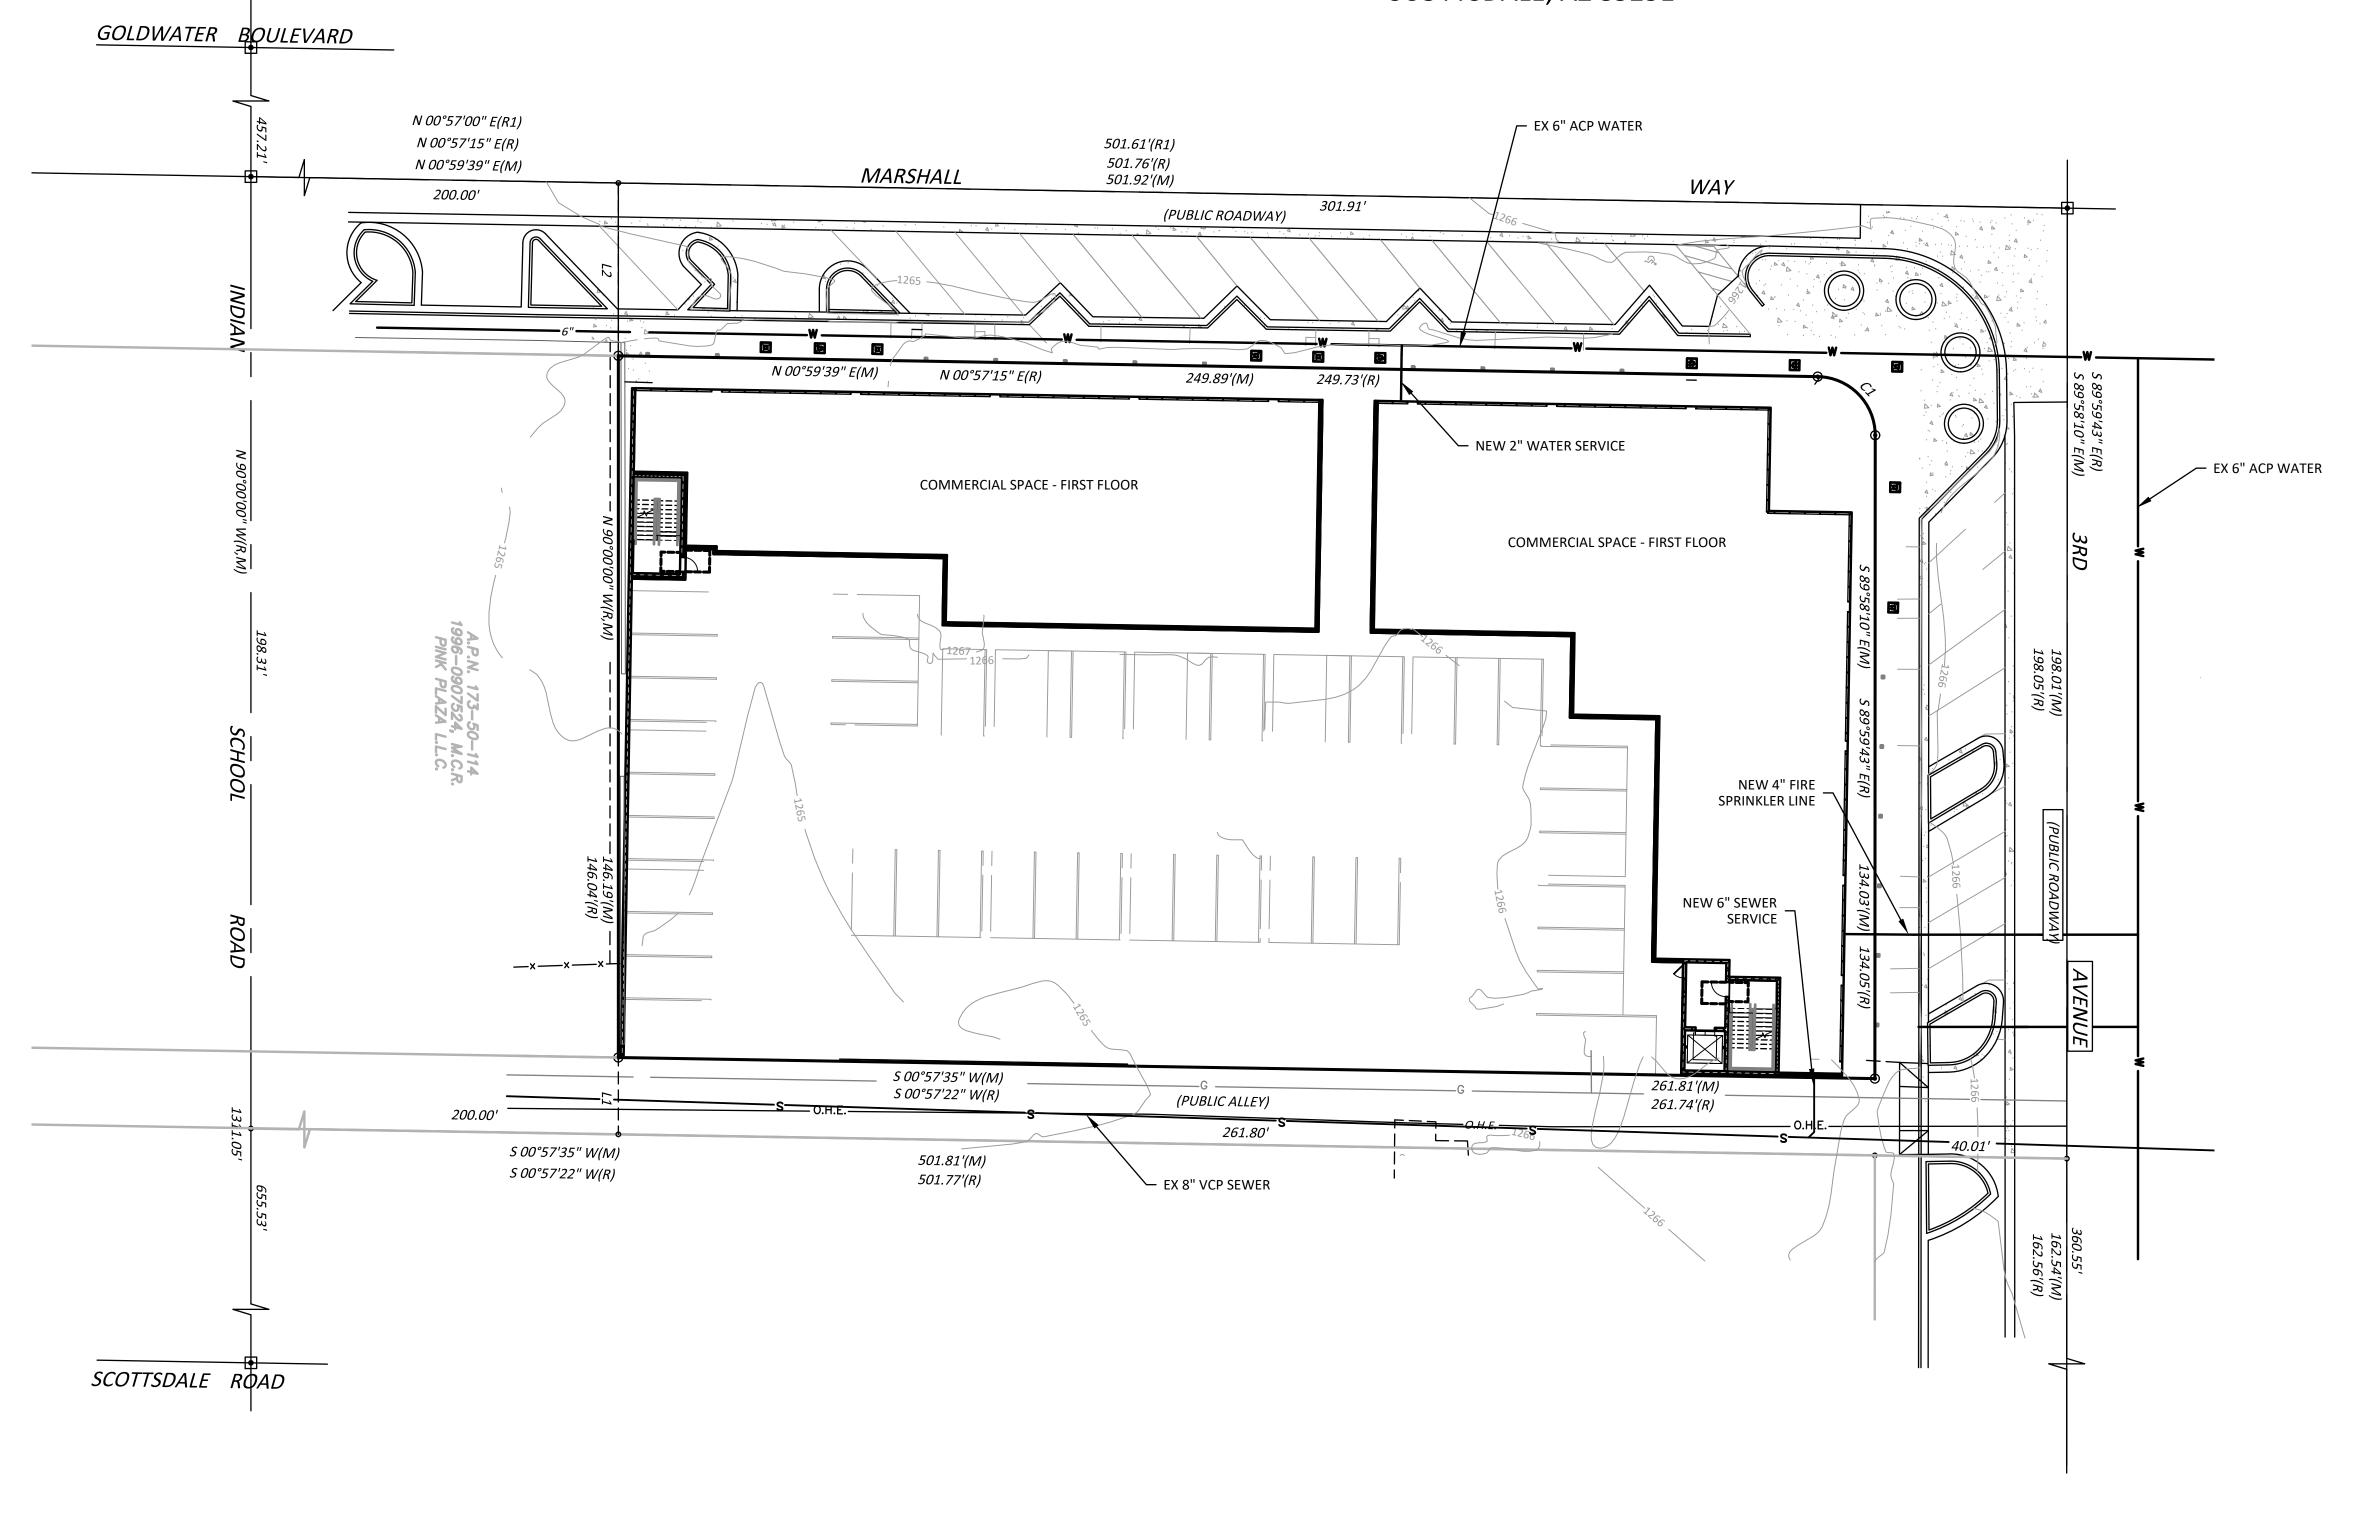

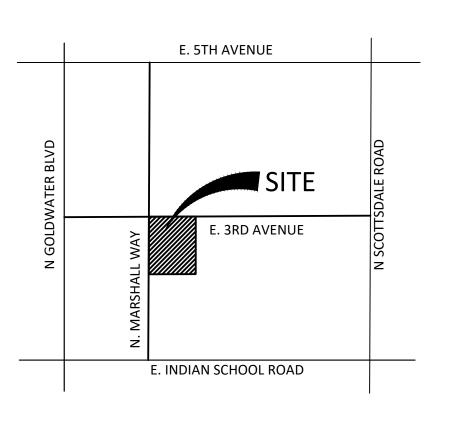

VICINITY MAP T2N, R4E, S 22 (N.T.S.)

ENGINEER

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ARCHITECT/DESIGNER

SYNECTIC DESIGN 1111 W. UNIVERSITY DRIVE SUITE 104 TEMPE, AZ 85281 PHONE: 480.948.9766 CONTACT: DAVE HAMBLEN

PROPERTY AREA

NET AREA: 38,189 SF GROSS AREA: 57,337 SF

BENCHMARK

FOUND NGS MONUMEN "AJ3679", BEING PID # 1DH1 ELEVATION: 1344.495 DATUM: CITY OF SCOTTSDALE NAVD 88

PROJECT DESCRIPTION

NEW 4-STORY MIXED USE PROJECT WITH 13,717 SF OF COMMERCIAL SPACE ON THE FIRST FLOOR AND 65 RESIDENTIAL UNITS ON FLOORS 2-4. PARKING WILL BE PROVIDED IN A BASEMENT PARKING GARAGE. THE SITE IS CURRENTLY A 1-STORY COMMERCIAL CENTER. THE EXISTING COMMERCIAL CENTER WILL BE DEMOLISHED PRIOR TO CONSTRUCTION OF THE NEW 4-STORY MIXED USE

LEGAL DESCRIPTION

LOT 19, OF MARSHALL WAY PLAZA, ACCORDING TO THE PLAT OF RECORD IN THE OFFICE OF THE COUNTY RECORDER OF MARICOPA COUNTY, ARIZONA RECORDED IN BOOK 718 OF MAPS, PAGE 35.

A.P.N.: 173-50-129



SCALE: 1"=20'

VELOPMENT

ARSHALL USE DEVE

PRELIMINARY

DESIGN JLW DRAWN JLW

CHK'D HRW

22048UP01.DWG

SHEET NO.

SUB.