
SHEET SYMBOLS

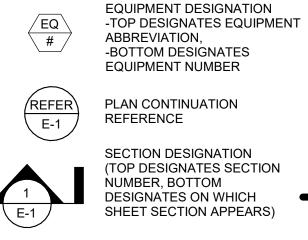

PLAN CONTINUATION REFERENCE SECTION DESIGNATION

(TOP DESIGNATES SECTION NUMBER, BOTTOM DESIGNATES ON WHICH SHEET SECTION APPEARS)



DETAIL REFERENCE (TOP=DETAIL NO., BOTTOM=DRAWING NO. SHOWN ON)

E/15B-6 DETAIL REFERENCE

EQUIPMENT AND WIRING

	MOTOR	J	SURFACE JUNCTION BOX				
T	TRANSFORMER	—(J)	SURFACE JUNCTION BOX - W				
	PANELBOARD SURFACE MOUNTED	J	FLUSH JUNCTION BOX - CEIL				
		— J	FLUSH JUNCTION BOX - WAL				
	PANELBOARD	$\langle J \rangle$	FLUSH JUNCTION BOX - FLOO				
	FLUSH MOUNTED	R	RELAY - TYPE AS NOTED				
	DISTRIBUTION PANELBOARD (NOT TO SCALE)	K	KIRK KEY INTERLOCK				
MCC	MOTOR CONTROL CENTER		NON-FUSED DISCONNECT S				
VFD	VARIABLE FREQUENCY DRIVE	Ε¬	FUSED DISCONNECT SWITCH				
ATS	AUTOMATIC TRANSFER SWITCH	В	ENCLOSED CIRCUIT BREAKE				
XX-XX		\bowtie	MAGNETIC MOTOR STARTER				
	PANEL DIVISION ARROW		COMBINATION MOTOR STAR				
	PANEL DIVISION LINE		PUSH BUTTON				
CT	CABLE TAP BOX	••	PUSH BUTTON - DOUBLE				
	BUSWAY PLUG-IN UNIT	ı •	GROUND CONNECTION				
GEN	REMOTE GENERATOR ANNUNCIATOR	G I	REMOTE GROUND INDICATO				
		G _P	ROOM REFERENCE GROUND				
		\otimes	AIR TERMINAL				
HHL.	HOMERUN	\odot	GROUND ROD				
A-1,		\otimes	GROUND ROD WITH TEST WI				
INDICATES NUMBER OF CONDUCTORS							

INDICATES NEUTRAL CONDUCTOR INDICATES GROUND CONDUCTOR

A-1,3,5 = PANEL AND CIRCUITS: PANEL A, CIRCUITS 1,3,5

ELECTRICAL SYMBOLS AND ABBREVIATIONS

NOTES: 1. EXISTING TO REMAIN IS SHOWN WITH LIGHT LINES. 2. NEW WORK IS SHOWN WITH SOLID HEAVY LINES.

3. DEMOLITION IS SHOWN WITH HEAVY DASHED LINES. 4. ALL DIMENSIONS ARE CENTERLINE MEASURED FROM FINISHED FLOOR UNLESS OTHERWISE NOTED.

LIGHTING

ELECTRICAL ABB

Т		UNSHADED REGION DESIGNATES LUMINAIRE FOR NORMAL OPERATION
		 SHADED REGION DESIGNATES LUMINAIRE FOR LIFE SAFETY OPERATION SHADED REGION DESIGNATES LUMINAIRE FOR CRITICAL OPERATION
<	1 GENERAL OR SHEET NOTES REFERENCE	LUMINAIRE ID - SEE <u>SUFFIX</u> <u>DESCRIPTION</u>
(POINT OF NEW CONNECTION TO EXISTING	X# E BATTERY PACK/INVERTER
	MATCHLINE DESIGNATION	CIRCUIT/SWITCH ARROW ADDED TO LOMINAIRE SYMBOL TO INDICATE DIRECTION TOWARDS WHICH THE LUMINAIRE IS TO POINT.
		LUMINAIRE SYMBOLS - REFER TO LUMINAIRE SCHEDULE FOR MORE INFORMATION
		✓ TRACK HEAD CEILING MOUNTED LUMINAIRES RECESSED
ND WI	RING	
J :	SURFACE JUNCTION BOX	
_	SURFACE JUNCTION BOX - WALL FLUSH JUNCTION BOX - CEILING	
- J	FLUSH JUNCTION BOX - WALL	PENDANT/SUSPENDED
	FLUSH JUNCTION BOX - FLOOR RELAY - TYPE AS NOTED	
Κ	KIRK KEY INTERLOCK	
	NON-FUSED DISCONNECT SWITCH	WALL MOUNTED LUMINAIRES RECESSED
		₽ ₽ ₽ ₽ ₽
	ENCLOSED CIRCUIT BREAKER MAGNETIC MOTOR STARTER	SURFACE MOUNTED
\square	COMBINATION MOTOR STARTER	
	PUSH BUTTON	FLOOR OR GRADE MOUNTED LIGHTS
	PUSH BUTTON - DOUBLE	
' I		
	REMOTE GROUND INDICATOR	
	AIR TERMINAL	
C		
S UCTORS	GROUND ROD WITH TEST WELL	BOLLARD OR GROUND MOUNTED LUMINAIRE INGRADE/IN-SLAB LUMINAIRE
TOR TOR		
JITS 1,3,5	5	EXIT SIGNS - CEILING MOUNTED SINGLE FACE OUBLE FACE - DIRECTIONAL ARROW
		EXIT SIGNS - WALL MOUNTED SINGLE FACE HOUBLE FACE HOUBLE FACE KROW
		EMERGENCY FIXTURE WITH BATTERY PACK SINGLE HEAD

		יוסכ
A AC	- AMPERES - ABOVE CEILING / ALTERNATING CURRENT	LAN LED LI
ADO AF	- AUTOMATIC DOOR OPENER - AMPERE FRAME	LSI
AFCI AFF	- ARC FAULT CIRCUIT INTERRUPTER - ABOVE FINISHED FLOOR	LSIA ALA
AIC ALT	- AMP INTERRUPTING CAPACITY - ALTERNATE	LSIC
ARCH ASC AT	- ARCHITECTURAL - ABOVE SUSPENDED CEILING - AMPERE TRIP	LTC LTG
ATC ATS	- AMPERE TRIP - ASTRONOMIC TIME CLOCK - AUTOMATIC TRANSFER	LTG LTS LV
AUTO	SWITCH - AUTOMATIC	MAT
BC BFC	- BARE COPPER - BELOW FINISH CEILING	MC MCE MCC
BFL BLDG	- BELOW FLOOR LEVEL - BUILDING	MCF MEF
BPIP BRKR	- BOILER PLANT INSTRUMENTATION PANEL - BREAKER	MH MIC
C		MICI MLC
CB CCTV CFCI	- CIRCUIT BREAKER - CLOSED CIRCUIT TELEVISION - CONTRACTOR FURNISHED,	MPT MTC MTC
CLG	CONTRACTOR INSTALLED - CEILING	MTO MTF
CKT CO CONTR	- CIRCUIT - CONDUIT ONLY - CONTRACTOR	MV NA
CORR CR	- CORRIDOR - CONTROL RELAY	NAC
CT DB	- CURRENT TRANSFORMER - DIRECT BURIAL	NC NEC NIC
DC DED	- DIRECT CURRENT - DEDICATED	NO NTS
DET DIA DISC	- DETAIL - DIAMETER - DISCONNECT	OC OFC
DN DP	- DOWN - DISTRIBUTION PANEL	OFC
DS EC	- DISCONNECT SWITCH - ELECTRICAL CONTRACTOR	Р
EDB EGC	ELECTRIC DUCT BANKEQUIPMENT GROUND	PA PB
EGS EJ	CONDUCTOR - ENGINE GENERATOR SET - EXPANSION JOINT	PC PDU
ELEC ELL	- ELECTRIC / ELECTRICAL - EMERGENCY LIFE SAFETY	PF PH
ELP	LIGHTING - EMERGENCY LIFE SAFETY POWER	PLB PNL POE
EM/EMER EMI	- EMERGENCY - ELECTROMAGNETIC	PS PT
EMT EQUIP	INTERFERENCE - ELECTRICAL METALLIC TUBING - EQUIPMENT	PTR PWF
ER ERL	- EXISTING TO BE REMOVED - EXISTING TO BE RELOCATED	REC
ERMS ESM	- ENERGY-REDUCING MAINTENANCE SWITCH - ELECTRIC STRIP MOLD	REC REF REL
EWC EX	- ELECTRIC WATER COOLER - EXISTING TO REMAIN	REG
FA FACP	- FIRE ALARM - FIRE ALARM CONTROL PANEL	RVA
FCU FDR	- FAN COIL UNIT - FEEDER	SCC
FDS FIXT FL	- FUSED DISCONNECT SWITCH - FIXTURE	SHT SIG
FL FLA FLEX	- AT FLOOR LINE - FULL LOAD AMPERES - FLEXIBLE	SIM SPD SPE
FLR FLUOR	- FLOOR - FLUORESCENT	SS SSB
FS FSCP	 FLOW SWITCH FLAME SAFEGUARD CONTROL PANEL 	STA STR
FVNR	- FULL VOLTAGE NON- REVERSING	SW SWE SWC
GC GE	- GENERAL CONTRACTOR - GROUNDING ELECTRODE	TEL
GEN GFA	- GENERATOR - GROUND FAULT ALARM	TFA TFB
GFCI GFI	 GROUND FAULT CIRCUIT INTERRUPTER GROUND FAULT INTERRUPTER 	TS TV
GFP GND	- GROUND FAULT PROTECTION - GROUND	TVT
GTB HH	- GROUND TERMINAL BOX - HANDHOLE	TYP UC
HOA HP	- HAND OFF AUTOMATIC - HORSE POWER	UG UH
HT HV	- HEIGHT / HEAT TRACE - HIGH VOLTAGE	UNC UPS
IMC INV	 INTERMEDIATE METAL CONDUIT INVERTER 	V VFD
INV J or JB	- INVERTER - JUNCTION BOX	VP
KV KVA	- KILOVOLT - KILOVOLT-AMPERES	W W/ WP
KVA KW KWH	- KILOVOLT-AMPERES - KILOWATTS - KILOWATT HOURS	WP WS WT
		XFM

/IA ⁻	TIONS
	- LOCAL AREA NETWORK
	- LIGHT EMITTING DIODE - LONG-TIME/INSTANTANEOUS LONG TIME/SHORT TIME/
	- LONG-TIME/SHORT-TIME/ INSTANTANEOUS
_	- LONG-TIME/SHORT-TIME/ INSTANTANEOUS/GROUND
Λ	- LONG-TIME/SHORT-TIME/
	INSTANTANEOUS/GROUND - LOCAL TEMPERATURE
	CONTROL PANEL - LIGHTING
	- LIGHTS - LOW VOLTAGE
	- MASTER ANTENNA TELEVISION
	- MECHANICAL CONTRACTOR - MAIN CIRCUIT BREAKER
	- MOTOR CONTROL CENTER - MOTOR CIRCUIT PROTECTOR
	- MECHANICAL EQUIPMENT ROOM
	- MANHOLE - MICROPHONE
)	- MICROWAVE - MAIN LUGS ONLY
	- MUSIC & PAGE TERMINAL BOX - MOUNTED
IGT	- MOUNTING
	- MOTOR / METER - MEDIUM VOLTAGE
	- NOT APPLICABLE
	- NOT APPLICABLE - NOTIFICATION APPLIANCE CIRCUIT
	- NORMALLY CLOSED - NATIONAL ELECTRICAL CODE
	- NOT IN CONTRACT
	- NORMALLY OPEN - NOT TO SCALE
	- OWNER FURNISHED, CONTRACTOR INSTALLED
	- OWNER FURNISHED, OWNER INSTALLED
	- PUBLIC ADDRESS - PULL BOX / PUSHBUTTON
	- PLUMBING CONTRACTOR / PHOTOCELL
	- POWER DISTRIBUTION UNIT - POWER FACTOR
	- PHASE - PLUMBING
	- PANEL - POWER OPERATED DAMPER
	- POWER SUPPLY - POTENTIAL TRANSFORMER
	- POWER TYPE ROOF VENTILATOR
	- POWER
5	- RECESSED - RECEPTACLE
	- REFRIGERATOR - RELOCATED
	- REQUIRED - RIGID METAL CONDUIT
	- REDUCED VOLTAGE AUTO TRANSFORMER
	- SHORT CIRCUIT CURRENT
	RATING - SHEET
	- SIGNAL - SIMILAR
	- SURGE PROTECTIVE DEVICE - SPECIFICATION
	- SAFETY SWITCH - SUPPLY SIDE BONDING
	JUMPER - STATION
	- STARTER - SWITCH
	- SWITCHBOARD - SWITCHGEAR
	- TELEPHONE
	- TO FLOOR ABOVE - TO FLOOR BELOW
	- TAMPER SWITCH / TIME SWITCH
	- TELEVISION - TELEVISION TERMINAL
	- TELEVISION TERMINAL CABINET - TYPICAL
	- TYPICAL - UNDER COUNTER
	- UNDER COUNTER - UNDERGROUND - UNIT HEATER
	- UNLESS NOTED OTHERWISE
	- UNINTERRUPTED POWER SUPPLY
	- VOLTAGE - VARIABLE FREQUENCY DRIVE - VAPOR PROOF
	- WIRE
	- WITH - WEATHERPROOF
	- WALL SURFACE - WATER TIGHT
	- TRANSFORMER - EXPLOSION PROOF
	Drawing List - DRB
Γ	DRB E0.01 ELECTRICAL SYMBOLS AND ABBREVIATIONS
	DRB_E1.01 ELECTRICAL SITE PLAN
-	DRB_E1.02 ELECTRICAL SITE LIGHTING PHOTOMETRICS
	DRB_E1.03 ELECTRICAL SITE LIGHTING CUT SHEETS 1 DRB_E1.04 ELECTRICAL SITE LIGHTING CUT SHEETS 2
	DRB_E1.04 ELECTRICAL SITE LIGHTING CUT SHEETS 2 DRB_E1.05 ELECTRICAL SITE LIGHTING CUT SHEETS 3
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Banner Health Center Plus

SCOTTSDALE CAMPUS

NW Corner of Hayden Rd. and Mayo Blvd. Scottsdale, Arizona 85255

NexCore GROU 1550 Market Street

Suite 200 Denver, CO 80202

SMITHGROUP

455 NORTH THIRD STREET SUITE 250 PHOENIX, AZ 85004 602.265.2200 smithgroup.com

AFFILIATED ENGINEERS, INC. MEP 4742 N 24TH STREET, SUITE 100 PHOENIX, AZ 85016 602.429.5800

SSUED FOR	REV	DATE

DRB CITY COMMENTS DEVELOPMENT DESIGN REVIEW

18JUN24 07 MAR 24

SEALS AND SIGNATURES




SHEET TITLE ELECTRICAL SYMBOLS AND ABBREVIATIONS

14303.000

PROJECT NUMBER DRB_E0.01

SHEET NUMBER

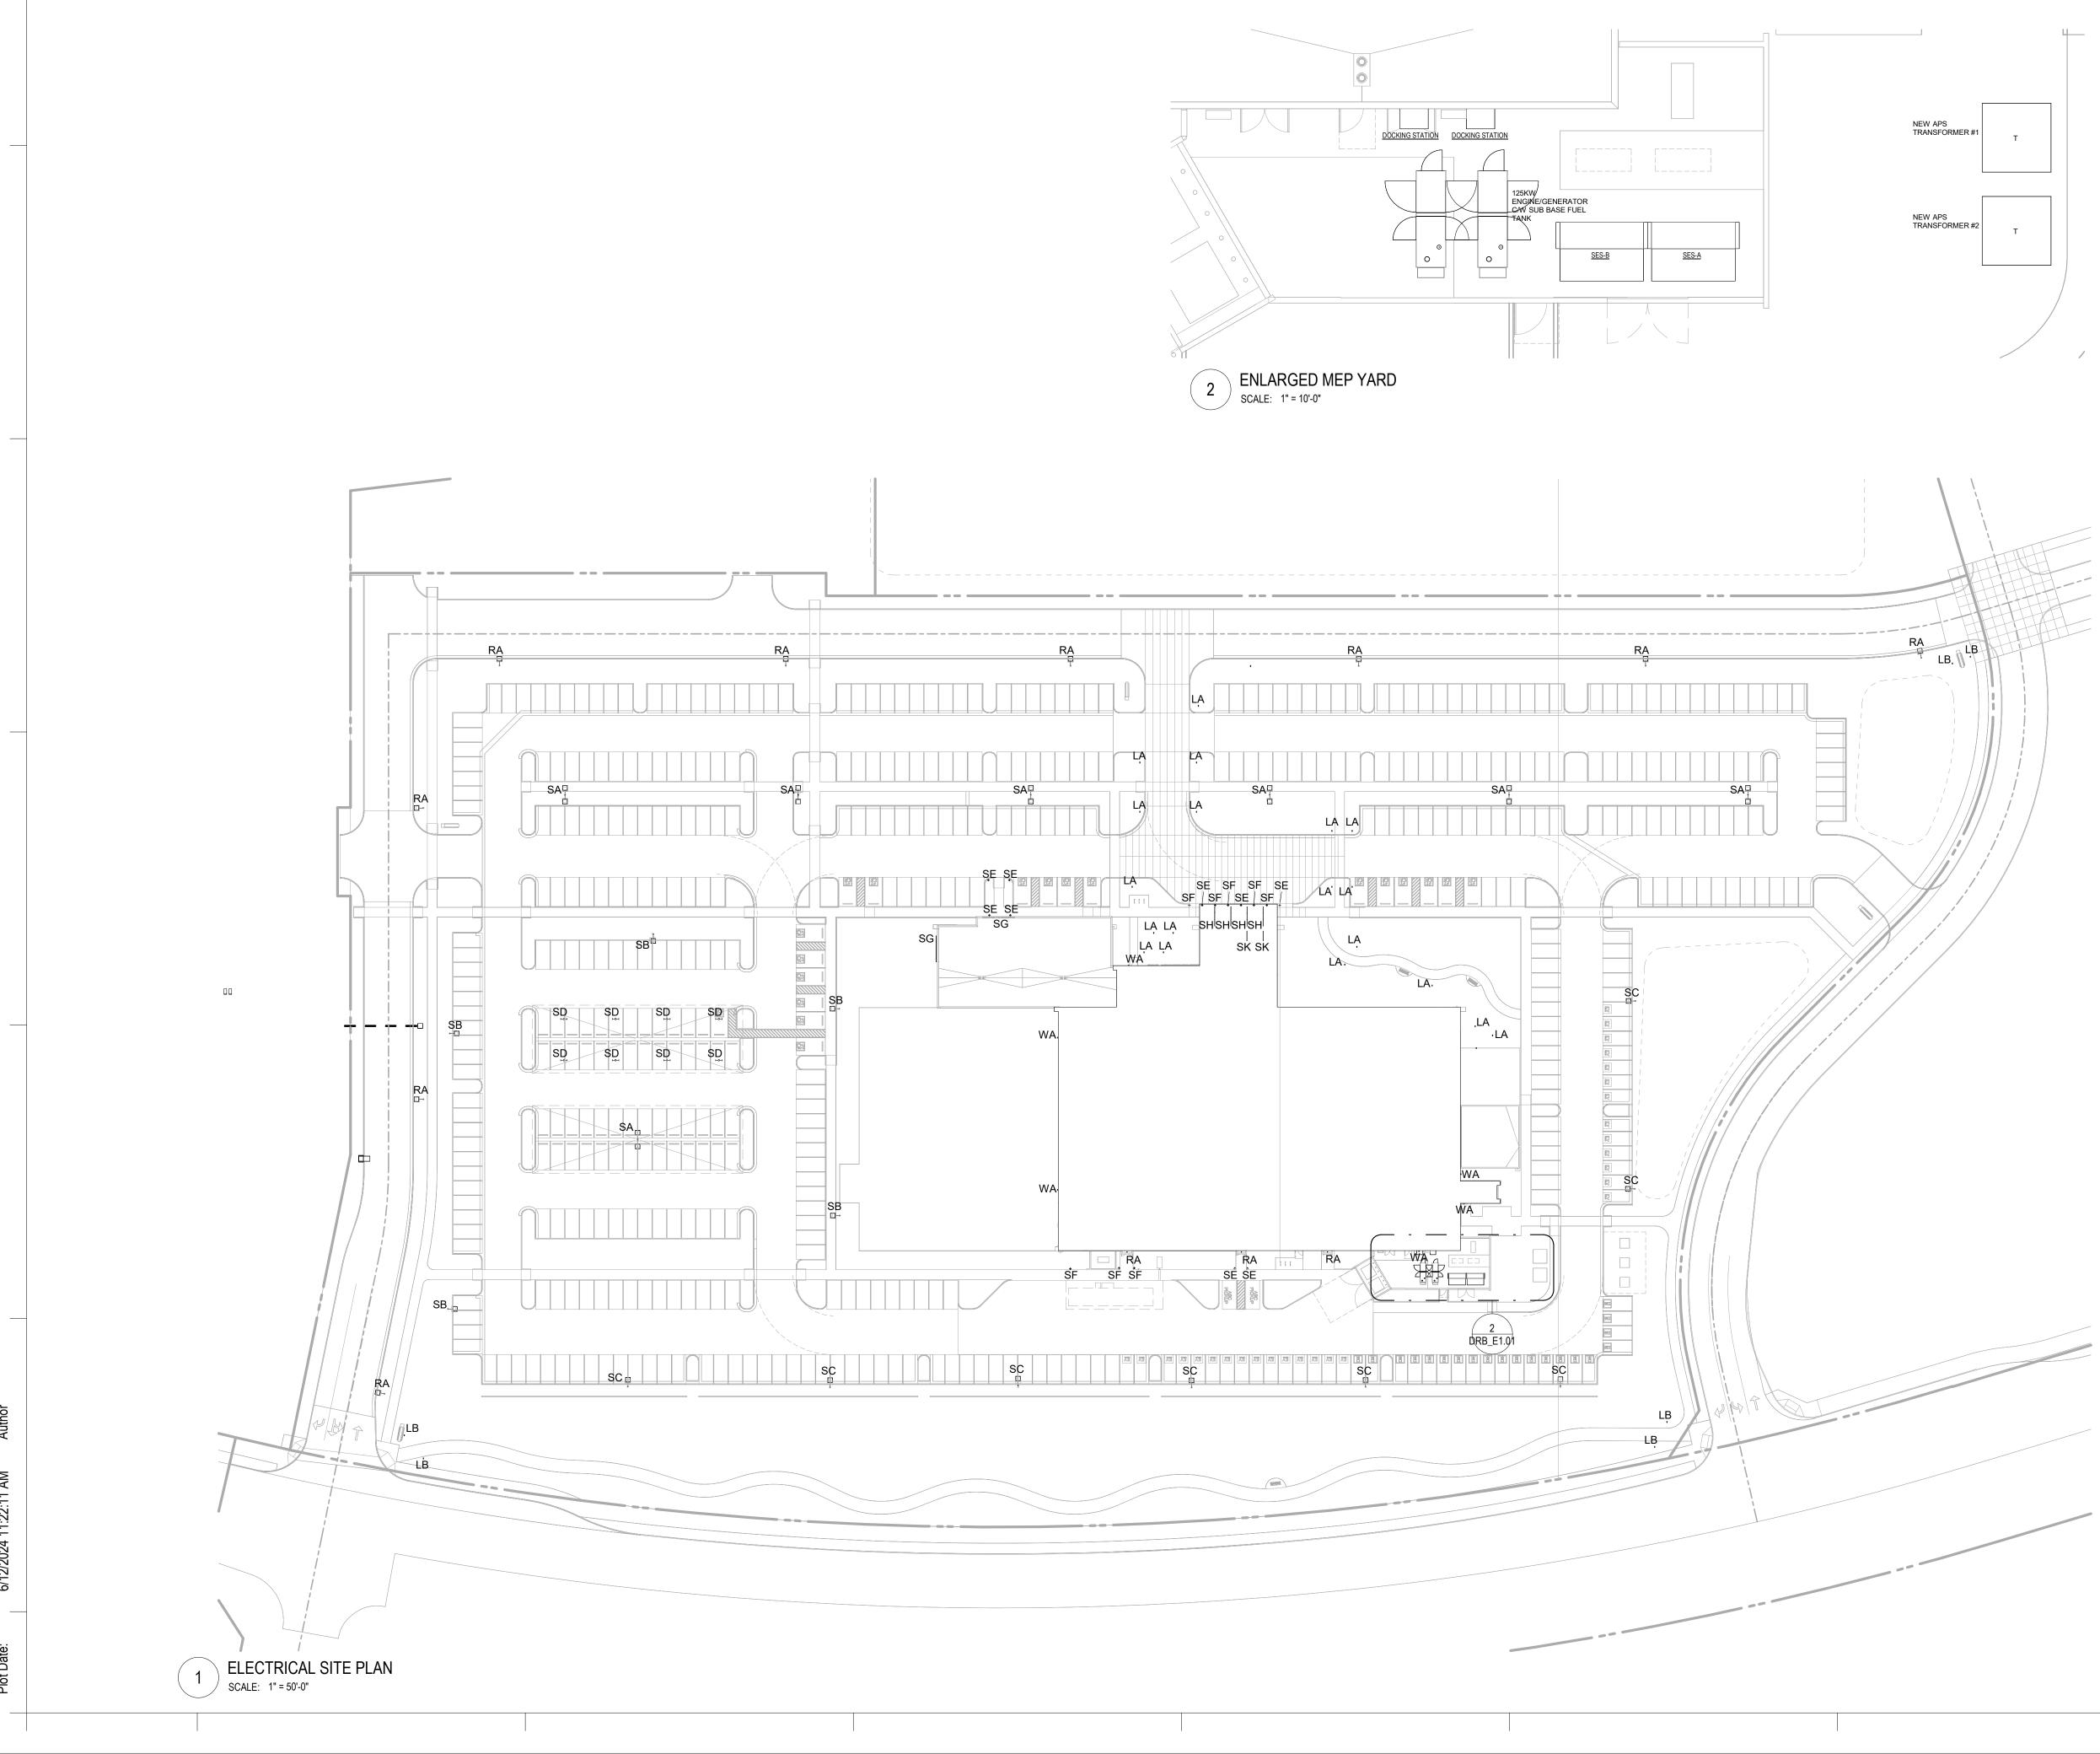

GENERAL NOTES

- A. SITE LIGHT FIXTURE SHALL BE CONNECTED USING 2#10, 1#10G, IN 1" CONDUIT.
- B. SITE LIGHTING SHALL BE CONTROLLED VIA PHOTOCELL. NORMAL AND EMERGENCY BRANCH SITE LIGHTING SHALL ALSO BE CONNECTED TO LIGHTING CONTROL PANEL. REFER TO SEQUENCE OF OPERATIONS FOR HOURS OF OPERATION OVERRIDE.
- EXTERIOR LUMINAIRES SHALL MEET IESNA REQUIREMENTS FOR FULL CUTOFF AND SHALL BE AIMED DOWNWARD.
- D. LUMINAIRES SHALL BE RECESSED OR SHIELDED SO THE LIGHT SOURCE IS NOT DIRECTLY VISIBLE FROM PROPERTY LINE.
- THE MAXIMUM HEIGHT FROM FINISHED GRADE TO THE BOTTOM OF ANY EXTERIOR LUMINAIRE SHALL NOT EXCEED TWENTY (20) FEET.
- EXTERIOR LIGHT POLES, POLE FIXTURES, AND YOKES, INCLUDING BOLLARDS, SHALL BE A FLAT BLACK OR DARK BRONZE.
- G. PARKING LOT LIGHTING POLES AND BASES SHALL NOT BE PLACED IN THE TWO (2) FOOT PARKING STALL OVERHANG OR IN A PARKING STALL.
- H. PER CITY OF SCOTTSDALE EXTERIOR LIGHTING POLICY:
- ALL LANDSCAPE LIGHTING DIRECTED UPWARD SHALL BE PAINTED BLACK. UTILIZE EXTENSION VISOR SHIELDS TO LIMIT VIEW OF LAMP SOURCE.
- LANDSCAPE LIGHTING DIRECTED UPWARD SHALL BE ORIENTED AWAY FROM THE PROPERTY LINE AND RIGHTS-OF-WAY.
- LANDSCAPE LIGHTING SHALL ONLY BE USED TO ACCENT PLANT MATERIAL.
- EXTERIOR LIGHTING LEVELS SHALL NOT EXCEED THE MAXIMUM ALLOWABLE 8.0 FC EXCEPT WHERE PERMISSABLE. IE. CANOPY LIGHTING WHERE LIGHT SOURCE IS INTEGRATED INTO SOFFIT OF THE CANOPY.



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NexCore GROU

1550 Market Street Suite 200 Denver, CO 80202

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PHOENIX, AZ 85016 602.429.5800

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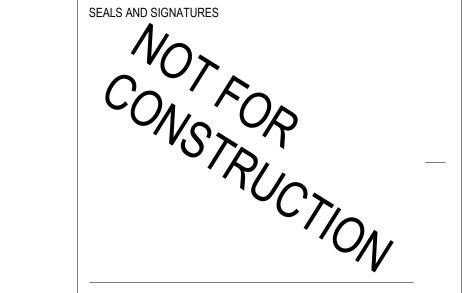
DEVELOPMENT DESIGN REVIEW

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REV DATE

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SHEET TITLE ELECTRICAL SITE PLAN

PROJECT NUMBER



DRB_E1.01

GRAPHIC SCALE: 1" = 50' - 0"

SHEET NUMBER