

STIPULATION SET RETAIN FOR RECORDS APPROVED

4/17/2025

MAXIMUM RESIDENTIAL UNIT QUANTITIES UNIT A: 5 UNITS UNIT B: 6 UNITS UNIT C: 5 UNITS UNIT D: 1 UNITS

FIRST FLOOR SQUARE FOOTAGE CALCULATION:

LODDI	454 31
	494 SF
COMMERICAL GARAGE	12645 SF
	12645 SF
COVERED PATIO	12189 SF
COVERED PATIO	12189 SF
PRIVATE GARAGE	13749 SF
GARAGE	13749 SF
FIRST LEVEL LIVABLE	5135 SF
SECOND LEVEL LIVABLE	31152 SF
THIRD LEVEL LIVABLE	32832 SF
LIVABLE	69119 SF
FIRST LEVEL OFFICE	2140 SF
SECOND LEVEL OFFICE	2136 SF

TOTAL SQUARE FOOTAGE

SQUARE FOOTAGE

12-DR-2024 3/31/2025

2 REFUSE ENCLOSURE

DW 22 [DREWETT WORKS // ARCHITECTURE 204 SCOTTSDALE. AZ. P855-373-9388 // F855-373-9388 WWW.DREWETT WORKS.COM

ATTACHMENT 8

112472 SF

PROJECT NAME

PARCEL

ADDRESS 7125 E 2ND ST & 3702 N. BISHOP LN. & 3638 N. BISHOP LN. & 3632 N. BISHOP LN. SCOTTSDALE AZ 8525

> ZONING C-3 DO

NET LOT AREA 49,315 SF 1.132 AC

49,315 SF + 3,843.75 SF (R/W) 3,849.9 SF (R/W) + 9,610.925 SF (R/W) 66,619.575 SF = GROSS LOT AREA GROSS FLOOR AREA

GROSS FLOOR AREA RATIO

23 DU PER ACRE OF GROSS LOT AREA 66,620 / 43,560 = 1.53 23 X 1.53 = 35.18 35 DWELLING UNITS ALLOWED 17 DWELLING UNITS PROVIDED MAX. BUILDING HEIGHT

OPEN SPACE

MIXED USE COMMERCIAL CENTER, 1/300 SF C GROSS FLOOR AREA GFA = 4,276SF / 300SF = 14.25 = 15

4% OF TOTAL REQUIRED TO BE ACCESSIBLE: 4% = 0.84 = 1 ACCESSIBLE SPACE REQUIRED. 2 ACCESSIBLE SPACES PROVIDED

PLUS 1 SPOT FOR EVERY 6 UNITS FOR GUESTS = 17 / 6 = 2.83 = 3 PARKING SPOTS REQUIRED: 3


IgCC AND ENERGY COMPLIANCE


LANDSCAPE

BICYCLE PARKING


BIKE RACK TO BE PER COS MAG DETAIL 228

HEAT ISLAND MITIGATION ALL PARKING IS COVERI

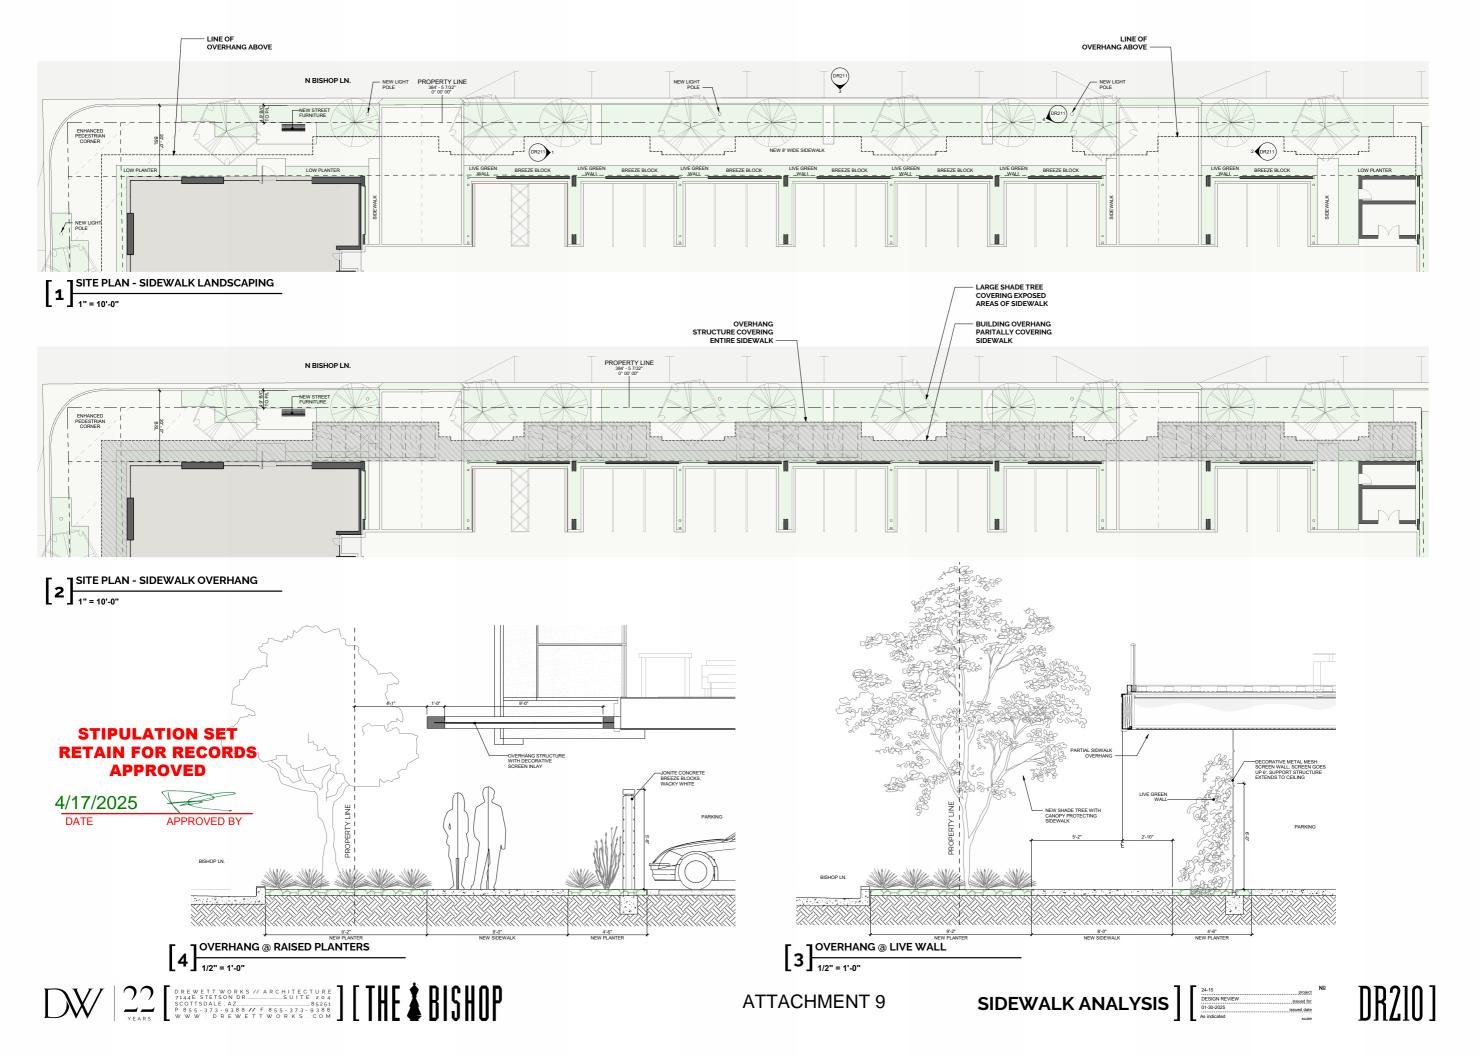

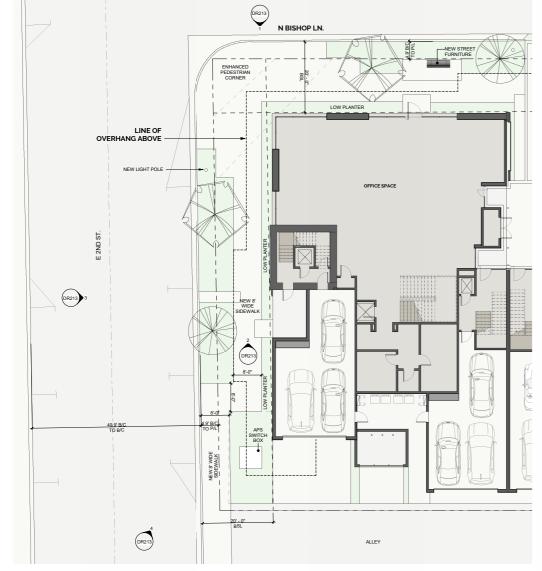

1 SITE PLAN - SIDEWALK LANDSCAPING

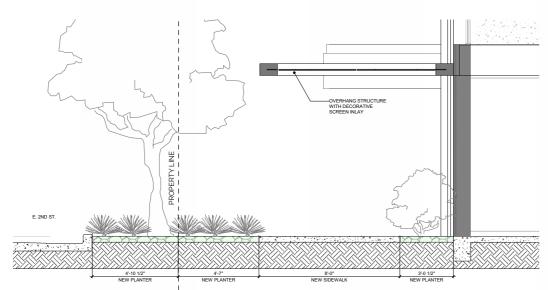


 $[3]_{\frac{1}{2"}=1'\cdot0"}^{\frac{1}{2}}$


STIPULATION SET RETAIN FOR RECORDS APPROVED

4/17/2025 DATE



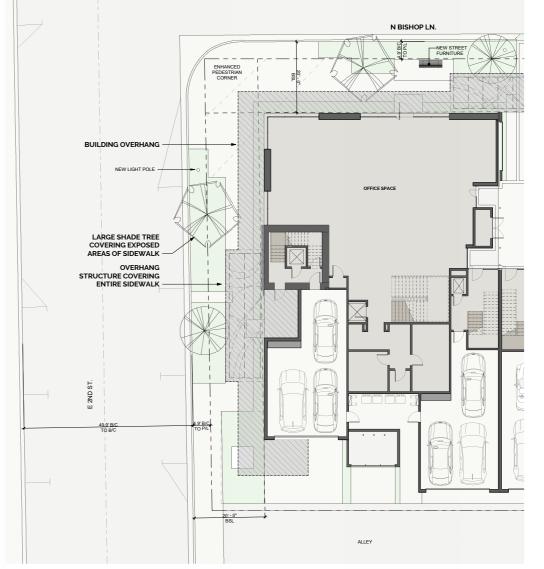

2 SITE PLAN - SIDEWALK OVERHANG

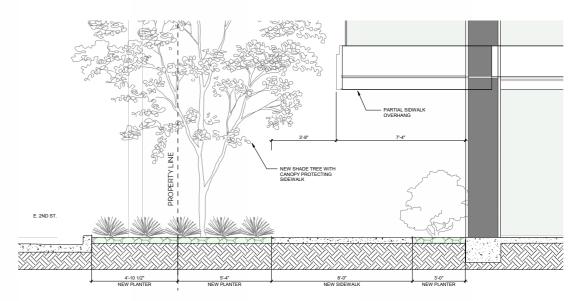

 $4 \frac{\text{SIDEWALK SECTION 4}}{1/2" = 1'-0"}$

- 1. PLANT MATERIALS MUST BE INDIVIDUALLY TAGGED IN THE FIELD AT THE TIME THE INVENTORY PLANS ARE SUBMITTED. TAGGED MATERIALS MUST BE CLEARLY MARKED WITH WATERPROOF INK AND INCLUDE THE NUMBER WHICH CORRESPONDS TO THE NUMBER SHOWN ON THE PLANS.
- 2. ALL PLANT MATERIALS MUST REMAIN ON SITE UNTIL THE SALVAGE PLAN IS APPROVED.
- 3. TAGS MUST BE ATTACHED SO THAT THEY WILL REMAIN ON THE PLANT FOR THE DURATION OF THE SALVAGE AND NURSERY STORAGE PERIOD.
- 4. ALL SALVAGEABLE MATERIAL IS TO BE CLEARLY FLAGGED WITH TAPE OR PLASTIC TAGS VISIBLE FROM ALL DIRECTIONS. TAGS SHALL BE NUMBERED TO CORRESPOND WITH THE PLANT INVENTORY PLAN AND LEGEND.

COLOR CODE AS FOLLOWS:

RED - SALVAGE AND RELOCATE

WHITE - PRESERVE AND PROTECT IN PLACE

BLUE - DESTROY, NOT SALVAGEABLE AND CANNOT REMAIN IN PLACE

- 5. ALL SALVAGEABLE PLANTS WILL BE STORED AT AN ON-SITE HOLDING YARD AND WILL BE RE-PLANTED ON-SITE AT A LATER DATE.
- 6. ALL MISCELLANEOUS CACTI UNDER 3' IN HEIGHT WILL BE SALVAGED AND STORED IN THE NURSERY IF THEY ARE WITHIN THE BUILDING ENVELOPE AND
- 7. UPON REMOVAL OF SALVAGEABLE NATIVE PLANTS THE SALVAGE CONTRACTOR SHALL SUBMIT A LIST IDENTIFYING THE TAG NUMBER OF THE PLANTS SURVIVING SALVAGE OPERATIONS TO THE CITY'S LANDSCAPE INSPECTOR PRIOR TO ISSUANCE OF THE CERTIFICATE OF OCCUPANCY.
- 8. CONTRACTOR IS RESPONSIBLE FOR VERIFYING ALL PROJECT PROPERTY LINES PRIOR TO SALVAGE. ANY PLANT MATERIAL THAT IS LABELED SALVAGEABLE OR NON-SALVAGEABLE OLITSIDE OF FINAL STAKING ROLINDARIES IS TO REMAIN IN PLACE LINESS OTHERWISE DIRECTED BY OWNER
- 9. CONTRACTOR TO VERIFY WITH OWNER ALL PLANT MATERIAL LABELED SALVAGEABLE OR NON-SALVAGEABLE ADJACENT TO N.A.O.S. BOUNDARIES AND /OR DRAINAGE WAYS



NOTE AERIAL SHOWS ADDITIONAL TREES
THAT ARE NOT NOTED. THESE ARE
EITHER DEAD OR HAVE BEEN
PREVIOUSLY REMOVED.

* SITE TO BE REDEVELOPED PER 12-DR-2024 TO INCLUDE NEW LANDSCAPING. ALL NEW TREES TO BE MATURE IN ACCORDANCE WITH ZONING ORDINANCE ARTICLE X.

STIPULATION SET RETAIN FOR RECORDS APPROVED

4/17/2025




INVENTORY COMPLETED BY:

ARIZONA SPECIALTY CACTUS
PHONE: 602-694-3496
E-MAIL: AZSPECIALTYCACTUS@GMAIL.COM
CONTACT: ALEX GREEY

The Bishop

PLANT SYMBOL LEGEND:

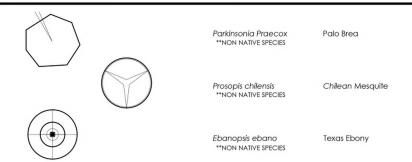

Species	Condition	Tree	Inventory	Tree Height-Ft	Caliper	Salvageablity Comments	Tree Width-F
1 Palo Brea	F-i-	Salvageability	Designation	neight-rt 20		Close To Pavement	vviatn-r
	Fair	Non Salvage	Remove				
2 Palo Brea	Fair	Non Salvage	Remove	16	9	Close To Pavement	
3 Palo Brea	Fair	Non Salvage	Remove	15	8	Poor Condition	
4 Palo Brea	Fair	Non Salvage	Remove	27	10	Poor Condition	
5 Mesquite	Fair	Non Salvage	Remove	32	16	Split Head	
6 Palo Brea	Fair	Non Salvage	Remove	22	10	Poor Condition	
7 Mesquite	Fair	Non Salvage	Remove	24	18	Leaning	
8 Mesquite	Fair	Non Salvage	Remove	15	8	Leaning	
9 Palo Brea	Fair	Non Salvage	Remove	15	6	Leaning	
10 Palo Brea	Fair	Non Salvage	Remove	17	8	Close To Pavement	
11 Palo Brea	Fair	Non Salvage	Remove	15	7	Poor Condition	
12 Palo Brea	Fair	Non Salvage	Remove	14	8	Poor Condition	
13 Texas Ebony	Fair	Non Salvage	Remove	34	24	Exposed Roots	

9 immany

Salvage Plant

- O Trees on this site to be salvaged totaling 11 caliper inches
- Cacti on this site that are to be salvaged 4 lateral Feet
 Total Plants to Salvage

- 13 Trees on this site that are to be removed (destroyed) totaling 146 caliper inches
- O Cacti on this site that are to be removed(destroyed) totaling 00 lateral feet
 Total Plants to Destroy (Unsalvageable)

POSSIBLE.

REASONING

BRANCHES.

3. THE QUALITY OF MANY OF THE TREES IS VERY POOR. YEARS OF BEING BUTCHERED THROUGH PRUNING HAS LEFT THEM IN BAD SHAPE AND FORM. NOT WORTH SALVAGING.

ADDITIONAL NOTES: SUMMARY OF

FOR MULTIPLE REASONS.


NO TREES WERE DEEMED SALVAGEABLE,

1. PALO BREA TREES ARE SUSCEPTIBLE

2. MANY ARE WITHIN CLOSE PROXIMITY TO SIDEWALKS, STRUCTURES OR WALLS, MAKING THEIR SALVAGEABILITY NOT

MUCH OF THIS ALL OVER THE TRUNK AND


TO A FUNGAL DISEASE, ONE SHOWS

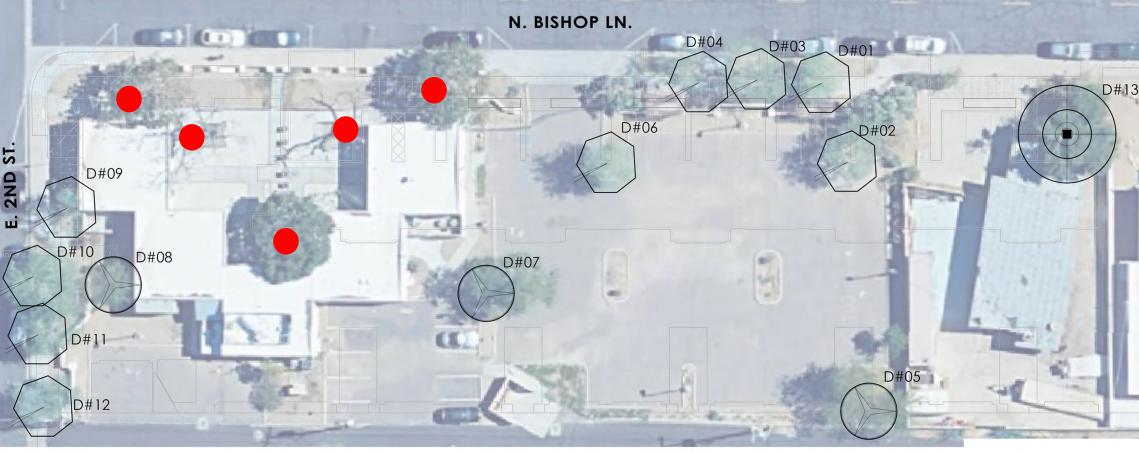


L2.0 Native Plant Inventory
AND MATURE TREE PLAN

ATTACHMENT 10



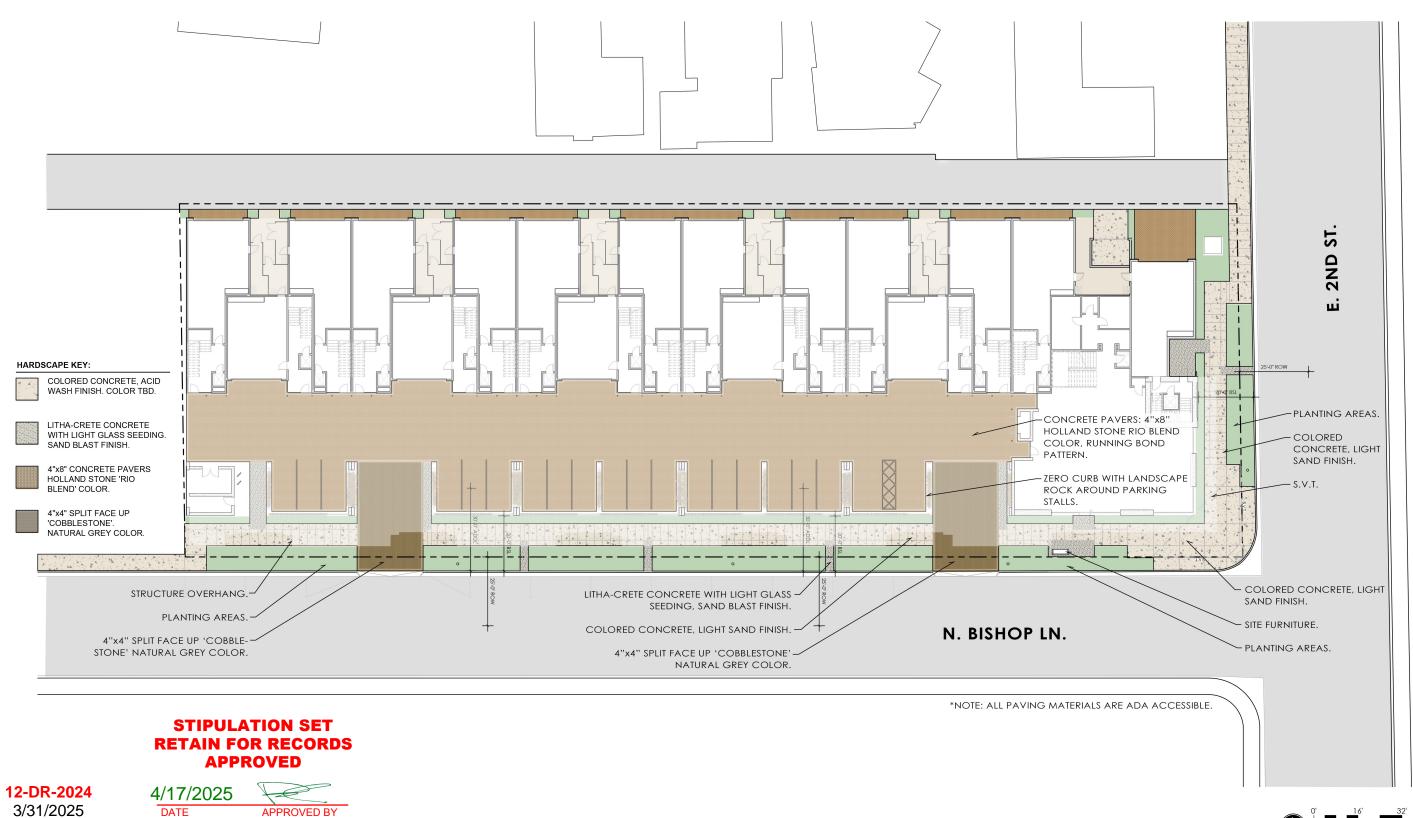


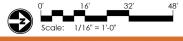




L2.1 Landscape Layout **ATTACHMENT 11**



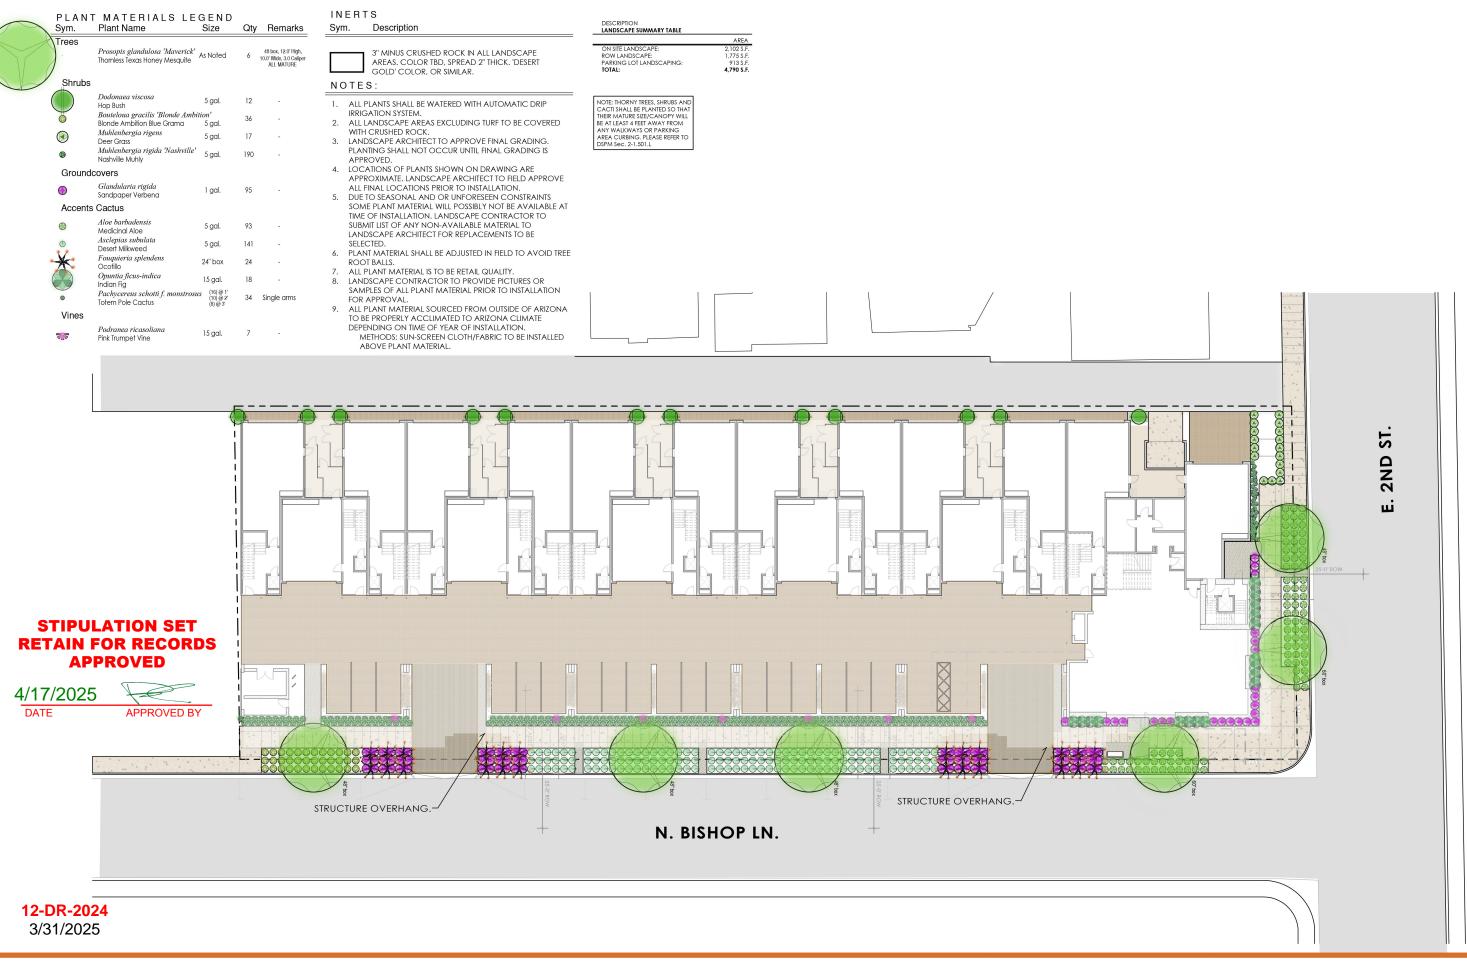

The Bishop Scottsdale, AZ 3/02 N Bishop L3.1 Planting Layout



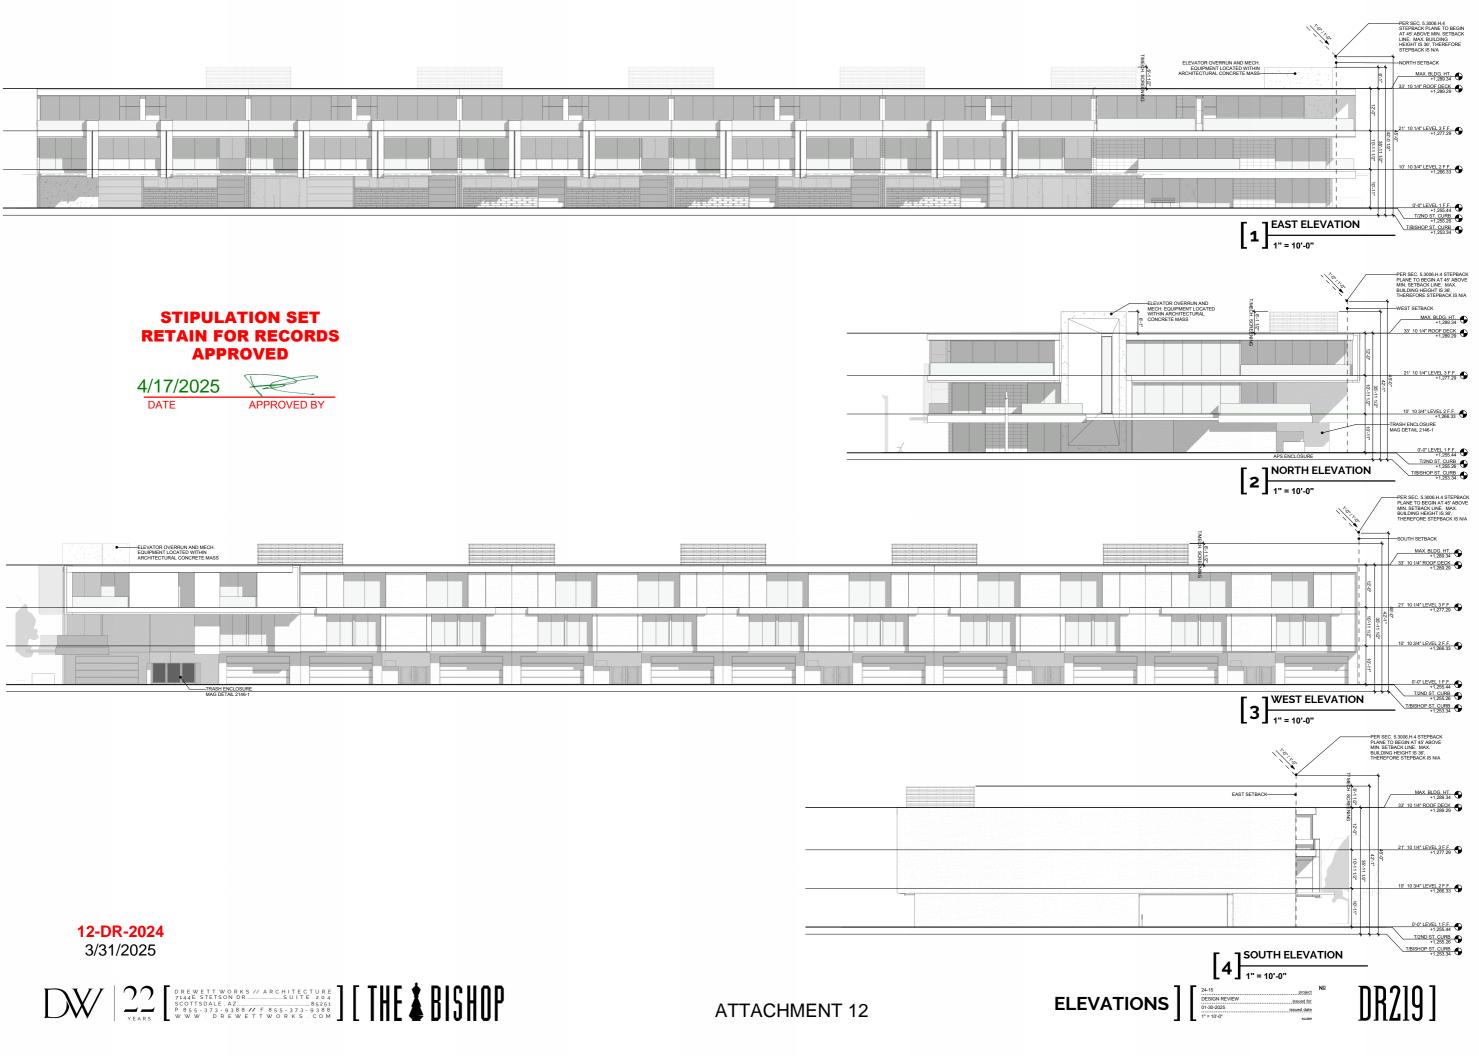




ARCHITECTURAL CONCRETE




DECORATIVE METAL MESH

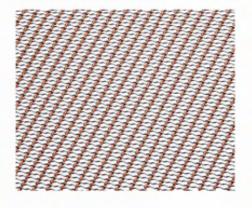

HEMLOCK SOFFIT



ACRYLIC FIN

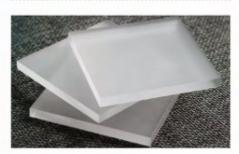

STIPULATION SET RETAIN FOR RECORDS APPROVED





STUCCO



INTERIOR / EXTERIOR LOCATION NUMBER: 254-C4 LRV: 74



INTERIOR / EXTERIOR LOCATION NUMBER: 244-C4 LRV: 32



METAL FASCIA /

QUARTZ-ZINC





WINDOW FRAMES



AWAKE WINDOW SYSTEMS, BLACK ANODIZED

BREEZE BLOCKS



JONITE CONCRETE BREEZE BLOCKS, WACKY WHITE

VENEER




SOLSTICE STONE, PAMPLONA GRAY WIDE SPLIT AND COMBED


MECH. ENCLOSURE



STEEL - POWDER COAT BLACK

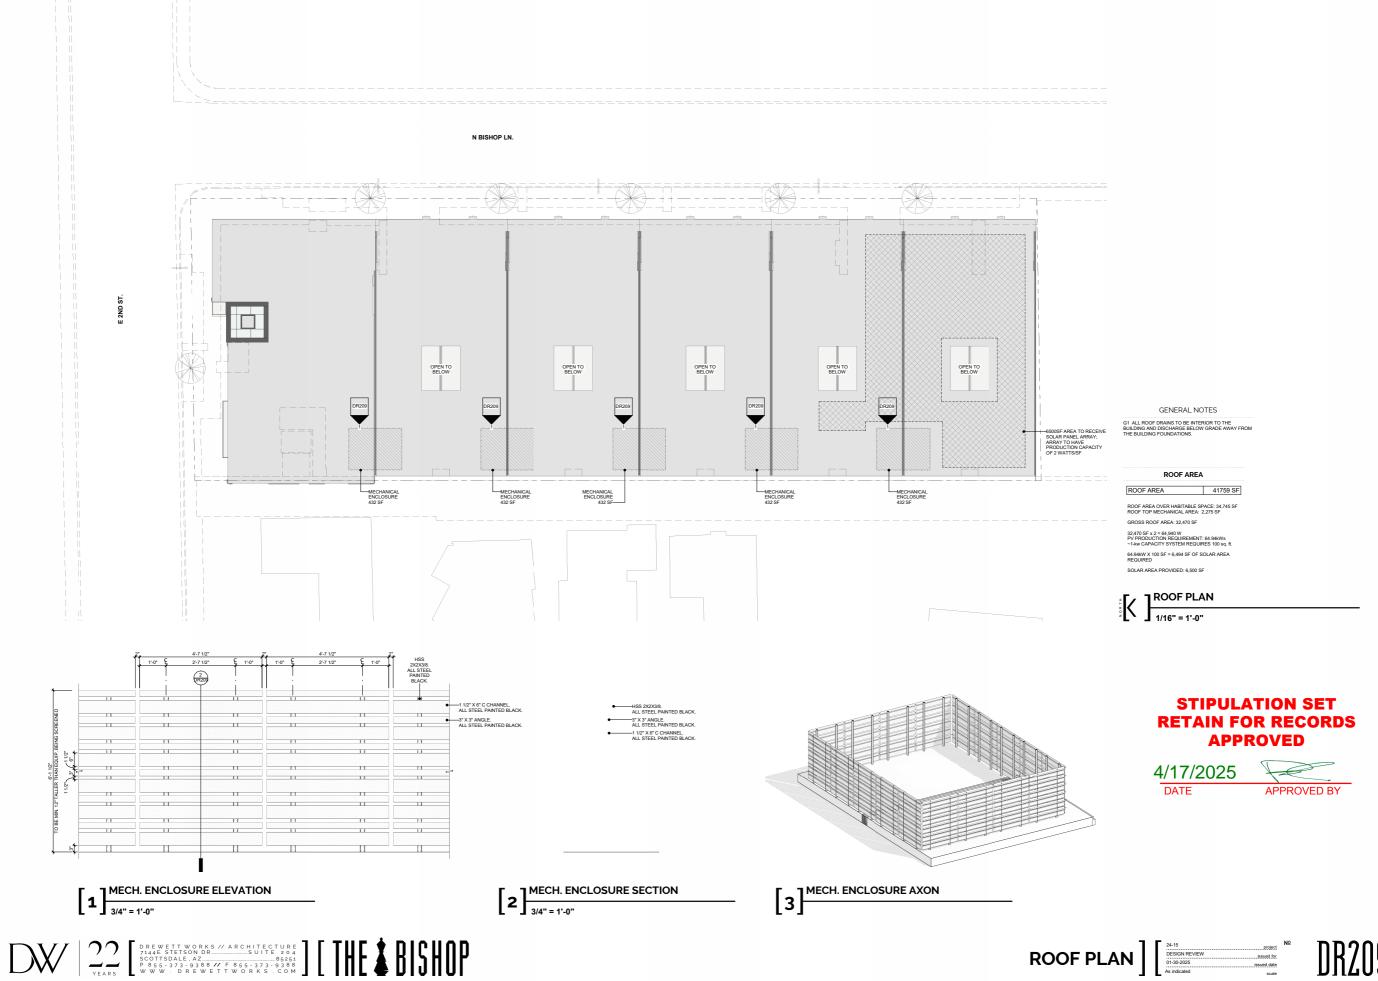

ROOF PLAN] [24-15 Project No. Issued for O1-30-2025 Issued for O

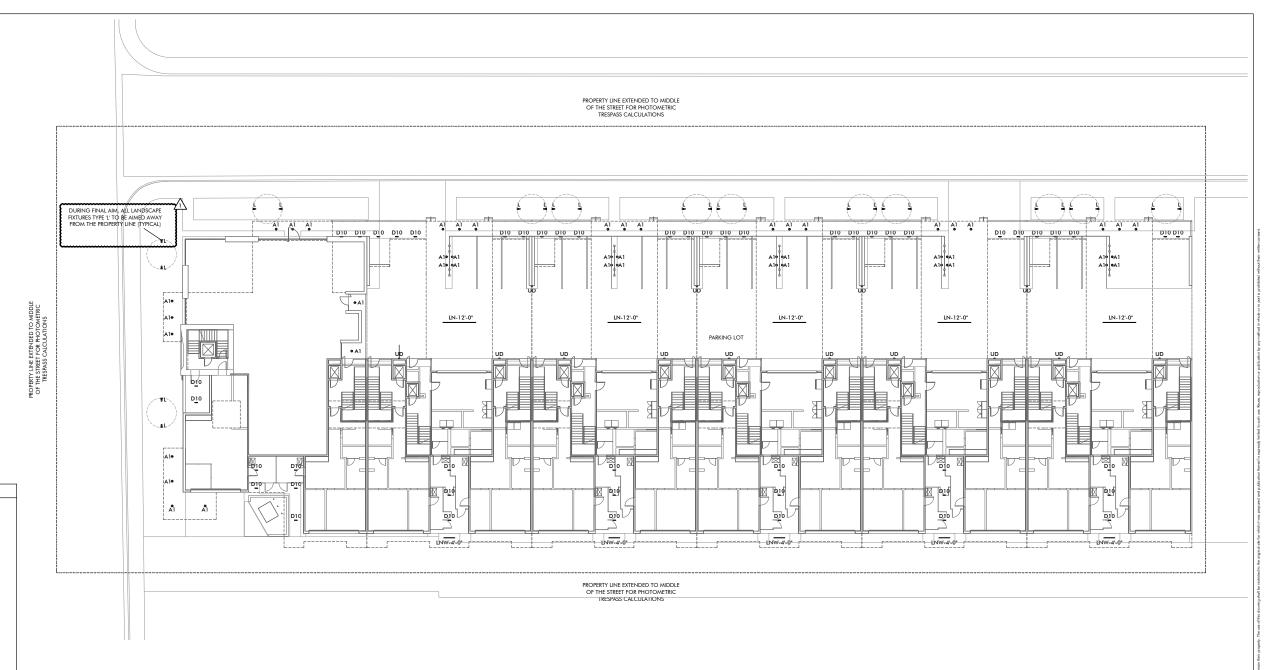

FIRST LEVEL LIGHTING PLAN

GENERAL NOTES

LIGHTING CONTROL SYSTEM CONTROL STATION LIGHTING CONTROL SYSTEM WIRELESS RF STATION

LIGHTING PLAN SYMBOL LEGEND

\$ SINGLE POLE SWITCH WITH WATERPROOF COVER

T# REMOTE LOW VOLTAGE TRANSFORMER - SEE FIXTURE SCHEDULE

S SINGLE POLE SWITCH

\$ 3-WAY SWITCH/SMART SWITCH

\$ SINGLE POLE JAMB SWITCH S SINGLE POLE MOTION SWITCH

\$ SINGLE POLE FAN SWITCH SINGLE POLE TIMER SWITCH D SINGLE POLE DIMMER

KEYNOTE BUBBLE

DUPLEX RECEPTACLE 1/2 HOT DUPLEX RECEPTACLE

WEATHER PROOF GFCI DUPLEX RECEPTACLE

1/2 HOT FLOOR PLUG RECEPTACLE

CEILING MOUNTED DECORATIVE LUMINAIRE

WALL MOUNTED DECORATIVE LUMINAIRE NOTE: SOME SYMBOLS ON THIS LEGEND MAY NOT BE USED ON THIS PROJECT.

SWITCHED WEATHER PROOF GFCI DUPLEX RECEPTACLE

-(J)- CEILING MOUNTED JUNCTION BOX

CEILING MOUNTED EXHAUST FAN WALL MOUNTED EXHAUST FAN FP ELECTRIC FIREPLACE IGNITER V# REMOTE LED DRIVER - SEE FIXTURE SCHEDULE MTR SHADE AND DRAPE MOTOR (BY SHADE CONTRACTOR)

- LIGHTING CONTROL SYSTEM STATION WITH WATERPROC IT IS THE INTENT OF THESE DRAWINGS AND SPECIFICATIONS TO PROVIDE A LIGHTING SYSTEM WHICH IS COMPLETE AND OPERATIONAL. ALL MATERIALS AND EQUIPMENT NECESSARY TO ACCOMPLISH THIS INTENT SHALL BE FUNNISHED AND INSTALLED BY THE ELECTRICAL CONTRACTOR. SUBSTITUTIONS TO SPECIFIED LIGHTING AND CONTROL EQUIPMENT SHALL NOT BE PREMITTED WITHOUT PRIOR REVIEW AND WRITTEN APPROVAL OF CREATIVE DESIGNS IN LIGHTING. LIGHTING CONTROL SYSTEM SWITCH LEG NUMBER
 - THE GENERAL CONTRACTOR AND THE ELECTRICAL CONTRACTOR ARE RESPONSIBLE FOR REVIEWING THE INFORMATION ON ALL OF THESE PLANS. IF THERE ARE ERRORS OR OMISSIONS OR QUESTIONS CONCERNING THESE PLANS PLEASE CALL CREATIVE DESIGNS IN LIGHTING FOR CLARIFICATION.
 - APPLICABLE REQUIREMENTS OF THE CURRENT NATIONAL ELECTRICAL CODE (NEC) AND STATE AND LOCAL CODES SHALL GOVERN AND DETERMINE THE MINIMUM STANDARD OF WORK. IN THE EVENT OF CONFLICT BETWEEN THIS DRAWING AND THE APPLICABLE CODE, THE CODE SHALL BREVAIL AND THE INSTALLATION SHALL BE MADE IN CONFORMANCE WITH THE CODE.

 - EXCEPT WHERE SPECIFICALLY NOTED, CONTRACTOR SHALL INSTALL ALL EQUIPMENT IN ACCORDANCE WITH MANUFACTURER'S RECOMMENDATIONS.

ELECTRICAL CONTRACTOR SHALL COORDINATE INSTALLATION OF ALL LIGHTING EQUIPMENT WITH THE GENERAL CONTRACTOR AND ANY APPLICABLE SUB-CONTRACTOR (I.E. FRAMING, MECHANICAL, CABINETRY, ETC.) PRIOR TO ROUGH-IN.

ALL RECESSED TRIMS AND/OR TRIM RINGS SHALL BE PAINTED TO MATCH COLOR OF CEILING (INTERIOR AND EXTERIOR).

- 8. COORDINATE WITH ARCHITECT/OWNER FOR MOUNTING HEIGHT AND FINAL LOCATIONS OF ALL WALL-BOX SWITCHES AND DIMMER DEVICES.
- 9. ELECTRICAL CONTRACTOR'S BID SHALL INCLUDE TWO ELECTRICIANS FOR TWO (2) ELECTRICAL CONTRACTOR'S BID STALL INCLUDE TWO ELECTRICIANS FOR TWO (2) EVENINGS (4 HOUR MINIMUM EACH) FOR FINAL AIM AND FOCUS OF ALL ADJUSTABLE LICHTING FIXTURES AND SCENE SETTING. CONTRACTOR TO PROVIDE ALL NECESSARY LADDERS/LIFTS AS REQUIRED.
- 10. FOR SPECIFIC WIRING INFORMATION AND CIRCUITING REFER TO THE ELECTRICAL PLANS.

STIPULATION SET RETAIN FOR RECORDS APPROVED

4/17/2025 DATE



ATTACHMENT 18

DESIGN DEVELOPMENT SET - NOT FOR CONSTRUCTION

DATE 10.01.2024 PROJECT NUMBER 104772-24

10.07.2024 MG

CREATIVE DESIGNS IN LIGHTING

15982 N. 78th St. Suite A Scottsdale, Arizona 85260


> 602.248.7822 design@cdltg.com www.cdltg.com 1978 46 2024

years of architectural


lighting design

BISHO

SITE LIGHTING PLAN

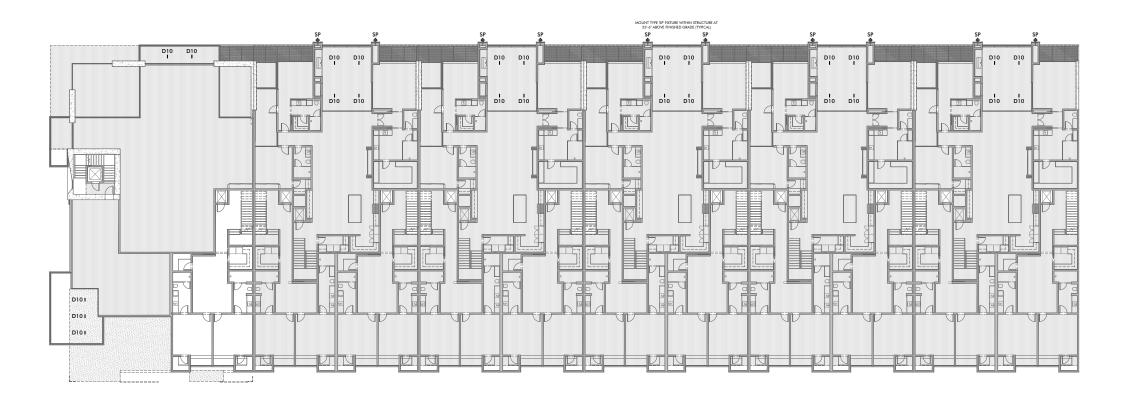

SECOND LEVEL LIGHTING PLAN

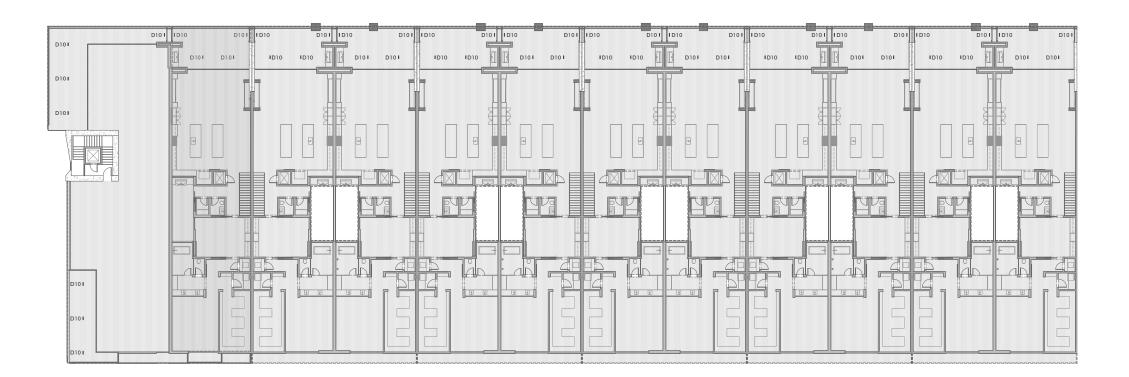

STIPULATION SET RETAIN FOR RECORDS APPROVED

4/17/2025



THIRD LEVEL LIGHTING PLAN

CREATIVE DESIGNS IN LIGHTING



602.248.7822 design@cdltg.com www.cdltg.com

1978 46 2024

years of architectural lighting design


BISHOP

	REVISIONS	
\triangle	10.07.2024 CITY COMMENTS	MG
\triangle		

DATE 10.01.2024
SCALE 1/16" = 1'-0"
PROJECT NUMBER 104772-24
DRAWN BY JB
CHECKED BY MG

LEVEL 2 LIGHTING PLAN



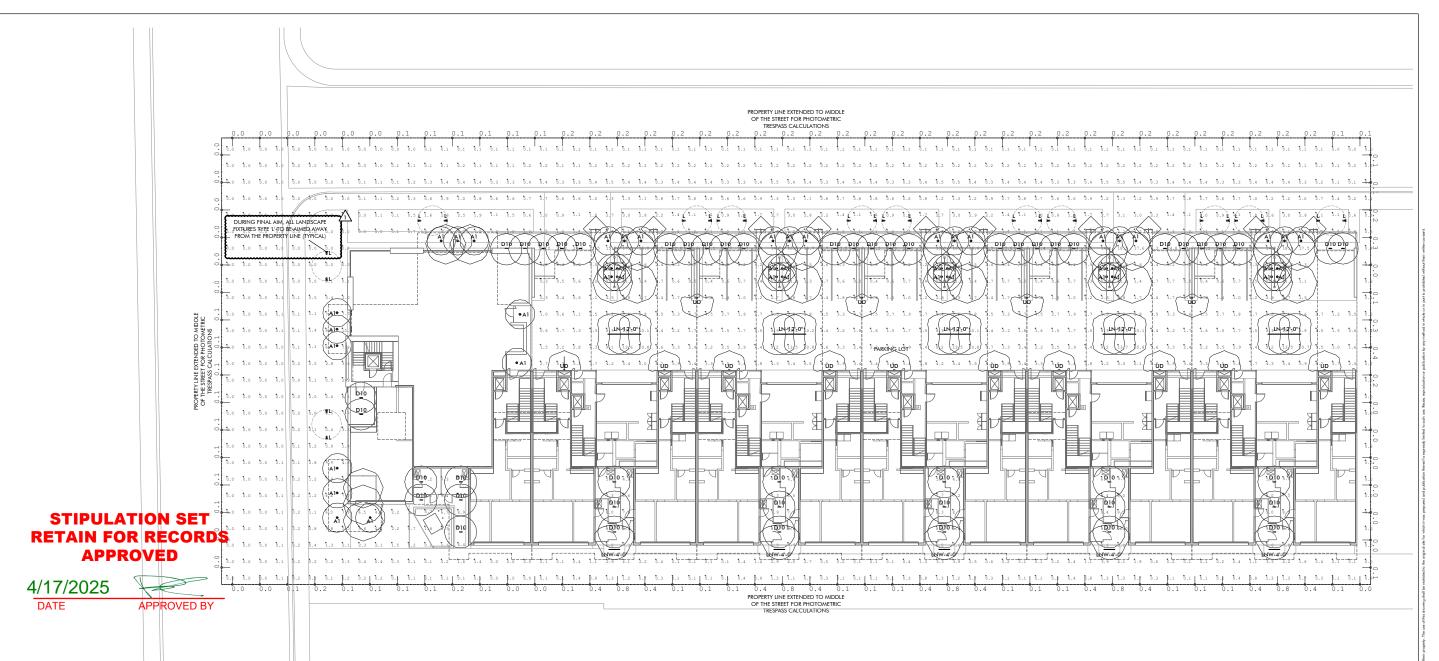

THE BISHOP LIGHTING FIXTURE SCHEDULE

SYMB.	TYPE	MANUFACTURE	R DESCRIPTION	FINISH	DIMMING	WATTS	VOLTS	LUMENS	LLF	LAMP
0	A1	ELEMENT	E3R-FF-LH-930-4-A-I / E3RFB-HW adjustable led downlight with 2* round beveled trim 40-degree beam spread, with shower rated tens contractors shall supply and install lenses and accessories du	White (Paintable) ring lome installar	0-10v	16.0 w	120v	1421	0.85	LED: 3000K i 90+ CRI INTEGRAL TO FIXTURE
-	D10	LUMENWERX	CLURIO-IC-ACB-TRM-INTEGRAL-120-1791-D1 / CLURIO-TLMP-SW-SOF-FLD-90-30-TMW-SQR-BL05 5 cell linear led fixed downlight	White Trimless Black Reflector	0-10v	23.6 w	120v	1791	0.85	LED: 3000K i 90+ CRI INTEGRAL TO FIXTURE
8	L	WAC	5012-30-BK / 5010-LSHR-BK / M6000-STAKE Landscape accent light with long shroud and ground stake	Black	Non-dim	14.5 w	120 v		0.85	LED: 3000K 85+ CRI INTEGRAL TO FIXTURE
_	LN	FLUXWERX	NN1-L-D2-B-93-E1-M-## Linear recessed fixture with open notch and side illumination Symmetric distribution	White	0-10v	5.5 w /ft	120-277	505 /ft	0.85	LED: 3000K i 90+ CRi INTEGRAL TO FIXTURE
	LNW	FLUXWERX	NN1-L-D2-A-B-93-E1-M-## Linear recessed fixture with open notch and side illumination	White	0-10v	5.5 w /ft	120-277	505 /ft	0.85	LED: 3000K 90+ CRI INTEGRAL TO FIXTURE
⊕	SP	ECOSENSE	F080-15-HO-30-9-05-K-X-A Wall mounted adjustable spotlight aim down for 90-degree cutoff (note-mounted within structure interior	Black	ELV	11.5 w	120-277	744	0.85	LED: 3000K 90+ CRI INTEGRAL TO FIXTURE
	UD	KIM	CY1.25.3K8.2.3.3-UNV-BLT-CBM-FPP Wall mounted sconce with up and downlighting with minimal glare (note-uplight is with building structure so there is no darksky uplishing).	Black	0-10V	26.0 W	120-277	2117	0.85	LED: 3000K 180+ CRI INTEGRAL TO FIXTURE

-Electrical Contractor to determine fusion mousing runing (i.e. Non-t. or Remolesy unless on -LED specifications provided for bidding purposes only. Electrical Contractor shall contact Creative Designs in Lighting for updated LED specifications prior to order. No substitutions permitted without prior approval from Creative Designs in Lighting. -Some fixtures on this schedule may not be used on this portion of the project.

Calculation Summary								
Label	Avg	Max	Min	Avg/Min	Max/Min	Notes		
Exterior Horizontal Plane	1.35	10.0	0.0	N.A.	N.A.	This calc uses 0.85 maintained light-loss factor		
Garage Horizontal Plane	6.49	25.8	0.3	21.63	86.00	This calc uses 0.85 maintained light-loss factor		
TRESPASS @ 6' AFF	0.16	0.9	0.0	N.A.	N.A.	This calc uses 1.0 maintained light-loss factor		

The horizontal illumination target maximums for the exterior lighting fixtures meet the IESNA RP-20-98 recommendations as required by City of Scottsdale "City Policy for Exterior and Site Lighting" of 2.5fc average and 10fc maximum. The same IESNA RP-20-98 document recommends 5-times higher footcandle levels for parking garages, so a separate calculation was prepared for this zone of lighting.

All exterior lighting is full cutoff distribution except for the landscape lighting permitted by City of Scottsdale. Fixture type 'UD' is only located within the parking garage, but does have an uplight component to indirectly illuminate the ceiling which is helpful in limiting glare for trespass lighting.

Trespass calculations were taken at the middle line of the streets and alleys and height of 6'-0'' and aimed toward the center of the property per City of Scottsdale requirements. All calculations were shown on 10'-0'' centers for the trespass values and even closer spacing of 6'-0'' for the horizontal calculations.

ATTACHMENT 19

DESIGN DEVELOPMENT SET - NOT FOR CONSTRUCTION



CREATIVE DESIGNS
IN LIGHTING



15982 N. 78th St. Suite A Scottsdale, Arizona 85260

> 602.248.7822 design@cdltg.com www.cdltg.com

1978 **46** 2024 years of architectural

lighting design

THE BISHOP

	REVISIONS	
\triangle	10.07.2024 CITY COMMENTS	MG
\triangle		

DATE
10.01.2024

SCALE
1/16" = 1'-0"

PROJECT NUMBER
104772-24


DRAWN BY
JB

CHECKED BY
MG

PHOTOMETRIC CALCULATIONS

CHEET NII IMBE

AL3

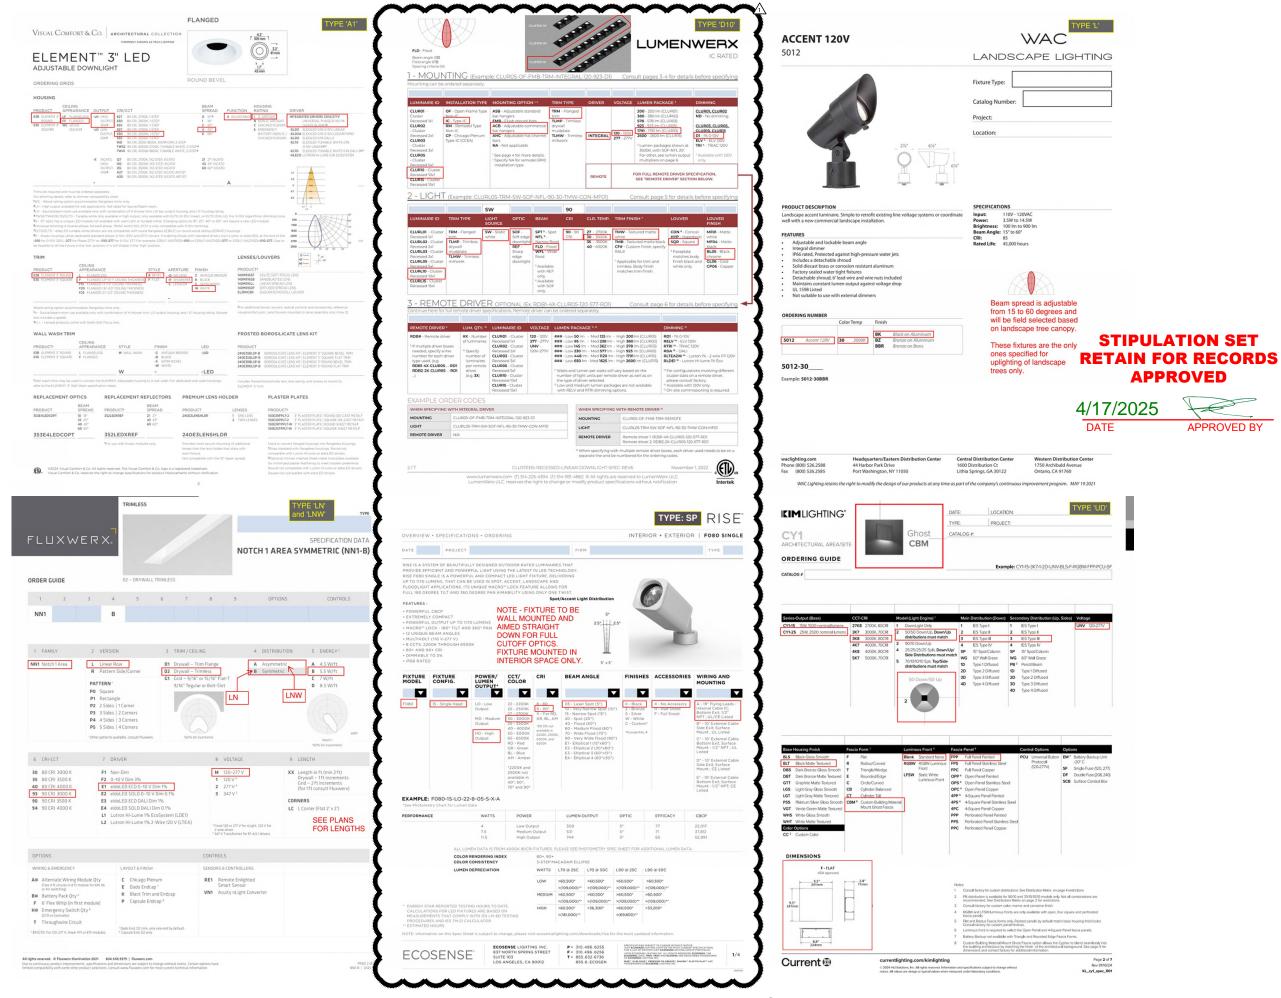



CREATIVE DESIGNS
IN LIGHTING



15982 N. 78th St. Suite A Scottsdale, Arizona 85260

> 602.248.7822 design@cdltg.com www.cdltg.com

1978 **46** 2024 years of architectural lighting design

lighting design

THE BISHOP

	REVISIONS	
\triangle	10.07.2024 CITY COMMENTS	MG
\triangle		
	<u> </u>	

DATE
10.01.2024

SCALE
N.T.S.

PROJECT NUMBER
10.4772-24

DRAWN BY
JB

CHECKED BY
MG

FIXTURE CUTSHEETS

SHEET NUMBER

AL4