

For development projects with taxilane access and/or parcels adjacent to airport property

The owner of developments within the Airport Influence Area shall complete forms required by the City and Scottsdale Airport to comply with the Scottsdale Revised Code, Chapter 5 – Aviation and the Airpark Rules and Regulations; and submit the completed forms with final plans to the assigned city project manager.

Project Name:	Pre-App:
Site Address:	
Contact name: Larson Associates Architects, Jim Larson	Phone: (602) 955-9929

#### 1. HEIGHT ANALYSIS, CH. 5, SEC. 5-354. GENERAL REQUIREMENTS

- Applicants must conduct a height analysis for all projects located within 20,000 feet of Scottsdale Airport.
  - 1. Complete a height analysis for all structures, appurtenances or construction equipment through the FAA at: <a href="https://oeaaa.faa.gov/oeaaa/external/portal/jsp">https://oeaaa.faa.gov/oeaaa/external/portal/jsp</a>, click on the Notice Criteria Tool (left side). If you do not exceed criteria, submit this FAA response from the website with your packet or you must complete step 2.

#### IF required by FAA, complete Step 2

 Submit an FAA form 7460-1 Notice of Proposed Construction or Alteration for review and determination. Please allow about 45 days for this process. A copy of the FAA's response will be required prior to final plan approval. Form 7460-1 was submitted to the FAA - Determination of No Hazard letter is forthcoming.

#### 2. TAXILANE ACCESS REVIEW, AIRPARK RULES AND REGULATIONS

- Submit a full-size site plan at a 1"= 20' scale and elevation plan for aviation staff review. The plans must depict the following: Taxilane centerline, proposed based aircraft (if known), hangar space dimensions, staging area dimensions, vehicle access path and gate.
  - A staging area shall be greater than or equal to the size of the largest hangar on the site per Definitions section.
  - Also proposed parcel site must include enough hangar space for each proposed aircraft to fit simultaneously inside. Sec. 310.

- The taxilane easement safety area must be a weight-bearing surface. Gravel for ground cover is discouraged, and if requested, must be between 2" -3" diameter. FAA Advisory Circular Airport Design.
- The Maximum Recommended Wingspan for aircraft stored in the airpark is 66 feet or less as stated in the Airpark Rules and Regulations, Sec. 206
- Vehicular access to hangar/staging area must not traverse taxilane easement and requires a gate. Sec. 404
- Existing or proposed fuel facility. A fuel storage area must be constructed and maintained in accordance with the regulations in Sec. 511.
   Proposed architectural barriers (buildings, walls, bollards, etc.) that will separate auto parking area and taxilane easement safety area.
   Drop-offs, objects exceeding 3" in height or vegetation in the taxilane safety area (50' from airpark taxilane centerline) are not permitted. FAA Advisory Circular Airport Design.
   Exterior lighting locations. Lighting must be illuminated downward toward taxilane.
   Landscape plan. Slope gradients should not exceed 5%; storm water retention is prohibited.
   Refuse collection dumpster storage locations. Locate away from aircraft staging, taxilane access points and airport property fence line.
   Helicopter landing area (if applicable). Proposed helicopter operations require approval from both the city and FAA and a conditional use permit. A conditional use permit is required by the City of Scottsdale. The FAA requires completion of an FAA 7480-1 Notice of


### 3. AIRCRAFT NOISE AND OVERFLIGHT DISCLOSURE, CH. 5, SEC. 5-356 & SECT. 5-357

Landing Area Proposal. NOT APPLICABLE - No proposed heliport.

- Incorporate the Airport Disclosure for Development around Scottsdale Airport language into the CC&Rs or other procedural documents and provide a copy.
- An avigation easement will need to be granted to the city. If not already recorded for property, submit a notarized Avigation Easement form with packet to your project manager.



#### SCOTTSDALE AIRPORT MASTER PLAN

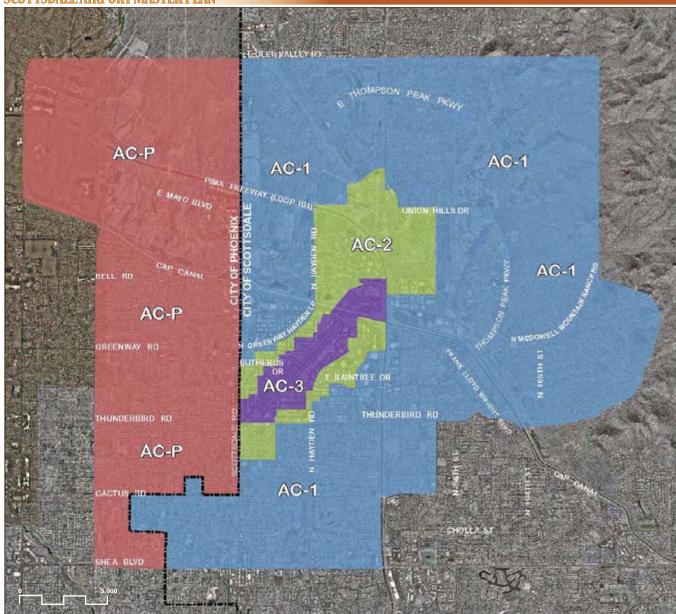

### LEGEND AND TABLE KEY

Airport Influence Areas

AC-1 AC-2

AC-3 AC-P

- NP Not Permitted
- P Permitted with Use Limitations
- (1) Avigation easement required under Sec. 5-357
- (2) Noise attenuation required under Sec. 5-358

Noise Sensitive Uses	AC¹-3	AC-2	AC-1
Dwelling unit*	NP	P (1) (2)	P (1)
Manufactured home*	NP	P (1) (2)	P (1)
Elementary and secondary school*	NP	P (1) (2)	P (1)
Hospital*	NP	P (1) (2)	Р
Travel accommodation*	NP	P (1) (2)	Р
Place of worship	NP	P (1) (2)	P (1)
Cultural, civic, and social organization	NP	P (1) (2)	P (1)

<sup>\*</sup>The terms dwelling unit, manufactured home, elementary and secondary school, hospital and travel accommodation defined in the Basic Zoning Ordinance.

1 AC - Airport Compatibility District







Alea Ol Detail

INSTRUCTIONS: Proposed temporary cranes or structures which exceed a height of 100:1 slope (100 ft horizontally for 1 foot vertically) from the nearest point of the runway must provide notice to the FAA via a 7460-1 form. Forms are available at the FAA Flight Standards District Office (480 419-0111) or the Scottsdale Airport Administration Office (480 312-2321).

# Scottsdale Airport Traffic Pattern Airspace

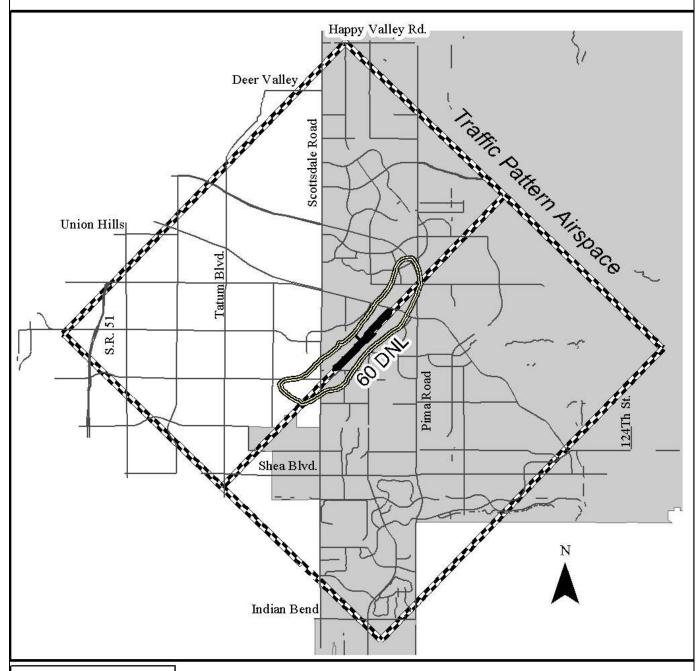

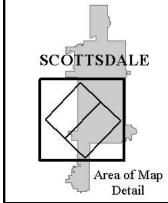



Map Date: October 18, 2001

#### SAMPLE FAIR DISCLOSURE FOR DEVELOPMENT AROUND SCOTTSDALE AIRPORT

#### **NOTICE TO PURCHASERS**

#### OF PROXIMITY TO THE SCOTTSDALE AIRPORT

To include in CC&R's or disclosure notice:

#### Proximity to Airport.

Each Owner of a Lot in the Airport Influence Area identified in Chapter 5 of the Scottsdale Revised Code acknowledges that, as of the date of this notice:

- (a) The Lot is close to the Scottsdale Airport (the "Airport"), located generally between Frank Lloyd Wright Boulevard on the north, Pima Road on the east, Thunderbird Road on the south and Scottsdale Road on the west.
- (b) The Airport is operated as a general aviation reliever/commercial service airport for Scottsdale and North Phoenix, and used generally for airplanes, jets and helicopters.
- (c) Aircraft using the Airport may fly over the Lot and adjacent properties at altitudes that vary for several reasons, including weather conditions, aircraft type, aircraft performance and pilot proficiency.
- (d) The majority of takeoffs and landings occur between 6:00 a.m. and 11:00 p.m., but the Airport is open 24 hours each day, so takeoffs and landings may occur at any time.
- (e) The number of takeoffs and landings at the Airport average approximately 400 each day, but that number varies and may increase.
- (f) Aircraft using the Airport will generate noise, the volume, pitch, amount and frequency of which will vary for several reasons, including weather conditions, aircraft type, aircraft altitude and aircraft number.
- (g) Airport management attempts to minimize aircraft noise and its influence on Lots in the Airport Influence Zone, but there is no guarantee that such attempts will be effective or remain in place.

The Owner accepts and assumes any and all risks, burdens and inconvenience caused by or associated with the Airport and its operations (including noise), and agrees not to assert or make any claim arising out of the Airport and its operations against the City of Scottsdale, its elected and appointed officials, officers, directors, commissioners, representatives, employees, and agents.

Any questions regarding the operation of the Airport can be directed to the Airport Administration office at 480-312-2321.

# See City staff for official document. Signed documents accepted by City only after approval of legal description.

#### WHEN RECORDED, RETURN TO:

City of Scottsdale
One Stop Shop/Records
7447 E. Indian School Road, Suite 100
Scottsdale, AZ 85251

Exempt from Affidavit of Value under A.R.S. § 11-1134(A)(2, 3)



## CITY OF SCOTTSDALE AVIGATION EASEMENT

WITOUT STATE OF THE STATE OF TH	APN
1 11	
FOR ONE DOLLAR (\$1.00) and other	er good and valuable consideration received (collectively "Grantor")
	an Arizona municipal corporation ("Grantee"), a upon, over and across the parcel of land (the
"Property") described on the legal de	scription and the sketch attached hereto as Exhibits
"A" and "B". The purpose of the	easement is for a right of flight for aircraft in the
airspace above the Property.	

Project No.

- 1. "Aircraft" means any manned or unmanned device that flies.
- Without limitation, the right of flight includes the right to operate aircraft over and near the Property, and cause any noise, vibration, fumes, light, exhaust, odors, fuel vapor particles, electronic interference, dust, annoyances, nuisances, emissions, and any other effects relating to operating aircraft (collectively "Aircraft Effects").
- 3. All Aircraft Effects are included within the scope of the easement, including without limitation those that reach or affect the Property or improvements to the Property, interfere with other uses of the Property, annoy users of the Property, and are caused or made worse by any changes in the following:
  - 3.1 The size, number, method of propulsion, weight, noisiness, design, fuel, category, type or other characteristics of aircraft, and in any aircraft practices, laws, rules, policies, circumstances, customs, protocols or procedures.
  - 3.2 The airport size, orientation, configuration, location, runway length, improvements or other characteristics, and in any airport practices, laws, rules, policies, circumstances, customs, protocols or procedures.
  - 3.3 The flight paths, flight frequency, flight timing, airport operations, climbing and descending, altitudes, takeoff and landing, air traffic control, and in any related aircraft and airport practices, laws, rules, policies, circumstances, customs, protocols or procedures.

# See City staff for official document. Signed documents accepted by City only after approval of legal description.

- 3.4 Grantor's or others' personal perceptions of Aircraft Effects or sensitivity to Aircraft Effects.
- 4. Grantor shall not cause or allow the Property to be used to discharge fumes; smoke; dust; or electronic, light, laser or other emissions, which may obstruct visibility or adversely affect or interfere with the operation of aircraft or any navigational facilities. No building, mast, tree, vegetation, or other thing upon the Property shall exceed Federal Aviation Administration approved height restrictions.
- 5. Grantor has been advised and understands that:
  - 5.1. All or a portion of the Property is located in a noise-influence area.
  - 5.2. Aircraft Effects might be annoying to users of the Property and might interfere with the unrestricted use and enjoyment of the Property.
  - 5.3. Aircraft Effects will likely increase over time.
- 6. Grantor waives all rights and claims that Grantor may ever have against, and agrees not to sue, Grantee regarding Aircraft Effects. Grantor makes its waivers and agreements for itself, its successors and assigns, in favor of Grantee, and all Grantee's officers, officials, employees, agents, lessees, permittees, invitees, successors and assigns.

Grantor warrants and covenants to Grantee and its successors and assigns that Grantor is lawfully seized and possessed of the Property; that Grantor has a good and lawful right to make the conveyance described herein; and that Grantee shall have title and quiet possession against the claims of all persons.

The person executing this document on behalf of a corporation, trust or other organization warrants his or her authority to do so and that all persons necessary to bind Grantor have joined in this document. This document runs with the land in favor of Grantee's successors and assigns.

DATED this day of, 20	<u> </u>	
	GRANTOR:	
		for
		for
STATE OF ARIZONA)		
) ss.		

# See City staff for official document. Signed documents accepted by City only after approval of legal description.

County of Maricopa )	
This document was acknowledged before me this day o for and on behalf of	f, 20, by
_	
My commission expires:	NOTARY PUBLIC
STATE OF ARIZONA) ) ss.	
County of Maricopa )	
This document was acknowledged before me this day o for and on behalf of	f, 20, by
	NOTARY PUBLIC
My commission expires:	NOTARY PUBLIC



<u>PURPOSE</u>: Scottsdale Airpark Rules and Regulations specify requirements relating to fueling, flammable fluids and safety in the airpark. Proposed installation plans for fuel dispensing facilities in the airpark must be reviewed and approved by airport staff to ensure compliance with all applicable laws, ordinances, rules and regulations. Airport approval is required prior to issuance of any other applicable City permits.

**INSTRUCTIONS:** Please complete Section A below and submit this form with a site plan, project description and system design for review and approval by Scottsdale Airport staff prior to final plans approval or fire department inspection. After project review, Airport staff will complete Section B and return the form to the Applicant at the specified address, fax, or email address.


<u>Section A</u> – To be completed by Applicant. Please "x" the boxes and complete the requested information as it applies to the project.

Applicant Name a	nd Fuel Dispensir	ng location:		
Applicant:				
Installation Address:				
APN:				
Authorized			Title:	
Representative:				
Indicate where approval should be sent:				
should be sent.				
Specify the number	er of dispensing s	sites, tanks, capacit	y of each tank, and	type of fuel:
	Tank 1 (Indicate capacity and fuel type below)	Tank 2 (Indicate capacity and fuel type below)	Tank 3 (Indicate capacity and fuel type below)	Tank 4 (Indicate capacity and fuel type below)
Dispensing Site 1				
Dispensing Site 2				
Dispensing Site 3				
I have reviewed and understand the applicable sections of the Airpark Rules and Regulations including, without limitation, Article 500 pertaining to Fueling, Flammable Fluids, and Safety.				
I certify that the statements made in this application are true and complete to the best of my knowledge. The undersigned representative certifies he/she is authorized to sign for the applicant.				
Authorized Representative'	s Signature			Date signed


Airport Director (or designee)	Date signed	
Approved Conditional Use Permit	Self-fueling Permit No	
Attach copies of applicable documents		
Stipulations:		
Airport staff cannot approve this project based upon the following stipulations before airport staff can approve	he submitted information. The proposed project must address	
Airport staff has reviewed the submitted informati proposed project complies with current Airpark Rules and	on pertaining to (AP#), and has determined the Regulations. Total gallons for the site:	
Section B – To be completed by Airport Staff and	d returned to Applicant.	
**************************************	inistration Only***********************	

Date: 11/6/2020

Project Number 17-029 Drawing No:

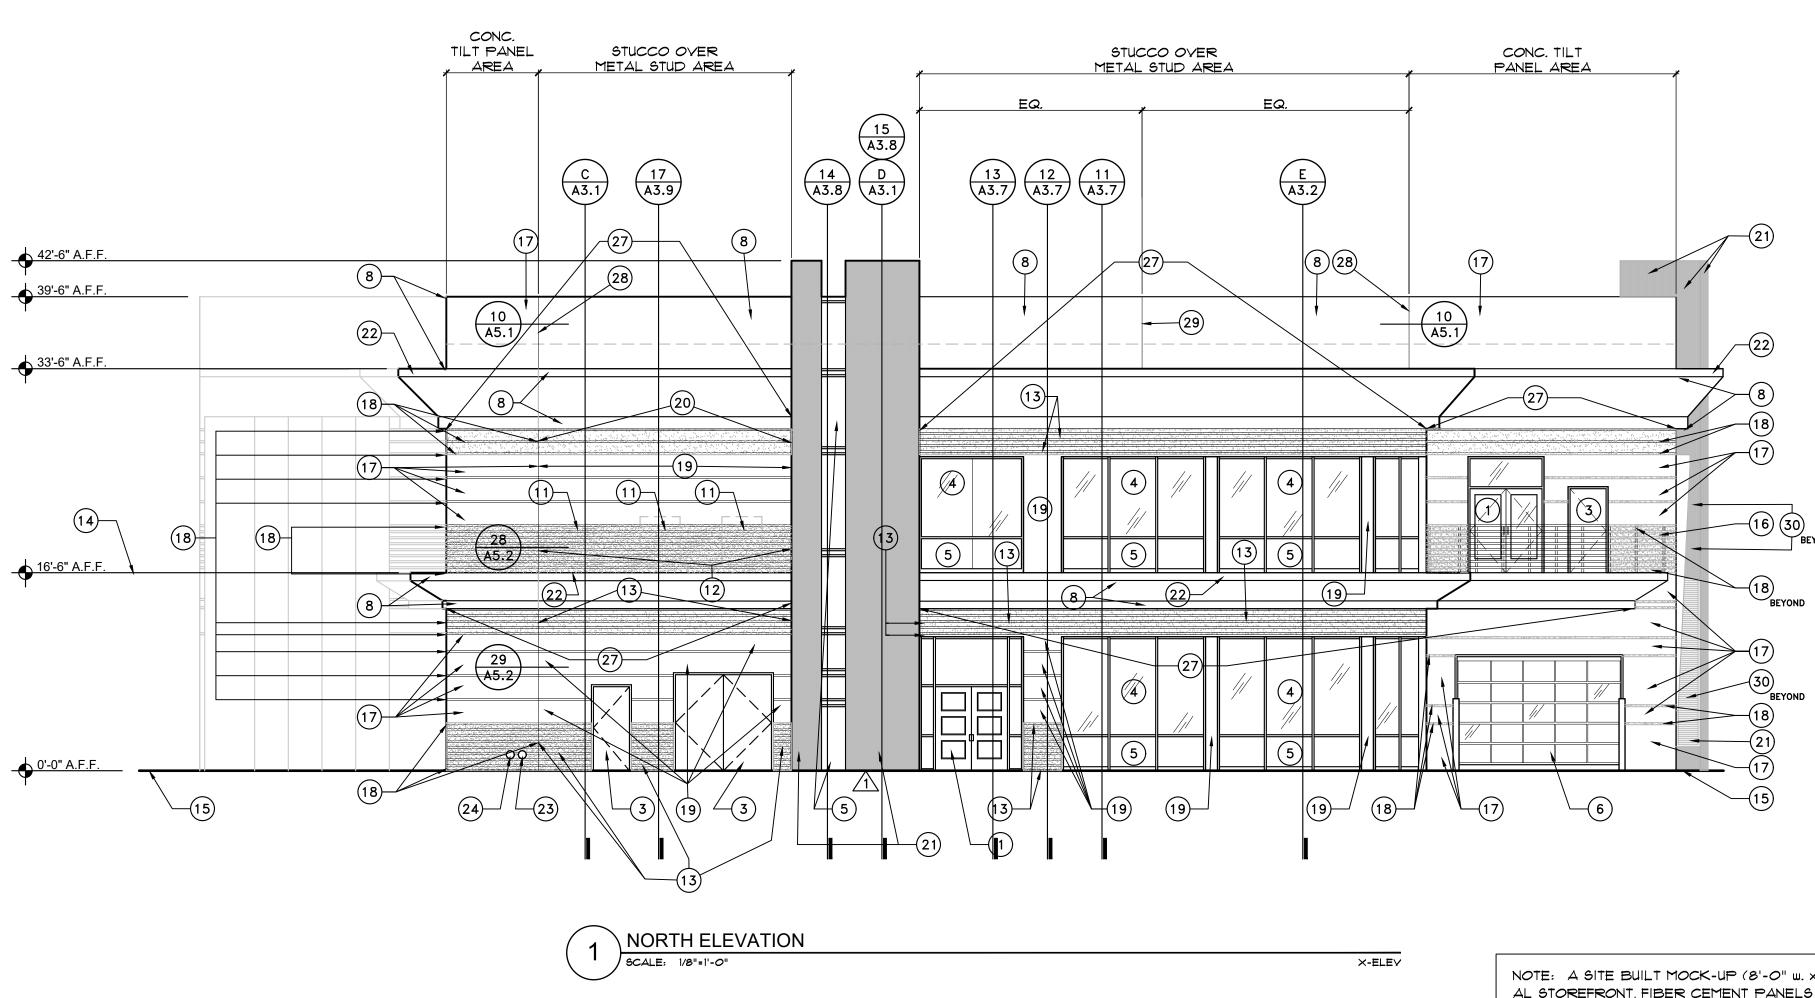

NOTE: A SITE BUILT MOCK-UP (8'-0" W. x 13'-6" h. MIN. SIZE) CONTAINING AL STOREFRONT, FIBER CEMENT PANELS (OVER 1  $\frac{1}{2}$ " DP. MIN. VERTICAL METAL SUPPORT PROFILES - PER MANUFACTURER'S RECOMMENDATIONS), OVER "VAPRO SHIELD" WEATHER BARRIER, OVER RIGID INSULATION, OVER EXTERIOR GRADE SHEATHING, OVER 8" METAL STUDS @ 24" O.C. - ALONG W/ B-DECKING AND STUCCO SECTIONS - TO DEMONSTRATE ALL EXTERIOR FINISHES AND CONNECTIONS - TO BE BUILT PRIOR TO MAIN BUILDING CONSTRUCTION FOR APPROVAL BY ARCHITECT AND OWNER - SEE SPECIFICATIONS.

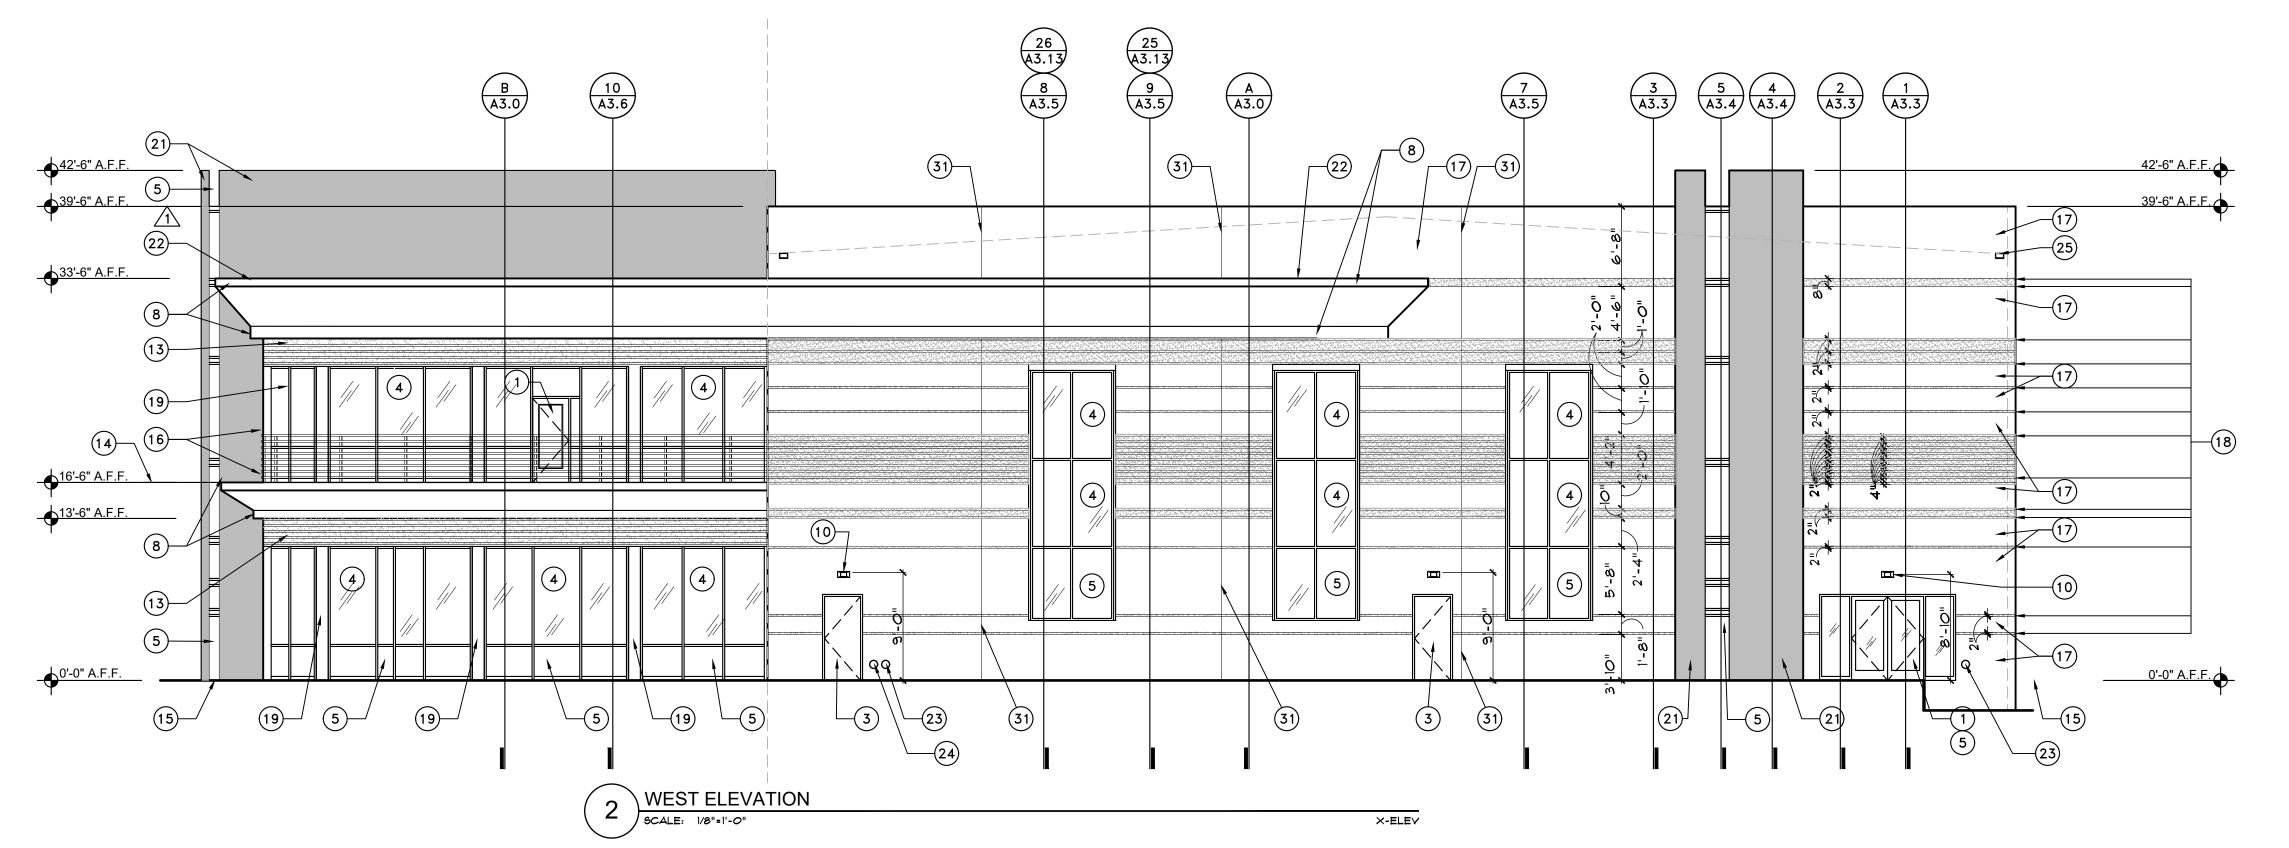

- **ELEVATION KEYNOTES**
- 1) CLEAR ANODIZED ALUM WINDOW & DOOR FRAMES

NOTE: NOT ALL KEYNOTES MAY BE USED ON THIS SHEET

- (2)NOT USED
- 3 HOLLOW METAL DOOR & DOOR FRAME TO BE PAINTED FIELD COLOR
- 4 UPPER PANEL OF GLASS TO BE GUARDIAN GLASS DUAL PANE LOW E GRAY GLASS -CLEAR ANODIZED ALUM WINDOW
- (5) DUAL PANEL LOW E MIDNIGHT GLASS GUARDIAN GLASS -LOWER PANEL OF GLASS AT OFFICE WINDOWS
- 6 CLEAR ANODIZED ALUM GARAGE DOOR WITH GLAZING LOW E MIDNIGHT GLASS GUARDIAN GLASS
- 7 HANGAR DOOR PANEL TO BE PRE-FINISHED PANEL AS CHOSEN BY ARCHITECT FROM MANUFACTURER'S STANDARDS TO CLOSELY MATCH OR COORDINATE WITH FIELD COLOR PT-1 (POSSIBLY PAINTED FIELD COLOR PT-1)
- (8) STUCCO SYSTEM PAINTED PT-1
- 9 EXTERIOR LIGHTING-FIXTURE SW -SEE FIXTURE CUT SHEETS AND PHOTOMETRIC PLANS
- (10) EXTERIOR LIGHTING-FIXTURE EM -SEE FIXTURE CUT SHEETS AND PHOTOMETRIC PLANS
- 11) MECHANICAL UNITS BEHIND EXTERIOR WALL
- PERFORATED TO VENT MECHANICAL SYSTEM BEYOND PAINTED B-DECK PAINTED ACCENT COLOR PT-2
- EXPOSED B-DECK LAYER TO BE PAINTED ACCENT COLOR USED SIMLAR TO REVEALS IN TILT SLAB PT-2
- (14) LINE INDICATING INTERIOR FINISH FLOOR
- (15) FINISHED GRADE
- (16) STAINLESS STEEL RAILING SYSTEM G.C. TO ENSURE RAILING SYSTEM MEETS ALL IBC AND ADA CODES
- 17 TYPICAL CONCRETE TILT SLAB WALL FIELD COLOR TO BE PAINTED PT-1
- REVEALS IN TILT SLAB TO BE PAINTED ACCENT COLOR PT-2
  SEE DETAILS 11\$12/A5.1 (SEE DETAIL 14/A5.1 @ 2 HR RATED WALL CONDITION
- 19 OFFICE BUILDING TO BE CLAD IN FIBER CEMENT EQUITONE TECTIVA TE90 OR EQUAL FCP-2
- OFFICE BUILDING TO BE CLAD IN FIBER CEMENT EQUITONE NATURA NOT3 OR EQUAL FCP-3
- 21) STAIR TOWER & VERTICAL ELEMENT TO BE FIBER CEMENT EQUITONE LINEA LT20 INSTALLED WITH VERTICAL PATTERN OR EQUAL FCP-1
- 22) BREAK METAL CAP PARAPET CAP TO BE PAINTED BUILDING FIELD COLOR PT-1
- (23) ROOF DRAIN SEE ROOF PLAN & PLUMBING PLANS
- (24) OVER FLOW DRAIN SEE ROOF PLAN & PLUMBING PLANS
- (25) OVER FLOW SCUPPER SEE ROOF PLAN & PLUMBING PLANS
- (26) INTERIOR SES LOCATED BEHIND EXTERIOR DOORS FOR DIRECT ACCESS
- 27 EXTERIOR ACCENT LIGHTING-FIXTURE SC -SEE FIXTURE CUT SHEETS AND PHOTOMETRIC PLANS - MOUNTED ON UNDERSIDE OF SOFFIT
- REVEAL BETWEEN STUCCO OVER METAL STUDS AND CONCRETE TILT PANEL (PAINT PT-2 ) SEE DETAIL 10/A5.1
- 29 REVEAL IN STUCCO PAINTED ACCENT COLOR PT-2
  SEE DETAIL 8/45.0
- 30 CLEAR ANODIZED AL LOUVERS FOR HANGAR EVAPORATIVE COOLING SYSTEM SEE MECHANICAL
- 31) TILT SLAB WALL JOINT SEE DETAIL 11/A5.1
- (32) SCORE JOINT IN STUCCO

BUILDING.

333'-0"  $\times$  7'-0" MAN DOOR IN SLIDING HANGAR DOOR - SEE SHOP DRAWINGS

ELECTRICAL UTILITY EASEMENT ALONG THE EXISTING TAXILANE. THIS LOCATION IS COMPLETELY SCREENED FROM VIEW FROM 81ST STREET BY THE BUILDING AND SITE WALLS. 5. ALL EXTERIOR MECHANICAL, UTILITY AND COMMUNICATION EQUIPMENT SHALL BE SCREENED BY A PARAPET THAT MATCHES THE ARCHITECTURAL CHARACTERISTICS, COLOR, AND FINISH OF THE BUILDING. PARAPET HEIGHT FOR ROOF-MOUNTED UNITS SHALL BE EQUAL TO, OR EXCEED THE HEIGHT OF THE TALLEST UNIT.

6. ALL ROOF DRAINAGE SYSTEMS SHALL BE INTERIOR TO THE


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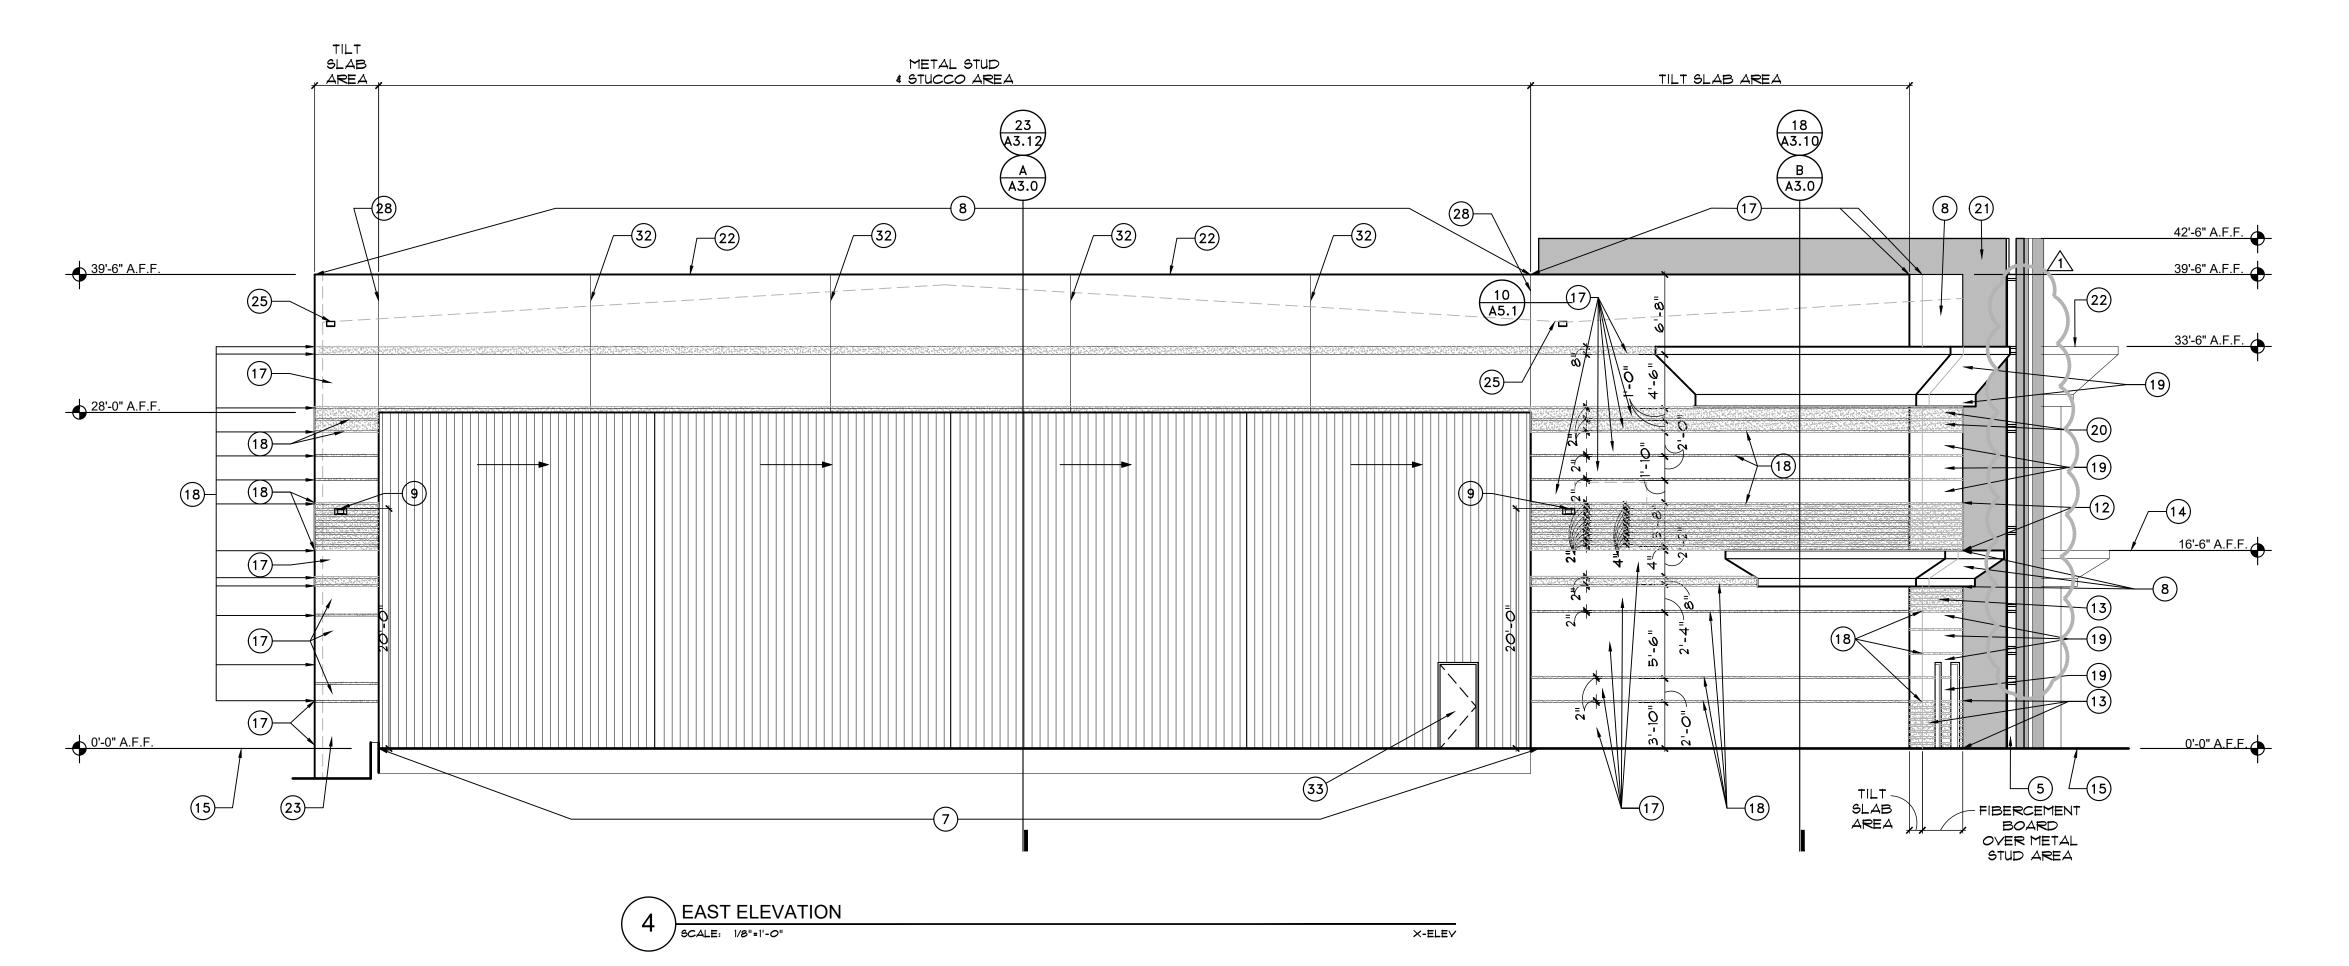
Revisions

Date: 11/6/2020

Project Number:

17-029 Drawing No:



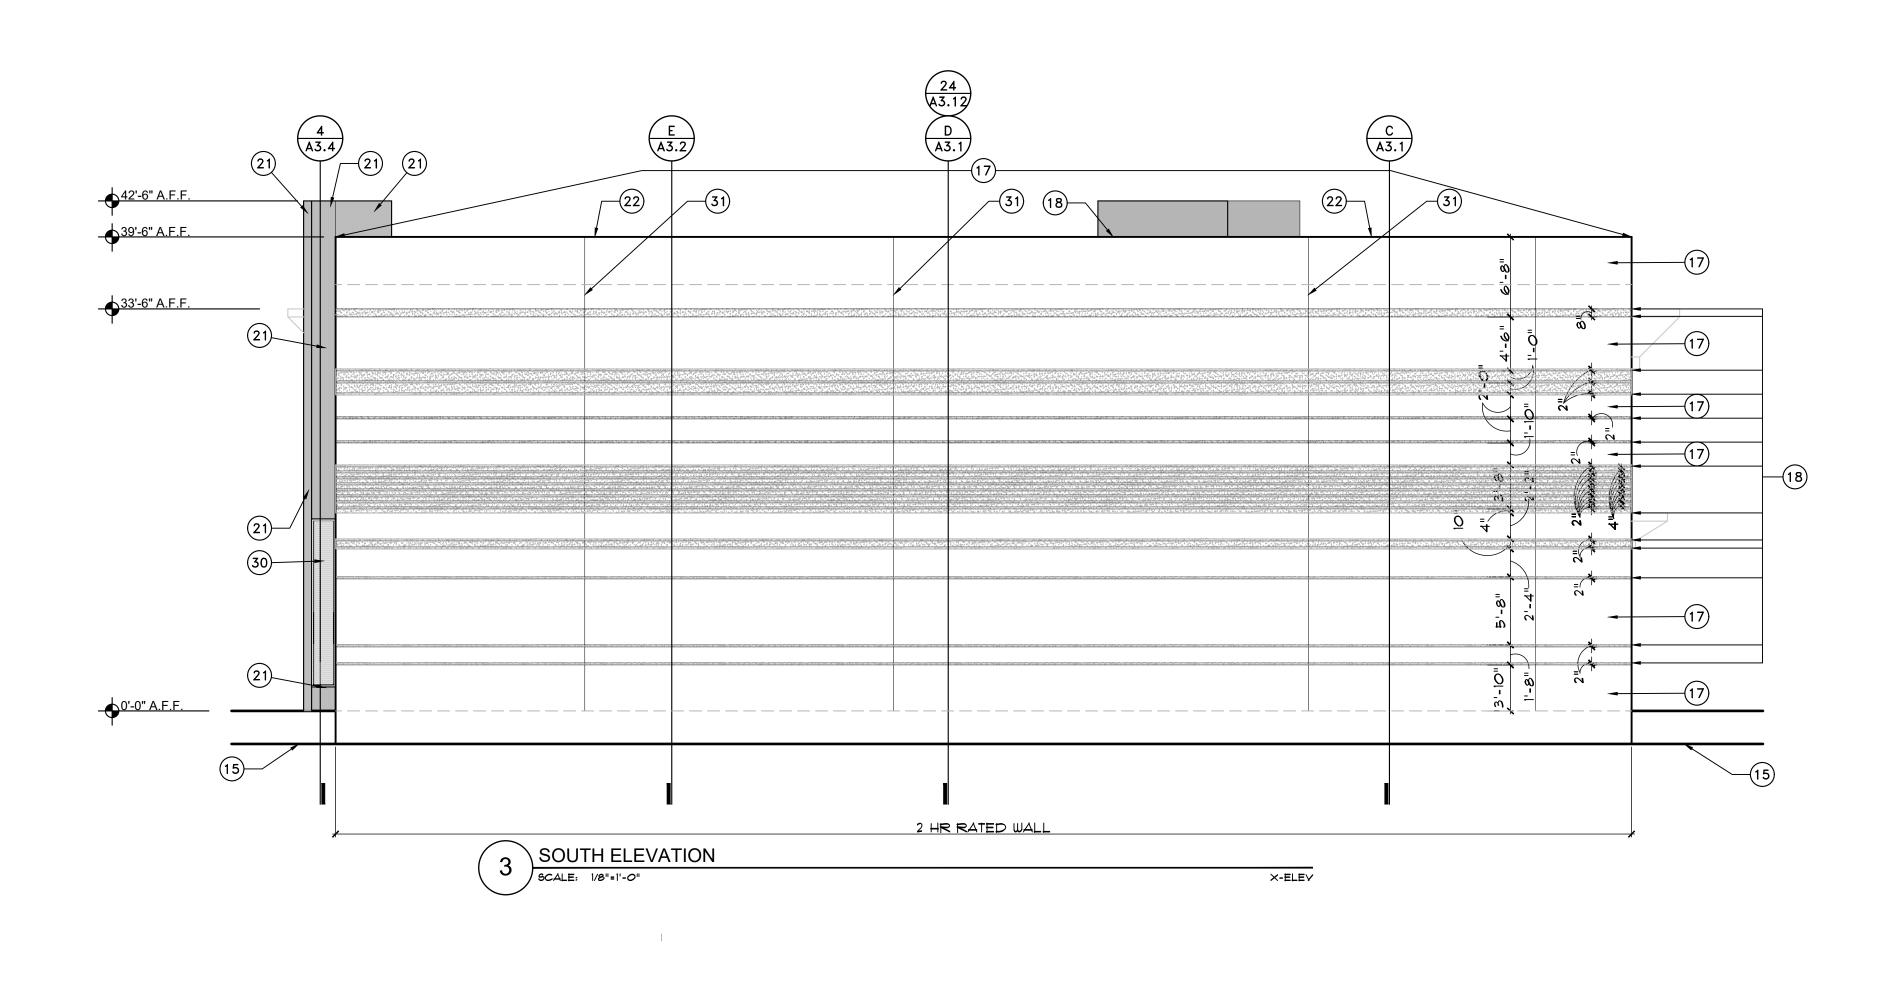

**ELEVATION KEYNOTES** NOTE: NOT ALL KEYNOTES MAY BE USED ON THIS SHEET

1) CLEAR ANODIZED ALUM WINDOW & DOOR FRAMES

2 NOT USED

3 HOLLOW METAL DOOR & DOOR FRAME TO BE PAINTED FIELD COLOR

4 UPPER PANEL OF GLASS TO BE GUARDIAN GLASS - DUAL PANE LOW E GRAY GLASS - CLEAR ANODIZED ALUM WINDOW

5) DUAL PANEL LOW E MIDNIGHT GLASS - GUARDIAN GLASS -LOWER PANEL OF GLASS AT OFFICE WINDOWS

6 CLEAR ANODIZED ALUM GARAGE DOOR WITH GLAZING - LOW E MIDNIGHT GLASS - GUARDIAN GLASS

7 HANGAR DOOR PANEL TO BE PRE-FINISHED PANEL AS CHOSEN BY ARCHITECT FROM MANUFACTURER'S STANDARDS - TO CLOSELY MATCH OR COORDINATE WITH FIELD COLOR PT-1 (POSSIBLY PAINTED FIELD COLOR PT-1)

(8) STUCCO SYSTEM - PAINTED PT-1

(9) EXTERIOR LIGHTING-FIXTURE SW -SEE FIXTURE CUT SHEETS AND PHOTOMETRIC PLANS

(10) EXTERIOR LIGHTING-FIXTURE EM -SEE FIXTURE CUT SHEETS AND PHOTOMETRIC PLANS

(11) MECHANICAL UNITS BEHIND EXTERIOR WALL

PERFORATED - TO VENT MECHANICAL SYSTEM BEYOND PAINTED B-DECK PAINTED ACCENT COLOR PT-2

EXPOSED B-DECK LAYER TO BE PAINTED ACCENT COLOR USED SIMLAR TO REVEALS IN TILT SLAB PT-2

(14) LINE INDICATING INTERIOR FINISH FLOOR

(15) FINISHED GRADE

(16) STAINLESS STEEL RAILING SYSTEM - G.C. TO ENSURE RAILING SYSTEM MEETS ALL IBC AND ADA CODES

17 TYPICAL CONCRETE TILT SLAB WALL FIELD COLOR TO BE PAINTED PT-1

REVEALS IN TILT SLAB TO BE PAINTED ACCENT COLOR PT-2 SEE DETAILS 11412/A5.1 (SEE DETAIL 14/A5.1 @ 2 HR RATED WALL

19 OFFICE BUILDING TO BE CLAD IN FIBER CEMENT - EQUITONE TECTIVA TE90 OR EQUAL FCP-2

OFFICE BUILDING TO BE CLAD IN FIBER CEMENT - EQUITONE NATURA NOT3 OR EQUAL FCP-3

(21) STAIR TOWER & VERTICAL ELEMENT TO BE FIBER CEMENT - EQUITONE LINEA LT20 - INSTALLED WITH VERTICAL PATTERN OR EQUAL FCP-1

22) BREAK METAL CAP PARAPET CAP TO BE PAINTED BUILDING FIELD COLOR PT-1

(23) ROOF DRAIN - SEE ROOF PLAN & PLUMBING PLANS

(24) OVER FLOW DRAIN - SEE ROOF PLAN & PLUMBING PLANS

(25) OVER FLOW SCUPPER - SEE ROOF PLAN & PLUMBING PLANS

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28 REVEAL BETWEEN STUCCO OVER METAL STUDS AND CONCRETE TILT PANEL (PAINT PT-2 ) - SEE DETAIL 10/A5.1

29 REVEAL IN STUCCO - PAINTED ACCENT COLOR PT-2
SEE DETAIL 8/45.0

30 CLEAR ANODIZED AL LOUVERS FOR HANGAR EVAPORATIVE COOLING SYSTEM - SEE MECHANICAL

(31) TILT SLAB WALL JOINT - SEE DETAIL 11/A5.1

(32) SCORE JOINT IN STUCCO

333'-0"  $\times$  7'-0" MAN DOOR IN SLIDING HANGAR DOOR - SEE SHOP DRAWINGS

1. THERE SHALL BE NO EXTERIOR OR ROOF MOUNTED MECHANICAL EQUIPMENT FOR THE PROJECT. ALL HYAC EQUIPMENT IS HOUSED INSIDE THE BUILDING ON THE SECOND FLOOR. 2. THERE SHALL BE NO EXTERIOR OR ROOF MOUNTED ELECTRICAL UTILITY EQUIPMENT FOR THE PROJECT. THE SERVICE ENTRY SECTION (S.E.S.) IS HOUSED INSIDE THE BUILDING ON THE FIRST FLOOR WITHIN THE SES ROOM, SPECIFICALLY PROVIDED FOR THIS PURPOSE. 3. THERE SHALL BE NO EXTERIOR OR ROOF MOUNTED COMMUNICATION EQUIPMENT FOR THE PROJECT. THE COMMUNICATION EQUIPMENT SHALL BE HOUSED INSIDE THE BUILDING ON THE FIRST FLOOR WITHIN THE SES ROOM, JANITOR'S CLOSET OR FIRE RISER ROOM AS APPROPRIATE TO THE USE AND SERVICE LOCATION. 4. ANY ELECTRICAL UTILITY COMPANY GROUND MOUNTED TRANSFOMERS INSTALLED BY THE UTILITY COMPANY FOR SERVICE TO THIS BUILDING SHALL BE INSTALLED WITHIN THE EXISTING 10' ELECTRICAL UTILITY EASEMENT ALONG THE EXISTING TAXILANE. THIS LOCATION IS COMPLETELY SCREENED FROM VIEW FROM 81ST STREET BY THE BUILDING AND SITE WALLS. 5. ALL EXTERIOR MECHANICAL, UTILITY AND COMMUNICATION

EQUIPMENT SHALL BE SCREENED BY A PARAPET THAT MATCHES THE ARCHITECTURAL CHARACTERISTICS, COLOR, AND FINISH OF THE

BUILDING. PARAPET HEIGHT FOR ROOF-MOUNTED UNITS SHALL BE

EQUAL TO, OR EXCEED THE HEIGHT OF THE TALLEST UNIT. 6. ALL ROOF DRAINAGE SYSTEMS SHALL BE INTERIOR TO THE

BUILDING.

659-PA-2024

10'

NEAT, COORDINATED AND ORGANIZED IN A

LIGHTING, ETC. TO BE NEAT AND ORDERLY

CONDUIT, PIPING, DUCTWORK, STRUCTURE,

CRISP AND ORDERLY FASHION. ALL EXPOSED

SITE PLAN

SCALE: 1"=20'-0"

SITE PLAN KEYNOTES

NEW GROUND-UP BUILDING - SEE FLOOR PLAN.

(2) site screen wall "type a" - see detail i5 & 16 /sp2.4 (top of wall 3'-6" a.f.g.)

(3) DUMPSTER ENCLOSURE AND CONCRETE PAD TO MATCH BUILDING WALLS - SEE DETAIL 11/SP2.2 4 14/SP2.3 - (C.O.S. STD. DTL. #2146-1)

(4) CONCRETE CURB PER CIVIL PLANS

5) TYPICAL PEDESTRIAN CONCRETE SIDEWALK WITH LIGHT BROOM FINISH - W/ 5'-O" LANDINGS OUTSIDE BUILDING EXIT DOORS WITH MAX. 2% SLOPE AND CROSS SLOPES - MAX. 2% CROSS SLOPES ALONG LENGTH OF WALK - MAX. RUN SLOPE OF 1" PER 1 FOOT ALONG LENGTH OF WALK SEE CIVIL PLANS AND DETAILS 1, 6, AND 7/SP2.0

6) TRAFFIC VIABILITY TRIANGLE TO REMAIN CLEAR OF OBSTRUCTIONS FROM 2'-O" TO 1'-O" ABOVE GRADE - SEE LANDSCAPE AND CIVIL PLANS

7) NEW DRIVEWAY CURB CUT PER CIVIL PLANS \$ 30/6P2.11 (C.O.6, 6TD. DTL. 2250)

8) H.C. ACCESSIBLE PARKING SPACE PER ADA STANDARDS - SEE DETAIL 10/5P2.1

9) H.C. ACCESSIBLE PARKING SPACE SIGN PER ADA STANDARDS - SEE DETAIL 24/SP2.7

SLOPES ALONG RUN - SEE CIVIL DRAWINGS 11) FIRE TRUCK LANE AND TURNING RADIUS PER CITY OF SCOTTSDALE REQUIREMENTS (INSIDE

RADIUS OF 25', OUTSIDE RADIUS OF 49', OVERHANG RADIUS OF 55')

(12) BIKE PARKING RACKS PER CITY OF SCOTTSDALE STANDARDS WITH 6'-6" x 9'-6" CLEAR AREA CONC. PAD - SEE DETAIL 27/SP2.8 (C.O.S. STD. DTL. 2285)

(13) DRIVEWAY CURB CUT W/ H.C ACCESSIBLE RAMP - MAX SLOPE 1:12 - SEE 30/SP2.11 AND CIVIL PLANS - (MIN. 4'-0" WIDTH @ APRON)

(14) SITE LIGHT - SEE DETAIL 25/SP2.7 AND STRUCTURAL AND ELECTRICAL DRAWINGS

(15) FAA READY LINE - COORDINATE SIZE, COLOR, ETC. WITH THE CITY OF SCOTTSDALE AIRPORT. PAINT LINE OUTSIDE THE TAXILANE SAFETY AREA (AREA EXTENDS 50'-O" FROM THE CENTERLINE OF THE TAXILANE). LINE SHALL BE PAINTED IN ACCORDANCE WITH FAA-AC 5340-J

(16) MOTORIZED TRAFFIC CONTROL GATE PER CITY OF SCOTTSDALE AIRPORT STANDARDS -WROUGHT IRON GATE TO COMPLETE SEPARATION OF AIRSIDE FROM LANDSIDE (SECURE AIRPORT) - SEE DETAIL 17 & 18/5P2.4 - G.C. TO PROVIDE A KEY SWITCH AND PREEMPTION SENSOR - SEE ELECTRICAL DRAWINGS AND SPECIFICATIONS FOR FURTHER GATE AND OPERATOR INFORMATION AND REQUIREMENTS

(17) CONTROL PANEL FOR STAGING AREA MOTORIZED GATE PER SPECIFICATIONS AND CITY OF SCOTTSDALE AIRPORT AUTHORITY STANDARDS - SEE ELECTRICAL PLANS

(18) NEW 8'-0" A.F.G. HIGH SITE WALL COORDINATE CONSTRUCTION WITH THE ADJACENT PROPERTY OWNER AS REQUIRED - SEE DETAIL 20/5P2.5 & 21/5P2.6

(19) LANDSCAPE AREA - SEE LANDSCAPE PLANS

9 FIRE RISER ROOM - SEE FLOOR PLAN SHEET ALO AND DEFERRED FIRE PROTECTION PLAN SUBMITTAL

(21) EXISTING CURB TO REMAIN AT EXISTING ROADWAY

(22) FDC PER CITY OF SCOTTSDALE STANDARDS - SEE BUILDING PLANS AND FIRE PROTECTION DRAWINGS

(23) DEMOLISH EXISTING 5'-O" SIDEWALK AT RIGHT-OF-WAY AND PROVIDE A NEW 6'-O" SIDEWALK PER CITY OF SCOTTSDALE

(24) 4" PARKING LOT STRIPING - SEE 4/5P2.0 AND CIVIL DRAWINGS

(25) TYPICAL H.C ACCESSIBLE RAMP MAX SLOPE 1:12 - SEE DETAILS 6 \$ 7/5P2.0 AND CIVIL PLANS

(26) AIRCRAFT FUEL PUMP - TO BE POP-UP STYLE FULL UNDERGROUND ENCASEMENT - UNDER SEPARATE PERMIT - SEE SHOP DRAWINGS

(27) AIRCRAFT FUEL TANK TO BE COMPLETELY UNDERGROUND - UNDER SEPARATE PERMIT - SEE SHOP DRAWINGS

(28) ASPHALT PARKING LOT PER CIVIL DRAWINGS

(29) FIRE LANE MARKINGS AT CURB - CURB TO BE COLORED PER SCOTTSDALE STANDARDS AND SIGNS POSTED PER C.O.S. STANDARD DETAIL 2365 - (DETAIL 28/SP2.9)

(30) SES LOCATED BEHIND EXTERIOR DOORS - SEE FIRST FLOOR PLANS

(31) DRIVEWAY TO BE 24'-O" WIDE TWO WAY- DIMENSION NOTED ON PLAN

(32) PROPOSED GROUND MOUNTED TRANSFORMER LOCATION - SUBJECT TO POWER COMPANY

(33) INSTALL 1  $\frac{1}{2}$ " PAINTED STEEL SQUARE TUBE GUARDRAIL - 42" HIGH (W/ HANDRAILS PER ADA @34" TO 36" MAX. TO TOP OF HANDRAIL) PER ADA REQUIREMENTS - MAX. 3.95" CLEAR OPENINGS IN SYSTEM (4" SPHERE CAN NOT PASS THRU) - SEE 2/SP2.0 AND CIVIL DRAWINGS. - ANCHOR PER MANUFACTURER'S RECOMMENDATIONS.

(34) INSTALL 8'-0" HIGH WROUGHT IRON SECURITY FENCE - PAINTED BLACK - SEE SPECIFICATION AND CIVIL - RUN FROM BUILDING TO PROPERTY LINE ALONG TAXILANE

(35) NEW ADA COMPLIANT 6'-6" WIDE CONCRETE SIDEWALK W/ LIGHT BROOM FINISH AND DROP OFF EDGES - ENSURE 5'-0" LANDING OUTSIDE BUILDING EXIT DOOR WITH MAX. 2% SLOPE AND CROSS SLOPE - MAX. 2% CROSS SLOPE ALONG LENGTH OF WALK - AND MAX. RUN SLOPE OF I"
IN 1 FOOT - SEE CIVIL DRAWINGS

(36)2 HOUR RATED EXTERIOR HANGAR WALLS (SOUTH AND WEST HANGAR WALLS) PER IBC SECTION 412.4.1 (WITHIN 30' OF PROPERTY LINE)

(37) SEE STRUCTURAL DETAIL 22/SI.4 FOR CONCRETE RETAINING CONDITION

(38) 90 GALLON CITY OF SCOTTSDALE RECYCLING CONTAINER PER IGCC 901.3.4.1

(39) ROOF MOUNTED ON-SITE RENEWABLE ENERGY SYSTEM (SOLOR PV) - NOT LESS THEN 3% OF ANNUAL ESTIMATED ENERGY OR 2 WATTS PER SQ. FT. MULTIPLIED BY THE GROSS ROOF AREA ACCORDANCE WITH IGCC AMENDED SECTION 701.3

> ALL ON-SITE PARKING AND CIRCULATION AREAS TO ACCOMMODATE C.O.S. ON-SITE DRIVE REQUIREMENTS - SEE 29/SP2.10.



MUST HAVE SPECIFIC DOCUMENTED

RULES AND REGULATIONS.

AIRPORT REVIEW AND APPROVAL TO

CONFIRM COMPLIANCE WITH AIRPORT

PAGE 12, AND CERTIFICATE OF CORRECTION

RECORDS OF MARICOPA COUNTY, ARIZONA.

RECORDED IN DOCUMENT NO. 94-268055,

APN: 215-48-054

VICINITY MAP NOT TO SCALE

CITY OF SCOTTSDALE APPROVAL BLOCK

EXPIRES: 6/30/2024

Sep 19, 202

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Drawing Name: SITE PLAN


Revisions

Date: 11/6/2020

Project Number 17-029

Drawing No:

659-PA-2024

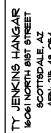

EXPIRES: 6/30/2024

### LEGAL DESCRIPTION

LOT 34, OF NORTH SCOTTSDALE AIRPARK UNIT 1, ACCORDING TO BOOK 327 OF MAPS, PAGE 12, AND CERTIFICATE OF CORRECTION RECORDED IN DOCUMENT NO. 94-268055, RECORDS OF MARICOPA COUNTY, ARIZONA.

NOT TO SCALE

FRANK LLOYD WRIGHT BOULEVARD

80TH STREÆT

SCOTTSDALE **AIRPORT** 

*PARADISE* LANE

81ST STREET

HAYDEN ROAD

MAP

Lega