

March 11, 2025

City of Scottsdale Planning & Development Services 7447 E. Indian School Road, Suite #105 Scottsdale, AZ 85251

RE: DRB Submittal Storage Conversion

10001 N. 92nd Street, Scottsdale, AZ 85258

Parcel #: 217-36-160A

This DRB Application submittal contains information for the conversion of an existing +/- 113,572 s.f., 2-story office building into a climate controlled self-storage facility with +/- 39,009 sf of new exterior loaded, non-conditioned units.

This site is located at 10001 N. 92nd Street, Scottsdale, AZ 85258. The project is being proposed on an existing 323,384 sf (7.42 Acre) site that has an existing zoning of C-O PCD. The proposed use would be permitted through the companion Text Amendment on file with the City (6-TA-2024).


Main access to the facility will be from 92nd Street with emergency/exit only access being provided from both Mountain View Road and the internal shared drive. Access points (main and emergency) into the facility will be managed by power assist sliding gates.

New exterior storage units will be constructed of integral colored CMU and metal paneling. Chosen colors for the integral colored cmu and metal paneling compliment the existing color palette of office building and parking garage. There will be an 8'-0' tall solid integral colored screen wall along Mountain View Road to screen the site. The height of the screen wall was a condition of approval from the HOA. Screen wall color will match the cmu of the new exterior storage units. Black wrought iron fencing will be provided along the shared drive to secure the site. The existing openings to the parking garage from the shared drive and along Mountain View Road will be closed off with breeze block in a color complimentary to the existing color palette. New landscaping will be provided throughout the site as required based on the new site layout.

If you should have any questions, please don't hesitate to contact me. Thank you.

Upward Architects

Justin Gregonis, NCARB Managing Partner

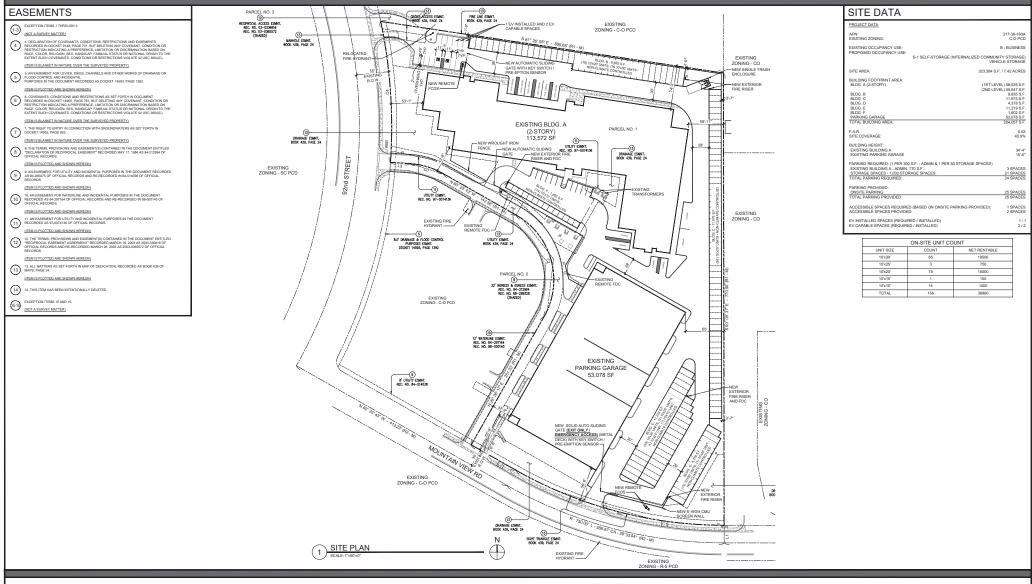

10001 N. 92nd Street Scottsdale, AZ. 85258







Tempe, AZ 85281
Ph 602.753.5222 www.upwardarchitects.com

STORAGE CONVERSION - 10001 N. 92nd STREET

project consultants

BERGIN FRAKES SMALLEY & OBERHOLTZER 4455 E CAMELBACK ROAD STE 210 PHOENIX ARIZONA 85018

1155 W RIO SALADO PARKWAY STE B-101 TEMPE, ARIZONA 85281 PROJECT CONTACT: JOHN BARCLAY PHONE: 602.753.5222 EMAIL: john@upwardarchitects.com

UPWARD ARCHITECTS

ELEVATIONS CIVIL ENGINEERS, LLC 3260 N. HAYDEN RD, SUITE 210 SCOTTSDALE, ARIZONA, 8525 CONTACT: JUSTIN EVINGER PHONE: 602.810.2975 EMAIL: justin.evinger@elevationce.com

DESIGN ETHIC, LLC 7525 EAST 6th AVENUE SCOTTSDALE, ARIZONA 85251 PROJECT CONTACT: BRANDON PAUL PHONE: 480.225.7077 EMAIL: bpaul@designethic.net

sheet index

SHEET	TITLE
10.01	COVER SHEET
L2.00	LANDSCAPE LEGENDS & NOTES
1201 1204	DI ANTINIC DI ANI



wicimitw map





key map



planting notes

THE SUB-CONTRACTOR SHALL MARK AND CONFIRM LOCATIONS OF UNDERGROUND UTILITIES PRIOR TO EXCAVATION. CONFLICTS SHALL BE REPORTED TO THE LANDSCAPE ARCHITECT FOR RESOLUTION.

- REPORTED TO THE LANDSCAPE ARCHITECT FOR RESOLUTION.

 PLANT MARERIAS SPECIMED SAIL BE SUBJECT TO HAND SELECTION BY THE
 FINSH GRADE OR TOP OF D.G. (MINICHEVER IS HIGHER) SHALL BE 1-1/2"

 BELOW ADJACHN CONCERE OR OF DIESP AVED SURFACES.

 LANDSCAPE CONTRACTOR IS RESPONSIBLE FOR ALL PLANTS SHOWN ON
 PLANTISC PLANT. HIE LANDSCAPE CONTRACTOR SHALL BE RESPONSIBLE FOR ACCURATE PLANT COUNTS, IF ANY DISCREPANCIES SHOULD ARISE WITH REGARDS TO PLANT QUANTITIES THE LANDSCAPE CONTRACTOR SHALL NOTIFY THE LANDSCAPE ARCHITECT WITHIN A PERIOD OF 48 HOUR FOR
- NOTIFY THE LANDSCAPE ARCHITECT WITHIN A PERIOD OF 48 HOUR FOR DISCUSSION.

 5. CONTRACTOR TO STAKE ALL TREE, PALM, AND SHRUB LOCATIONS FOR LANDSCAPE ARCHITECTS APPROVAL PRIOR TO PLANTING.

 6. LANDSCAPE ARCHITECT WILL NOT BE RESPONSIBLE FOR LOCATION AND
- PLACEMENT OF TREES AND PALMS UNLESS THE LOCATION WAS APPROVED BY LANDSCAPE ARCHITECT
- BILL TREE AND PALM CANOPIES MUST BE A MINIMUM OF 3'-5' FROM ANY BUILDING WALLS OR BUILDING WINDOWS WHEN THE PLANT REACHES IT'S
- ALL PLANT MATERIALS SHALL BE SIZED ACCORDING TO THE ARIZONA
- AURENMY ASSOCIATION STANDARDS, PLANT IMPERIAL SITES IN ON IMPROVING THE AURENMENT ASSOCIATION STANDARDS, PLANT IMPERIAL SITES IN ON IMPROVING THE AMERICAN ASSOCIATION OF HURSERYMEN STANDARDS.
 ALL NEWLY INSTALLED IREES ARE TO BE STAKED IN PLACE PER THE LANDSCAPE ARCHITECTS DETAILS FOUND WITHIN THE PLAN SET OR WITHIN THE LANDSCAPE ARCHITECTS DETAILS FOUND WITHIN THE PLAN SET OR WITHIN THE LANDSCAPE ARCHITECTS DETAIL AND SPECIFICATION BOOKET.
- DEVELOPED FOR THE PROJECT.

 10. ACID ETCH IMPERVIOUS SOILS AS REQUIRED AT PROPOSED TREE LOCATIONS
- ACLIDE L'OR HINFERVIOUS SOIRS AS REQUIRED AT PROPOSED TREE L'OCATIC TO ENSURE PLANT HEALTH AND VITALITY. SUB-CONTRACTOR TO TREAT ALL D.G. AREAS WITHIN THE LIMITS OF CONSTRUCTION WITH ONE FINAL APPLICATION OF AN APPROVED PRE-EMERGENT HERBICIDE AT THE TIME OF ACCEPTANCE BY THE OWNER.
- 12. CACTI SHALL RECEIVE NO SUPPLEMENTAL IRRIGATION UNLESS OTHERWISE NOTED OR IDENTIFIED WITHIN THE LANDSCAPE ARCHITECT'S IRRIGATION
- DKAWINGS. NO PLANT SURSTITUTIONS TYPE OF QUANTITY DEVIATIONS FROM THE APPROVED LANDSCAPE OR IRRIGATION PLANS WITHOUT PERMISSION FROM THE LANDSCAPE ARCHITECT.

 14. ALL R.O.W. PLANT MATERIAL TO BE IN COMPLIANCE WITH THE ARIZONA
- DEPARTMENT OF WATER RESOURCES LOW WATER USE PLANT LIST.

 15. EXISTING TREES AND SHRUBS IN R.O.W. TO REMAIN OR BE RELOCATED BY
- EXISING INCES AND SHRUBSIN IN CUN. TO REMAIN ON BE RELOCATED BY CONTRACTOR. ANY PLANT MATERIAL DAMAGED OR DESTROYOU WILL BE REPLACED IN KIND BY THE CONTRACTOR.
 ALL LANDSCAPE AREAS SHALL RECEIVE 2" D.G. UNILESS NOTED. COLOR TO BE SELECTED BY OWNER UNLESS NOTED. ALL D.G. SAMPLES SHALL BE
- SUBMITTED TO THE LANDSCAPE ARCHITECT FOR APPROVAL
- ROUGH GRADING TO WITHIN +0 10 FOOT, INCLUDING ALL BERMS AND/OF
- ROUGH GRADING I OWIHIN "JUID FOOT, INCLUDING ALL BEAMS AND/OR SWALES AND RETENTION AREAS WILL BE PROVIDED BY BUILDER / DEVELOPER OR THE OWNERS AGENT PRIOR TO PLANT INSTALLATION. ANY DISCREPANCIES FOUND BETWEEN PLANS, SPECIFICATIONS, AND SITE SHALL BE BROUGHT TO THE ATTENTION OF THE LANDSCAPE ARCHITECT FOR RESOLUTION.
- 19. THE LANDSCAPE ARCHITECT HAS THE OPTION TO REJECT ANY PLANT
- MATERIALS DEEMED UNACCEPTABLE UPON DELIVERY TO SITE.

 20. FINAL BUILDING PERMIT CANNOT BE OBTAINED UNTIL BONDING ON APPROVED ASSURANCES IS PROVIDED FOR LANDSCAPING WITHIN T RIGHT-OF-WAY.

 21. ACKNOWLEDGE REQUIREMENT OF COUNTY DUST CONTROL PERMIT AND
- LANDSCAPE PERMIT FOR ALL LANDSCAPE WORK WITHIN THE PROJECT ON
- ENIODATE FERMIN FOR ALL DANDSCAFE WORK WINININ HE FROZECTON RESIDENTIAL, COMMERCIAL, AND INDUSTRIAL SUBDIVISIONS. ALL ON-SITE SIDEWALS SHALL HAVE A MAXIMUM SLOPE OF 1:20 WITH THE MAXIMUM CROSS SLOPE OF 1:50, ALL CURSE MUST PROVIDE ACCESSIBLE RAMPS PURSUANT TO THE AMERICAN WITH DISABILITIES ACT (ADA) STANDARDS
 23. TREES, SHRUBS, VINES, GROUNDCOVER, AND TURF WHICH HAVE TO BE
- REPLACED UNDER TERMS OF THE GUARANTEE. SHALL BE GUARANTEED FOR
- REPEACED UNIDER TERMS OF THE OWNAMINES SHALL BE GUARANTIES OF AN ADDITIONAL SIXTY (3D DAYS FROM THE DATE OF REPLACEMENT.

 24. ALL POOLS, SIGNS AND MONUMENT WALLS REQUIRE A SEPARATE BUILDING APPROVAL AND FERMITS.

 25. THE CONTRACTOR SHALL PROVIDE ALL REQUIRED SHOP DRAWINGS TO THE
- LANDSCAPE ARCHITECT FOR REVIEW AND APPROVAL PRIOR TO THE BEGINNING OF CONSTRUCTION, REQUIRED SHOP DRAWINGS MAY INCLUDE BUT ARE NOT LIMITED TO WALLS, COLUMNS, ENTRY GATES, POOL FENCE BUI ARE NOI LIMILED 10 WALLS, COLUMN, ENRY GAILS, POOL FEATS, AND/OR WATER FEATURES, SHOULD A DISPUTE ARESE WITH ANY DESIGN ELEMENT REQUIRING SPONDED PRAWINGS, HE LANDSCAFE ARCHITECT SHALL ONLY ASSUMENT OF THE SHAPPING ONLY ASSUMENT OF THE CHARGE OF THE
- ALL TREES WITHIN THE SIGHT TRIANGLE AND DISTANCE AREAS SHALL BE MAINTAINED TO A MINIMUM CANOPY CLEARANCE OF 7"-0".
- 28. THERE IS NO FIRE LINE BACK FLOW PREVENTER ON THIS SITE

irrigation notes

- IRRIGATION DESIGN SHALL COMPLY WITH THE INTENT OF THE CITY OF AVONDALE WATER CONSERVATION, LANDSCAPING AND WATER WASTE ORDINANCE.
 CONTRACTOR TO CONTACT THE LOCAL UNDERGROUND UTILITY
- SERVICES FOR UTILITY LOCATION AND IDENTIFICATION. STAKE ALL LITHTIES, INCLUDING SEWER AND DRAINAGE PRIOR TO ANY
- STARE ALL UTILITIES, INCLUDING SEWER AND DRAINAGE PRIOR TO AN EXCAVATION, CONFLICTS SHALL BE REPORTED TO THE ARCHITECTICANDSCAPE ARCHITECT FOR RESOLUTION, PEPFORME EXCAVATION IN THE VICINITY OF UNDERGROUND UTILITIES WITH CARE AND IF NECESSARY, BY HAND. THE CONTRACTOR BEARS FULL RESPONSIBILITY FOR THIS WORK AND DISRUPTION OR DAMAGE TO UTILITIES SHALL BE REPAIRED IMMEDIATELY AT NO EXPENSE TO THE
- OWNER.

 REFER TO CIVIL ENGINEER'S UTILITY AND PRECISE GRADING PLANS FOR UTILITY LOCATION AND FINAL GRADING. IF ACTUAL SITE CONDITIONS VARY FROM WHAT IS SHOWN ON THE PLANS, CONTACT THE ARCHITECT FOR DIRECTION AS TO HOW TO PROCEED. VERIFY LOCATIONS OF PERTINENT SITE IMPROVEMENTS INSTALLED UNDER OTHER SECTIONS. IF ANY PART OF THIS PLAN CANNOT BE FOLLOWED DUE TO SITE CONDITIONS, CONTACT ARCHITECT FOR INSTRUCTIONS PRIOR TO COMMENCING WORK.
 THE DESIGN OF THE IRRIGATION SYSTEM SHALL BE THE RESPONSIBILITY OF
- OF THE CONTRACTOR PER THE PROJECT SPECIFICATIONS. THE CONTRACTOR SHALL SUBMIT IRRIGATION AS-BUILT DESIGN DRAWINGS AND ASSOCIATED DOCUMENTATION TO THE ARCHITECT FOR AND ASSOCIATED DOCUMENTATION TO THE ARCHITECT FOR APPROVAL FROIR TO INSTALLATION. THE IRRIGATION SYSTEM SHALL BE RUN WITH A FULLY AUTOMATED IRRIGATION CONTROLLER. RUN TIME SHALL BE ADJUSTED ACCORDING TO SEASON, LOCATION AND PLANT PERFORMANCE. DRIP EMITTERS SHALL BE USED FOR ALL PLANT MATERIAL EXCEPT SOD AND POSSIBLY PERENNIAL GROUND COVERS THESE AREAS SHALL BE IRRIGATED WITH SPRAY EMITTERS APPROPRIATED DESIGNED TO AVOID OVER-SPRAY ONTO IMPERMEABLE SURFACES AND
- DESIGNED TO AVOID OVER-SPRAY ONTO IMPERMEABLE SURFACES AND ADJACENT PAYING.
 IRRIGATION EQUIPMENT NOT OTHERWISE DETAILED OR SPECIFIED SHALL BE INSTALLED PER MANUFACTURER'S RECOMMENDATIONS AND REPORTED THE PROPERTY OF THE PR SPECIFICATIONS.
- IF THERE ARE ANY DISCREPANCIES WITH VALVE SIZES, METER SIZES, IF I HERE ARE ANT LOSS, AREPARCIES WITH YALVE SIZES, WHERE XIZES, WAIEN PRESS, WAIEN PRESS, WAIEN PRESS, WAIEN PRESS, WAIEN PRESS, WAIEN PRESS, OR LAYOUT - THE CONTRACTOR IS TO NOTIFY THE LANDSCAPE ARCHITECT WITHIN ONE BUSINESS DAY TO DISCUSS AND ADDRESS THE ISSUE(S).

 DEPTH OF BURY OF THE MANIFULE SHALL BE A MINIMUM OF 18", DEPTH DEPTH OF BURY OF THE MANIFULE SHALL BE A MINIMUM OF 18".
- OF BURY ON LATERAL PIPING SHALL BE A MINIMUM OF 12". THE MAIN OF DURY ON CARRAL PIPING SHALL BE A MINIMUM OF 12. THE MED LINE AND LATERAL LINES SHALL BE SCHEDULE & 0 PVC SOLVENI WELD PIPE WITH INTEGRAL LINES SHALL BE SCHEDULE SHERNCHES AND BENDING OF PIPE TO A VOID FITTINGS WILL NOT BE ACCEPTED. FOR MEETS THAT OPERATE MORE SALLONS PER MINUTE (G.P.M.) THAN THE MEETS THAT OPERATE MORE SALLONS PER MINUTE (G.P.M.) THAN THE MEETS APACITY. CONTRACTOR SHALL PROGRAM THE
- CONTROLLER TO OPERATE VALVES TO THE MAXIMUM METER CAPACITY
- CONTROLLER TO OPERATE VALVES TO THE MAXIMUM MELEY CAPACITY A METER AND THE MAXIMUM MELEY CAPACITY A METER AND THE METER RUN THIS STO OPERATE ALL POINT OF CONNECTION A CONNECTION TO POTABLE WATER FOR PRICATION PURPOSES WILL BE MADE ON THE PROPERTY, SEE UTILITY PLANS FOR EXACT LOCATION OF METER. VALVE BOXES AND THE COURTE OF THE METER OF THE M WATER PRESSURE AT WATER METER PRIOR TO START OF WORK, A
- WATER PRESSURE AT WATER MIETER FROM TO 3 TAIN TO P WORL A
 BOOSTER PUMP MAY BE REQUIRED IT HITE PRESSURE IS TOO LOW.

 12. BACKFLOW PREVENTER TO BE VERIFIED IN PIELD BY LANDSCAPE
 ARCHITECT OR OWNER PRIOR TO INSTALLATION.

 13. ELECTRICAL POWER/PEDESTAL(S) LOCATIONS TO BE PROVIDED BY
- OTHERS, FINAL LOCATION OF CONTROLLER TO BE STAKED AND APPROVED BY LANDSCAPE ARCHITECT OR OWNER PRIOR TO INSTALLATION.
- 14. ALL 24 VOLT WIRING FROM CONTROLLER TO ELECTRIC VALVES SHALL BE MINIMUM 14 GAUGE SOLID COPPER DIRECT BURIAL WIRE.

 PER ARIZONA HOUSE BILL 2256, A BLUE 18 GAUGE TRACER WIRE SHALL

 BE INSTALLED WITH 2" AND LARGER MAINLINES. 6" INCHES OF WHICH
- SHALL BE COILED INSIDE THE CONTROLLER.

 16. MAINLINE AND LATERAL PIPING IS SCHEMATIC. LOCATE ALL MAINLINES AND EQUIPMENT OUTSIDE OF THE PUBLIC ROW AND PILE BUT WITHIN
- THE LANDSCAPE AREAS. CONTRACTOR TO ADJUST AS NECESSARY IN FIELD.

 ALL MANULINES, LATERAL LINES AND WIRING UNDER PAVEMENT TO BE IN SEPARATE SCHEDULE 80 PVC SICHEDULE SIEVES SHALL BE A MINIMUM INSIDE DIAMETER OF 2 TIMES THE IRRIGATION LINE
- DIAMETER, VALVE WIRING SHALL BE WITHIN SEPARATE ADJACENT SLEEVE.
 THE CONTRACTOR SHALL PROVIDE IN-LINE AND/OR SPRINKLER CHECK
 VALVES AS REQUIRED THROUGHOUT THE IRRIGATION SYSTEM LOCATED
 WITHIN A SLOPED AREAS TO PREVENT LOW IRRIGATION HEAD
- 19. PROVIDE SEPARATE VALVES FOR TREES AND SHRUBS, ALL DRIP ZONE
- PROVIDE SEPARATE VALVES FOR INCES AND SHRUBS. ALL DRIP ZONE PVC SHALL BE A MINIMUM 3/4" CLASS 200.
 ALL PIPING IS TO BE FUSHED FOR A PERIOD OF 10 MINUTES PRIOR TO THE INSTALLATION OF EMITTERS. CONTRACTOR SHALL BE RESPONSIBLE FOR NECESSARY FLUSHING OF SYSTEM DUE TO CLOGGING FOR THE DURATION OF THE LANDSCAPE MAINTENANCE PER SPECIFICATIONS. MAXIMUM LENGTH OF MICRO-TUBING ON DRIP 7ONE TO BE 5' WITH 6
- MAXIMUM LENGTH OF MICRO-TUBING ON DRIP ZONE TO BE 5. WITH 6"
 MIN. EXPOSED AT THE EMITTEE BHD.
 CONTRACTOR TO GUARANITEE 100% IRRIGATION COVERAGE FOR ALL
 LAWIN AREAS, CONTRACTOR TO NOTIFY LANDSCAPE ARCHITECT OF
 ANY LAWIN AREAS WITHOUT FULL COVERAGE.
 IRRIGATION HEADS SHALL BE SET PERPENDICULAR TO FINISH GRADE
- UNLESS OTHERWISE SPECIFIED

- eifw of scottsdale notes:
- AREAS OF DECOMPOSED GRANITE WITHOUT PLANT MATERIALS/ GROUNDCOVERS SHALL NOT EXCEED DIMENSIONS OF MORE THAN 7' IN ANY ONE DIRECTION, MEASURED BETWEEN PLANT CANOPIES AND/OR COVERAGE.
- A MINIMUM OF 50% OF THE PROVIDED TREES SHALL BE MATURE TREES, PURSUANT TO THE CITY OF SCOTTSDALE'S ZONING ORDINANCE ARTICLE X, SECTION 10:301. AS DEFINED IN THE CITY OF SCOTTSDALE'S ZONING
- ORDINANCE ARTICLE III, SECTION 3,100
 A SINGLE TRUNK TREE'S CALIPER SIZE, THAT IS TO BE EQUAL OR LESS THAN 4" SHALL BE DETERMINED BY UTILIZING THE SMALLEST DIAMETER OF THE TRUNK 6
 INCHES ABOVE FINISHED GRADE ADJACENT TO THE TRUNK. TREE'S CALIPER SIZE, FOR SINGLE TRUNK TREES THAT ARE TO HAVE A DIAMETER GREATER THAN 4-INCHES, SHALL BE DETERMINED BY UTILIZING THE SMALLEST DIAMETER OF THE TRUNK 12-INCHES ABOVE FINISHED GRADE AD JACENT TO THE TRUNK. A MULTIPLE TRUNK TREE'S CALIPER SIZE IS MEASURED AT 6" ABOVE THE LOCATION THAT THE TRUNK SPLITS ORIGINATES, OR 6" ABOVE FINISHED GRADE IF ALL
- TRUNKS ORIGINATE FROM THE SOIL.

 AREA WITHIN THE SIGHT DISTANCE TRIANGLES IS TO BE CLEAR OF LANDSCAPING, SIGNS, OR OTHER VISIBILITY OBSTRUCTIONS WITH A HEIGHT GREATER THAN 2 FEET. TREES WITHIN THE SAFETY TRIANGLE SHALL HAVE A CANORY THAT REGINS AT 7 FEET IN HEIGHT UPON INSTALLATION. ALL HEIGHTS ARE MEASURED FROM NEAREST STREET LINE ELEVATION.

NO TURF AREAS ARE TO BE PROVIDED.

- RETENTION/ DETENTION BASINS SHALL BE CONSTRUCTED SOLELY FROM THE APPROVED DESIGN (ADDITIONAL FILL, BOULDERS, ETC.) SHALL REQUIRE ADDITIONAL FINAL PLANS STAFF REVIEW AND APPROVAL.
 ALL RIGHTS-OF-WAY ADJACENT TO THIS PROPERTY SHALL BE LANDSCAPED
- AND MAINTAINED BY THE PROPERTY OWNER.
 PRIOR TO THE ESTABLISHMENT OF WATER SERVICE, NON-RESIDENTIAL PROJECTS WITH AN ESTIMATED ANNUAL WATER DEMAND OF TEN (10) ACRE-FEET OF MORE SHALL SUBMIT A CONSERVATION PLAN IN CONFORMANCE WITH SECTIONS 49-245 THROUGH 49-248 OF THE CITY CODE TO THE WATER
- CONSERVATION OFFICE.

 NO LIGHTING IS PROPOSED WITH THIS SUBMITTAL.
- THE LANDSCAPE SPECIFICATION SECTION(S) OF THESE PLANS ARE NOT REVIEWED AND SHALL NOT BE PART OF THE CITY OF SCOTTSDALE'S APPROVAL. ALL SIGNS REQUIRE SEPARATE PERMITS AND APPROVALS
- NEW LANDSCAPING, INCLUDING SALVAGED PLANT MATERIAL, AND LANDSCAPING INDICATED TO REMAIN, WHICH IS DESTROYED, DAMAGED, OR EXPIRES DURING CONSTRUCTION SHALL BE REPLACED WITH LIKE SIZE, KIND, AND QUANTITY PRIOR TO THE ISSUANCE OF THE CERTIFICATE OF OCCUPANCY / LETTER OF ACCEPTANCE TO THE SATISFACTION OF THE INSPECTION SERVICES

NO NATIVE PLANTS WILL BE DISTURBED DURING ENTIRE DURATION OF CONSTRUCTION

LANDSCAPE PLAN APPROVED CITY OF SCOTTSDALE

CASE NUMBER

APPROVED BY

DATE

CONSTRUCTION AND INSTALLATION SHALL BE IN ACCORDANCE WITH THIS PLAN AND ALL DEVIATIONS WILL REQUIRE REAPPROVAL. THE CITY WILL NOT ISSUE A C OF O UNTIL INSPECTION SERVICES STAFF APPROVES THE LANDSCAPE INSTALLATION.

ALL LANDSCAPE AREAS AND MATERIALS, INCLUDING THOSE LOCATED IN PUBLIC RIGHTS-OF-WAY, SHALL BE MAINTAINED IN A HEALTHY, NEAT, CLEAN AND WEED- FREE CONDITION. AMERICAN NATIONAL STANDARDS INSTITUTE (ANSI) A300 STANDARD PRACTICES FOR PRUNING, SUPPORT SYSTEMS, AND SAFETY SHALL BE USED FOR MAINTENANCE CRITERIA. THIS SHALL BE THE RESPONSIBILITY OF THE PROPERTY OWNER.







CONVERSION

0001 NORTH 92nd STREET SCOTTSDALE, ARIZONA STORAGE

NOTES

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SHEET

COVER !

JOB NO DRAWN BY SUBMITTED:

REVISED

25-015 B. PAUL 04.07.2025

SHEET L0.01

	trees	botanical name common name	qty	
	11000			
		ACACIA STENOPHYLLA SHOESTRING ACACIA	23	
	1	PARKINSONIA FLORIDUM BLUE PALO VERDE	11	
A.	(B)	EBENOPSIS EBANO TEXAS EBONY	4	
	H	PROSOPIS CHILENSIS CHILEAN MESQUITE	3	(
10				

extistina plant leaend

existin	g piant legend	
	botanical name common name	qty
existing trees		
	ACACIA STENOPHYLLA SHOESTRING ACACIA	12
100	PARKINSONIA FLORIDUM BLUE PALO VERDE	17
E	EBENOPSIS EBANO TEXAS EBONY	3
	PROSOPIS CHILENSIS CHILEAN MESQUITE	26
r	RHUS LANCEA AFRICAN SUMBAC	2
existing palm	s	
E	PHOENIX DACTYLIFERA DATE PALM	6
existing shrub	S	
®	BOUGAINVILLEA 'ROSENKA' ROSENKA BOUGAINVILLEA	32
(CAESALPINIA PULCHERRIMA RED BIRD OF PARADISE	60
-	CALLIANDRA ERIOPHYLLA PINK FAIRY DUSTER	11
(4)	LARREA TRIDENTATA CREOSOTE	13
•	LEUCOPHYLLUM FRUTESCENS 'COMPACTA' COMPACT TEXAS RANGER	213
e	NERIUM OLEANDER PETITE PINK OLEANDER	135
(6)	RUELLIA PENINSULARIS BAJA RUELLIA	51
exsiting acce	ents	
(DASYLIRION WHEELERI DESERT SPOON	13
*	FOUQUIERIA SPLENDENS OCOTILLO	2
•	CARNEGIEA GIGANTEA SAGUARO	3
exsiting groun	ndcovers	
•	LANTANA 'NEW GOLD' NEW GOLD LANTANA	20
exsiting inerts		
(3)	EXISTING DECOMPOSED GRANITE TO REMAIN	62,834 S.F.
(EXISTING RIP RAP TO REMAIN	7,278 S.F.
B	EXISTING GRANITE BOULDERS	

plant legend


		botanical name common name	emitters	size	qty	comments
t	rees					
	A(H)	ACACIA STENOPHYLLA SHOESTRING ACACIA	(5 @ 1.0 GPH)	24" BOX	9	8.0H., 3.0W., 1.0 CAL. STAKE IN PLACE
が		PROSOPIS CHILENSIS CHILEAN MESQUITE	(5 @ 1.0 GPH)	24" BOX	3	6.0H., 3.0W., 1.0 CAL. STAKE IN PLACE
S	hrubs					
	Ø	BOUGAINVILLEA 'ROSENKA' ROSENKA BOUGAINVILLEA	(1 @ 1.0 GPH)	5 GAL.	10	
	3	LARREA TRIDENTATA CREOSOTE	(1 @ 1.0 GPH)	5 GAL.	18	
	0	LEUCOPHYLLUM FRUTESCENS 'COMPACTA' COMPACT TEXAS RANGER	(1 @ 1.0 GPH)	5 GAL.	21	
	0	NERIUM OLEANDER PETITE PINK OLEANDER	(1 @ 1.0 GPH)	5 GAL.	3	
	Φ	RUELLIA PENINSULARIS BAJA RUELLIA	(1 @ 1.0 GPH)	5 GAL.	5	
	\bigcirc	TECOMA STANS 'GOLD STAR' 'GOLD STAR' YELLOW BELLS	(1 @ 1.0 GPH)	5 GAL.	8	
C	ccents					
	6	DASYLIRION WHEELERI DESERT SPOON	(1 @ 1.0 GPH)	5 GAL.	2	
groundcovers						
	③	ACACIA REDOLENS DESERT CARPET	(1 @ 1.0 GPH)	5 GAL.	13	
	•	LANTANA 'NEW GOLD' NEW GOLD LANTANA	(1 @ 1.0 GPH)	5 GAL.	37	
ir	nerts					
	0	NEW DECOMPOSED GRANITE COLOR:		3/4" SCRND	6,220 S.F.	2" MINIMUM DEPTH IN ALL PLANTERS

existing landscape & irrigation notes

- SITE VERIFY ALL EXISTING CONDITIONS PRIOR TO BIDDING, ANY DISCREPANCIES ARE TO BE BROUGHT
- 1. SIE VERIFY ALL EXISTING CONDITIONS PRIOR TO BIDDING, ANY DISCREPANCIES ARE TO BE BROUGHT TO THE LANDSCAFE ARCHITECTS ATTENTION WITHIN 24 HOURS OF THE OBSERVATION.

 CONTRACTOR TO INSPECT EXISTING RIREGATION SYSTEM AND VERIFY THAT THE SYSTEM IS WORKING PROPERTY.

 ALL PLANT MATERIAL DESIGNATED AS "EXISTING TO REMAIN" SHALL BE PROTECTED DURING ALL PHASES OF CONSTRUCTION. ANY TREETES THAT DE DUE TO: LACK OF WATER, LACK OF MAINTENANCE OR AS TO AND THE CONTROL AND THE CONTROL OF THE CONTROL ON THE CONTROL OF THE CO

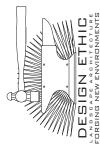







STORAGE CONVERSION


10001 NORTH 92nd STREET SCOTTSDALE, ARIZONA

LANDSCAPE LEGENDS & NOTES

JOB NO: 25-015

DRAWN BY: B. PAUL SUBMITTED: 04.07.2025 REVISED:

> SHEET L2.00

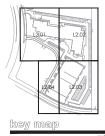

MATCHLINE 'B' - SEE SHEET L2.03

existing plant legend



PARKINSONIA FLORIDUM BLUE PALO VERDE

EBENOPSIS EBANO TEXAS EBONY

PROSOPIS CHILENSIS CHILEAN MESQUITE

RHUS LANCEA AFRICAN SUMBAC



PHOENIX DACTYLIFERA DATE PALM

BOUGAINVILLEA 'ROSENKA' ROSENKA BOUGAINVILLEA

CAESALPINIA PULCHERRIMA RED BIRD OF PARADISE

CALLIANDRA ERIOPHYLLA PINK FAIRY DUSTER

LARREA TRIDENTATA CREOSOTE

LEUCOPHYLLUM FRUTESCENS 'COMPACTA' COMPACT TEXAS RANGER

NERIUM OLEANDER PETITE PINK OLEANDER

RUELLIA PENINSULARIS BAJA RUELLIA **(e)**

DASYLIRION WHEELERI DESERT SPOON **(B)**

FOUQUIERIA SPLENDENS OCOTILLO

CARNEGIEA GIGANTEA SAGUARO

EANTANA 'NEW GOLD' NEW GOLD LANTANA

(3)

EXISTING DECOMPOSED GRANITE TO REMAIN



EXISTING RIP RAP TO REMAIN



EXISTING GRANITE BOULDERS

plant legend



BOUGAINVILLEA 'ROSENKA ROSENKA BOUGAINVILLEA

LARREA TRIDENTATA CREOSOTE 3

LEUCOPHYLLUM FRUTESCENS 'COMPACTA' COMPACT TEXAS RANGER 0

NERIUM OLEANDER PETITE PINK OLEANDER

RUELLIA PENINSULARIS BAJA RUELLIA Φ

TECOMA STANS 'GOLD STAR' 'GOLD STAR' YELLOW BELLS

DASYLIRION WHEELERI DESERT SPOON

groundcovers

ACACIA REDOLENS DESERT CARPET

LANTANA 'NEW GOLD' NEW GOLD LANTANA



NEW DECOMPOSED GRANITE COLOR:

planting key notes

PROPERTY LINE / RIGHT OF WAY LINE.

DECOMPOSED GRANITE IN ALL PLANTING AREAS. SIGHT VISIBILITY TRIANGLE, MAXIMUM MATURE PLANT MATERIAL HEIGHT IN THE SIGHT VISIBILITY TRIANGLES IS 24 INCHES.

ACCESSIBLE RAMP. SEE CIVIL ENG. PLANS.

SIDEWALK. SEE CIVIL ENG. PLANS.

CURB. SEE CIVIL ENG. PLANS.

EXISTING FIRE HYDRANT 3'-0" CLEAR OF ALL PLANT MATERIAL.

NEW EXTERIOR FIRE RISER AND FDC

(12)

(B)

NEW 8'-0" HT. CMU SCREEN WALL. SEE ARCH. PLAN.

NEW 8'-0" HT. SOLID AUTOMATIC SLIDING GATE. SEE ARCH. PLANS. NEW WROUGHT IRON FENCE. SEE ARCH. PLANS.

EXISTING TRASH ENCLOSURE. SEE ARCH. PLANS.


EXISTING SITE LIGHTING, SEE ARCH, PLANS, EXISTING STORMWATER RETENTION. SEE CIVIL ENG. PLANS.

15 EXISTING DECOMPOSED GRANITE TO REMAIN.

(6) EXISTING RIP RAP TO REMAIN.

RELOCATED FIRE HYDRANT.

EXISTING TRANSFORMER LOCATION. MAINTAIN 3' ACCESS & CLEARANCE AROUND ALL EDGES. ALLOW FOR 12' CLEAR OPERATIONAL AREA IMMEDIATELY IN FRONT OF TRANSFORMER.

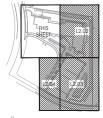

key map









CONVERSION

STORAGE

PLANTING PLAN

10001 NORTH 92nd STREET SCOTTSDALE, ARIZONA

JOB NO: DRAWN BY: B. PAUL SUBMITTED: 04.07.2025 REVISED:

> SHEET L2.01

MATCHLINE 'C

existing plant legend



PARKINSONIA FLORIDUM BLUE PALO VERDE



EBENOPSIS EBANO TEXAS EBONY

PROSOPIS CHILENSIS CHILEAN MESQUITE

RHUS LANCEA AFRICAN SUMBAC



PHOENIX DACTYLIFERA DATE PALM

- BOUGAINVILLEA 'ROSENKA' ROSENKA BOUGAINVILLEA **(b)**
- CAESALPINIA PULCHERRIMA RED BIRD OF PARADISE
- CALLIANDRA ERIOPHYLLA PINK FAIRY DUSTER
- LARREA TRIDENTATA CREOSOTE
- LEUCOPHYLLUM FRUTESCENS 'COMPACTA' COMPACT TEXAS RANGER
- NERIUM OLEANDER PETITE PINK OLEANDER
- RUELLIA PENINSULARIS BAJA RUELLIA **(e)**

- DASYLIRION WHEELERI DESERT SPOON **(P)**
- FOUQUIERIA SPLENDENS OCOTILLO
- CARNEGIEA GIGANTEA SAGUARO

exsiting groundcovers

EANTANA 'NEW GOLD' NEW GOLD LANTANA



EXISTING DECOMPOSED GRANITE TO REMAIN



EXISTING RIP RAP TO REMAIN



plant legend



ACACIA STENOPHYLLA SHOESTRING ACACIA

PROSOPIS CHILENSIS CHILEAN MESQUITE

BOUGAINVILLEA 'ROSENKA' ROSENKA BOUGAINVILLEA LARREA TRIDENTATA CREOSOTE

3 LEUCOPHYLLUM FRUTESCENS 'COMPACTA' COMPACT TEXAS RANGER 0

NERIUM OLEANDER PETITE PINK OLEANDER

RUELLIA PENINSULARIS BAJA RUELLIA Φ

TECOMA STANS 'GOLD STAR' 'GOLD STAR' YELLOW BELLS

DASYLIRION WHEELERI DESERT SPOON

groundcovers

ACACIA REDOLENS DESERT CARPET

LANTANA 'NEW GOLD' NEW GOLD LANTANA

(12)

(B)



NEW DECOMPOSED GRANITE COLOR:

planting key notes

PROPERTY LINE / RIGHT OF WAY LINE.

DECOMPOSED GRANITE IN ALL PLANTING AREAS. SIGHT VISIBILITY TRIANGLE, MAXIMUM MATURE PLANT MATERIAL HEIGHT IN THE SIGHT VISIBILITY TRIANGLES IS 24 INCHES.

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SIDEWALK. SEE CIVIL ENG. PLANS.

CURB. SEE CIVIL ENG. PLANS.

EXISTING FIRE HYDRANT 3'-0" CLEAR OF ALL PLANT MATERIAL.

NEW EXTERIOR FIRE RISER AND FDC NEW 8'-0" HT. CMU SCREEN WALL. SEE ARCH. PLAN.

NEW 8'-0" HT. SOLID AUTOMATIC SLIDING GATE. SEE ARCH. PLANS.

NEW WROUGHT IRON FENCE. SEE ARCH. PLANS. EXISTING TRASH ENCLOSURE. SEE ARCH. PLANS.


EXISTING SITE LIGHTING. SEE ARCH. PLANS. EXISTING STORMWATER RETENTION. SEE CIVIL ENG. PLANS.

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RELOCATED FIRE HYDRANT.

EXISTING TRANSFORMER LOCATION. MAINTAIN 3' ACCESS & CLEARANCE AROUND ALL EDGES. ALLOW FOR 12' CLEAR OPERATIONAL AREA IMMEDIATELY IN FRONT OF TRANSFORMER.



key map

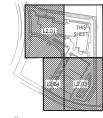



SCALE: 1" = 20'-0'

JOB NO: DRAWN BY: SUBMITTED:

REVISED:

B. PAUL 04.07.2025

25-015

SHEET L2.02

4 of 6

PLANTING PLAN

existing plant legend





EBENOPSIS EBANO TEXAS EBONY

PROSOPIS CHILENSIS CHILEAN MESQUITE

RHUS LANCEA AFRICAN SUMBAC



PHOENIX DACTYLIFERA DATE PALM

- BOUGAINVILLEA 'ROSENKA' ROSENKA BOUGAINVILLEA **(b)**
- CAESALPINIA PULCHERRIMA RED BIRD OF PARADISE
- CALLIANDRA ERIOPHYLLA PINK FAIRY DUSTER
- LARREA TRIDENTATA CREOSOTE
- LEUCOPHYLLUM FRUTESCENS 'COMPACTA' COMPACT TEXAS RANGER
- NERIUM OLEANDER PETITE PINK OLEANDER
- RUELLIA PENINSULARIS BAJA RUELLIA **(e)**

- DASYLIRION WHEELERI DESERT SPOON **(B)**
- FOUQUIERIA SPLENDENS OCOTILLO
- CARNEGIEA GIGANTEA SAGUARO

exsiting groundcovers

EANTANA 'NEW GOLD' NEW GOLD LANTANA



EXISTING DECOMPOSED GRANITE TO REMAIN



EXISTING RIP RAP TO REMAIN



EXISTING GRANITE BOULDERS

plant legend



BOUGAINVILLEA 'ROSENKA ROSENKA BOUGAINVILLEA

LARREA TRIDENTATA CREOSOTE 3

LEUCOPHYLLUM FRUTESCENS 'COMPACTA' COMPACT TEXAS RANGER 0

RUELLIA PENINSULARIS BAJA RUELLIA Φ

TECOMA STANS 'GOLD STAR' 'GOLD STAR' YELLOW BELLS

DASYLIRION WHEELERI DESERT SPOON

groundcovers

ACACIA REDOLENS DESERT CARPET

LANTANA 'NEW GOLD' NEW GOLD LANTANA



NEW DECOMPOSED GRANITE COLOR:

planting key notes

PROPERTY LINE / RIGHT OF WAY LINE.

DECOMPOSED GRANITE IN ALL PLANTING AREAS. SIGHT VISIBILITY TRIANGLE, MAXIMUM MATURE PLANT MATERIAL HEIGHT IN THE SIGHT VISIBILITY TRIANGLES IS 24 INCHES.

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SIDEWALK. SEE CIVIL ENG. PLANS.

CURB. SEE CIVIL ENG. PLANS.

EXISTING FIRE HYDRANT 3'-0" CLEAR OF ALL PLANT MATERIAL.

[12]

(B)

NEW EXTERIOR FIRE RISER AND FDC

NEW 8'-0" HT. CMU SCREEN WALL. SEE ARCH. PLAN. NEW 8'-0" HT. SOLID AUTOMATIC SLIDING GATE. SEE ARCH. PLANS.

NEW WROUGHT IRON FENCE. SEE ARCH. PLANS. EXISTING TRASH ENCLOSURE. SEE ARCH. PLANS.

EXISTING SITE LIGHTING, SEE ARCH, PLANS,

EXISTING STORMWATER RETENTION. SEE CIVIL ENG. PLANS. 15 EXISTING DECOMPOSED GRANITE TO REMAIN.

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RELOCATED FIRE HYDRANT.

EXISTING TRANSFORMER LOCATION. MAINTAIN 3' ACCESS & CLEARANCE AROUND ALL EDGES. ALLOW FOR 12' CLEAR OPERATIONAL AREA IMMEDIATELY IN FRONT OF TRANSFORMER.



key map



AR ZONASI Ball 811 or ottok fortsonasi CONVERSION 0001 NORTH 92nd STREET SCOTTSDALE, ARIZONA STORAGE

SCALE: 1" = 20'-0'

PLANTING PLAN

JOB NO: DRAWN BY: B. PAUL SUBMITTED: 04.07.2025

REVISED:

SHEET L2.03

existing plant legend





RHUS LANCEA AFRICAN SUMBAC



PHOENIX DACTYLIFERA DATE PALM

- BOUGAINVILLEA 'ROSENKA' ROSENKA BOUGAINVILLEA **(b)**
- CAESALPINIA PULCHERRIMA RED BIRD OF PARADISE
- CALLIANDRA ERIOPHYLLA PINK FAIRY DUSTER
- LARREA TRIDENTATA CREOSOTE
- LEUCOPHYLLUM FRUTESCENS 'COMPACTA' COMPACT TEXAS RANGER
- NERIUM OLEANDER PETITE PINK OLEANDER
- RUELLIA PENINSULARIS
 BAJA RUELLIA

- DASYLIRION WHEELERI DESERT SPOON **(%)**
- FOUQUIERIA SPLENDENS OCOTILLO
- CARNEGIEA GIGANTEA SAGUARO

exsiting groundcovers

EANTANA 'NEW GOLD' NEW GOLD LANTANA



EXISTING DECOMPOSED GRANITE TO REMAIN



EXISTING RIP RAP TO REMAIN



EXISTING GRANITE BOULDERS

plant legend



PROSOPIS CHILENSIS CHILEAN MESQUITE

BOUGAINVILLEA 'ROSENKA' ROSENKA BOUGAINVILLEA

LARREA TRIDENTATA CREOSOTE 3

LEUCOPHYLLUM FRUTESCENS 'COMPACTA' COMPACT TEXAS RANGER 0 NERIUM OLEANDER PETITE PINK OLEANDER

RUELLIA PENINSULARIS BAJA RUELLIA Φ

TECOMA STANS 'GOLD STAR' 'GOLD STAR' YELLOW BELLS

DASYLIRION WHEELERI DESERT SPOON

groundcovers

ACACIA REDOLENS DESERT CARPET LANTANA 'NEW GOLD' NEW GOLD LANTANA



NEW DECOMPOSED GRANITE COLOR:

planting key notes

PROPERTY LINE / RIGHT OF WAY LINE. DECOMPOSED GRANITE IN ALL PLANTING AREAS.

SIGHT VISIBILITY TRIANGLE, MAXIMUM MATURE PLANT MATERIAL HEIGHT IN THE SIGHT VISIBILITY TRIANGLES IS 24 INCHES.

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SIDEWALK. SEE CIVIL ENG. PLANS.

CURB. SEE CIVIL ENG. PLANS.

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NEW 8'-0" HT. SOLID AUTOMATIC SLIDING GATE. SEE ARCH. PLANS. NEW WROUGHT IRON FENCE. SEE ARCH. PLANS.

EXISTING TRASH ENCLOSURE. SEE ARCH. PLANS.

EXISTING SITE LIGHTING. SEE ARCH. PLANS. EXISTING STORMWATER RETENTION. SEE CIVIL ENG. PLANS.


15 EXISTING DECOMPOSED GRANITE TO REMAIN.

EXISTING RIP RAP TO REMAIN. (6) Ŏ

(12)

(B)

RELOCATED FIRE HYDRANT. EXISTING TRANSFORMER LOCATION. MAINTAIN 3' ACCESS & CLEARANCE AROUND ALL EDGES. ALLOW FOR 12' CLEAR OPERATIONAL AREA IMMEDIATELY IN FRONT OF TRANSFORMER.

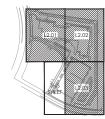

key map













CONVERSION

STORAGE

REVISED:

10001 NORTH 92nd STREET SCOTTSDALE, ARIZONA PLANTING PLAN

JOB NO: 25-015 DRAWN BY: B. PAUL SUBMITTED: 04.07.2025

> SHEET L2.04

existing plant legend

	botanical name common name	aty
existing_trees		
	ACACIA STENOPHYLLA SHOESTRING ACACIA	12
	PARKINSONIA FLORIDUM BLUE PALO VERDE	16
100	EBENOPSIS EBANO TEXAS EBONY	3
3	PROSOPIS CHILENSIS CHILEAN MESQUITE	26
	RHUS LANCEA AFRICAN SUMBAC	2
existing palm	S	
	PHOENIX DACTYLIFERA DATE PALM	6
existing shrub	S	
	BOUGAINVILLEA 'ROSENKA' ROSENKA BOUGAINVILLEA	32
	CAESALPINIA PULCHERRIMA RED BIRD OF PARADISE	60
	CALLIANDRA ERIOPHYLLA PINK FAIRY DUSTER	11
	LARREA TRIDENTATA CREOSOTE	13
	LEUCOPHYLLUM FRUTESCENS 'COMPACTA' COMPACT TEXAS RANGER	213

NERIUM OLEANDER PETITE PINK OLEANDER 135

RUELLIA PENINSULARIS BAJA RUELLIA

DASYLIRION WHEELERI DESERT SPOON FOUQUIERIA SPLENDENS OCOTILLO CARNEGIEA GIGANTEA SAGUARO

LANTANA 'NEW GOLD' NEW GOLD LANTANA


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EXISTING DECOMPOSED GRANITE 62,834 TO REMAIN S.F. 7,278 S.F.

plant l	plant legend				
	botanical name common name	emitters	size	gty	comments
trees					
	ACACIA STENOPHYLLA SHOESTRING ACACIA	(5 @ 1.0 GPH)	24" BOX	9	8.0H., 3.0W., 1.0 CAL. STAKE IN PLACE
shrubs	PROSOPIS JULIFLORA NATIVE MESQUITE	(5 @ 1.0 GPH)	24" BOX	3	6.0H., 3.0W., 1.0 CAL. STAKE IN PLACE
(6)	BOUGAINVILLEA 'ROSENKA' ROSENKA BOUGAINVILLEA	(1 @ 1.0 GPH)	5 GAL.	10	
	LARREA TRIDENTATA CREOSOTE	(1 @ 1.0 GPH)	5 GAL.	18	
	LEUCOPHYLLUM FRUTESCENS 'COMPACTA' COMPACT TEXAS RANGER	(1 @ 1.0 GPH)	5 GAL.	21	
6	NERIUM OLEANDER PETITE PINK OLEANDER	(1 @ 1.0 GPH)	5 GAL.	3	
	RUELLIA PENINSULARIS BAJA RUELLIA	(1 @ 1.0 GPH)	5 GAL.	5	
	TECOMA STANS 'GOLD STAR' 'GOLD STAR' YELLOW BELLS	(1 @ 1.0 GPH)	5 GAL.	8	
accents					
6	DASYLIRION WHEELERI DESERT SPOON	(1 @ 1.0 GPH)	5 GAL.	2	
groundcove	ers				
	ACACIA REDOLENS DESERT CARPET	(1 @ 1.0 GPH)	5 GAL.	13	
<u> </u>	LANTANA 'NEW GOLD' NEW GOLD LANTANA	(1 @ 1.0 GPH)	5 GAL.	37	
inerts					
②	3/4" SCREENED DECOMPOSED GRANITE		3/4" SCRND	6,220 S.F.	2" MINIMUM DEPTH IN ALL PLANTERS







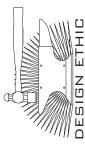




RENDERING

STORAGE CONVERSION 10001 NORTH 92nd STREET SCOTTSDALE, ARIZONA

JOB NO: DRAWN BY: B. PAUL SUBMITTED: 04.07.2025


SHEET RENDERING

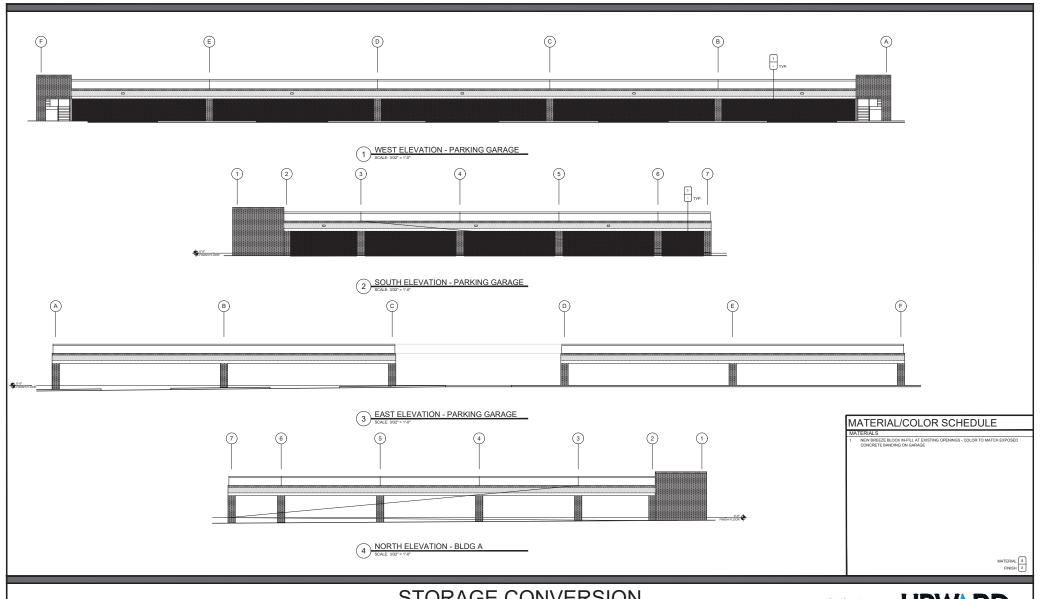

10001 N. 92nd Street Scottsdale, AZ. 85258






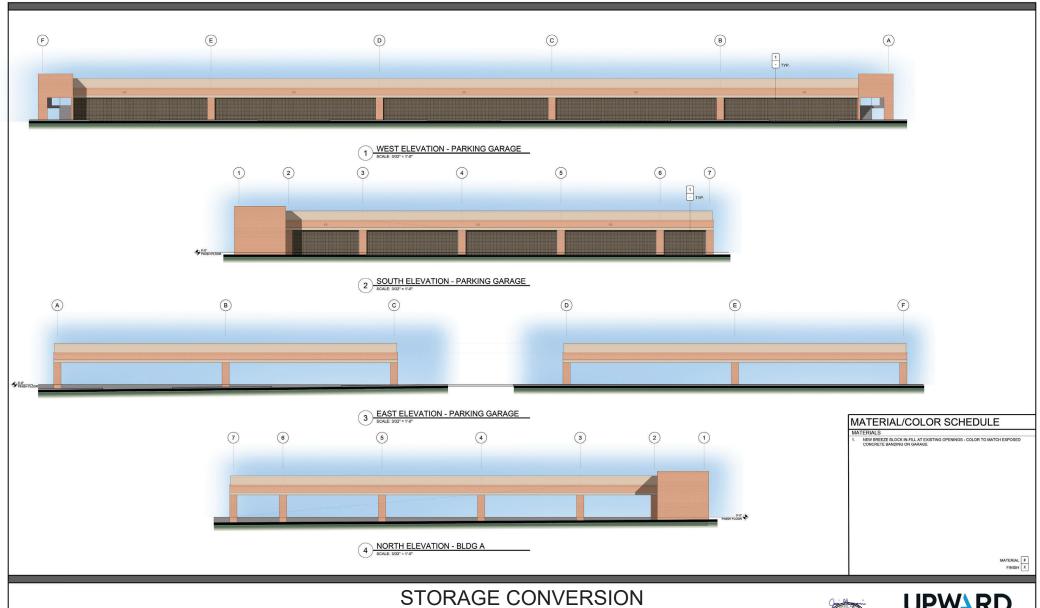

10001 N. 92nd Street Scottsdale, AZ. 85258






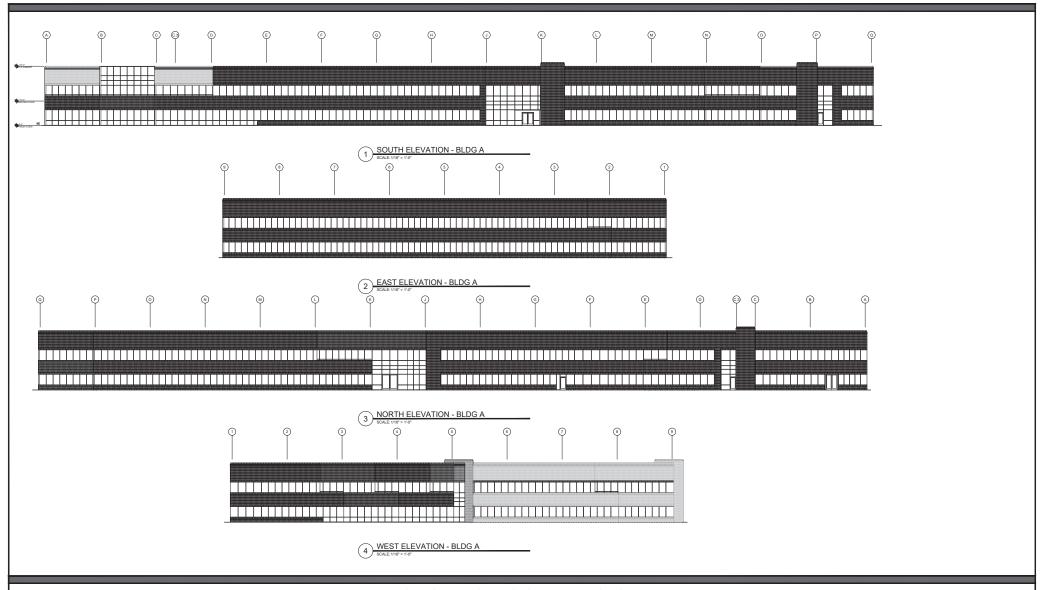

10001 N. 92nd Street Scottsdale, AZ. 85258






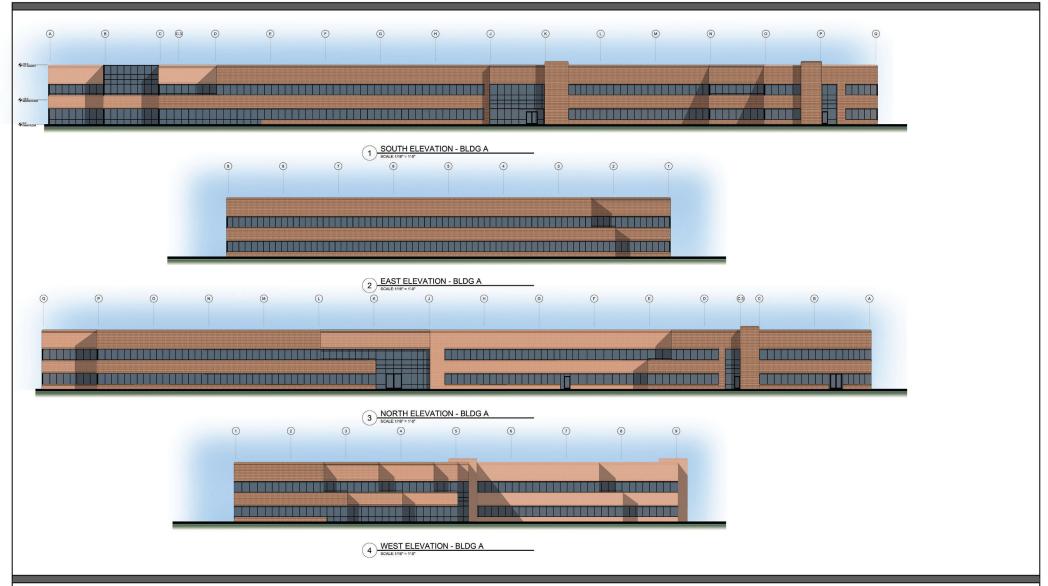

10001 N. 92nd Street Scottsdale, AZ. 85258





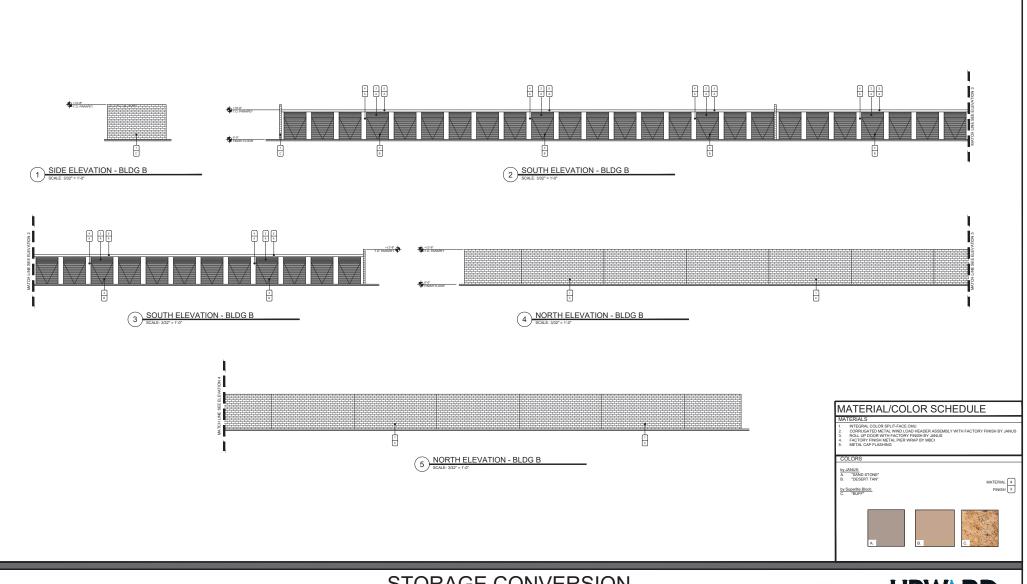


10001 N. 92nd Street Scottsdale, AZ. 85258





03.14.2025 PROJECT NO. 24088

1155 W. Rio Salado Parkway, Suite B-101 Tempe, AZ 85281 Ph 602.753.5222 www.upwardarchitects.com

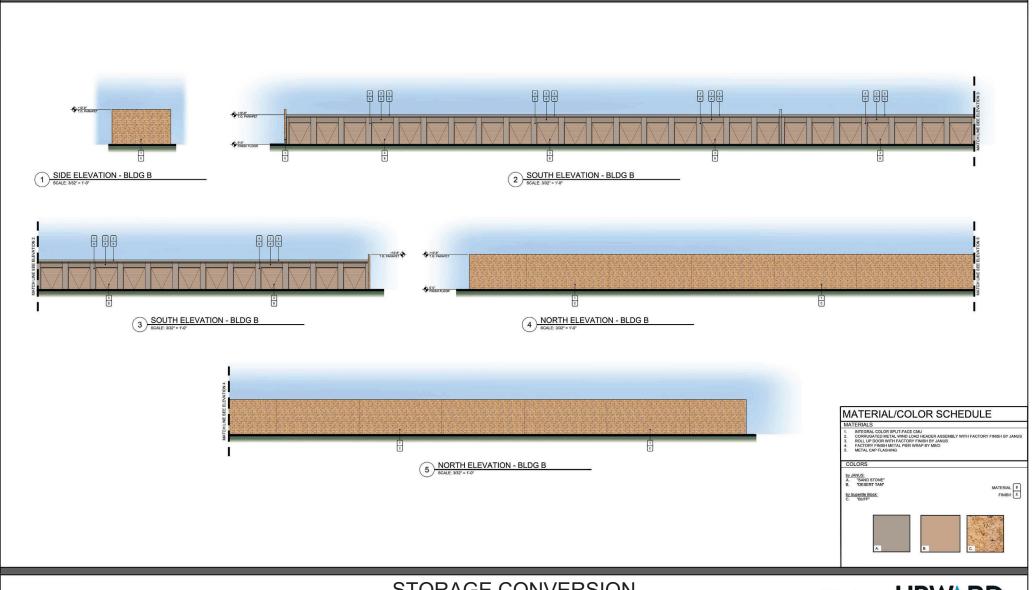


10001 N. 92nd Street Scottsdale, AZ. 85258






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Scottsdale, AZ. 85258

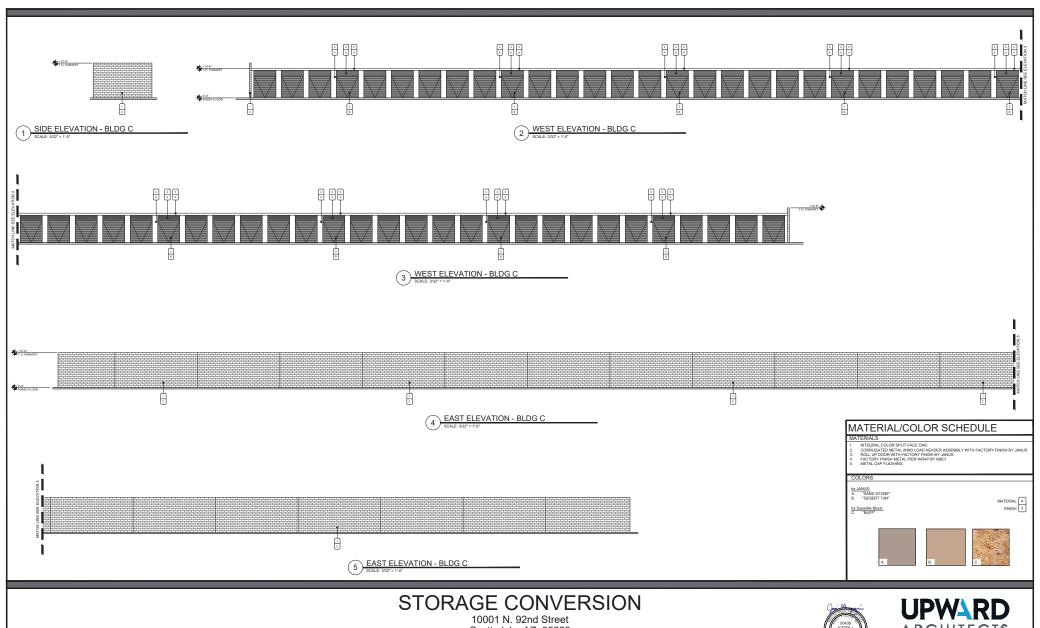






Scottsdale, AZ. 85258

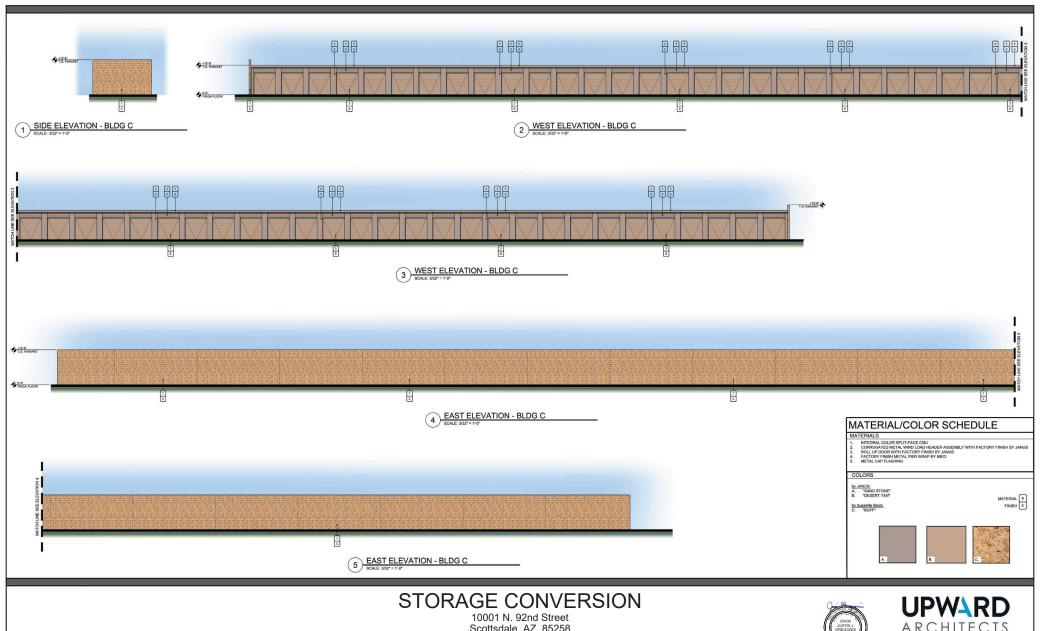



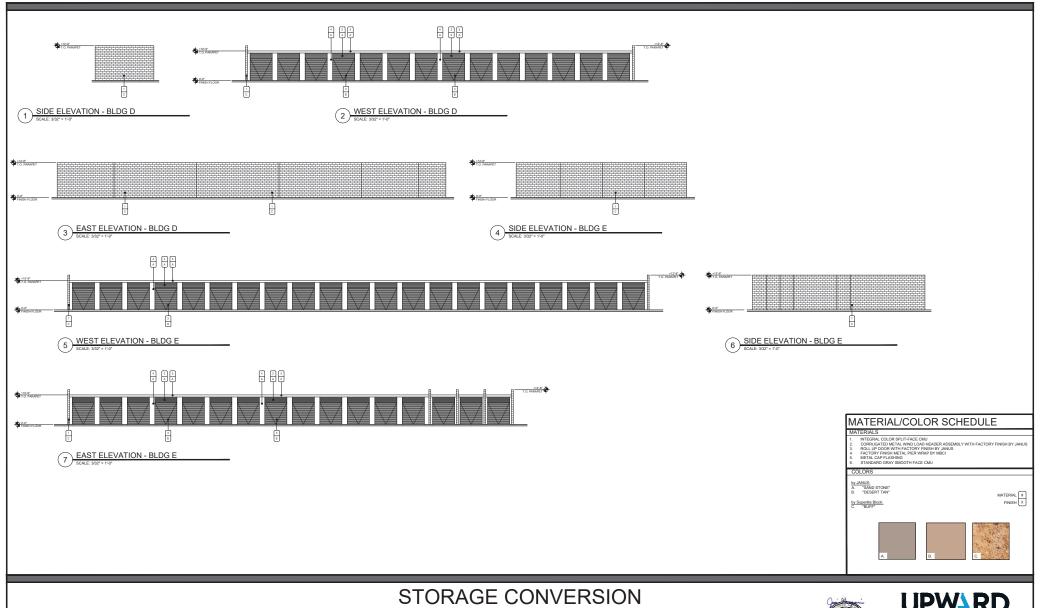


10001 N. 92nd Street Scottsdale, AZ. 85258






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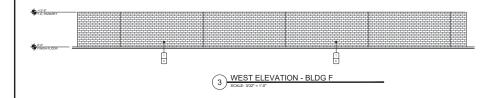


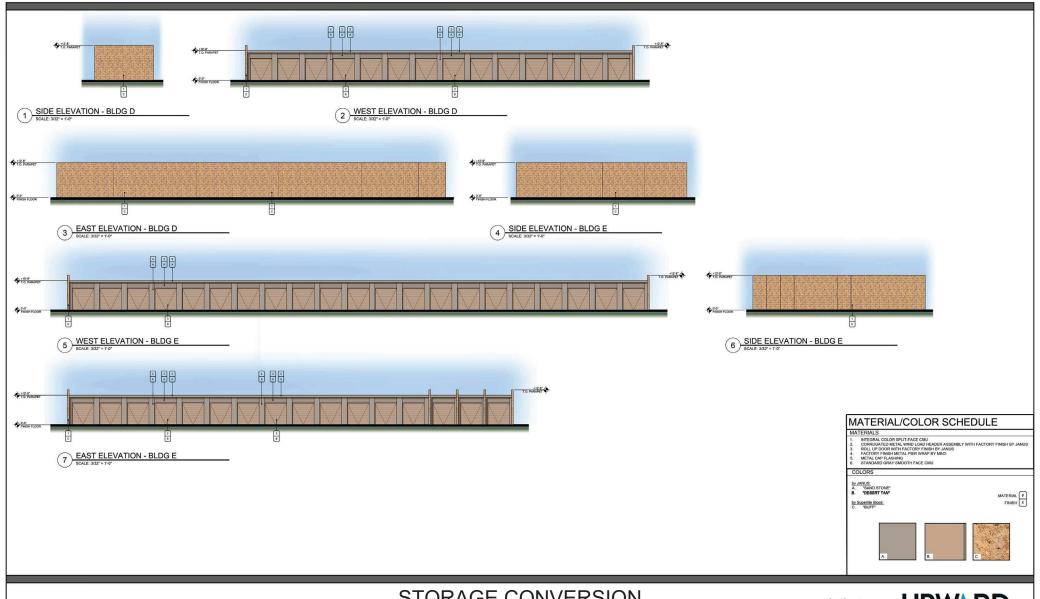
10001 N. 92nd Street Scottsdale, AZ. 85258







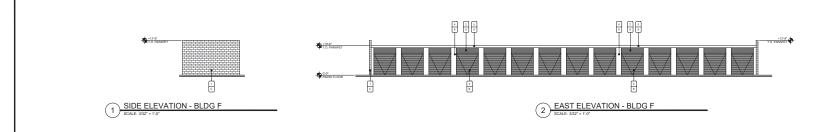

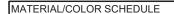

- INVESTMENT COLORS BUT FACE CALL

 NTEGRAL COLORS BUT FACE CALL

 NTEGRAL COLORS BUT FACE CALL

 SOLID BUT FACE CALL COLORS BUT FACE CALL

 AND COLORS BUT FACE CALL CALL FACE CALL

 FACTORY FINES BUT ALL

 FACTORY FINES BUT FACE CALL

 SOLID CALL CAP FLASHING

 STANDARD GRAY MIGHT FACE CALL

 STANDARD GRAY MIGHT FACE CALL

 STANDARD GRAY MIGHT FACE CALL

 TO CALL CAP FLASHING

by Superlite Block: C. "BUFF"







MATERIAL # X

STORAGE CONVERSION


10001 N. 92nd Street Scottsdale, AZ. 85258

03.14.2025 PROJECT NO. 24088





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STORAGE CONVERSION 10001 N. 92nd Street Scottsdale, AZ. 85258

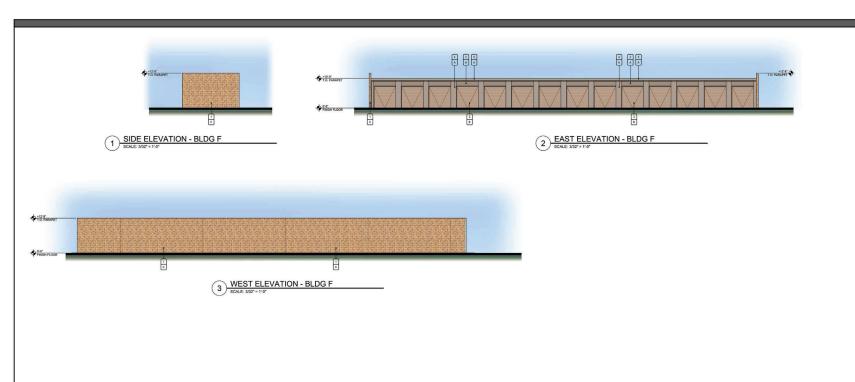









10001 N. 92nd Street Scottsdale, AZ. 85258



