

March 19, 2024

FLEXJET PROJECT INFORMATION

The proposed project consists of a ground-up terminal/office building attached to an aircraft hangar with below-grade parking structure. The project is located at 15115 N. Airport Drive, south of the Atlantic (formerly Ross) Aviation hangars. The parcel is leased from the Airport by Atlantic Aviation. There are existing buildings that abut an existing group of hangars: an office building and a pre-engineered airplane shade cover. These two structures will be demolished, leaving the hangar buildings intact. The project is being developed by Atlantic Aviation for the proposed tenants, Flexjet and Directional Aviation.

DEMO PERMIT

The client seeks to secure a demolition permit prior to the new construction. The demolition permit would include demolition of the existing office building, shade cover and the outdated electrical equipment that serves the existing office and hangar (a transformer outside the building, and the SES and panels located inside the building). The demolished transformer, SES and panels would be replaced with new equipment designed to serve only the existing hangar to remain.

NEW CONSTRUCTION

The terminal/office building is 2-stories and features a private passenger departure lounge with FBO support spaces on the first floor, combined with office space on the second floor to be used by Flexjet's parent company, Directional Aviation. Flexjet occupancy is very light since more than 90% of all transiting or arriving passengers are picked up or dropped off, and the offices on the second floor are only seasonally occupied.

The hangar is 180'-8" x 161'-10" with a 150'-0" rolling hangar door, sized to house several aircraft in Flexjet's fleet. The hangar includes a shop and storage mezzanine and will be cooled with evaporative cooling.

Directly below the hangar is a below-grade parking structure with 60 parking spaces. Car storage is only for pax. And not for long-term parking.

Site drainage will be handled with a continuation of the existing drainage patterns from the existing parking lot using the airport storm drainage system.

BUILDING STATISTICS

Garage level:

Parking garage with lobby 32,683 s.f.
Covered ramp into garage 3,460 s.f.
Hangar 31,379 s.f.

Terminal/Office

First floor 8,949 s.f.
Second floor 9,616 s.f.
Exterior Deck 2,373 s.f.

Site size is within the Atlantic Aviation lease and totals 84,548 ft²

FLEXJET PROJECT NARRATIVE

ORDINANCES, MASTER PLANS, GENERAL PLAN, AND STANDARDS

REQUIREMENTS:

Describe how the proposed development will comply with the design and character elements of the General Plan, the appropriate character area plan, all applicable city-wide master plans, the zoning ordinance development standards, the Design Standards and Policies Manual, all applicable city-wide design guidelines, and the appropriate Master Environmental Design Concept Plan.

The project is an aviation project on airport property and is zoned I-1 (Scottsdale Municipal Airport). The site design includes a 20' street-side landscape setback per zoning requirements, as well as a variety of landscape areas on-site and in parking areas, designed to meet City of Scottsdale open space requirements, and provide pleasant outdoor spaces for building tenants. There is no side yard, or ramp-side setback required, though 6 feet of space is provided in between the new hangar and the existing hangars to the northeast.

The project responds to the General Plan by offering aviation-related commercial opportunities at the edge of the Scottsdale Airport runway, housed within buildings that display unique architecture that responds to the image and climate of the Sonoran desert. The Flexjet terminal will draw local, interstate, and international visitors, and the project will facilitate and promote the current business and travel industries in the City of Scottsdale. The building and site design respond to Plan outlines by appropriately densifying the sub-urban environment, while providing a pedestrian-oriented interface with the public along Airport Dr., via sidewalks, public art, and desert landscaping. A below-grade parking garage is included, which will reduce asphalt surface area and screen and shade parking areas.

ARCHITECTURAL CHARACTER, LANDSCAPING, AND SITE DESIGN REQUIREMENTS:

Explain how the proposed development has been designed so that it:

- Promotes a desirable relationship of structures to one another, to open spaces and topography, both on the site and in the surrounding neighborhood
- Avoids excessive variety and monotonous repetition
- Recognizes the unique climatic and other environmental factors of this region to respond to the Sonoran
 Desert Environment, as specified in the Sensitive Design Principles
- Conforms to the recommendations and guidelines in the Environmentally Sensitive Lands (ESL) Ordinance, in the ESL Overlay District, and
- Incorporates unique or characteristic architectural features, including building height, size, shape, color, texture, setback, or architectural details, in the Historic Property Overly District

RESPONSE:

As an aviation project, the building forms and facades were designed to evoke images of flight, as evidenced by the sloping glass and upward-sloping roof of the Flexjet building. Tubular support columns further accentuate the upward motion of the roof structure. Exterior building finishes are generally smooth and are designed to recall aircraft materials. Finishes include silver "pearlescent" metal panels, sand finished stucco, and sand-blasted and pigmented grey concrete, and textured exterior porcelain tile pavers. Colors are neutral and blend with the

surrounding architecture and desert environment. The building expresses interesting and complex angular forms that are reminiscent of the natural forms of the desert.

Effort is made to set the building glass back from the roof line, to provide for shading, and/or recess the window frames in the exterior walls. The exterior decks are shaded with overhangs above, and the decks are also designed to shade exterior spaces and building glass on the first floor.

Landscaping is included throughout the site to visually reduce the amount of paving and offer a cooling effect. There is a large landscape area along the ramp down to the garage which buffers the site from the street. An art installation will be located in the area. Plantings will be desert-sensitive, conform to City standards, and blend with newer, neighboring projects at the airport.

The Environmentally Sensitive Lands (ESL) Ordinance does not apply to this project. The project is not in the Historic Property Overlay District.

INGRESS, EGRESS, ON-SITE CIRCULATION, PARKING, AND PEDESTRIANS

REQUIREMENTS:

Describe how the site layout of the proposed development has been designed to promote safety and convenience, relative to ingress, egress, internal traffic circulation, off-street parking facilities, loading and service areas, and pedestrian ways.

RESPONSE:

Vehicular:

Site ingress and egress maintain current vehicle circulation, though there is only one entry and exit planned for the development where there are now currently two. On-site circulation is designed to be circular, with particular thought given to the ease of drop-off and pick-up of passengers. Access to the below-grade valet parking is provided via a ramp at the north side of the site. Drop-off/pick-up space is provided in front of the Flexjet building, where passengers might tend to accumulate. The building entries is logically located adjacent to the surface parking lot.

The tenants may also lease the fenced and gated parking lot along 75th Street. Proposed vehicular circulation will continue the pattern of vehicles entering through the north gate, traveling one-way through the lot, and exiting through the gate at the south end. Accessible parking will be provided within the lot, and an accessible path of travel will be provided from the leased lot to the building entrances across Airport Drive.

Pedestrian:

The existing public sidewalk along Airport Drive will be extended to be continuous along the leasehold boundary, intersecting with the existing neighborhood sidewalk system. A new accessible path of travel connects the leased parking lot across Airport Drive, to the Flexjet site. Additionally, bicycle parking is conveniently located near each building entry. On-site pedestrian circulation occurs primarily around the surface parking lot, connecting the two buildings to the public right of way.

MECHANICAL SCREENING

REQUIREMENTS:

Describe how the proposed development will locate mechanical equipment, appurtenances, and utilities so that these elements will not conflict with street frontage open space, pedestrian amenities, resident

amenities, landscape features, or on-site circulation, and has utilized screening devices that are integral to the design of the building, in order to screen mechanical equipment, appurtenances and utilities.

RESPONSE:

All ground level utilities will be screened from public view by site walls and landscaping, with the exception of the new SES and panels for the existing hangar. This equipment will be installed on the west wall of the existing hangar as part of the demolition permit work. All other building electrical equipment has been designed internal to the building. Mechanical units will be roof-mounted and fully screened behind parapets or architectural screening devices that coordinate with the building colors and materials. All roof drainage will be via drain and overflow drain lines internal to the building.



EXPIRES: 6/30/2024

TENANT

ATLANTIC AVIATION 14600 N. AIRPORT DR. SCOTTSDALE, AZ 85260 CONTACT: RICK WIELEBSKI PHONE: 480,948,2400 E-MAIL: Rick.Wielebski@atlanticaviation.com

SUB TENANT

DIRECTIONAL AVIATION 355 RICHMOND RD. CLEVELAND, OH 44143 (SEND ALL CORRESPONDENCE THROUGH THE ARCHITECT.

CONTRACTOR

WILLMENG CONSTRUCTION 1702 E. HIGHLAND AVE. PHOENIX, ARIZONA 85016 CONTACT: DEAN LUTGEN PHONE: 480,968,4755 E-MAIL: dlutgen@willmeng.com

LARSON ASSOCIATES ARCHITECTS, INC.

CIVIL TO AIRPORT

SCOTTSDALE, AZ 85260

PHONE: 480.376.0581

COFFMAN ASSOCIATES

CONTACT: JUDI KRAUSS

PHONE: 602,993,6999

4835 E. CACTUS RD.

CONTACT: BRAD MIKULECKY

AIRPORT CONSULTANT

SCOTTSDALE, ARIZONA 85254

8800 E. RAINTREE DRIVE, SUITE 285

EMAIL: Brad.Mikulecky@meadhunt.com

E-MAIL: jkrauss@coffmanassociates.com

MEAD & HUNT

3801 NORTH 24TH STREET, SUITE 100 PHOENIX, ARIZONA 85016 CONTACT: JIM LARSON PHONE: 602,955,9929 FAX: 602,954,4790 E-MAIL: [larson@larson-architects.com

CONSULTANTS

CIVIL

ZELL COMPANY, LLC 3400 NORTH DYSART ROAD SUITE 130 AVONDALE, ARIZONA 85392 CONTACT: KEN ZELL PHONE: 623,547,2500 EMAIL: KZELL@ZELL-CO.COM

LANDSCAPE

HILLMAN WORKSHOP 2901 E. HIGHLAND AVE. PHOENIX, ARIZONA 85016 CONTACT: AARON HILLMAN PHONE: 480.686.2001

E-MAIL: aaronh@hillmanworkshop.com

STRUCTURAL

BAKKUM NOELKE 2525 E. ARIZONA BILTMORE CIRCLE SUITE D-240 PHOENIX, ARIZONA 85016 CONTACT: FRED NOELKE PHONE: 602.955.9200

MECHANICAL ENGINEER

E-MAIL: fnoelke@bakkumnoelke.com

BC ENGINEERING INC. - PHIL BAGBY PO BOX 617 MORRISTOWN, AZ 85342 CONTACT: HECTOR PEREZ PHONE: 602.716.1743 E-MAIL: hector@bcengr.com

ELECTRICAL ENGINEER

EDC ELECTRICAL CONSULTING, LLC 20958 WEST LOST CREEK DRIVE BUCKEYE, ARIZONA 85396 CONTACT: EDWARD CAMACHO PHONE: 623.236.3264 E-MAIL: ed@edcconsult.com

SHEET INDEX

GENERAL

LANDSCAPE

ARCHITECTURAL

CO.0 COVER SHEET 1 OF 1 PRELIMINARY GRADING PLAN L1.0 PRELIMINARY PLANTING PLAN SP0.0 SURVEY - FOR REFERENCE ONLY DEMOLITION SITE PLAN CODE SITE PLAN DIMENSIONED SITE PLAN NEW KEYNOTE SITE PLAN AERIAL SITE PLAN SECURITY SITE PLAN OPEN SPACE SITE PLAN HARDSCAPE SITE PLAN REFUSE PLAN FIRE ACCESS SITE PLAN VISIBILITY SITE PLAN TRANSITION SITE PLAN PEDESTRIAN/VEHICULAR CIRCULATION SITE PLAN EXTERIOR LIGHTING SITE PLAN PHOTOMETRIC SITE PLAN PARKING SITE PLAN SITE CROSS SECTIONS SITE DETAILS SITE DETAILS SITE DETAILS SITE DETAILS EXTERIOR LIGHT FIXTURE CUT SHEETS EXTERIOR LIGHT FIXTURE CUT SHEETS EXTERIOR LIGHT FIXTURE CUT SHEETS SP3.3 EXTERIOR LIGHT FIXTURE CUT SHEETS EXTERIOR LIGHT FIXTURE CUT SHEETS SP3.4 EXTERIOR LIGHT FIXTURE CUT SHEETS BASEMENT DIMENSION PLAN IST FLOOR OVERALL DIMENSION PLAN IST FLOOR DIMENSION PLAN IST FLOOR DIMENSION PLAN 2ND FLOOR OVERALL DIMENSION PLAN 2ND FLOOR DIMENSION PLAN A1.0.2A 2ND FLOOR DIMENSION PLAN A1.0.2B ROOF PLAN ROOF PLAN EXTERIOR ELEVATIONS EXTERIOR ELEVATIONS

EXTERIOR ELEVATIONS

ADJACENT DRB APPROVALS

34-DR-2019 24-DR-2020 48-DR-2021 2-DR-2017

OWNER VENDORS

THE CONTRACTOR SHALL COORDINATE THE INSTALLATION OF SYSTEMS WITH THE OWNER'S DIRECT HIRED VENDORS. THOSE YENDORS MAY INCLUDE, BUT ARE NOT LIMITED TO:

1. SECURITY (CAMERAS AND MONITORING, ACCESS CONTROLS) 2. AUDIO-VISUAL (SPEAKERS)

3. WATER TREATMENT 4. INFORMATION TECHNOLOGY 5. FURNITURE

AS BUILT ITEMS

THE CONTRACTOR SHALL PROVIDE THE FOLLOWING "AS-BUILT" ITEMS:

I. CABINET BOX FOR FIRE SPRINKLER AND FIRE ALARM 2. FIRE SPRINKLER PLANS

3. UTILITY LINES

4. ALL OTHER ITEMS TO BE DETERMINED AND/OR AS REQUIRED BY CITY, UTILITY COMPANIES AND THE OWNER

DEFERRED SUBMITTALS

FRANK LLOYD WRIGHT

HUNDERBIRD RD

VICINITY MAP

NOT TO SCALE

1. KNOX BOX SHOP DRAWINGS 2. WOOD TRUSSES 3. FIRE SPRINKLER DRAWINGS 4. FIRE ALARM DRAWINGS 5. SIGNAGE 6. ACCESS CONTROLS

DEFERRED SUBMITTAL ITEMS SHALL BE SUBMITTED ACCORDING TO IBC SECTION 107.3.4, AND AS FOLLOWS:

LARSON ASSOCIATES ARCHITECTS, THE REGISTERED DESIGN PROFESSIONAL IN CHARGE SHALL BE RESPONSIBLE FOR REVIEWING AND COORDINATING SUBMITTAL DOCUMENTS PREPARED BY OTHERS, INCLUDING PHASED AND DEFERRED SUBMITTAL ITEMS, FOR COMPATIBILITY WITH THE DESIGN OF THE BUILDING.

PER IBC SECTION 107.3.4.1, SUBMITTAL DOCUMENTS FOR DEFERRED SUBMITTAL ITEMS SHALL BE SUBMITTED TO THE REGISTERED DESIGN PROFESSIONAL IN RESPONSIBLE CHARGE, WHO SHALL REVIEW THEM AND FORWARD THEM TO THE BUILDING OFFICIAL WITH A NOTATION INDICATING THAT THE DEFERRED SUBMITTAL DOCUMENTS HAVE BEEN REVIEWED AND THAT THEY HAVE BEEN FOUND TO BE IN GENERAL CONFORMANCE WITH THE DESIGN OF THE BUILDING. THE DEFERRED SUBMITTAL ITEMS SHALL NOT BE INSTALLED UNTIL THE DEFERRED SUBMITTAL DOCUMENTS HAVE BEEN APPROVED BY THE BUILDING

RAINTREE DR

NORTH

PROJECT DESCRIPTION

THE PROJECT CONSISTS OF A NEW HANGAR AND 2-STORY FBO/OFFICE BUILDING. THE PROJECT IS LOCATED ON AIRPORT PROPERTY. CURRENTLY OCCUPIED BY A PARKING LOT AND SMALL OFFICE BUILDING, CONNECTED TO A SERIES OF HANGARS. THE PROJECT INCLUDES DEMOLITION OF THE EXISTING OFFICE BUILDING, LEAVING THE EXISTING HANGARS INTACT.

THE PROJECT IS BEING DEVELOPED BY ATLANTIC AVIATION FOR PROPOSED TENANT, FLEXJET AND DIRECTIONAL AVIATION. THE FLEXJET PASSENGER TERMINAL WILL OCCUPY THE GROUND FLOOR OF THE OFFICE PORTION OF THE BUILDING, AND THE SECOND FLOOR WILL HOUSE SEASONAL OFFICES FOR DIRECTIONAL AVIATION, THE BELOW-GRADE PARKING STRUCTURE WILL BE LOCATED DIRECTLY BENEATH THE AIRCRAFT HANGAR.

PROJECT DATA

PROJECT ADDRESS: 15115 N. AIRPORT DR. SCOTTSDALE, ARIZONA 85260 ATLANTIC AVIATION PROPERTY OWNER: 14600 N. AIRPORT DR. SCOTTSDALE, AZ 85260 DIRECTIONAL AVIATION PROJECT TENANT:

355 RICHMOND RD. CLEVELAND, OH 44143 215-56-413E

I-1 (SCOTTSDALE MUNICIPAL AIRPORT) PARCEL ZONING:

84,548 S.F. (1,941 ACRES) GROSS LOT AREA: NET LOT AREA: 84,548 S.F. (1.941 ACRES) (LEASEHOLD)

APPLICABLE CODES: 2021 INTERNATIONAL BUILDING CODE (IBC) 2021 INTERNATIONAL FIRE CODE (IFC) 2021 INTERNATIONAL PLUMBING CODE (IPC) 2021 INTERNATIONAL MECHANICAL CODE (IMC) 2021 INTERNATIONAL FUEL GAS CODE (IFGC) 2020 NATIONAL ELECTRIC CODE (NEC)

> 2021 INTERNATIONAL ENERGY CONSERVATION 2021 INTERNATIONAL GREEN CONSTRUCTION CODE (IGCC)

ALL CODES TO INCLUDE STATE, COUNTY AND CITY AMENDMENTS

LEGAL DESCRIPTION

A PORTION OF LOT I OF THE MINOR LAND DIVISION FOR SCOTTSDALE AIRPORT, RECORDED IN BOOK 1619 OF MAPS, 39, RECORDS OF MARICOPA COUNTY, ARIZONA, LOCATED IN THE NORTHEAST QUARTER OF SECTION 11, TOWNSHIP 3 NORTH, RANGE 4 EAST OF THE GILA AND SALT RIVER BASE AND MERIDIAN, MARICOPA COUNTY, ARIZONA, BEING MORE PARTICULARY DESCRIBED AS FOLLOWS

COMMENCING AT THE 3-INCH CITY OF SCOTTSDALE BRASS CAP IN HANDHOLE (0.40' DOWN) MARKING THE NORTH QUARTER CORNER OF SAID SECTION II FROM WHICH A BRASS CAP IN HANDHOLE 3/1.50' DOWN) MARKING THE NORTHEAST QUARTER OF SAID SECTION II BEARS SOUTH 89 DEGREES 38 MINUTES II SECONDS EAST 2638,57 FEET, SAID DESCRIBED LINE BEING THE BASIS OF BEARINGS FOR THIS DESCRIPTION;

THENCE SOUTH 89 DEGREES 38 MINUTES II SECONDS EAST 1443.62 FEET ALONG THE NORTH LINE OF SAID NORTHEAST QUARTER TO THE NORTHEASTERLY PROLONGATION OF THE NORTHWEST LINE OF SAID LOT 1: THENCE SOUTH 43 DEGREES 58 MINUTES 46 SECONDS WEST 1097.73 FEET

ALONG SAID NORTHWEST LINE; THENCE SOUTH 46 DEGREES OT MINUTES 42 SECONDS EAST 31.47 FEET TO THE POINT OF BEGINNING;

THENCE CONTINUING SOUTH 46 DEGREES OF MINUTES 42 SECONDS EAST 295.53

THENCE SOUTH 44 DEGREES 11 MINUTES 18 SECONDS WEST 134.82 FEET, THENCE NORTH 45 DEGREES 32 MINUTES 51 SECONDS WEST 30.26 FEET, THENCE SOUTH 44 DEGREES 27 MINUTES 51 SECONDS WEST 172.92 FEET, THENCE NORTH 46 DEGREES OI MINUTES 35 SECONDS WEST 259.17 FEET, THENCE NORTH 44 DEGREES OO MINUTES 55 SECONDS EAST 144.83 FEET, THENCE NORTH 40 DEGREES 49 MINUTES 26 SECONDS EAST 16.02 FEET THENCE NORTH 43 DEGREES 40 MINUTES 47 SECONDS EAST 45.64 FEET THENCE NORTH 44 DEGREES II MINUTES OS SECONDS EAST 40.58 FEET TO THE POINT OF BEGINNING.

> APPROVED PER ARTICLE 7 OF LEASE AGREEMENT 2010-166-COS **INITIALS:**

CITY OF SCOTTSDALE APPROVAL BLOCK

9252 JAMES LAWRENCE Apr 26, 2024 EXPIRES: 6/30/2024

Drawing Name: COVER SHEET

Revisions 1-12-24 PRE-APP

4-15-24 AIRPORT APPROVAL DOCS

4/15/24 Date: Project Number 2021.004

Drawing No:

5/16/2024

S

drson

GISOF

FIRE ORDINANCE REQUIREMENTS

PREMISES IDENTIFICATION TO BE LEGIBLE FROM STREET OR DRIVE AND MUST BE ON ALL PLANS. 2. FIRE LANES AND EMERGENCY ACCESS SHALL BE PROVIDED AND MARKED IN COMPLIANCE WITH CITY ORDINANCE AND IFC AT THE FOLLOWING LOCATIONS: PER SRC, 24 WIDE, TURNING RADII 25' INSIDE, 49' OUTSIDE, PLUS 55' OUTSIDE AERIAL LADDER BUCKET SWING. 3. PROVIDE ALL WEATHER ACCESS ROADS (MIN. 16' WIDE) TO ALL BUILDINGS AND HYDRANTS FROM PUBLIC WAY DURING CONSTRUCTION.

4. A FIRE SPRINKLER SYSTEM SHALL BE INSTALLED PER NFPA STANDARDS.

5. PROVIDE A KNOX ACCESS SYSTEM: A, KNOX BOX B. PAD LOCK

C. KNOX OVERRIDE AND PRE-EMPTION STROBE SWITCH FOR AUTOMATIC GATES. 6. THE BUILDING IS NOT INTENDED FOR THE STORAGE OF HAZARDOUS MATERIALS.

7. NOT USED. 8. PROVIDE INTERIOR TENANT NOTIFICATION WHEN OFF-SITE MONITORING IS REQUIRED. (SEE FIRE

ALARM INTERPRETATIONS FOR CLARIFICATION) 9. FIRE LINES, SPRINKLER AND STANDPIPE SYSTEMS SHALL BE FLUSHED AND PRESSURE TESTED PER NFPA STANDARDS AND CITY OF SCOTTSDALE REVISED CODES. 10. BUILDINGS MAY BE SUBJECT TO INSTALLATION AND TESTING REQUIREMENTS FOR A PUBLIC SAFETY

RADIO AMPLIFICATION SYSTEM. 11. BACKFLOW PREVENTION WILL BE REQUIRED ON VERTICAL RISER FOR CLASS 1 AND 2 FIRE SPRINKLER SYSTEMS PER SCOTTSDALE REVISED CODE AND NFPA 13/13R. 12. PROVIDE ALL WEATHER ACCESS ROAD (MIN. 16') TO ALL BUILDINGS AND HYDRANTS FROM A

PUBLIC WAY DURING CONSTRUCTION. 13. SEE APPROVED CIVILS FOR THE NUMBER OF FIRE HYDRANTS REQUIRED. DEVELOPER SHALL HAVE THE REQUIRED HYDRANTS INSTALLED AND OPERABLE PRIOR TO THE FOOTING INSPECTION. HYDRANTS SHALL BE SPACED AT A MAXIMUM OF EXIST AT 1500 GPM. THE DEVELOPER SHALL MAKE THE C.O.S. APPROVED CIVIL WATER PLANS AVAILABLE TO THE FIRE SPRINKLER CONTRACTOR.

14. PORTABLE FIRE EXTINGUISHERS SHALL BE INSTALLED SEE FLOOR PLAN SHEET ALO. 15. EXIT AND EMERGENCY LIGHTING SHALL COMPLY WITH THE C.O.S. ORDINANCE AND THE IFC. SEE THE ELECTRICAL LIGHTING SHEETS.

16. PROVIDE "OWNER'S INFORMATION CERTIFICATE" WITH FIRE SPRINKLER PLAN SUBMITTAL. IT. FIRE LINE, SPRINKLERS AND STANDPIPE SYSTEM SHALL BE FLUSHED AND PRESSURE TESTED PER NFPA STANDARDS AND SCOTTSDALE REVISED CODES.

18. FDC SIAMESE CONNECTIONS FOR SPRINKLERS AND/OR STANDPIPES WILL BE LOCATED PER ORDINANCE AND/OR AT AN APPROVED LOCATION. MINIMUM SIZE 2-1/2 x 2-1/2 x (NSHT) OR 2-1/2 x 2-1/2 x2-1/2 x 6 IF OVER 1000 GPM 4' TO 8' BACK OF CURB; INDEPENDENT WET LINE. 19. ADEQUATE CLEARANCE SHALL BE PROVIDED AROUND FIRE RISER, DIMENSIONS FROM FACE OF PIPE SHALL MEASURE A MINIMUM OF 12" OFF THE BACK WALL, 18" ON EACH SIDE AND 36" CLEAR IN FRONT WITH A FULL HEIGHT DOOR. THE FIRE LINE SHALL EXTEND A MAXIMUM OF 3' INTO THE BUILDING

20. SPRINKLER SYSTEM SHALL BE INSTALLED TO COMPLY WITH MINIMUM NFPA CRITERIA AND SCOTTSDALE REVISED CODES, SYSTEMS WITH 100 HEADS OF MORE SHALL HAVE OFF SITE MONITORING. AFTER BUILDING PLAN REVIEW INSTALLING CONTRACTOR SHALL SUBMIT (3) THREE COMPLETE SETS OF DRAWINGS AND HYDRAULIC CALCULATIONS REVIEWED BY A MINIMUM NICET III DESIGN TECHNICIAN. A. NOT USED. B. NOT USED.

C. NFPA 13 COMMERCIAL SYSTEM/DESIGN CRITERIA: PER OFFICE (LIGHT HAZARD) GROUP II HANGAR (EXTRA HAZARD GROUP 2) (NO COMMODITIES OVER 8'-O" IN STACKING HEIGHT, MAX. OPERATION AREA OF 5,196 S.F. NO HAZARDOUS MATERIALS), TYPE II SEISMIC DESIGN CATEGORY AS DETERMINED BY THE STRUCTURAL DESIGNER REQUIRED DENSITY 17/500 AT OFFICES AND AT HANGARS WITHOUT FOAM PER NFPA 409 AND IBC AND REQUIRED DENSITY OF .10/1500 FOR OFFICES. D. NOT USED E. NOT USED

F. NOT USED.

G. FIRE SPRINKLER SYSTEM: WET PER 2012 IBC AND NFPA 409. 21. CURRENT CODE 2012: IFC AND NFPA STANDARDS.

ABBREVIATIONS

CONCRETE BLOCK WALL

COVED CERAMIC TILE

CONCRETE SEALED

GYPSUM BOARD

SUSPENDED ACOUSTIC TILE HM

MATERIAL

ALUMINUM

CONCRETE

CARPE1 CERAMIC TILE

GLASS

ACT

C-BLK

CONC

CONC-S

CCT

CPT

GB

FROM INSIDE FACE OF WALL TO CENTER OF PIPE.

SCOTTSDALE FIRE DEPARTMENT NOTES

1. SUBMIT SHOP DRAWINGS FOR ANY D=MODIFICATION OF EXISTING FIRE SPRINKLER SYSTEM AND COMPLY WITH NFPA 13 AND LOCAL AMENDMENTS. IN LIGHT HAZARD OCCUPANCIES, EXISTING STANDARD RESPONSE SPRINKLER HEADS WITHIN TENANT SPACE SHALL BE CHANGED OUT TO QUICK RESPONSE WHEN SCOPE OF WORK WILL ADD AND/OR RELOCATE 50% OR MORE OF SPRINKLER HEADS. 2. ALL FIRE PROTECTION SYSTEMS SHALL REMAIN OPERATIONAL AND MODIFIED AS NECESSARY FOR CODE COMPLIANCE.

3. INSTALL FIRE EXTINGUISHERS PER IFC. FIRE EXTINGUISHER QUANTITY AND LOCATION(S) SHALL BE APPROVED BY FIRE INSPECTOR. 4. EXIT AND EMERGENCY LIGHTING SHALL COMPLY WITH CITY ORDINANCE AND IFC.

5. NUMERICAL PREMISES ID MUST BE LEGIBLE FROM STREET OR DRIVE. MINIMUM 12" NUMBERS FOR BUILDING AND 4" NUMBERS FOR SUITE. 6. SUBMIT SHOP DRAWINGS FOR ANY MODIFICATION OF FIRE ALARM SYSTEM (IF EXISTING) TO COMPLY

WITH NFPA 72 AND LOCAL CODES. 7. NEW TYPE I HOOD SYSTEMS REQUIRE SUBMITTAL OF PLAN FOR AUTOMATIC HOOD EXTINGUISHING SYSTEMS IN COMPLIANCE WITH CURRENT U.L. 300 STDS. EXISTING TYPE I HOOD STETEINS SHALL DE UPGRADED TO COMPLY WITH CURRENT U.L. 300 STANDARDS. 8. WAREHOUSE RACKS FOR STORAGE OVER 12' IN HEIGHT REQUIRE A SEPARATE SUBMITTAL FOR

MATERIAL

MCH-EX MATCH EXISTING

₽∆IN1

HCWD

QŤ

RBR

HOLLOW METAL

MARBLE TILE

QUARRY TILE

RUBBER COVE

STAINLESS STEEL

SOLID CORE

PLASTIC LAMINATE

HOLLOW CORE WOOD DOOR STP

PORCELAIN CERAMIC TILE

MATERIAL

TILE

STAINED & POLISHED

VINYL COMPOSITION TILE

CODE

VCT

WD

APPROVAL PRIOR TO INSTALLATION.

9. SEPARATE SUBMITTAL AND APPROVAL IS REQUIRED FOR MAG LOCKS. 10. BULK COMPRESSED GAS STORAGE REQUIRES SEPARATE FIRE DEPARTMENT PERMIT.

PROJECT DESCRIPTION

THE PROJECT CONSISTS OF A NEW HANGAR AND 2-STORY FBO/OFFICE BUILDING. THE PROJECT IS LOCATED ON AIRPORT PROPERTY, CURRENTLY OCCUPIED BY A PARKING LOT AND SMALL OFFICE BUILDING, CONNECTED TO A SERIES OF HANGARS. THE PROJECT INCLUDES DEMOLITION OF THE EXISTING OFFICE BUILDING, LEAVING THE EXISTING HANGARS INTACT.

THE PROJECT IS BEING DEVELOPED BY ATLANTIC AVIATION FOR PROPOSED TENANT, FLEXJET AND DIRECTIONAL AVIATION. THE FLEXJET PASSENGER TERMINAL WILL OCCUPY THE GROUND FLOOR OF THE OFFICE PORTION OF THE BUILDING, AND THE SECOND FLOOR WILL HOUSE SEASONAL OFFICES FOR DIRECTIONAL AVIATION. THE BELOW-GRADE PARKING STRUCTURE WILL BE LOCATED DIRECTLY BENEATH THE AIRCRAFT HANGAR.

PROJECT DATA

PROJECT ADDRESS: 15115 N. AIRPORT DR. SCOTTSDALE, ARIZONA 85260

ATLANTIC AVIATION PROPERTY OWNER:

14600 N. AIRPORT DR. SCOTTSDALE, AZ 85260

DIRECTIONAL AVIATION PROJECT TENANT: 355 RICHMOND RD. CLEVELAND, OH 44143

215-56-413E

I-I (SCOTTSDALE MUNICIPAL AIRPORT) PARCEL ZONING:

GROSS LOT AREA: 84,548 S.F. (1.941 ACRES) 84,548 S.F. (1.941 ACRES) NET LOT AREA:

APPLICABLE CODES: 2021 INTERNATIONAL BUILDING CODE (IBC)

2021 INTERNATIONAL FIRE CODE (IFC) 2021 INTERNATIONAL PLUMBING CODE (IPC) 2021 INTERNATIONAL MECHANICAL CODE (IMC) 2021 INTERNATIONAL FUEL GAS CODE (IFGC) 2020 NATIONAL ELECTRIC CODE (NEC)

2021 INTERNATIONAL ENERGY CONSERVATION CODE (IECC) 2021 INTERNATIONAL GREEN CONSTRUCTION CODE (IGCC)

SITE ZONING CODE DATA

YARD SETBACKS:

(LEASEHOLD)

FRONT REQUIRED (AIRPORT DR.) 20'-0" MIN. FULL LENGTH OF PROPERTY FRONT PROVIDED 20'-0" MIN. FULL LENGTH OF PROPERTY

SIDE REQUIRED (NORTHEAST) NONE REQUIRED SIDE PROVIDED 6'-0" SIDE REQUIRED (SOUTHWEST) NONE REQUIRED SIDE PROVIDED 0'-0" REAR REQUIRED (RUNWAY) NONE REQUIRED REAR PROVIDED 0'-0"

LOT AREA: 84,548 S.F. (1.94 ACRES)

BUILDING AREA:

FIRST FLOOR 8,949 G.S.F. SECOND FLOOR 9,616 G.S.F. 31,379 G.S.F.

SUB-TOTAL 49,944 G.S.F BELOW-GRADE PARKING GARAGE 32,683 G.S.F.

FLOOR AREA RATIO:

MAXIMUM = 0.8 X NET LOT AREA = REQUIRED 0.8 × 84,548 S.F. = 67,638.4 G.S.F.

PROVIDED 49,944 G.S.F. IS LESS THAN 67,638.4 G.S.F. THEREFORE OK

BUILDING HEIGHT: MAXIMUM ABOVE FINISH GRADE

52'-0" PROVIDED 44'-0"

OPEN SPACE:

OPEN FRONT SPACE REQUIRED 20'-0" MIN. FULL LENGTH OF PROPERTY OPEN FRONT SPACE PROVIDED 20'-0" MIN. FULL LENGTH OF PROPERTY, THEREFORE OK

FIRST 12'

OTHER OPEN SPACE REQUIRED

 $10\% \times NET\ LOT\ AREA = 0.1 \times 84,548\ S.F. =$ 8,454.80 S.F. 40' × .003 × 84,548 S.F. = 10,145.76 S.F. ABOVE 12' TOTAL 8,454.80 + 10,145.76 = 18,600.56 S.F.

OPEN SPACE PROVIDED OPEN FRONT SPACE OTHER OPEN SPACE

5,647 S.F. $\times\!\!\times\!\!\times\!\!\times$ (NOT INCL. PARKING

LOT LANDSCAPING) XXXXX S.F. IS GREATER THAN 18,600.56 S.F., THEREFORE OK

LANDSCAPING: STREET FRONTAGE

TOTAL

REQUIRED LANDSCAPE SETBACK 20'-0" MIN. ON AIRPORT DRIVE PROVIDED LANDSCAPE SETBACK 20'-0" MIN., THEREFORE OK

PARKING LOT STREET

REQUIRED 5' BETWEEN PARKING AND STREET 5' MIN. BETWEEN PARKING AND STREET PROVIDED

PARKING LOT PAVED AREA LANDSCAPING REQUIRED

.15 \times PARKING LOT AREA = .15 \times 9,939 S.F. = ,490.85 S.F. = 1,491 S.F. 2,819 S.F., IS GREATER THAN 1,491 S.F., LANDSCAPING PROVIDED

THEREFORE OK ALL OUTDOOR ACTIVITIES, MECHANICAL

EQUIPMENT, OUTDOOR STORAGE AND

ENCLOSED BUILDING OR SCREENED BY A

REFUSE AREAS SHALL BE WITHIN AN

LOT COVERAGE:

SCREENING:

SOLID WALL AT LEAST 6'-O" MIN. HEIGHT.

MAXIMUM \times % MA \times . ACTUAL 56,143 S.F. ACTUAL PERCENT LOT COVERAGE 56,143 S.F. / 84,548 S.F. = 66.40%

BICYCLE PARKING:

2 SPACES PER 10 VEHICLE SPACES REQUIRED 95 / 10 * 2 = 19 REQUIRED PROVIDED 20 PROVIDED

AIRPORT GENERAL NOTES

I. AIRPORT RULES AND REGULATIONS AND AIRPORT MINIMUM OPERATING STANDARDS SHALI REGULATE THE ACTIVITIES ALLOWED ON THIS PROPERTY. 2. PRIOR TO THE START OF CONSTRUCTION, THE CONTRACTOR SHALL MEET WITH AIRPORT STAFF TO PLAN ALL CONSTRUCTION RELATED ACTIVITIES INCLUDING THE INSTALLATION OF CONSTRUCTION FENCING, PAYING ADJACENT TO THE TAXILANE, SITE SECURITY, AND ANY OTHER ITEMS AS DEEMED NECESSARY BY THE AIRPORT STAFF. 3. THE CONTRACTOR SHALL SUBMIT ALL 1460 FORMS TO THE FAA FOR TEMPORARY CRANES


AND OTHER EQUIPMENT REQUIRED FOR THE CONSTRUCTION OF THE PROJECT.

AIRPORT AUTHORITY REQUIREMENTS

GENERAL NOTES

APPROVED PER ARTICLE 7 OF LEASE AGREEMENT 2010-166-COS DATE: INITIALS:

CITY OF SCOTTSDALE APPROVAL BLOCK

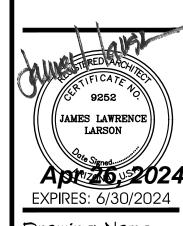

Ш

S

₩

Drawing Name: SITE CODE DATA # NOTES

Revisions 1-12-24 PRE-APP 4-15-24 AIRPORT

APPROVAL DOCS


Date:

Project Number 2021.004

Drawing No:

4/15/24

11-DR-2024 5/16/2024

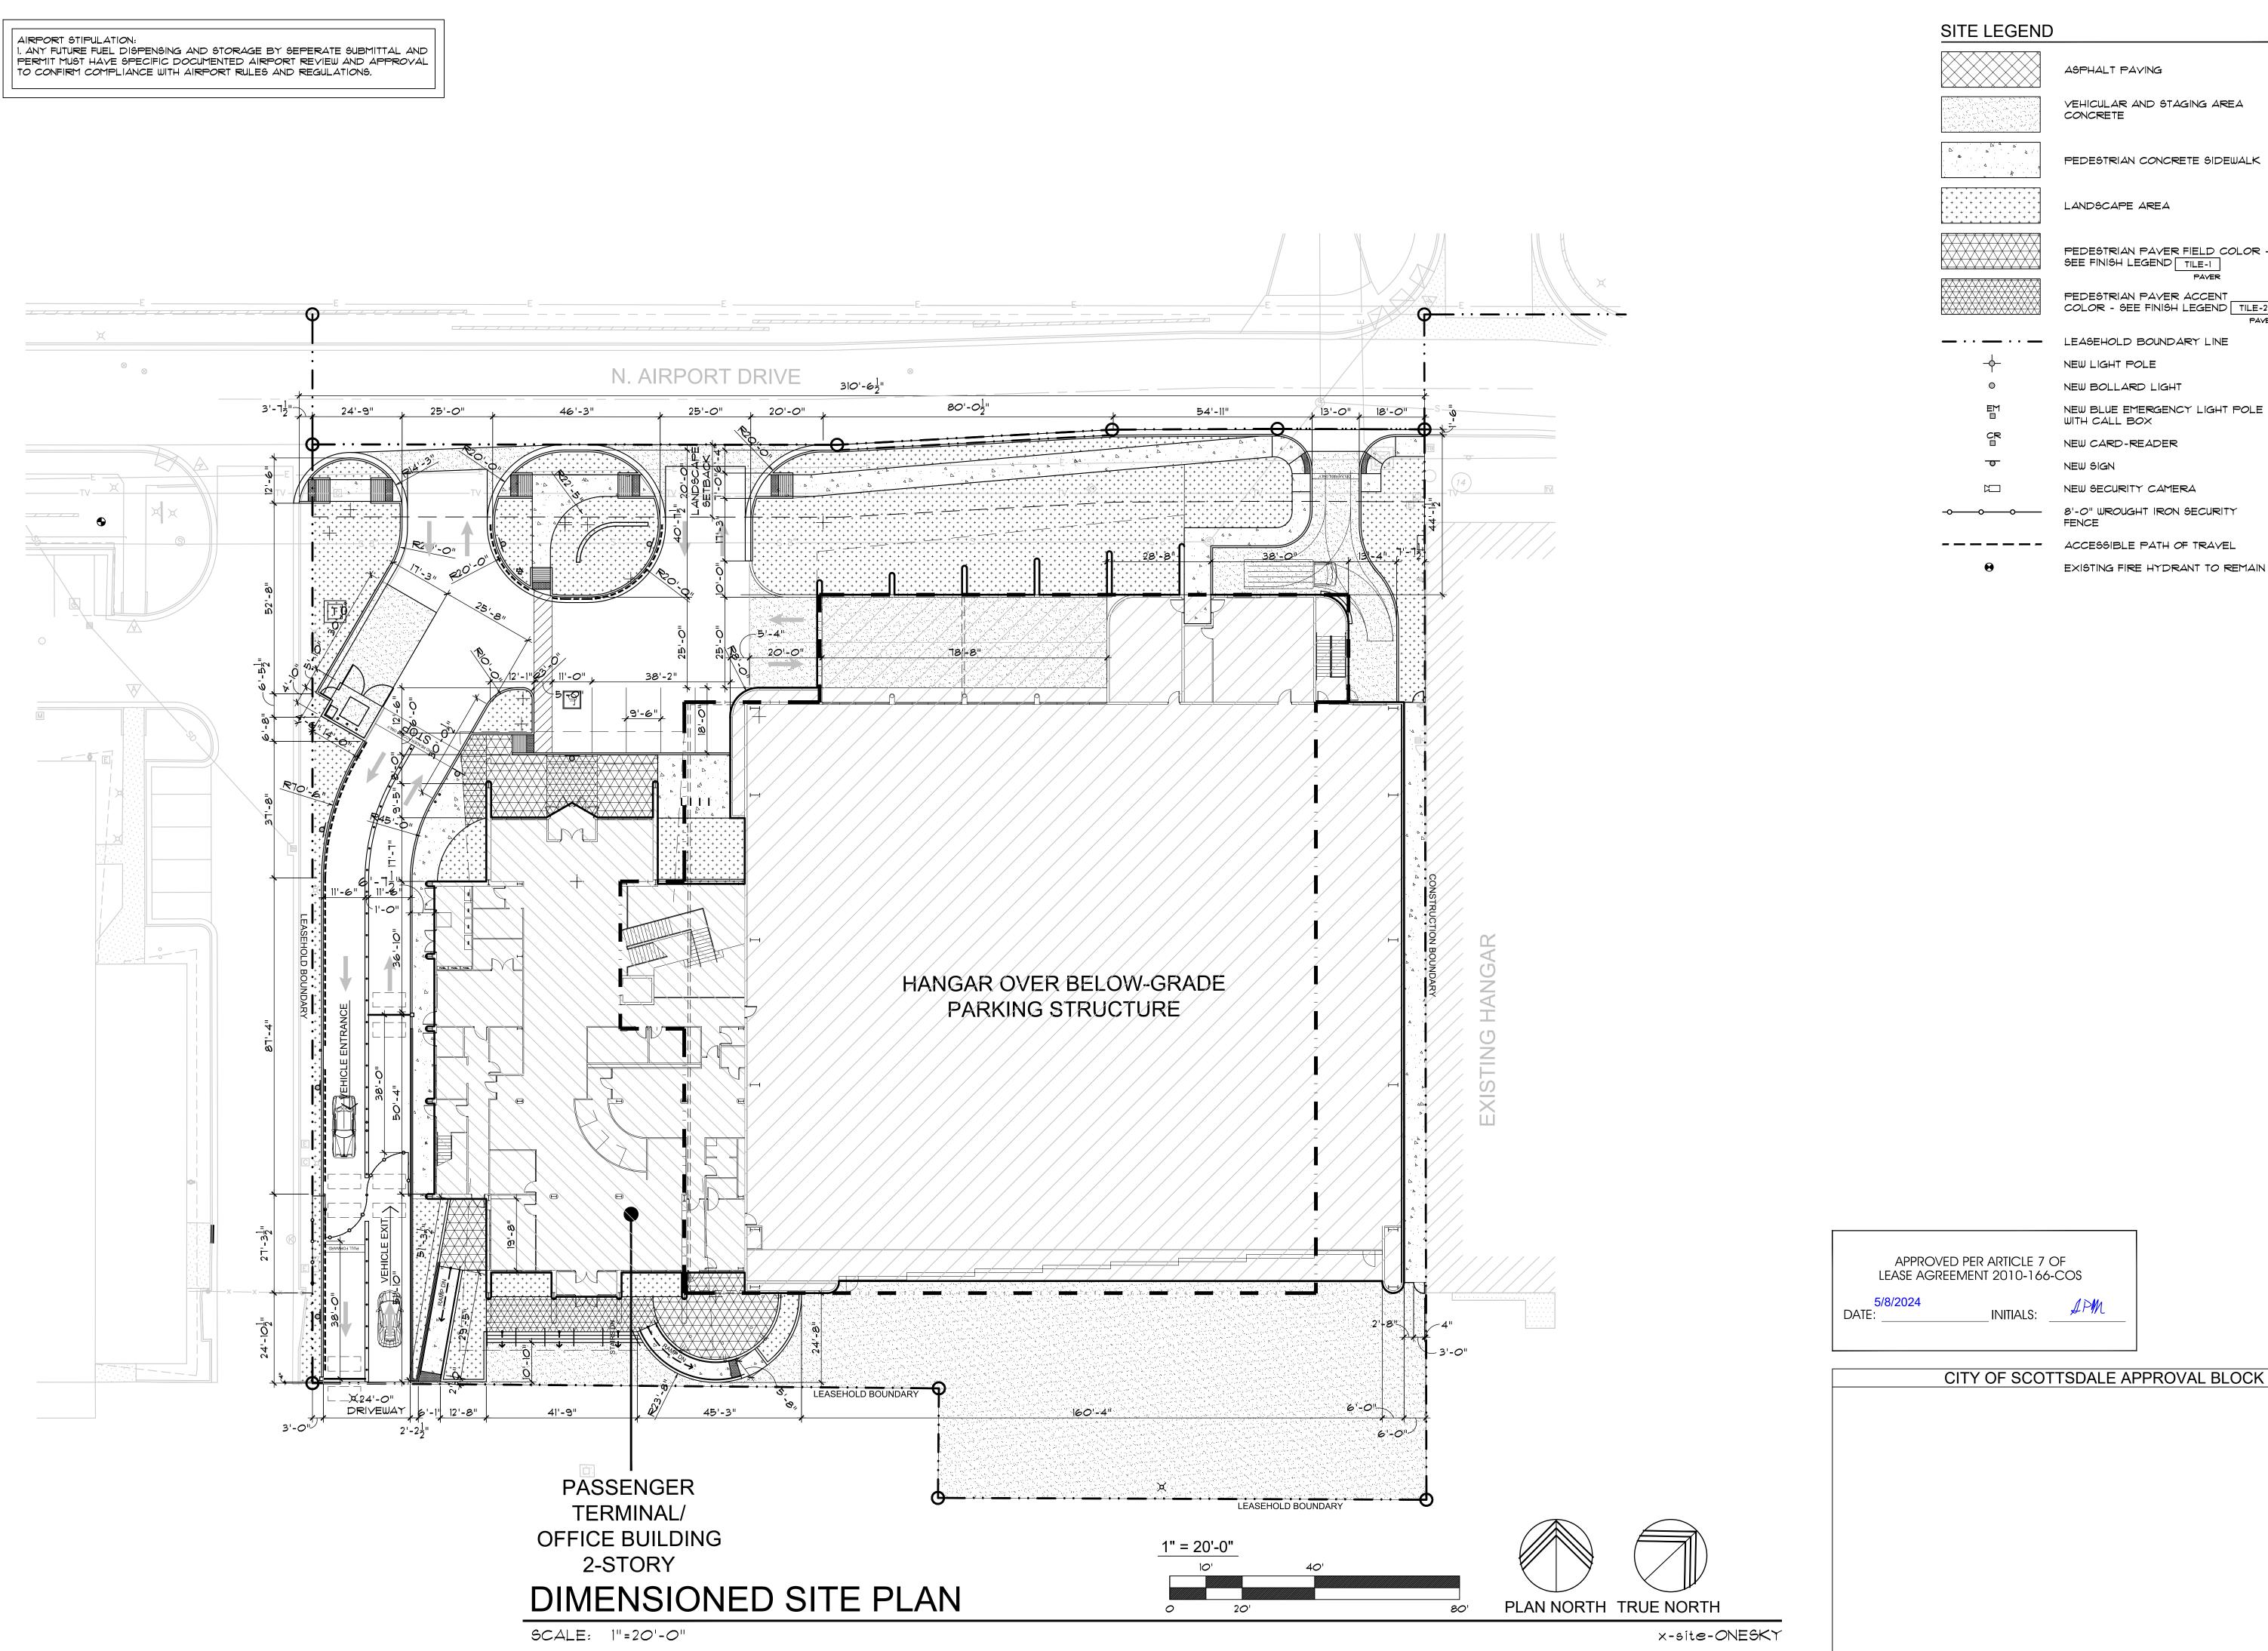

VEHICULAR AND STAGING AREA PEDESTRIAN CONCRETE SIDEWALK PEDESTRIAN PAVER FIELD COLOR -SEE FINISH LEGEND TILE-1 PEDESTRIAN PAVER ACCENT COLOR - SEE FINISH LEGEND TILE-2 LEASEHOLD BOUNDARY LINE NEW BOLLARD LIGHT NEW BLUE EMERGENCY LIGHT POLE NEW CARD-READER NEW SECURITY CAMERA 8'-0" WROUGHT IRON SECURITY ---- ACCESSIBLE PATH OF TRAVEL EXISTING FIRE HYDRANT TO REMAIN

Apriz 2024 EXPIRES: 6/30/2024

Drawing Name: DIMENSIONED SITE PLAN


Revisions 1-12-24 PRE-APP

4-15-24 AIRPORT APPROVAL DOCS.

Date: 4/15/24

Project Number: 2021.004 Drawing No:

SP1.0

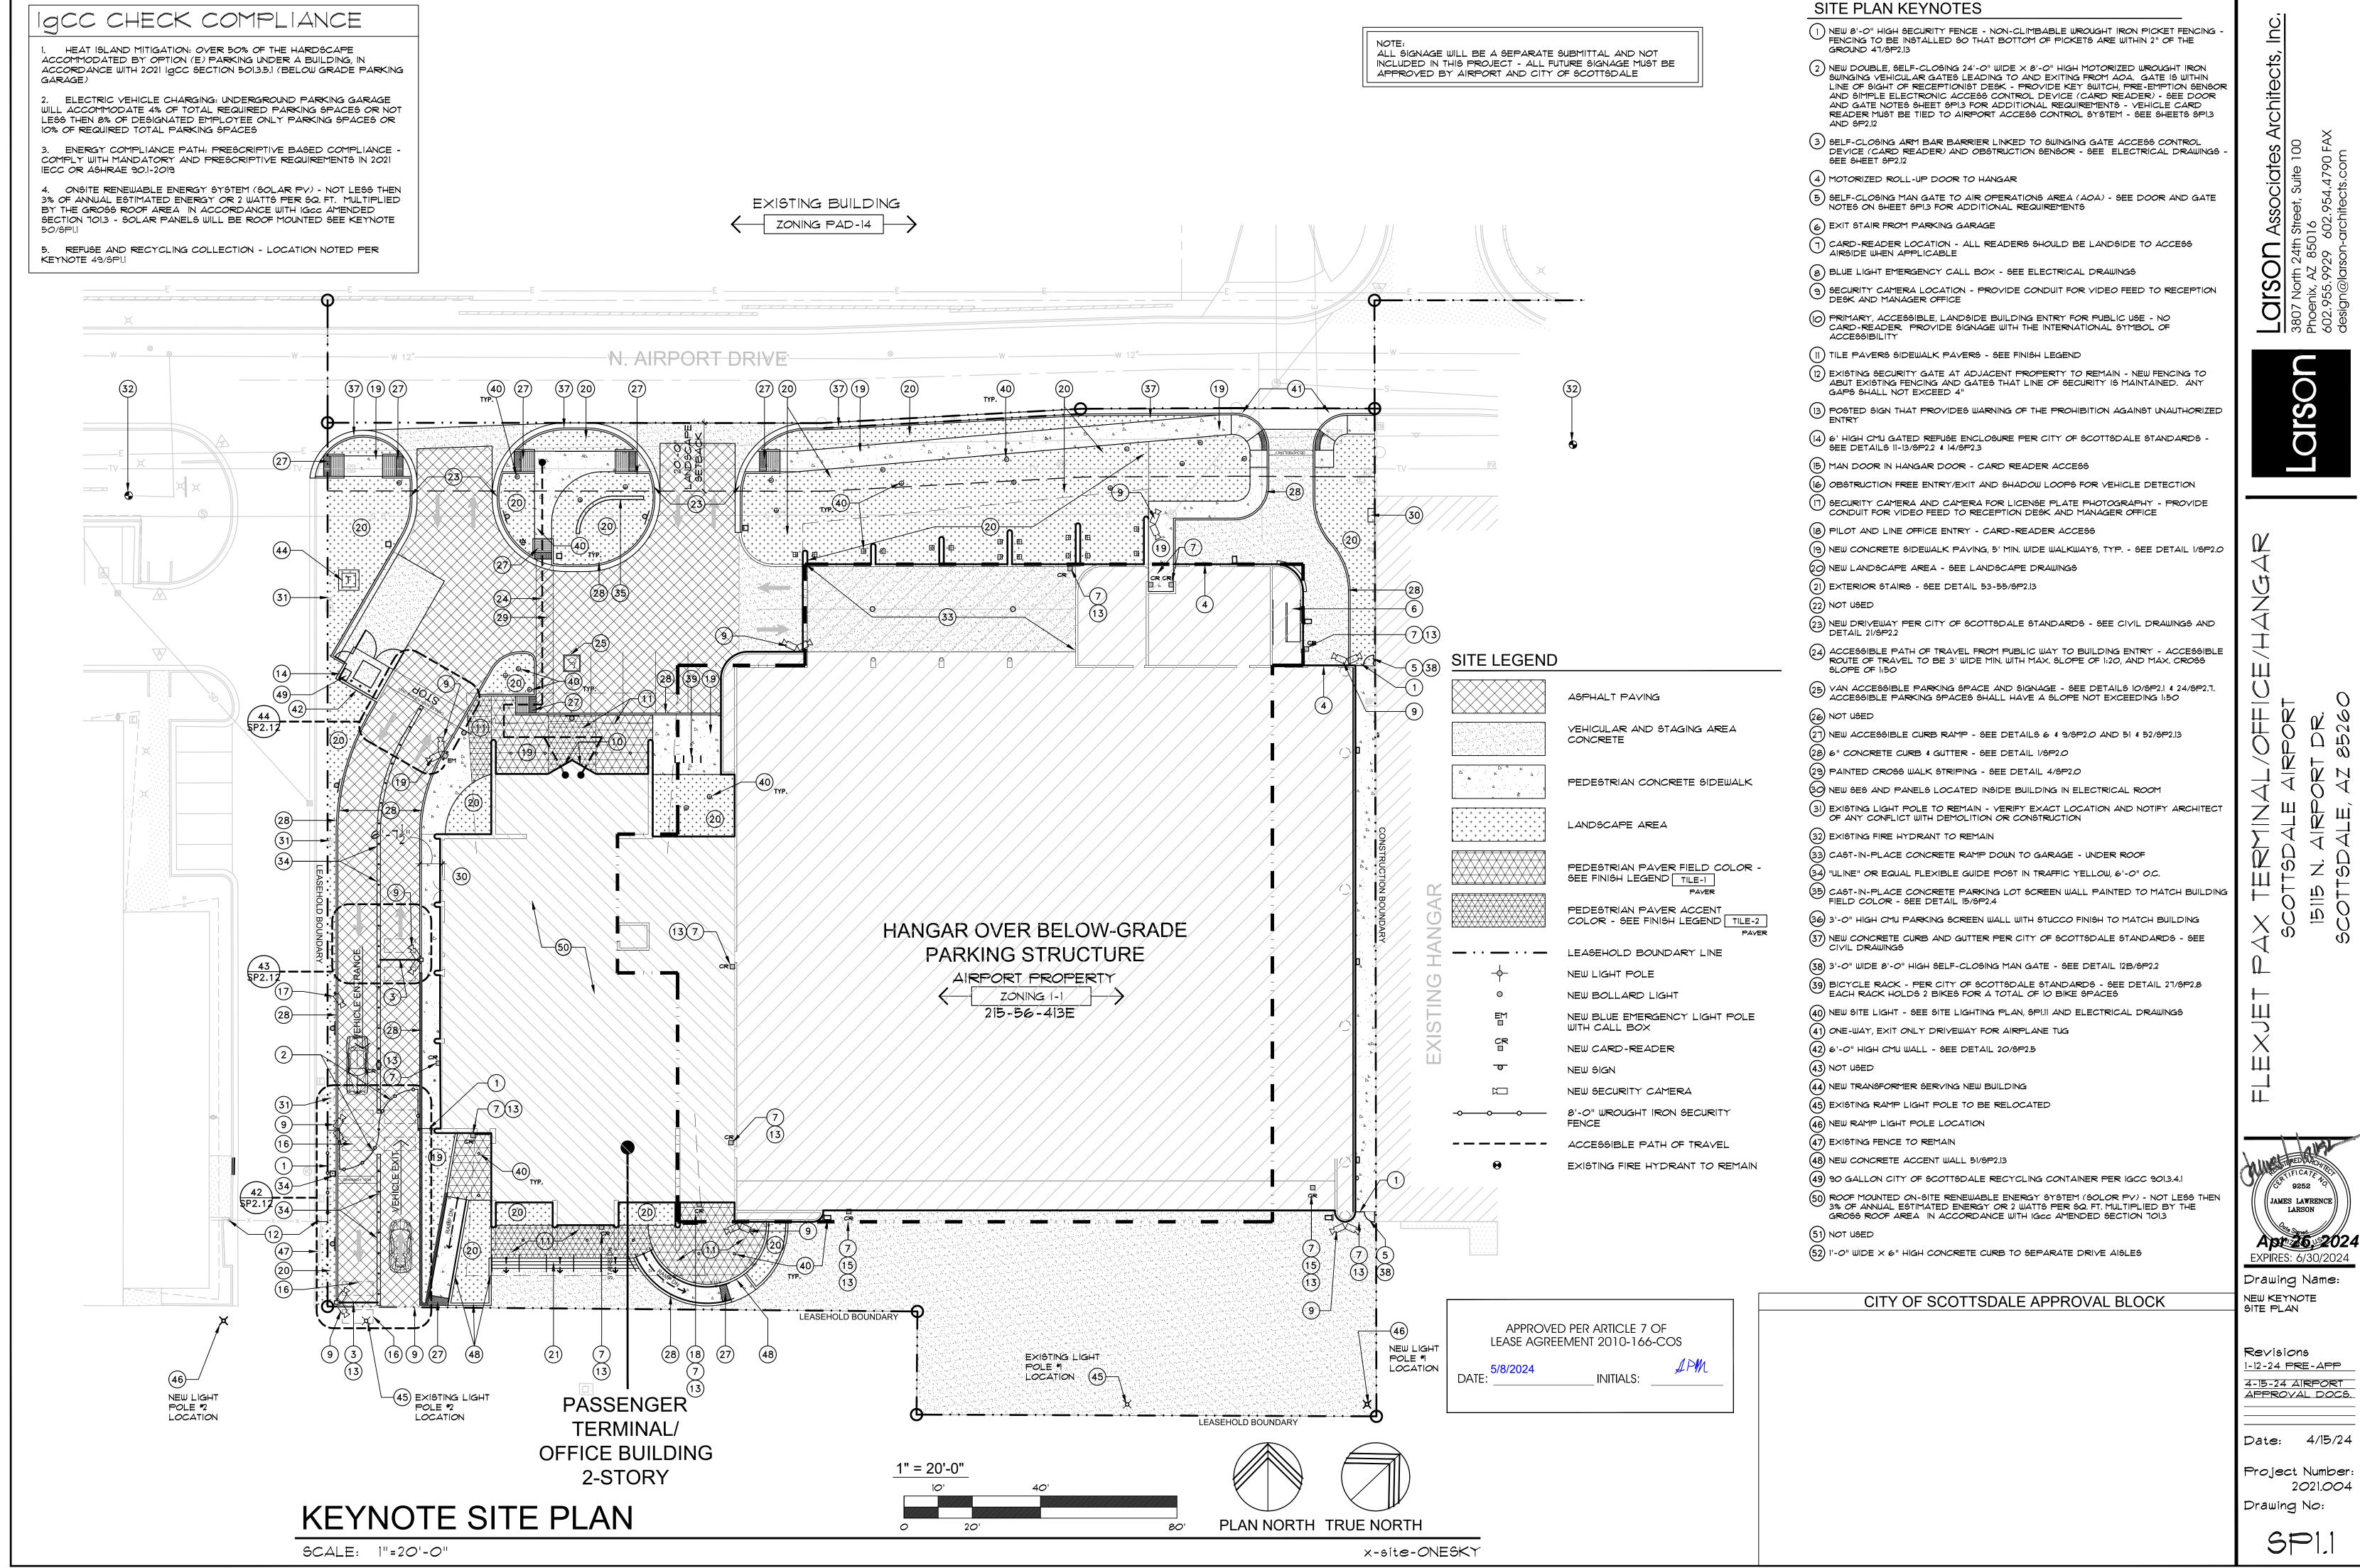

11-DR-2024 5/16/2024

NORTH

Drawing Name: AERIAL SITE PLAN

Revisions 1-12-24 PRE-APP 4-15-24 AIRPORT APPROVAL DOCS.

Date: 4/15/24 Project Number:

2021.004 Drawing No:

SP1.2

VICINITY MAP NOT TO SCALE EXISTING HANGARS TO REMAIN EXISTING OFFICE BUILDING AND RAMADA TO BE DEMOLISHED - NEW HANGAR, BELOW-GRADE PARKING GARAGE AND TERMINAL/OFFICE BUILDING


AIRPORT STIPULATION:


1. ANY FUTURE FUEL DISPENSING AND STORAGE BY SEPERATE SUBMITTAL AND PERMIT MUST HAVE SPECIFIC DOCUMENTED AIRPORT REVIEW AND APPROVAL TO CONFIRM COMPLIANCE WITH AIRPORT RULES AND REGULATIONS.

APPROVED PER ARTICLE 7 OF LEASE AGREEMENT 2010-166-COS

CITY OF SCOTTSDALE APPROVAL BLOCK

x-site-ONESKY-aerial PLAN NORTH TRUE NORTH

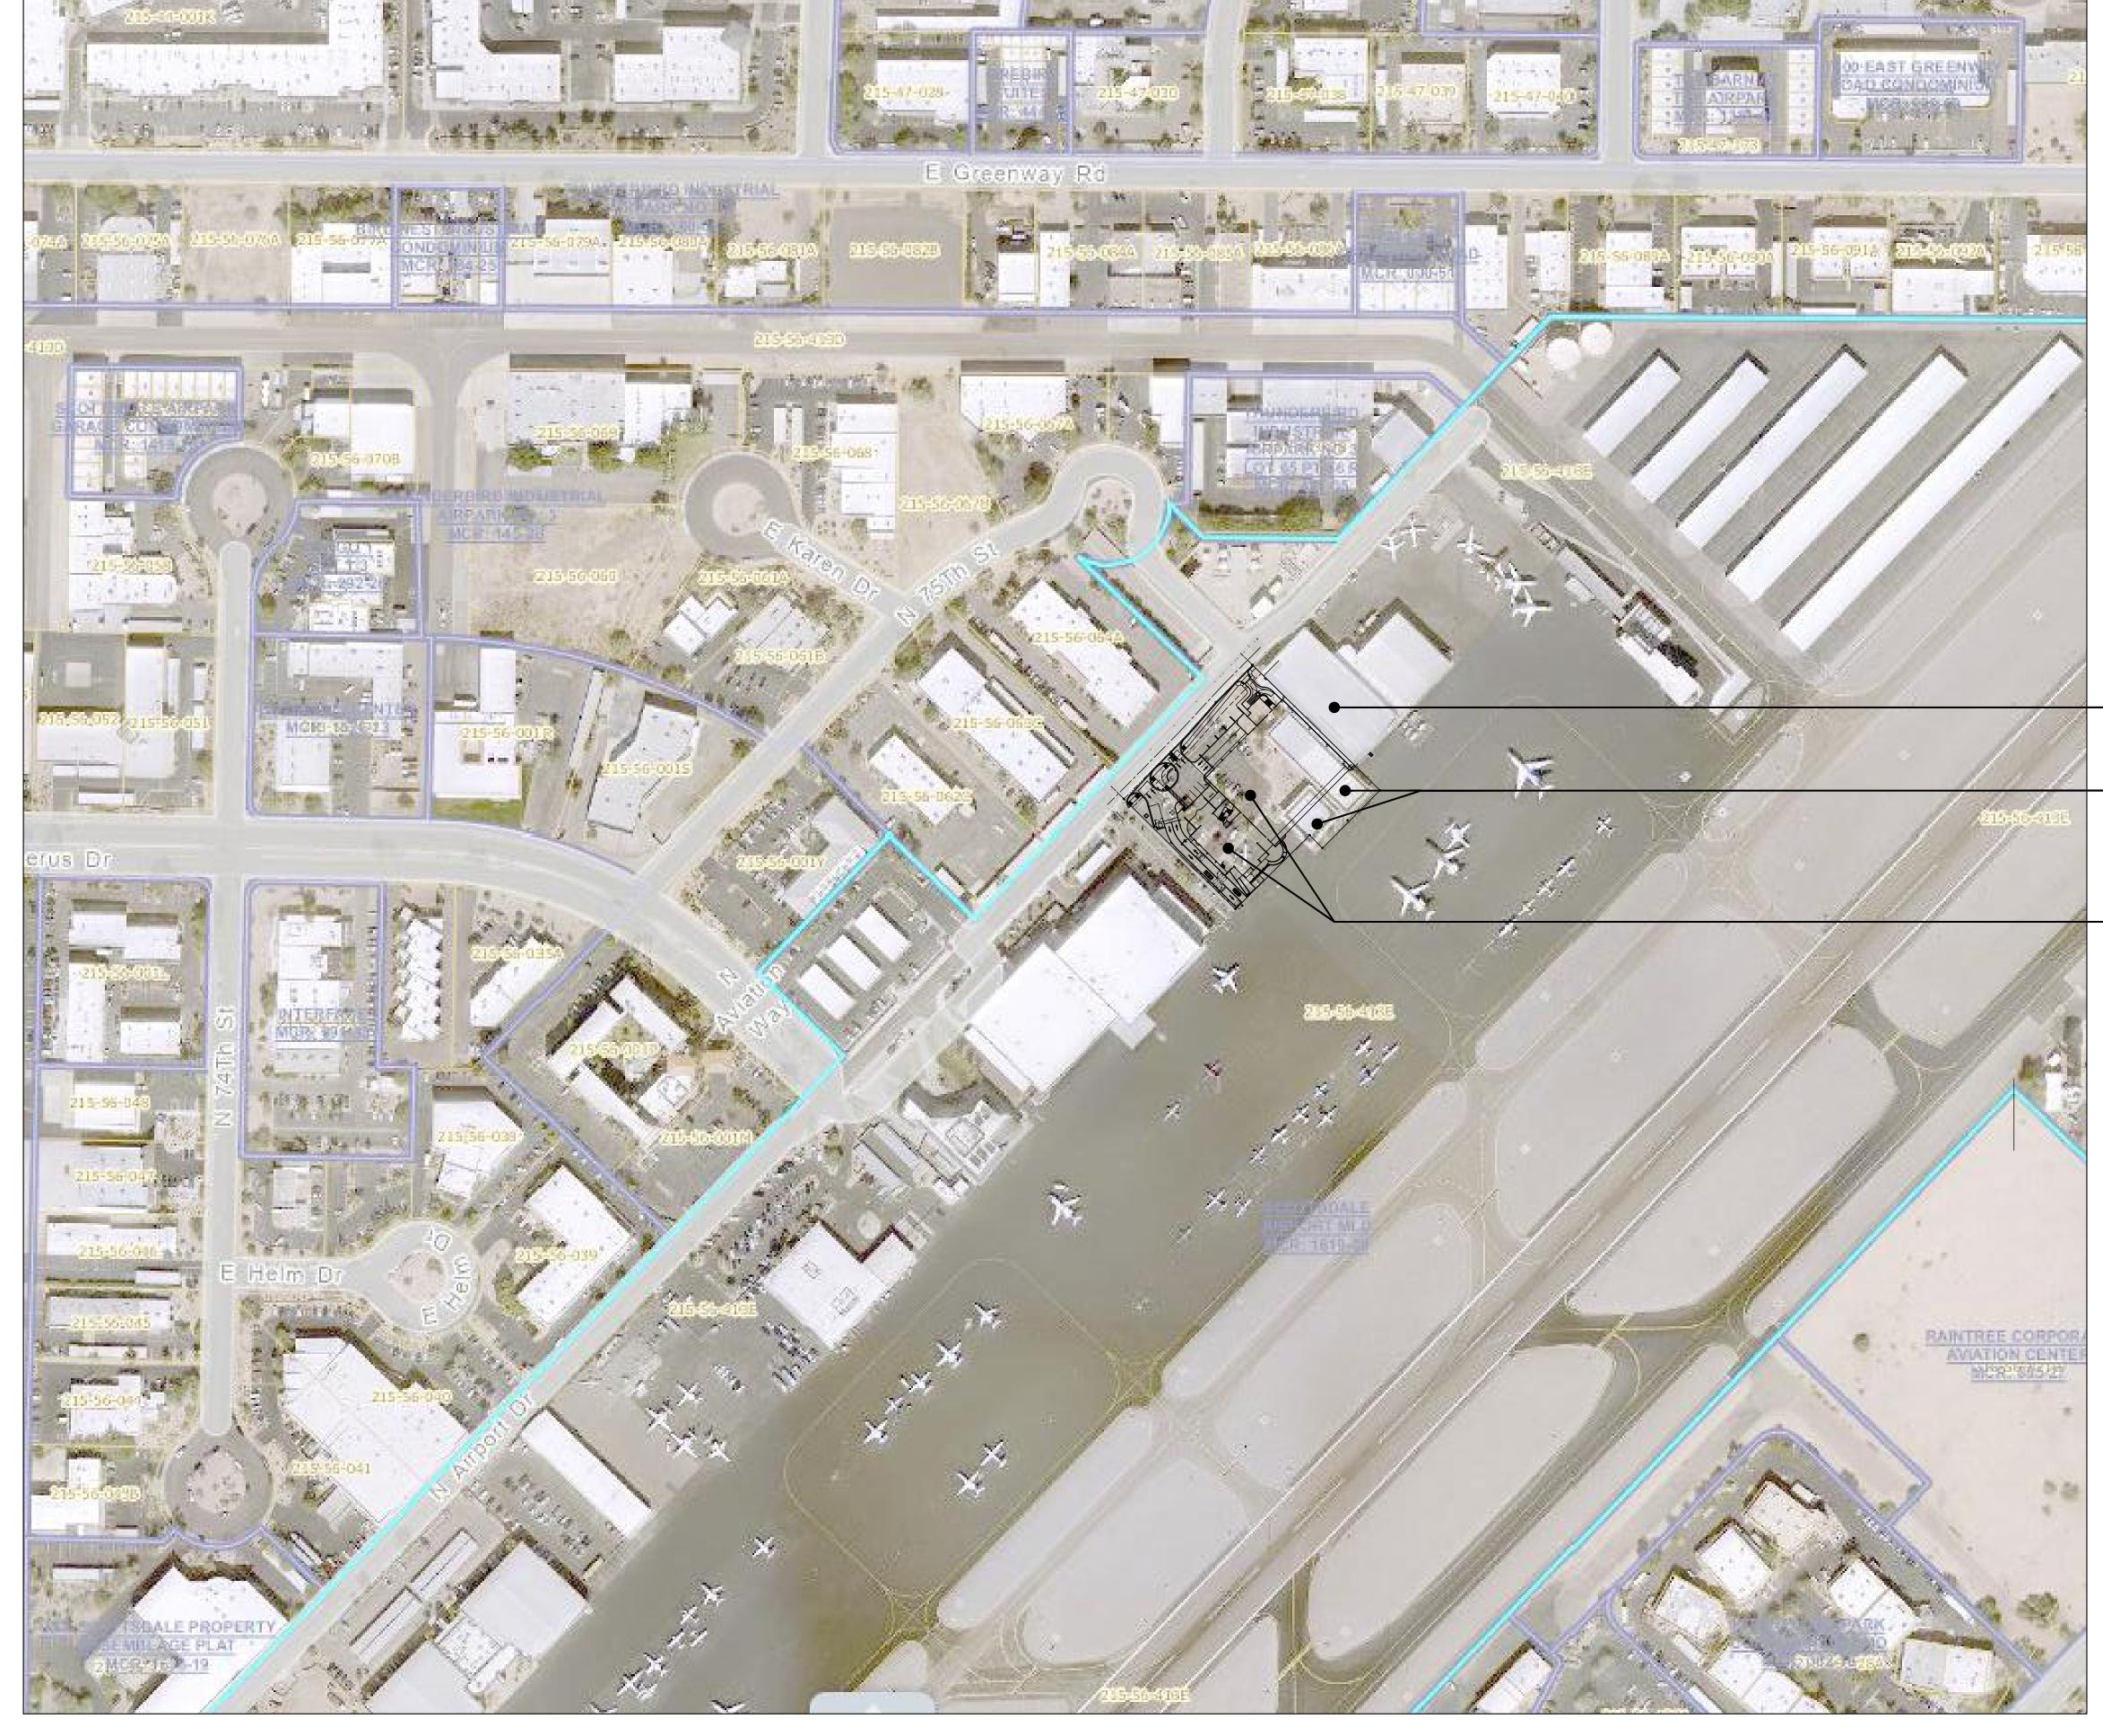

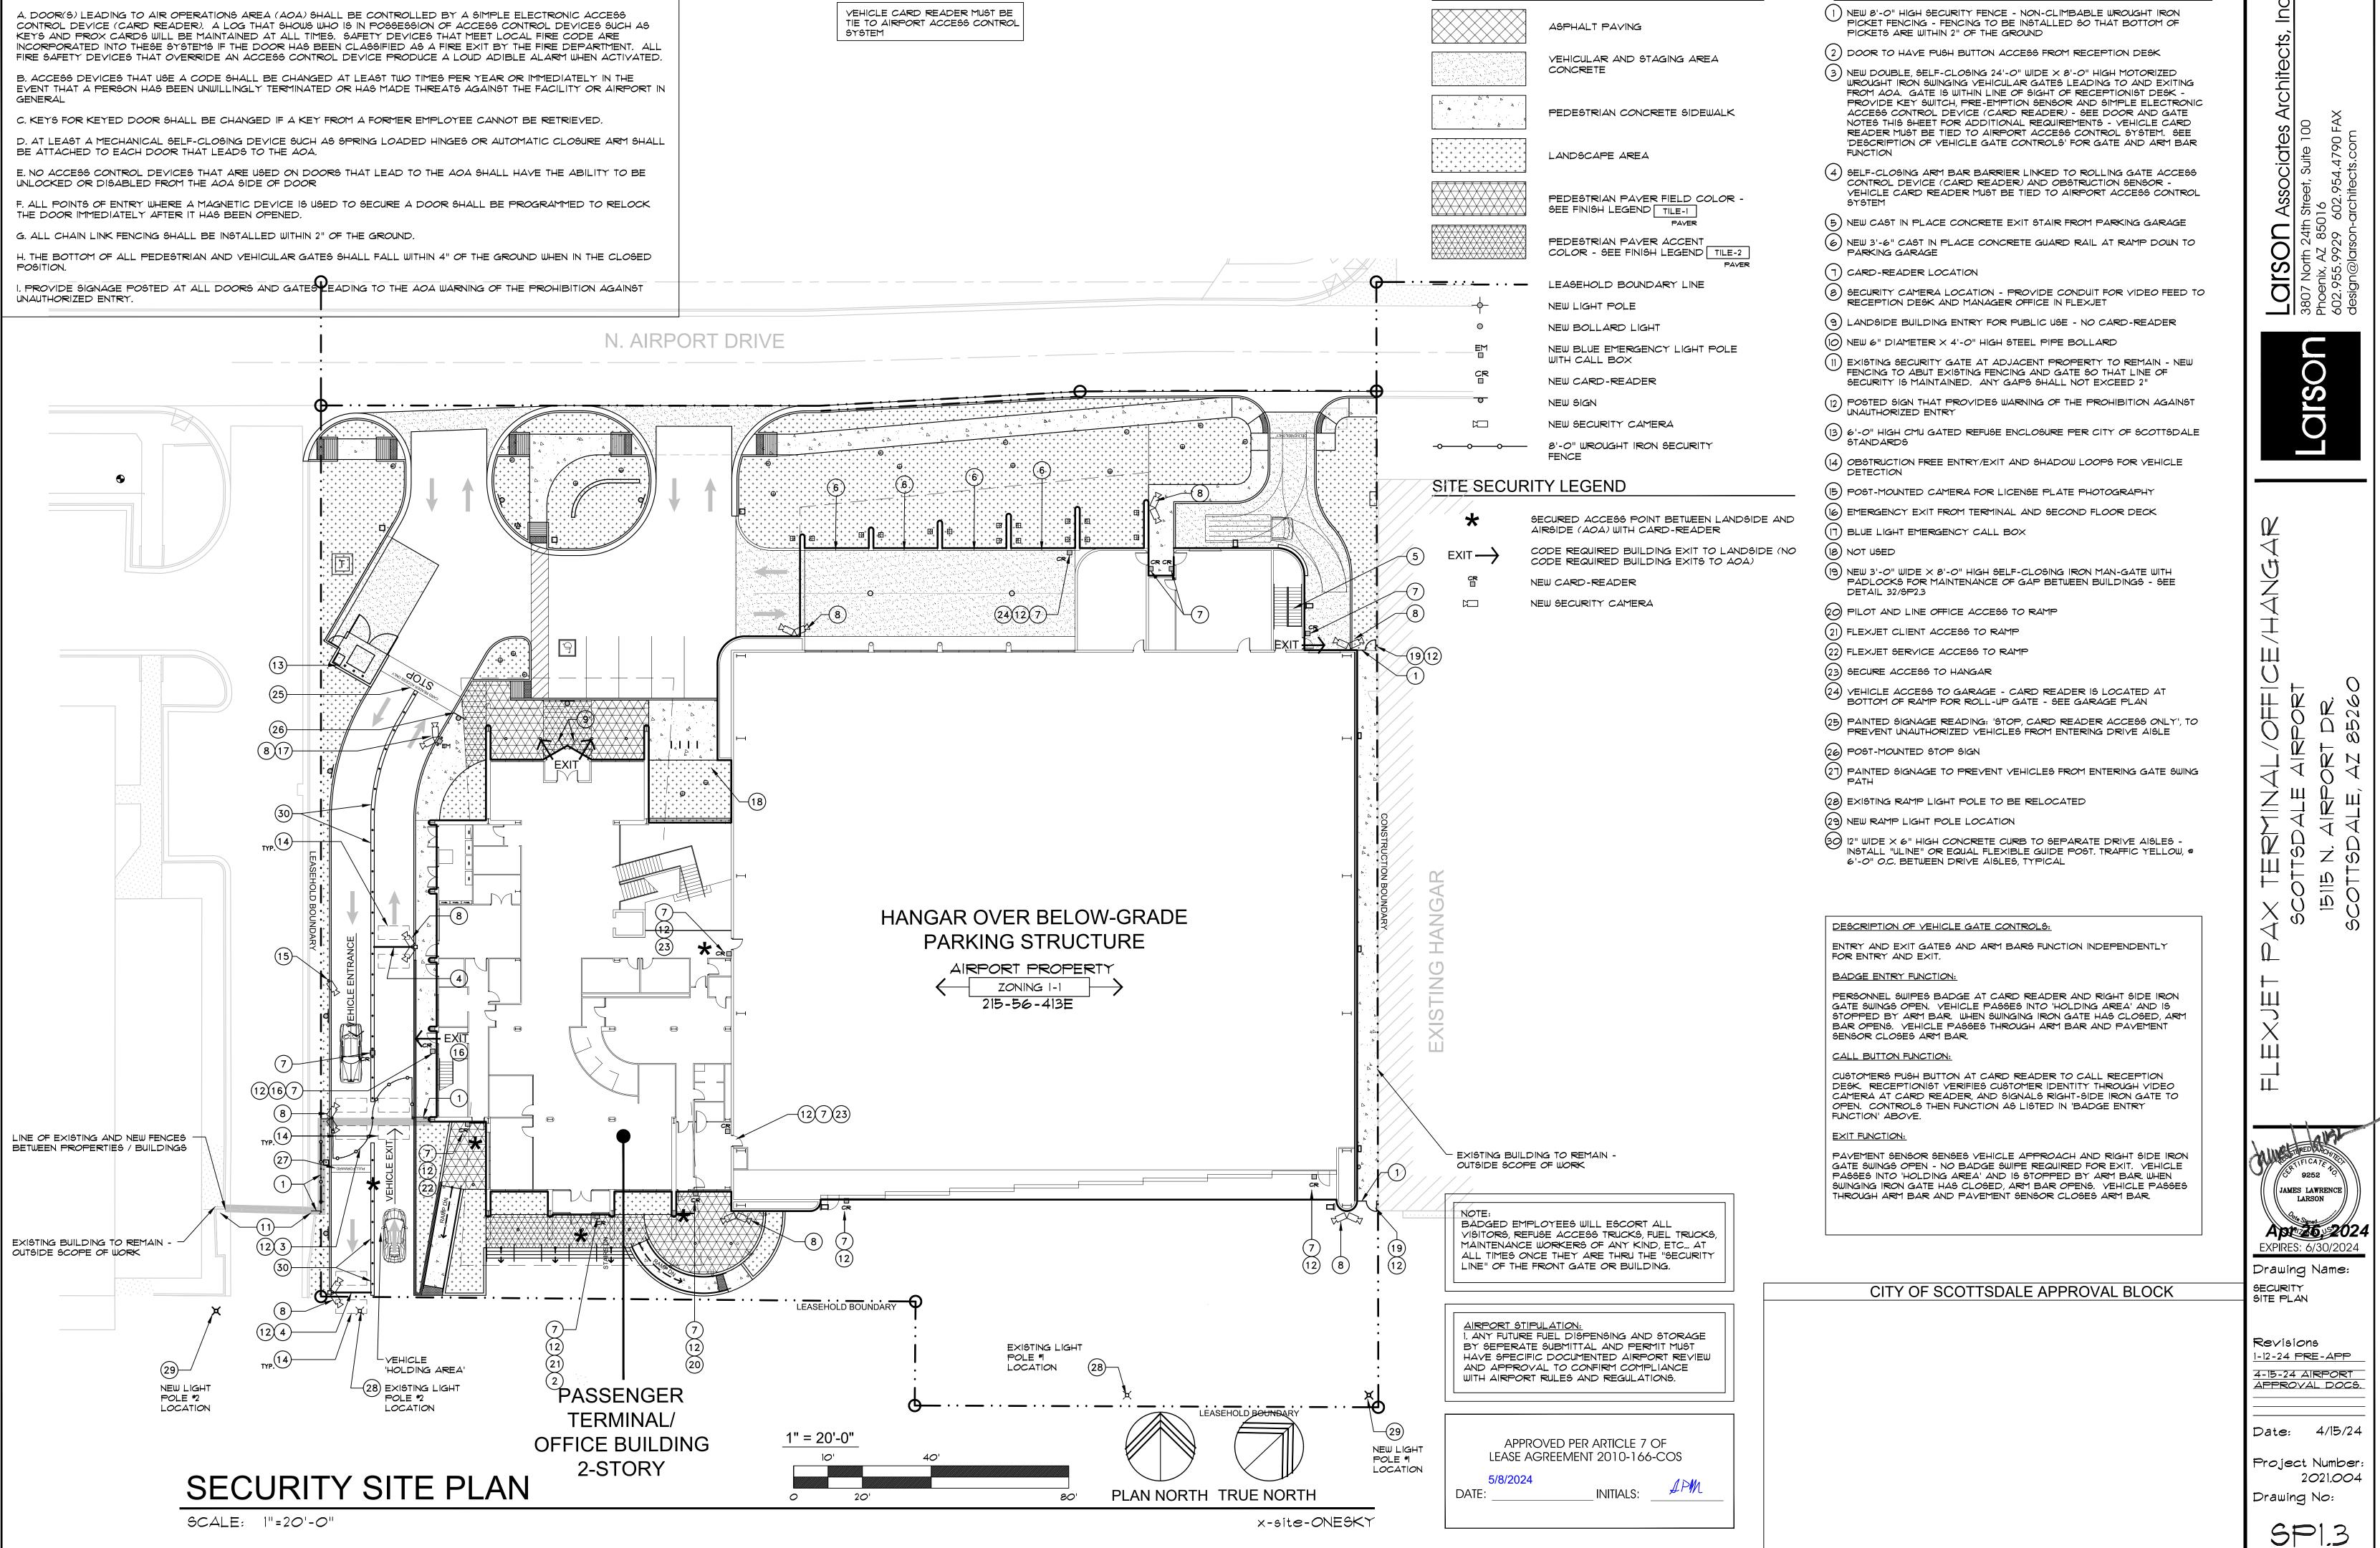

DOOR AND GATE NOTES (FOR DOORS AND GATES ACCESSING AOA):

SITE LEGEND

SITE PLAN KEYNOTES


Revisions

1-12-24 PRE-APP 4-15-24 AIRPORT APPROVAL DOCS

Date: 4/15/24

Project Number 2021.004 Drawing No:

SP2.0

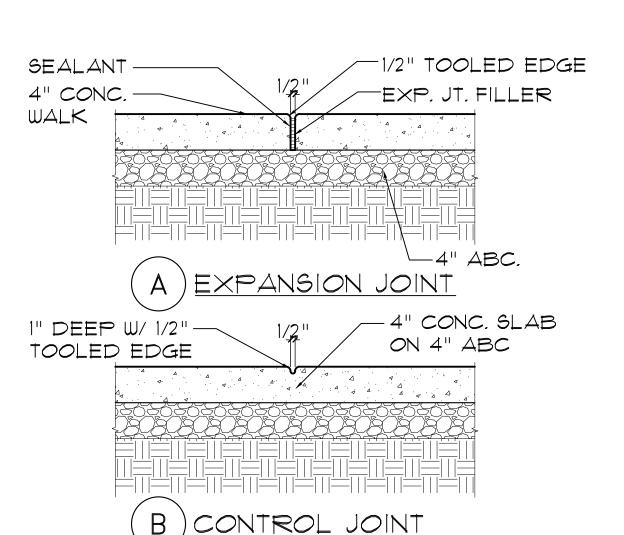


EXPANSION / CONTROL JOINT

NOT USED


SCALE: 1" = 1'-0"


-CONTROL JOINT AT
OUTER EDGE OF
CROSSWALK - RUN
PERPENDICULAR TO
CURB U.N.O. 4" WIDE PAINT STRIPING TO MATCH PAINT OF H.C. PARKING STALLS PER CITY OF SCOTTSDALE STANDARDS

> CROSSWALK STRIPING SCALE: 3/8"=1'-0"

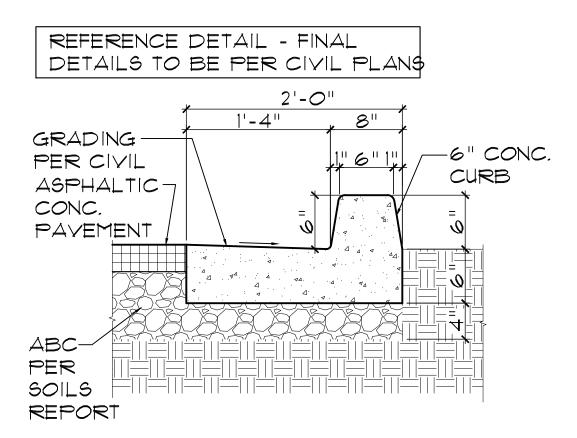

CURB AND GUTTER - REFERENCE ONLY - SEE CIVIL

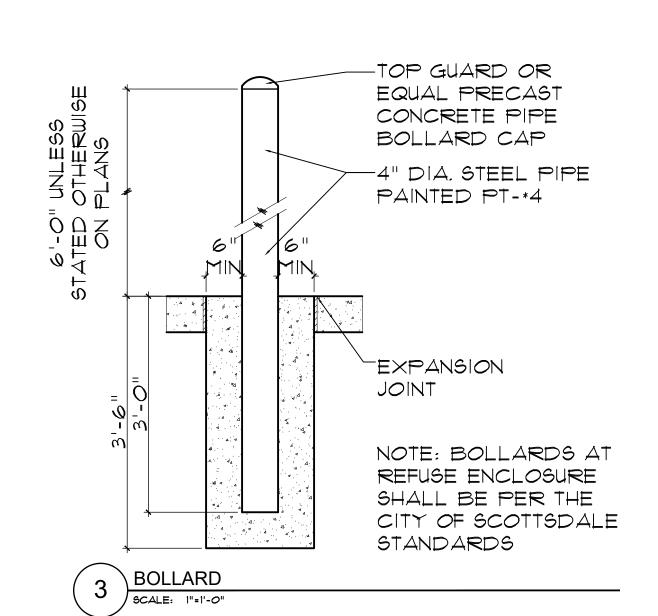

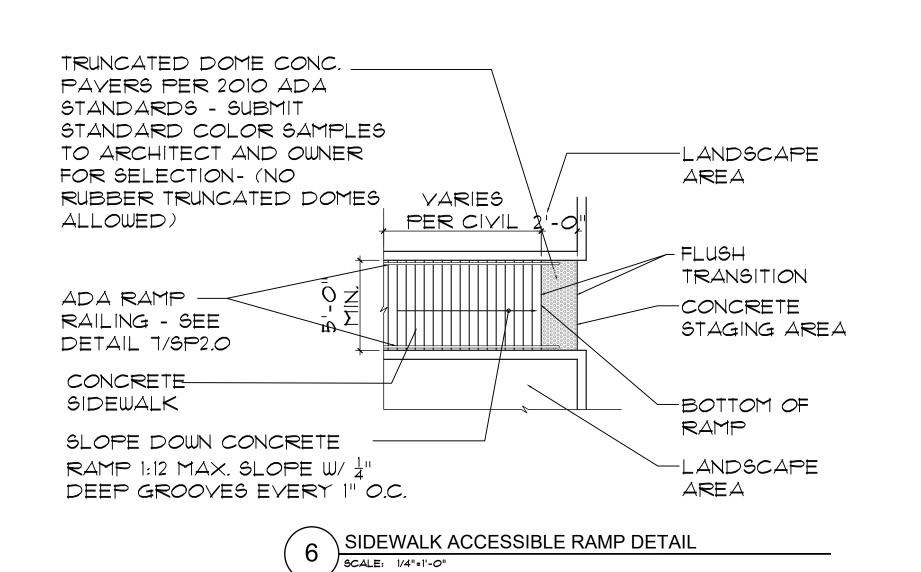

\ SIDEWALK ACCESSIBLE RAMP DETAIL SCALE: 1/4"=1'-0"

NOT USED SCALE: 1/4"=1'-0"

> 6'-0" CONC. W/2-24" LONG STEEL RODS (1'-0" FROM ENDS)

2'-0" - EDGE OF PAYING,

END OF SPACE,

OR FACE OF WALK

NO RUBBER TRUNCATED

SLOPE 1:12.0 MAXIMUM

DOME SURFACING - INTEGRAL CONCRETE SYSTEMS ONLY

-LOW LEYEL CONCRETE

-PAINTED 4" LINE STRIPING

PER C.O.S. STANDARD

DETAIL - SEE 4/SP2.0

TO BE FLUSH WITH

PARKING LOT

\ CONCRETE PARKING BUMPER DETAIL

SCALE: 1/2"=1'-0"

SLOPED CONCRETE-

1/4" DEEP GROOVES

EVERY I" O.C.

CONCRETE

SIDEWALK

CONCRETE CURB

TRUNCATED DOME LANDING

AREA FLUSH PARKING AREA

PAVERS PER A.D.A.A.G. SECTION

SAMPLES TO ARCHITECT AND

105 - SUBMIT STANDARD COLOR

TRUNCATED DOME CONC.

OWNER FOR SELECTION


SIDEWALK RAMP WITH


4-15-24 AIRPORT APPROVAL DOCS.

Date: 4/15/24

Project Number: 2021.004 Drawing No:

SP2.1

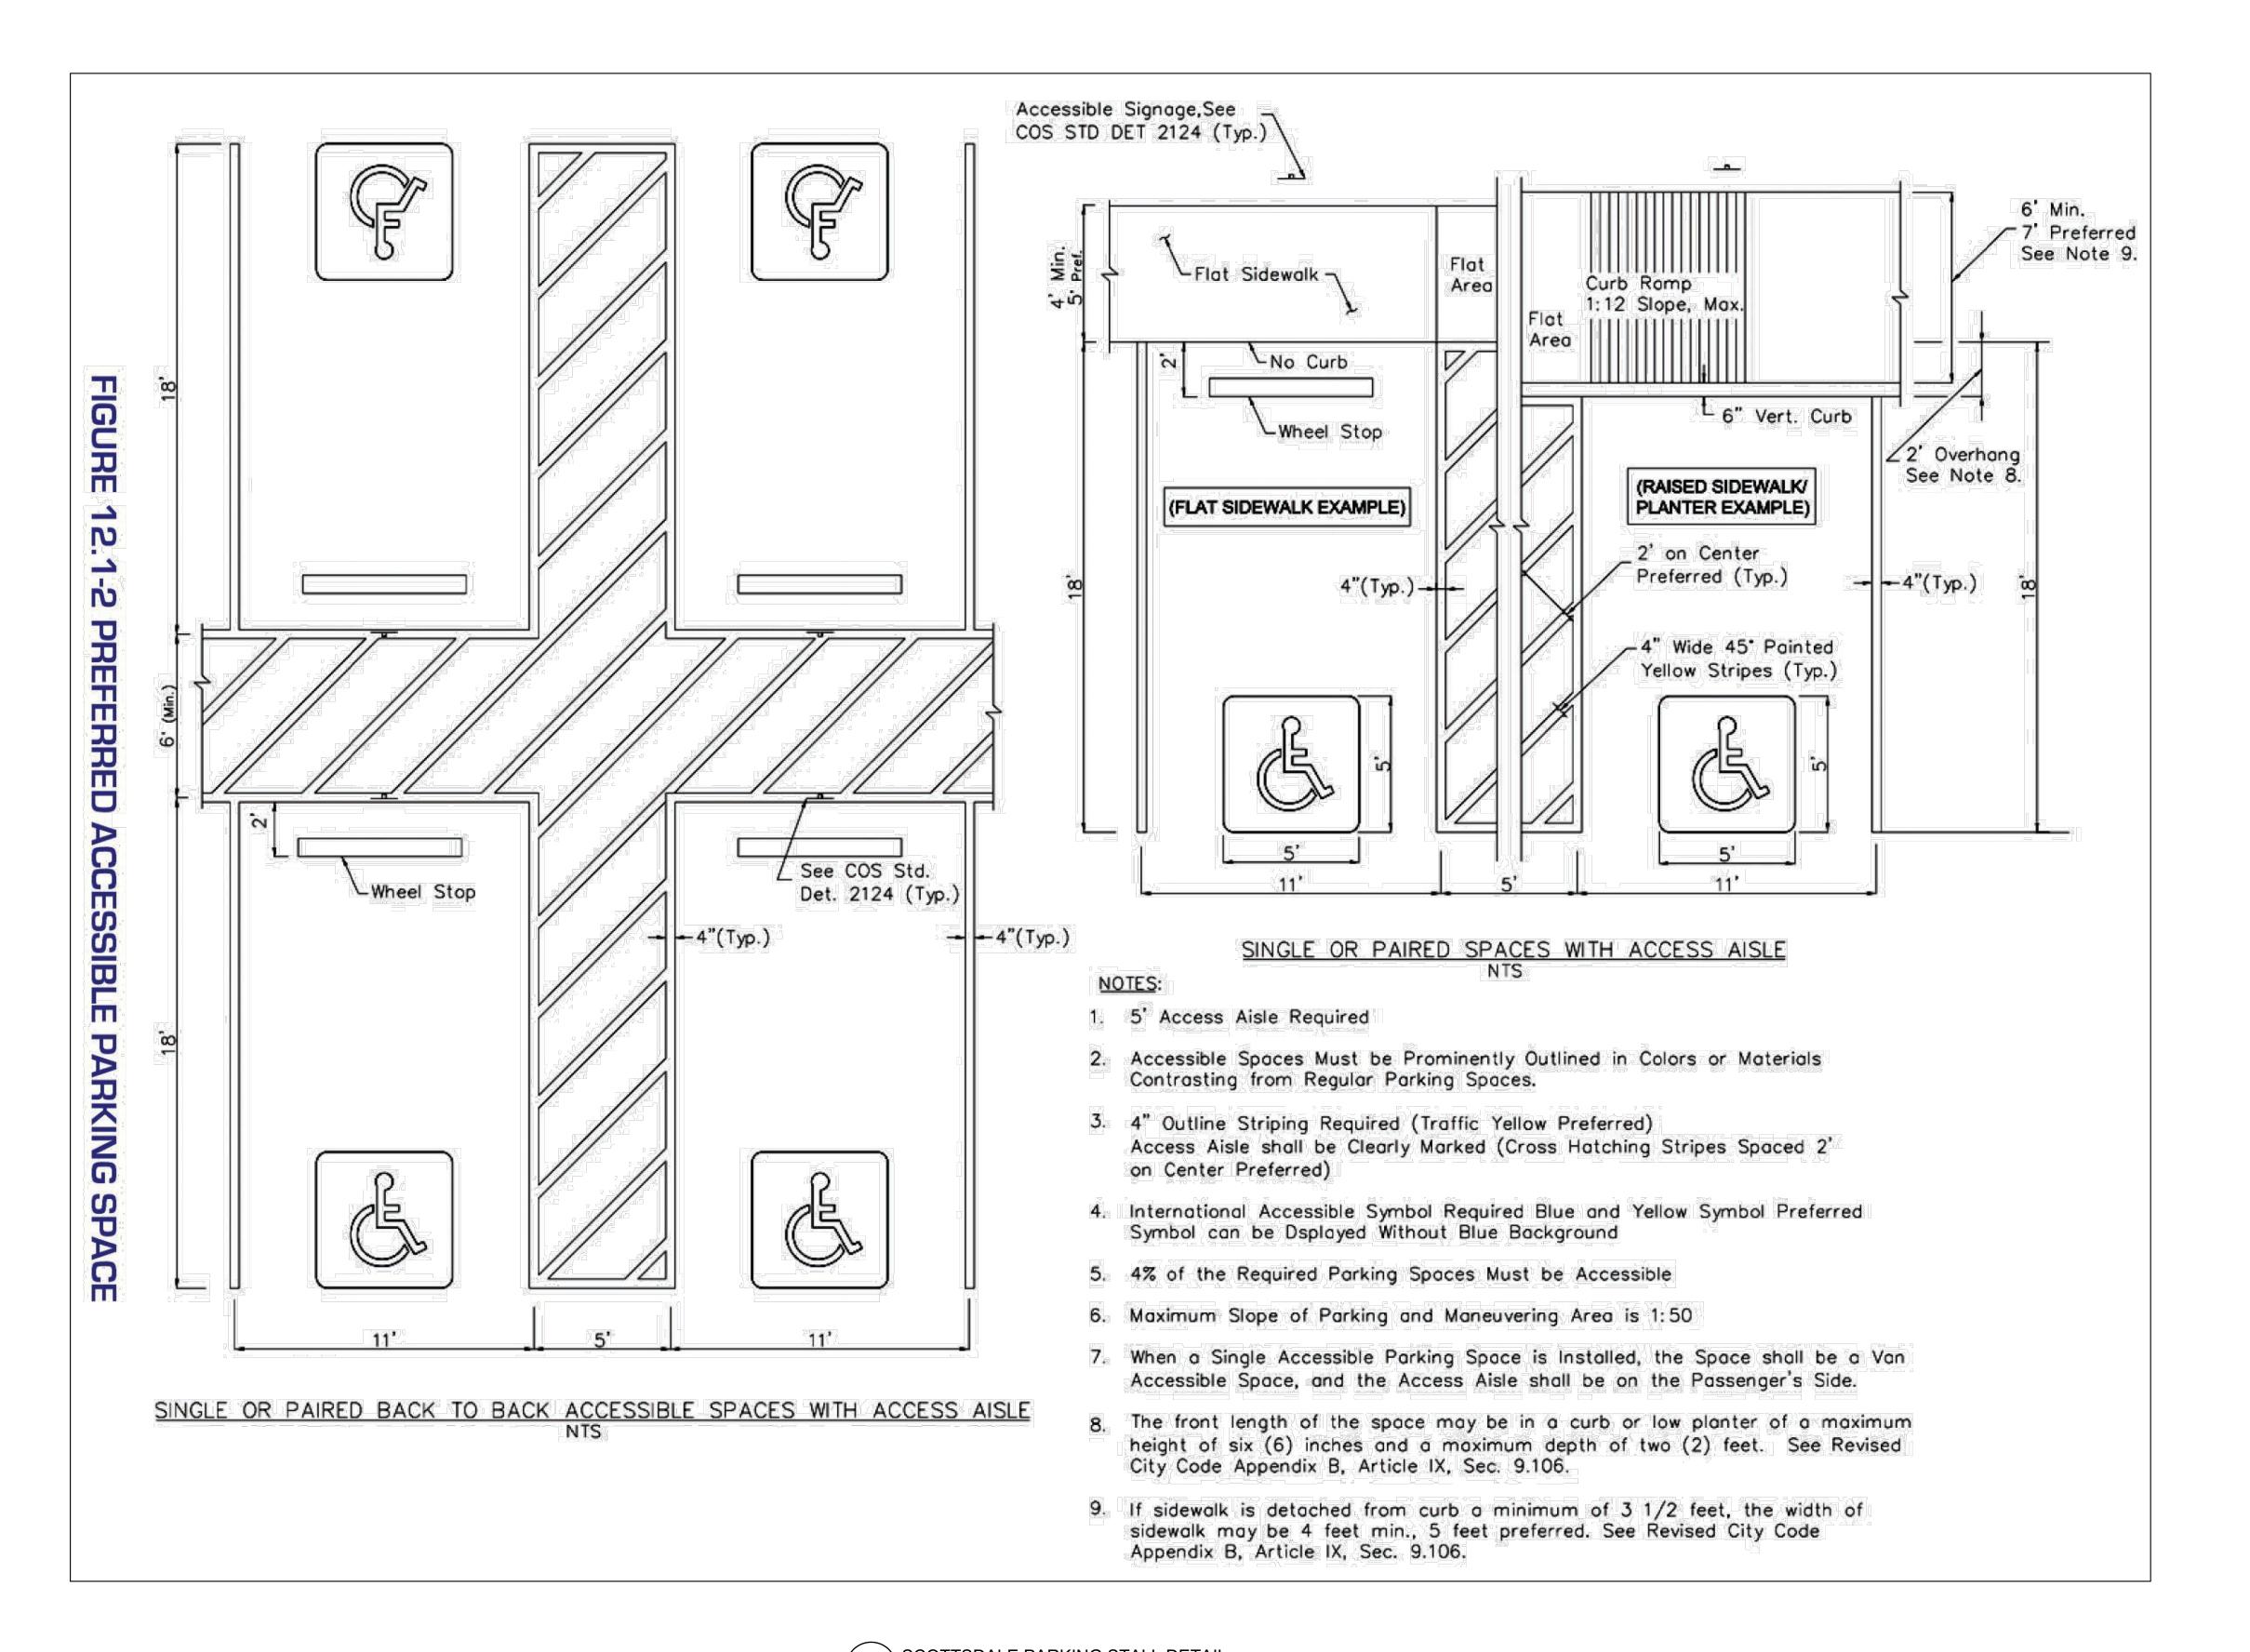

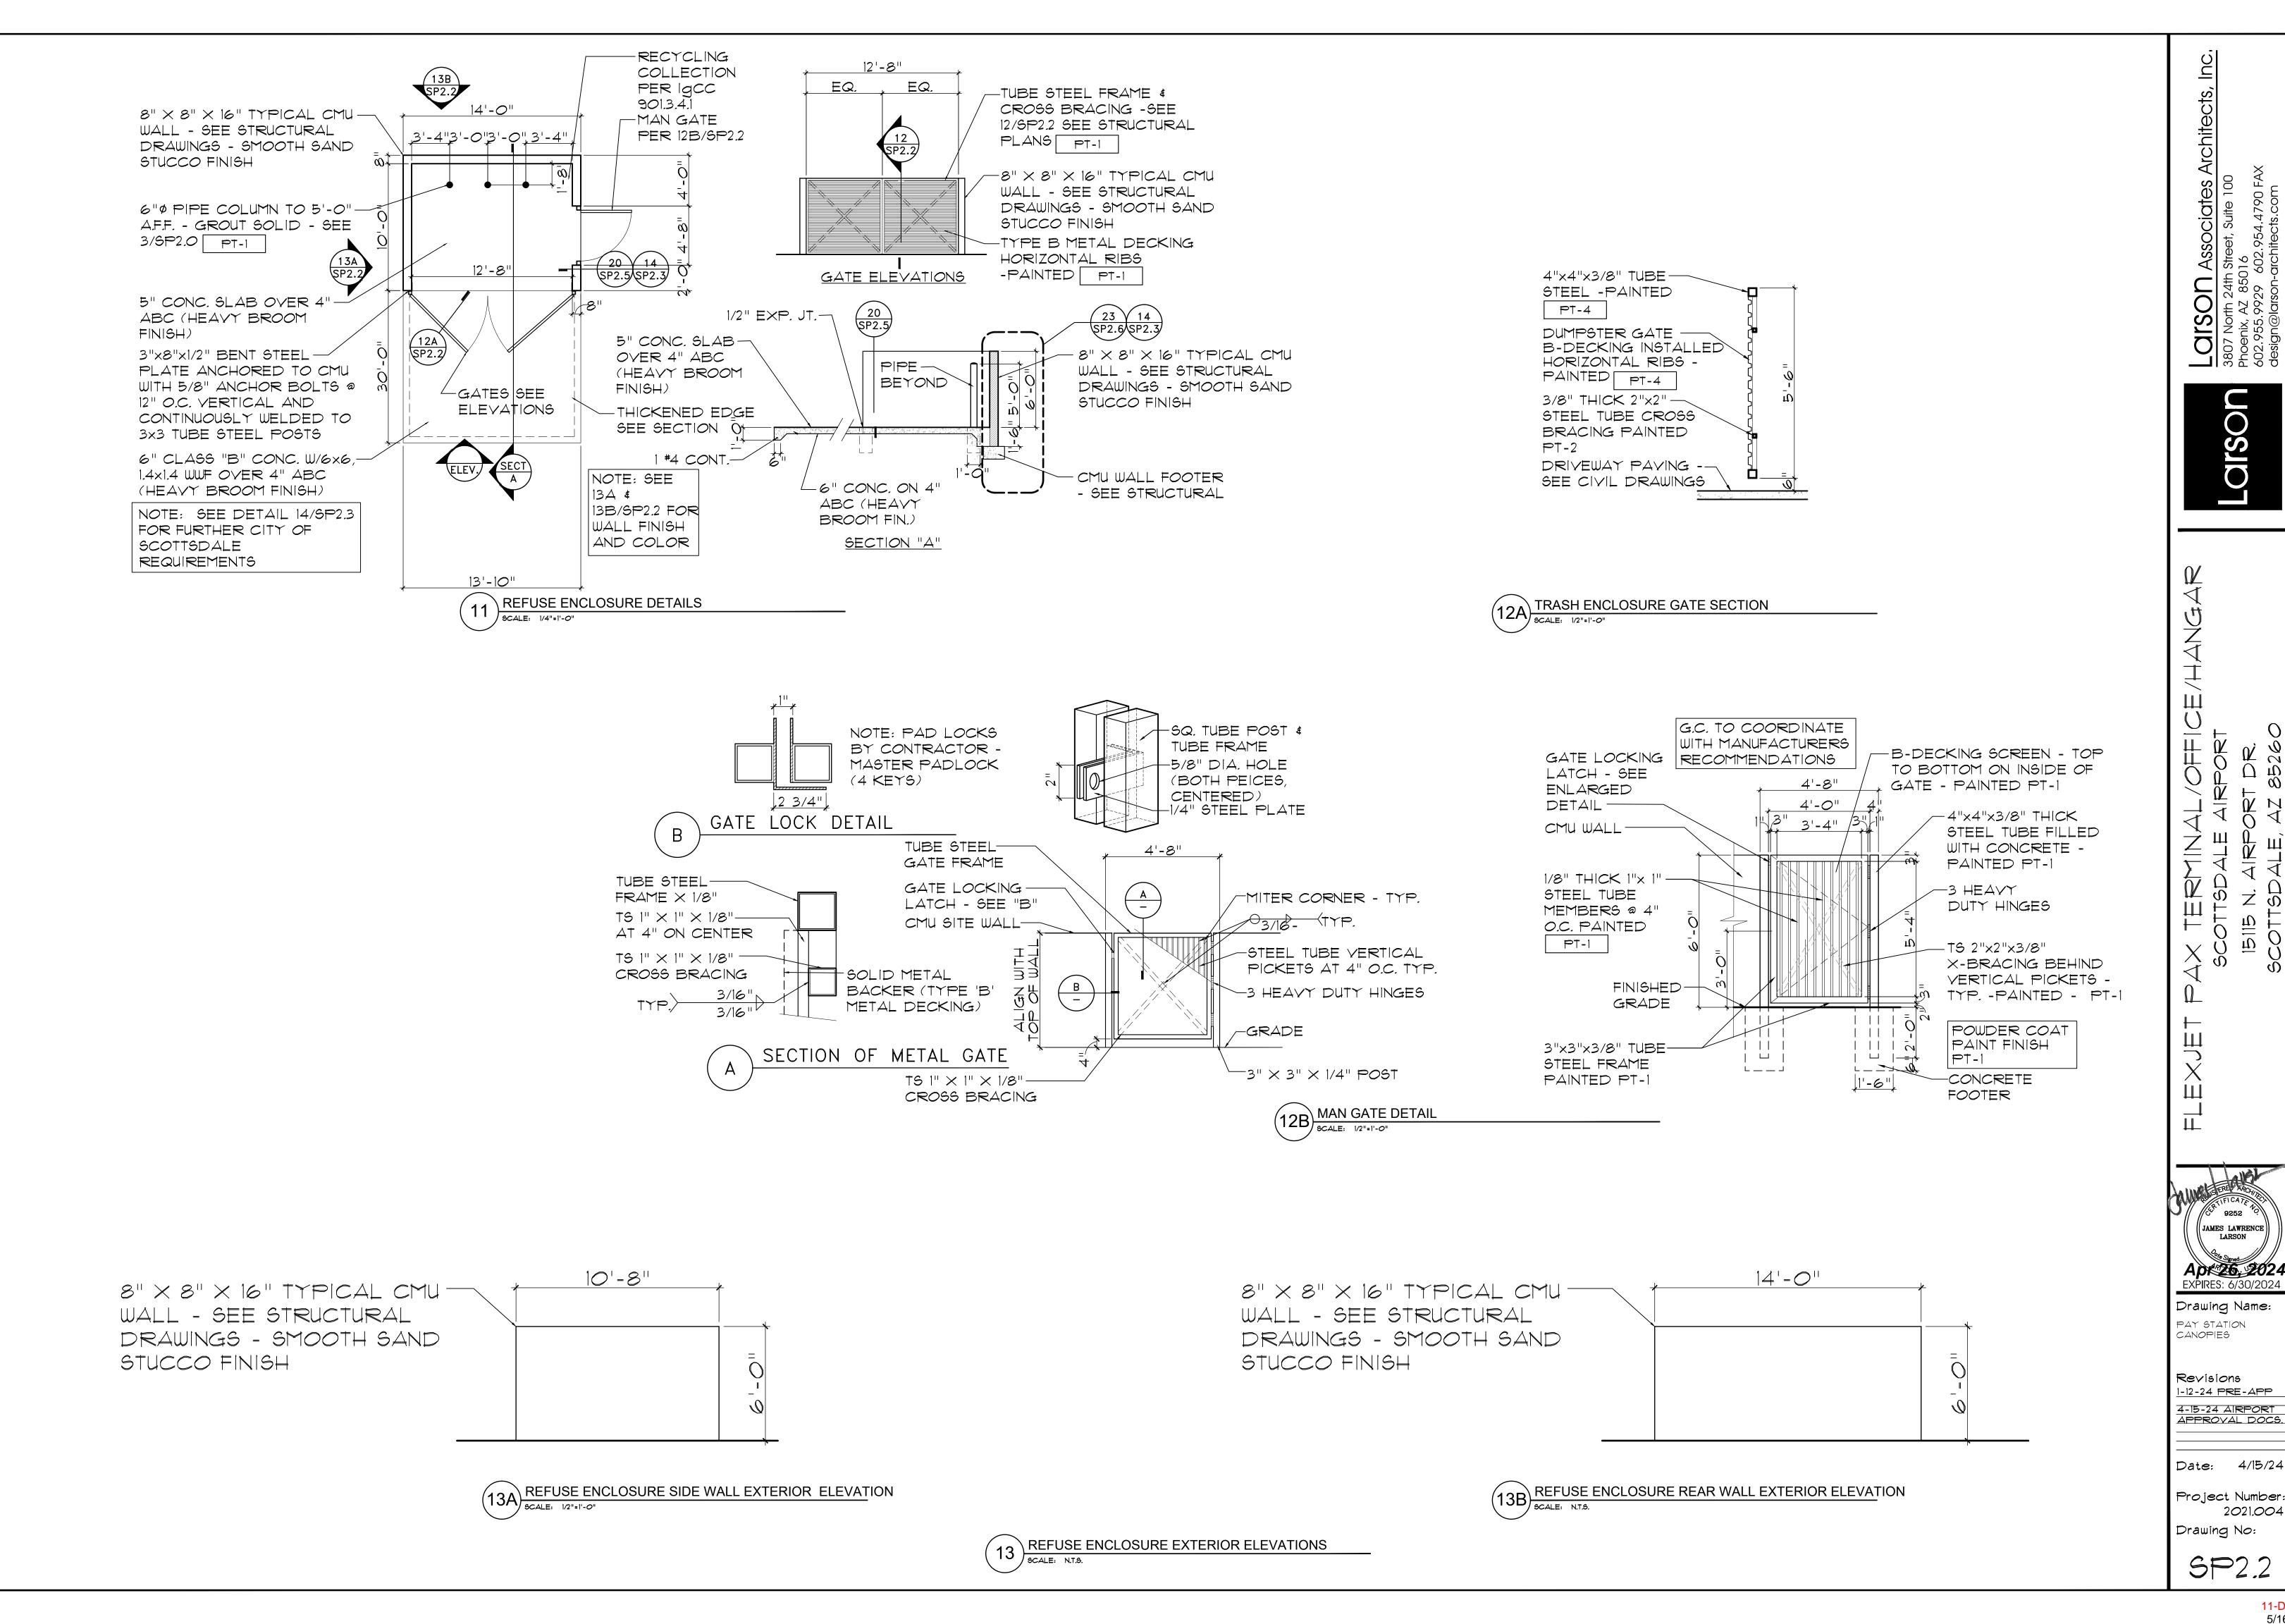

11-DR-2024 5/16/2024

Drawing Name:


Date: 4/15/24

Project Number:

Drawing No:

2021.004

SP2.4

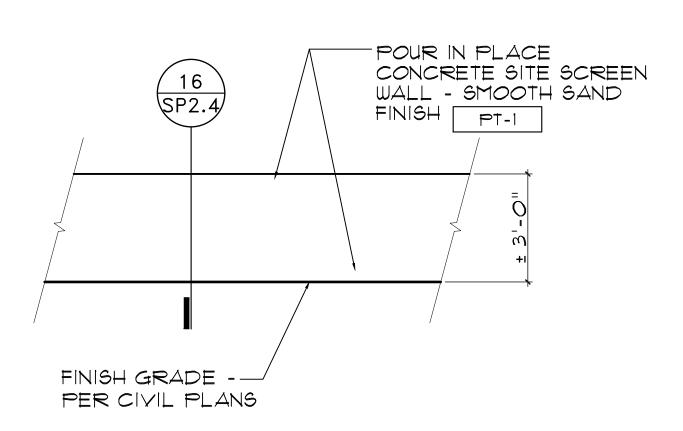

LOW SITE SCREEN WALL ELEVATION

SCALE: 1/2"=1'-0"

NOTES:

(1) REINFORCING PER STRUCTURAL

2) 8" THICK CONC. POUR IN PLACE WITH REINFORCING PER STRUCTURAL - SMOOTH SAND FINISH PAINTED PT-1

3 CONCRETE SLAB PER CIVIL WHERE REQUIRED

4 DOWELS TO MATCH AND LAP VERTICAL WALL REINFORCING PER G.S.N. - ALTERNATE BENDS.

5 CONCRETE FOOTING PER STRUCTURAL

(6)(2) #4 CONTINUOUS

7 SEE STRUCTURAL FOR REINFORCING


8 EXPANSION JOINT - SEE NOTE ON MATERIAL ON DETAIL 13/5P2.1

9 PROVIDE 4" H. OPENING AT LOW POINTS WHERE SLAB SLOPES BACK INTO BIN RECEPTACLE - SPACE AT 10'-0" O.C.

MINIMUM, APPROVED MATERIALS:

CONCRETE F'C = 2000 PSI
REINFORCING FY = 40,000 PSI
CMU F'M = 1350 PSI
MORTAR ASTM TYPE S
GROUT F'C = 2000 PSI
DUROWALL F'Y = 80,000 PSI

NOTE: ALL CELLS TO BE GROUTED SOLID FULL HEIGHT NOTE: THIS IS FOR REFERENCE ONLY -SEE STRUCTURAL FOR FINAL DETAILING

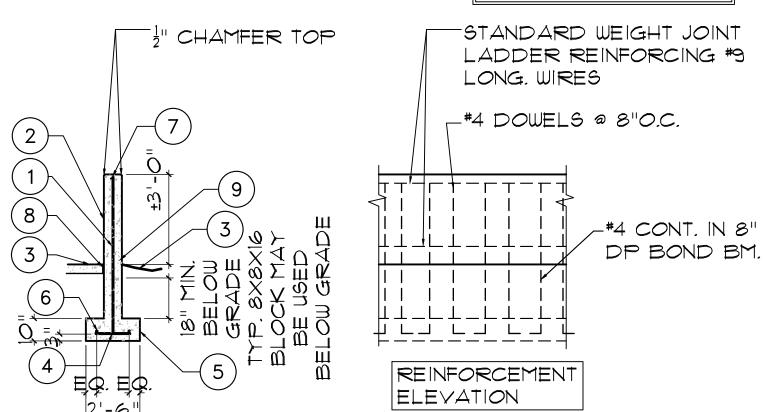

16 3'-0" TALL POUR IN PLACE SCREEN WALL SECTION

SCALE: 1/2"=1'-0"

NOT USED

9CALE:

11-DR-2024 5/16/2024

Revisions
1-12-24 PRE-APP
4-15-24 AIRPORT
APPROVAL DOCS

Date: 4/15/24

Project Number: 2021.004 Drawing No:

SP2.5

NOT USED SCALE:


MINIMUM, APPROVED MATERIALS:

CONCRETE F'C = 2000 PSI
REINFORCING FY = 40,000 PSI
CMU F'M = 1350 PSI
MORTAR ASTM TYPE S
GROUT F'C = 2000 PSI
DUROWALL F'Y = 80,000 PSI

NOTES

- (1) STANDARD WEIGHT JOINT LADDER REINFORCING #9 LONG. WIRES
- 2 8×8×16 CMU MASONRY WALLS WITH #4 VERTS AT 8"O.C. GROUT CELLS SOLID FULL HEIGHT
- (3) 6" CONCRETE SLAB
- 4 DOWELS TO MATCH AND LAP VERTICAL WALL REINFORCING PER G.S.N. - ALTERNATE BENDS.
- (5) CONCRETE FOOTING
- (6) (2) #4 CONTINUOUS
- (7) #4 CONT. IN 8" DP. BOND BM.
- (8) EXPANSION JOINT SEE NOTE ON MATERIAL ON DETAIL 13/SP2.1
- 9 PROVIDE 4" H. OPENING AT LOW POINTS WHERE SLAB SLOPES BACK INTO BIN RECEPTACLE SPACE AT 10'-0" O.C.

NOTE: THIS IS FOR REFERENCE ONLY -SEE STRUCTURAL FOR FINAL DETAILING

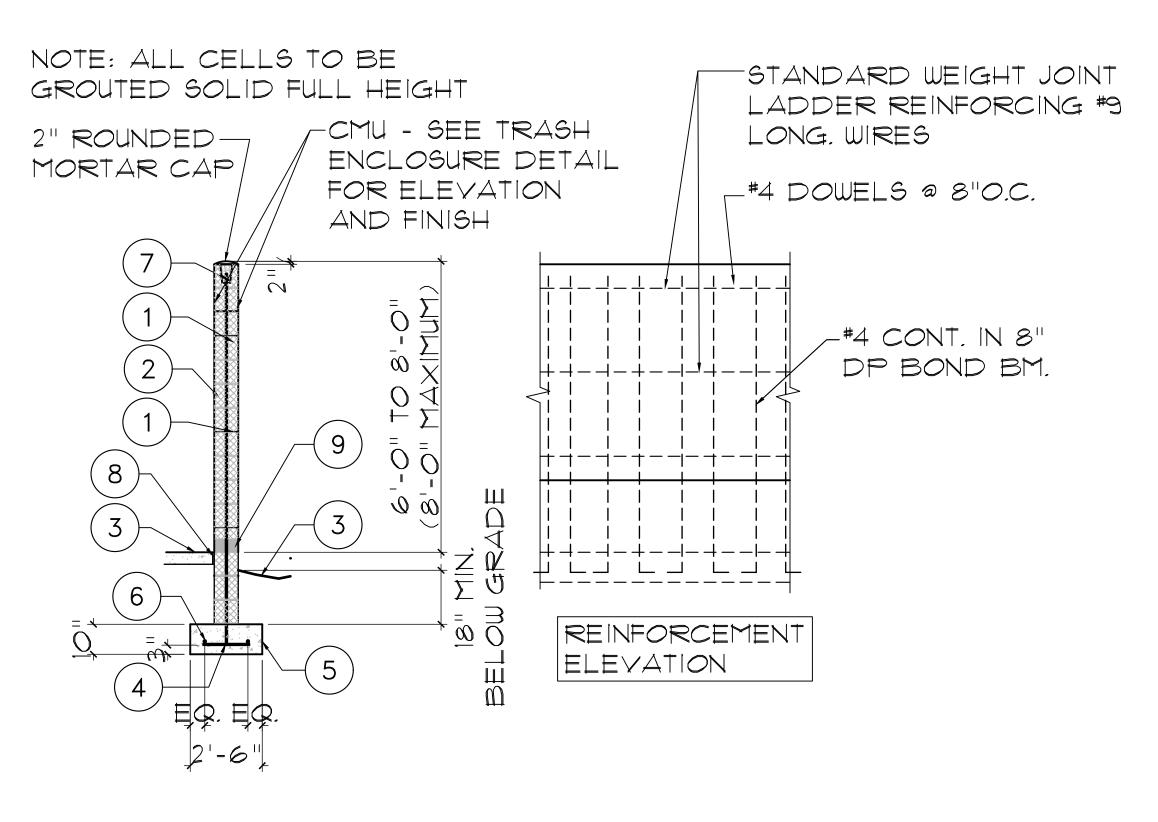

6' TO 8' SITE WALL SECTION

SCALE: 1/2"=1'-0"

JAMES LAWRENCE Apr 26, 2024 EXPIRES: 6/30/2024

X

Drawing Name: SITE DETAILS

Revisions 1-12-24 PRE-APP


4-15-24 AIRPORT APPROVAL DOCS.


Date: 4/15/24

Project Number:

2021.004 Drawing No:

SP2.6

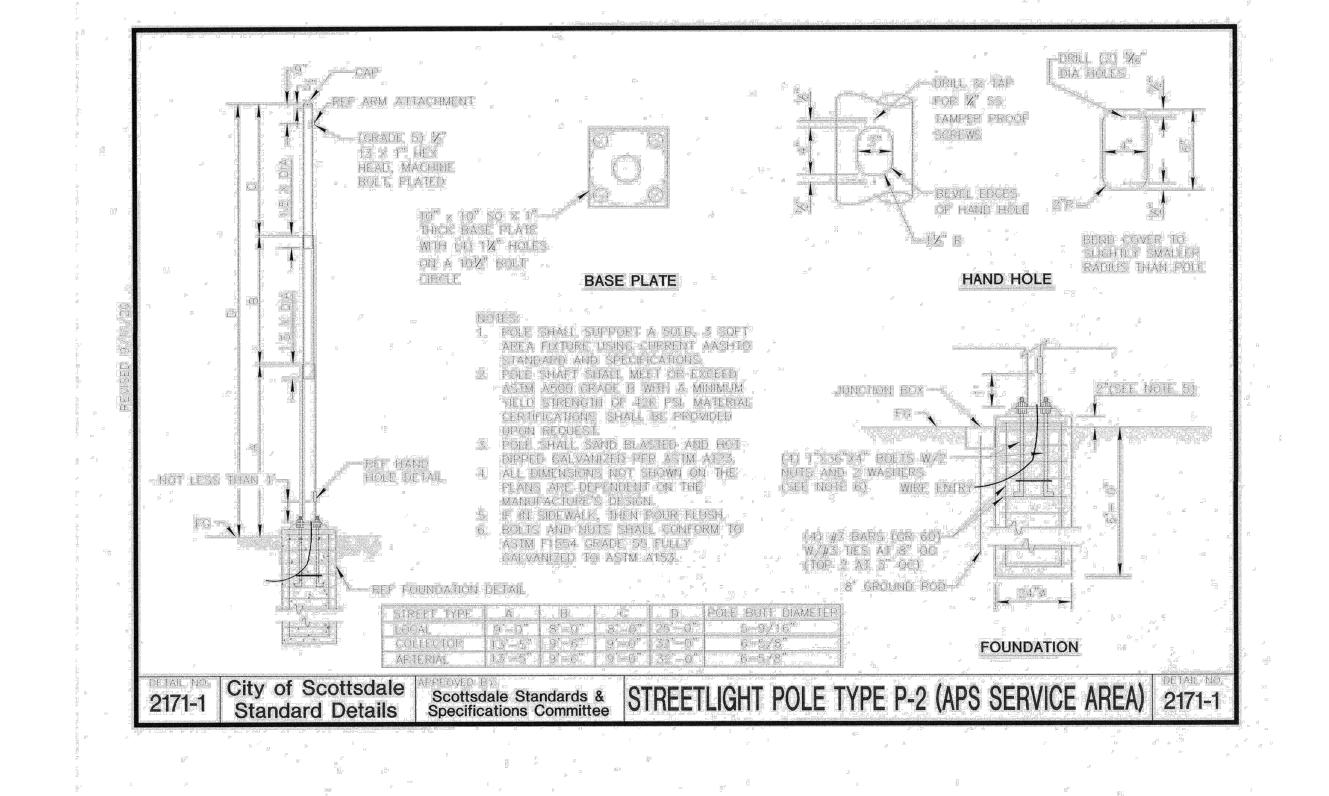

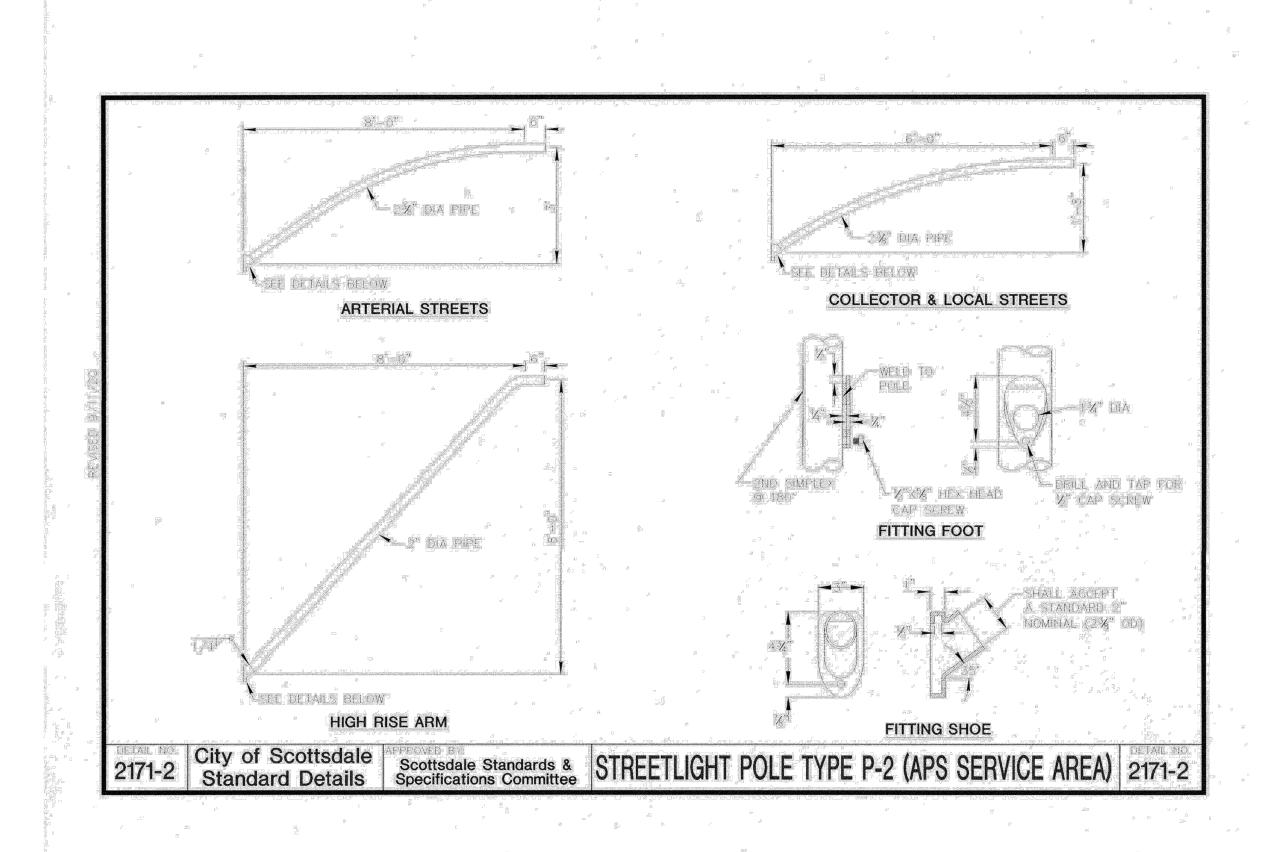


CITY OF SCOTTSDALE STREET LIGHT POLE DETAILS "2171-1" AND "2171-2" SCALE: 3/8"=1'-0"


NOT USED 22 NOT USED SCALE: 3/8"=1'-0" NOT USED 9CALE: 3/8"=1'-0"

Date: 4/15/24

Project Number 2021.004 Drawing No:

SP2.

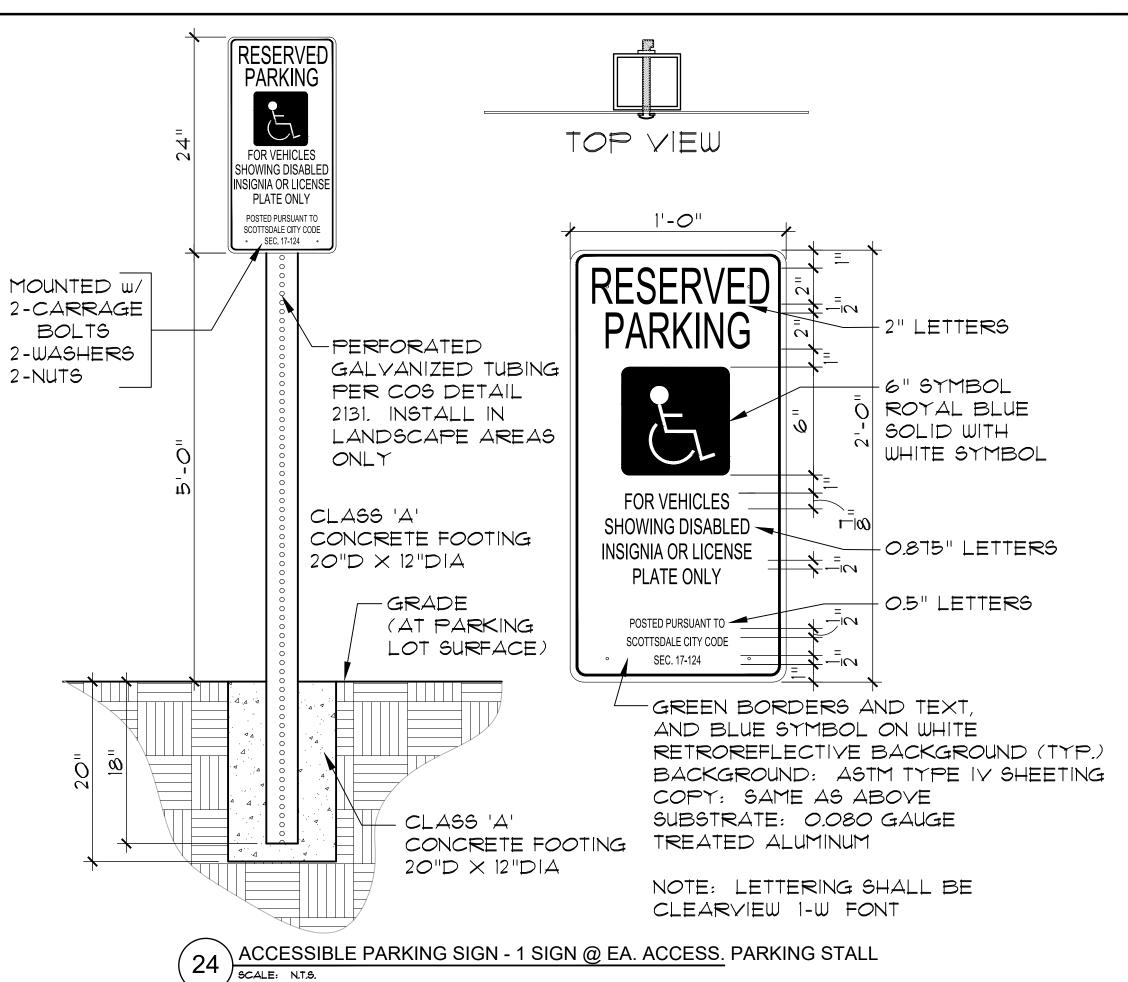

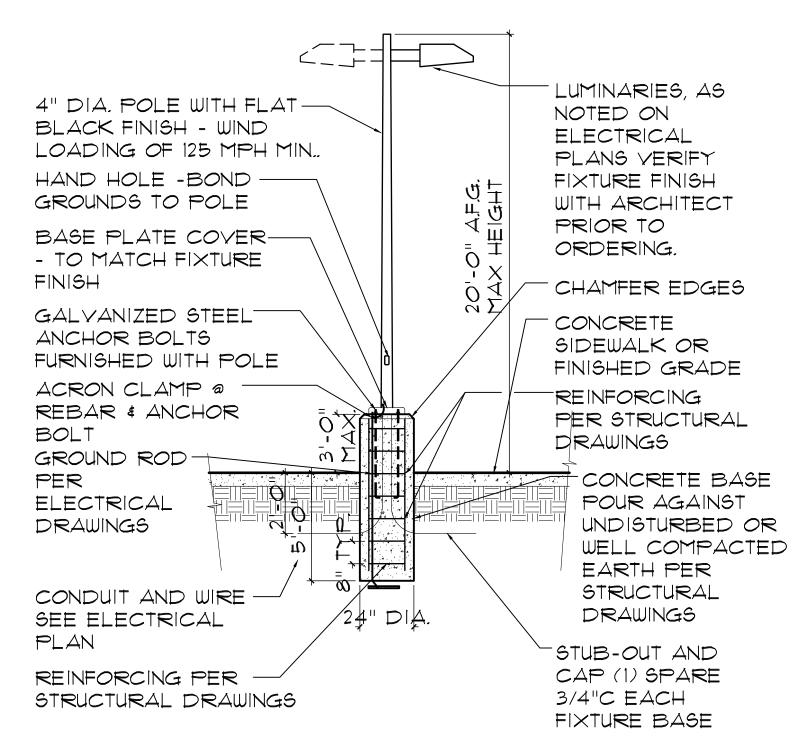

NOTE: PROVIDE REINFORCING AND FOOTING DEPTH PER THE STRUCTURAL DRAWINGS

NOTE: E.P.A. RATING AND SOIL CONDITIONS SHALL BE COORDINATED WITH POLE AND FIXTURE ASSEMBLY

NOTE: BONDING CONDUCTOR PER ELECTRICAL DRAWINGS

NOTE: SEE STRUCTURAL DRAWINGS FOR CALCS. AND DETAILS

NOTE: POLE FINISH TO BE "FLAT BLACK"

\ SITE LIGHT POLE (FOR REFERENCE ONLY) SCALE:

SEE ELECTRICAL AND STRUCTURAL DRAWINGS ALSO

ACCESSIBILITY 2. EXTERIOR EXITS WHICH ARE LOCATED ADJACENT TO ACCESSIBLE AREAS & WITHIN 6' OF ADJACENT GROUND LEVEL SHALL BE ACCESSIBLE.

ACCESSIBLE ENTRANCES TO THE BLDG, SHALL BE

IDENTIFIED BY THE INTERNATIONAL SYMBOL OF

ACCESSIBLE NOTES

3. ACCESSIBLE RAMPS REQ. BY ANSI A117.1 SHALL NOT HAVE SLOPES WHICH EXCEED 1 FT. IN 12 FEET

4. THE SURFACE OR RAMPS & GROUND SURFACES SHALL BE ROUGHENED OR SHALL BE OF SLIP RESISTANT MATERIALS.

5. AN ACCESSIBLE ROUTE SHALL OF TRAVEL 3FT WIDE MIN. MUST BE PROVIDED TO ALL PORTIONS OF THE BLDG. BETWEEN THE BLDG. & THE PUBLIC WAY. ACCESSIBLE ROUTE SHALL HAVE A MAXIMUM SLOPE OF 1:20 AND A MAXIMUM CROSS SLOPE OF 1:50

6. THRESHOLD MUST BE 1/2" IN HEIGHT OR LESS

THE PRIMARY ENTRANCE TO THE BLDG. MUST BE ACCESSIBLE ALL OTHER REQUIRED ENTRANCES TO THE BLDG. MUST BE ACCESSIBLE

8. ALL ACCESSIBLE PARKING SPACES SHALL HAVE A SLOPE NOT EXCEEDING 1:50

9. ALL ACCESSIBLE PARKING SPACES SHALL BE OUTLINED ON ALL FOUR SIDES, HAVE A CONTRASTING COLOR AND THE INTERNATIONAL WHEELCHAIR SYMBOL ON THE GROUND WITHIN THE SPACE.

10. ALL ACCESSIBLE PARKING SPACES SHALL HAVE A SIGN (MINIMUM 5 FT. ABOVE FIN. GRADE IN FRONT OF THE SPACE) WHICH INCLUDES THE INTERNATIONAL SYMBOL OF ACCESSIBILITY


. SIGNS DESIGNATING PERMANENT ROOMS AND SPACES SHALL MEET ACCESSIBILITY REQUIREMENTS

12. ALL ELECTRICAL RECEPTACLES AND CONTROLS SHALL BE 18" MINIMUM & 48" MAXIMUM ABOVE FINISH FLOOR

13. ALL ALARMS SHALL BE AUDIBLE & VISUAL AND MEET ACCESSIBILITY REQUIREMENTS.

14. ACCESSIBLE ROUTE SHALL BE WITHOUT STEPS OR CHANGES IN LEVELS GREATER THAN 1/2" WITHOUT AN APPROVED RAMP.

ACCESSIBLE ROUTES SHALL SERVE AS EXITS OR CONNECT TO AREAS OF RESCUE ASSISTANCE

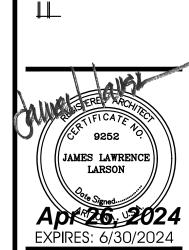

EXPIRES: 6/30/2024

Drawing Name:

SITE DETAILS

SITE DETAILS

Revisions
1-12-24 PRE-APP
4-15-24 AIRPORT
APPROVAL DOCS.

NOTE:

PT-4

PAINT RACKS


Date: 4/15/24

Project Number:

Drawing No:

SP2.8

2021.004

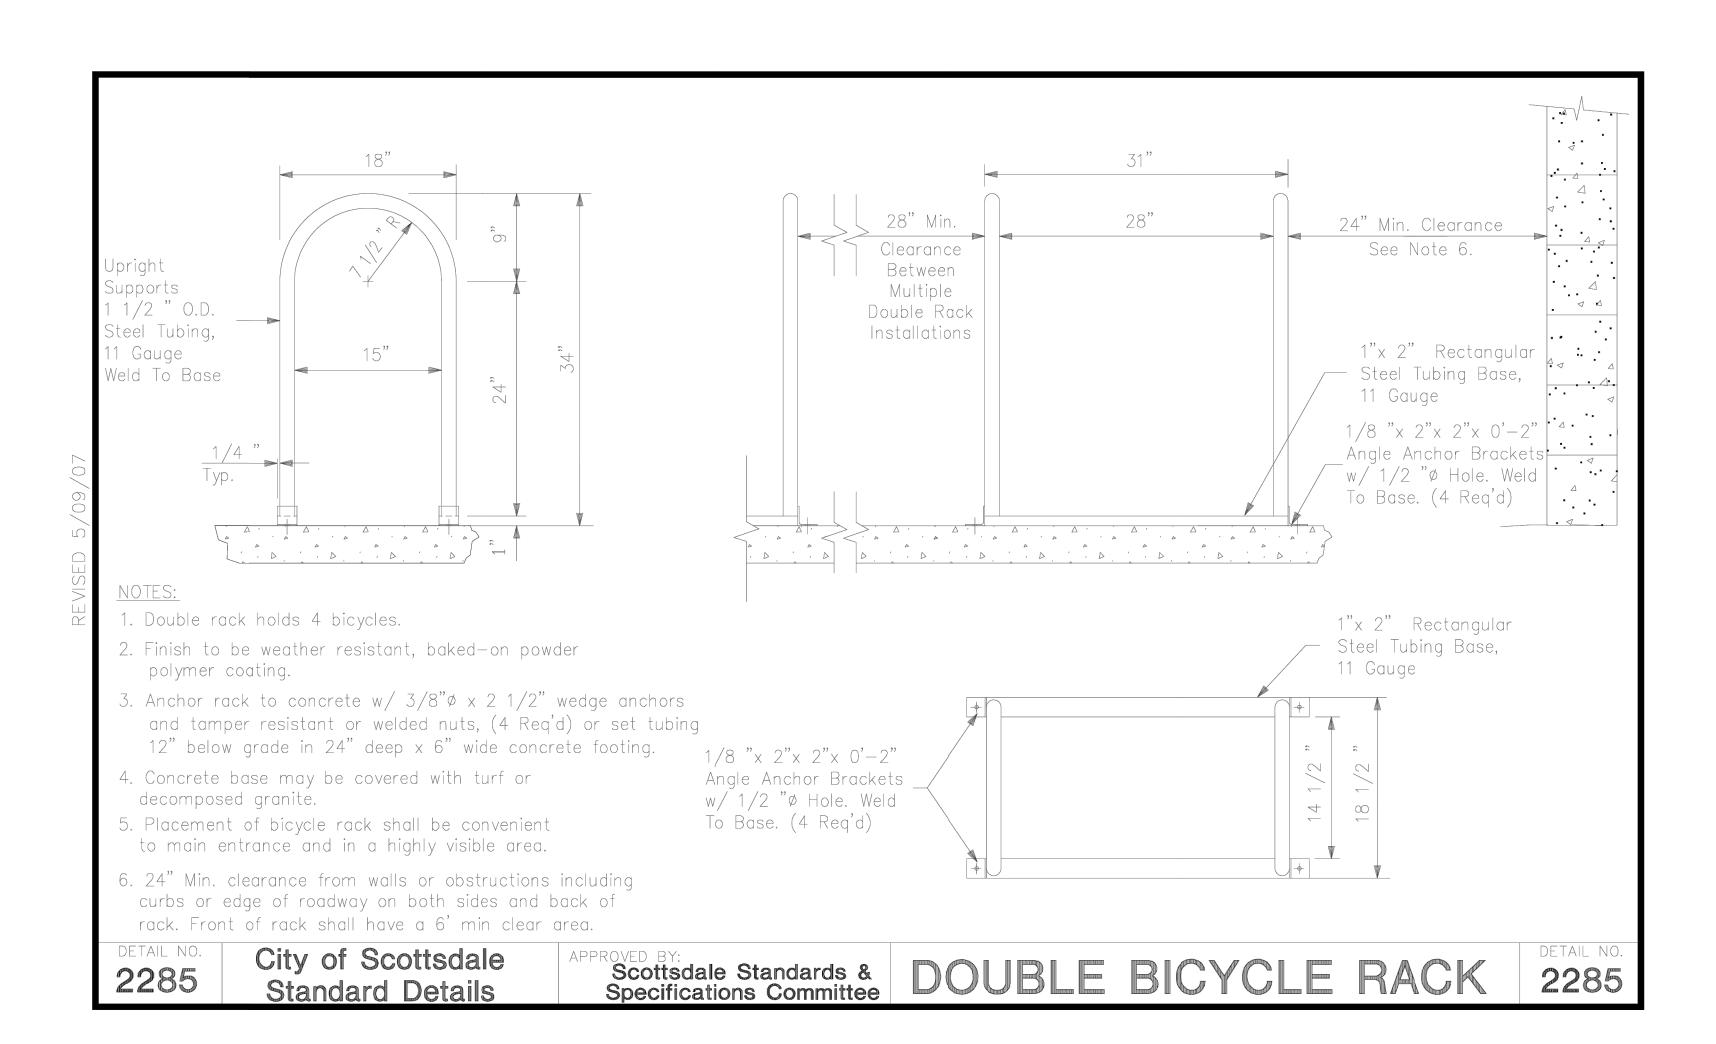

₹ °°

SP2.9

GENERAL CONSIDERATIONS & REQUIREMENTS

Section 2-1

2-1.800 ON-SITE CIRCULATION & PARKING AREA DESIGN

The following guidelines focus on general and specific techniques to assure safe access, emergency access, and community benefits.

2-1.801

MAJOR DRIVEWAYS

Major driveways provide direct access from the street and into a parking lot with more than fifty (50) spaces, and/or provide the driveway access across the front of a retail center. Such driveways should:

- 1. Be a minimum width of thirty (30) feet from face-of-curb to face-of-curb;
- 2. Prohibit designated customer loading areas that are utilized for landscaping, construction materials, and major appliances, etc., departments of retail stores, as well as loading areas used for general business activity;
- 3. Provide adequate vehicle stacking distances where they access public streets, and do not allow direct parking aisle access in close proximity to the street intersection;
- 4. Provide adequate site area that will allow fire equipment vehicles to turn-around. Refer to Section 2-1.802;
- 5. Be located in coordination with adjacent bus stop locations, when appropriate (see Section 5-6.000) and have level landing, that is a minimum of four (4) feet wide, immediately behind the driveway, in order to allow for pedestrian mobility.

2-1.802

EMERGENCY ACCESS AND FIRE LANES

For specific Fire Department requirements, including a Fire Plan Review checklist, see www.ScottsdaleAZ.gov/bldgresources/forms. After reviewing the plan for the proposed development, the Fire Department will determine the code required fire apparatus access. See the International Fire Code Chapter 5 and Appendix D for guidance. For complete Fire Code related issues, see <a href="https://www.chapter.gov/chap

A. Emergency Access Provisions

Fire apparatus access may be provided from public access ways, approved private streets, residential driveways and/or on-site fire lanes. For additional requirements for public access ways, private streets and residential driveways see Section 5-3.000.

B. Fire Lanes

On-site access (Fire Lanes) for fire fighting and emergency vehicle use may be required in addition to the planned public access ways so an emergency vehicle can reach the interior of the development when normal access is blocked. For example, an additional access way may be required due to the number of structures, the square footage of structures, topography (grade), and/or washes and flood plains. See the International Fire Code Appendix D for guidance. Emergency access ways shall be secured by an easement. If any emergency access route is intended to be closed and locked, any lock placed on an emergency access gate must be approved by the Fire Department. See COS Standard Detail 2364 for construction and identification of emergency access ways. See Figure 2.1-4 for minimum requirements for gated entrances for residential development.

The following criteria for the lanes shall apply:

- 1. Fire lane signage must comply with COS Standard Details, Series 2300.
- 2. The minimum width of a two-way fire lane is 24 feet. One-way lanes, such as divided entrances and drive thru by-pass lanes shall be 20; wide. For project specific information, contact Fire Plan Review. 480-312-7080. See International Fire Code Sections 503.2.1 and 503.2.2 for other lane width requirements.

Page 8

Design Standards & Policies Manual

City of Scottsdale - January 2010

Section 2-1

Page 9

Apr 26, 2024

Project Number 2021.004

Drawing No:

SP2.10

GENERAL CONSIDERATIONS & REQUIREMENTS

ON-SITE CIRCULATION & PARKING AREA 2-1.800 **DESIGN**

The following guidelines focus on general and specific techniques to assure safe access, emergency access, and community benefits.

MAJOR DRIVEWAYS 2-1.801

Section 2-1

Major driveways provide direct access from the street and into a parking lot with more than fifty (50) spaces, and/or provide the driveway access across the front of a retail center. Such driveways should:

- 1. Be a minimum width of thirty (30) feet from face-of-curb to face-of-curb;
- 2. Prohibit designated customer loading areas that are utilized for landscaping, construction materials, and major appliances, etc., departments of retail stores, as well as loading areas used for general business activity;
- 3. Provide adequate vehicle stacking distances where they access public streets, and do not allow direct parking aisle access in close proximity to the street intersection;
- 4. Provide adequate site area that will allow fire equipment vehicles to turn-around. Refer to Section 2-1.802;
- 5. Be located in coordination with adjacent bus stop locations, when appropriate (see Section 5-6.000) and have level landing, that is a minimum of four (4) feet wide, immediately behind the driveway, in order to allow for pedestrian mobility.

EMERGENCY ACCESS AND FIRE LANES 2-1.802

For specific Fire Department requirements, including a Fire Plan Review checklist, see www.ScottsdaleAZ.gov/bldgresources/forms. After reviewing the plan for the proposed development, the Fire Department will determine the code required fire apparatus access. See the International Fire Code Chapter 5 and Appendix D for guidance. For complete Fire Code related issues, see Chapter 11.

A. Emergency Access Provisions

Fire apparatus access may be provided from public access ways, approved private streets, residential driveways and/or on-site fire lanes. For additional requirements for public access ways, private streets and residential driveways see Section 5-3.000.

B. Fire Lanes

On-site access (Fire Lanes) for fire fighting and emergency vehicle use may be required in addition to the planned public access ways so an emergency vehicle can reach the interior of the development when normal access is blocked. For example, an additional access way may be required due to the number of structures, the square footage of structures, topography (grade), and/or washes and flood plains. See the International Fire Code Appendix D for guidance. Emergency access ways shall be secured by an easement. If any emergency access route is intended to be closed and locked, any lock placed on an emergency access gate must be approved by the Fire Department. See COS Standard Detail 2364 for construction and identification of emergency access ways. See Figure 2.1-4 for minimum requirements for gated entrances for residential development.

The following criteria for the lanes shall apply:

- 1. Fire lane signage must comply with COS Standard Details, Series 2300.
- 2. The minimum width of a two-way fire lane is 24 feet. One-way lanes, such as divided entrances and drive thru by-pass lanes shall be 20; wide. For project specific information, contact Fire Plan Review. 480-312-7080. See International Fire Code Sections 503.2.1 and 503.2.2 for other lane width requirements.

GENERAL CONSIDERATIONS & REQUIREMENTS

- 3. The fire lane surface shall be suitable for all-weather use, with a minimum loading design of 83,000 lb. gross vehicle weight. Where not co-located with vehicular service or access lanes, surfaces other than asphalt such as concrete, paver stones, "grasscrete" and stabilized and compacted crushed granite should be considered.
- 4. The minimum vertical clearance for the passage of fire department apparatus is 13 feet 6 inches.
- 5. The minimum outside edge radius of the lane on a turn is 49 feet, with 55 feet outside radius required for aerial bucket clearance for commercial and multi-family uses. ASSHTO engineered elliptical radius design may be approved in certain circumstances where there are no barriers over 6 feet in height on the outer aerial bucket radius R3- for project specific information, contact Fire Plan Review 480-312-7080. 40.5 feet is the minimum for other residential uses. See Figure 2.1-1 below.

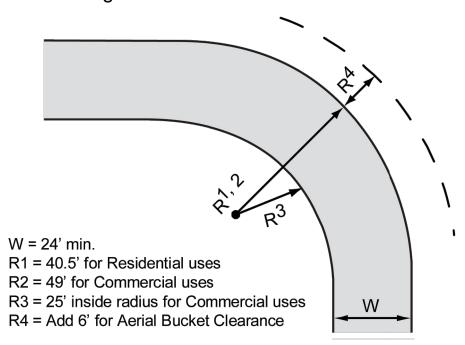


FIGURE 2.1-1 FIRE LANE DIMENSIONS

- 6. Fire lanes must be posted in accordance with the COS Standard Detail 2365
- 7. See Figure 2.1-2 for on-site fire access turnarounds for commercial and residential
- 8. Provide a turn-around for emergency vehicles at the end of a dead-end parking aisle designated for emergency access (fire lane) if it exceeds 300 feet in length for fire sprinklered structures, 150 feet in length for non-sprinklered structures, as shown by the T-Types in Figure 2.1-2.

Page 8

Design Standards & Policies Manual

City of Scottsdale - January 2010

Design Standards & Policies Manual

City of Scottsdale - January 2010

ON-SITE VEHICLE DRIVE REQUIREMENTS SCALE: N.T.S.

11-DR-2024



Revisions 1-12-24 PRE-APP


4-15-24 AIRPORT APPROVAL DOCS.


Date: 4/15/24

Project Number:




11-DR-2024 5/16/2024

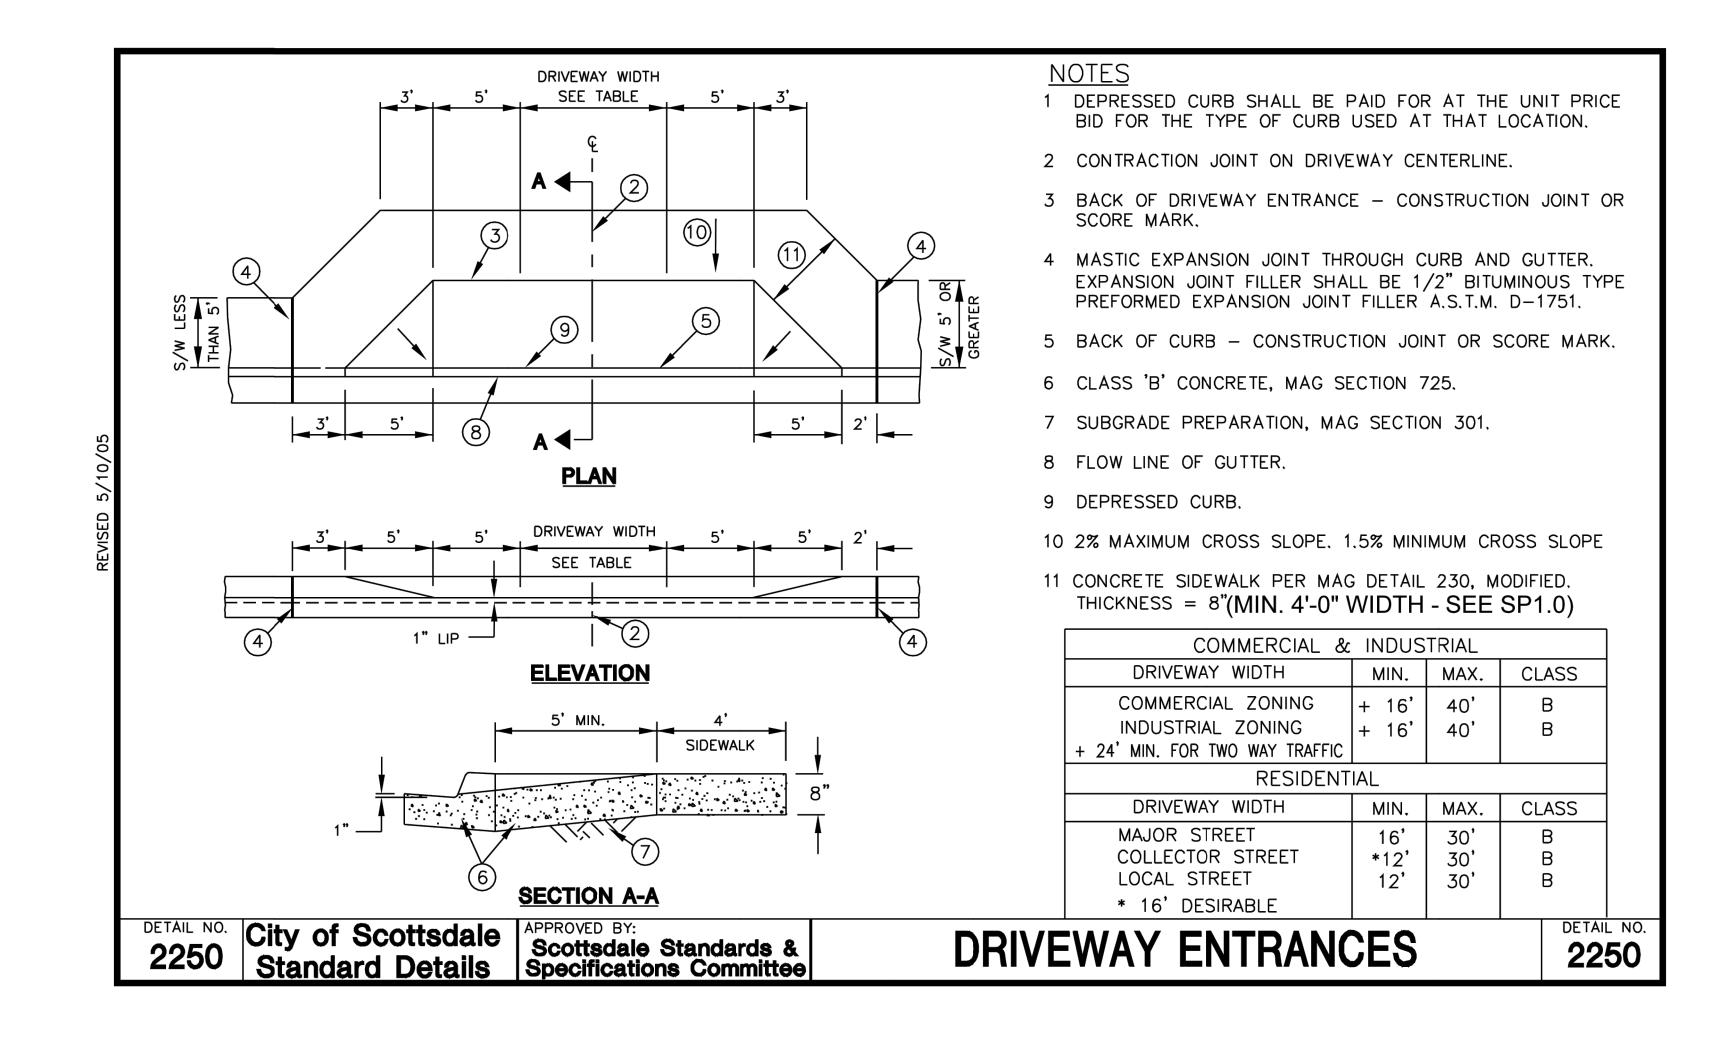

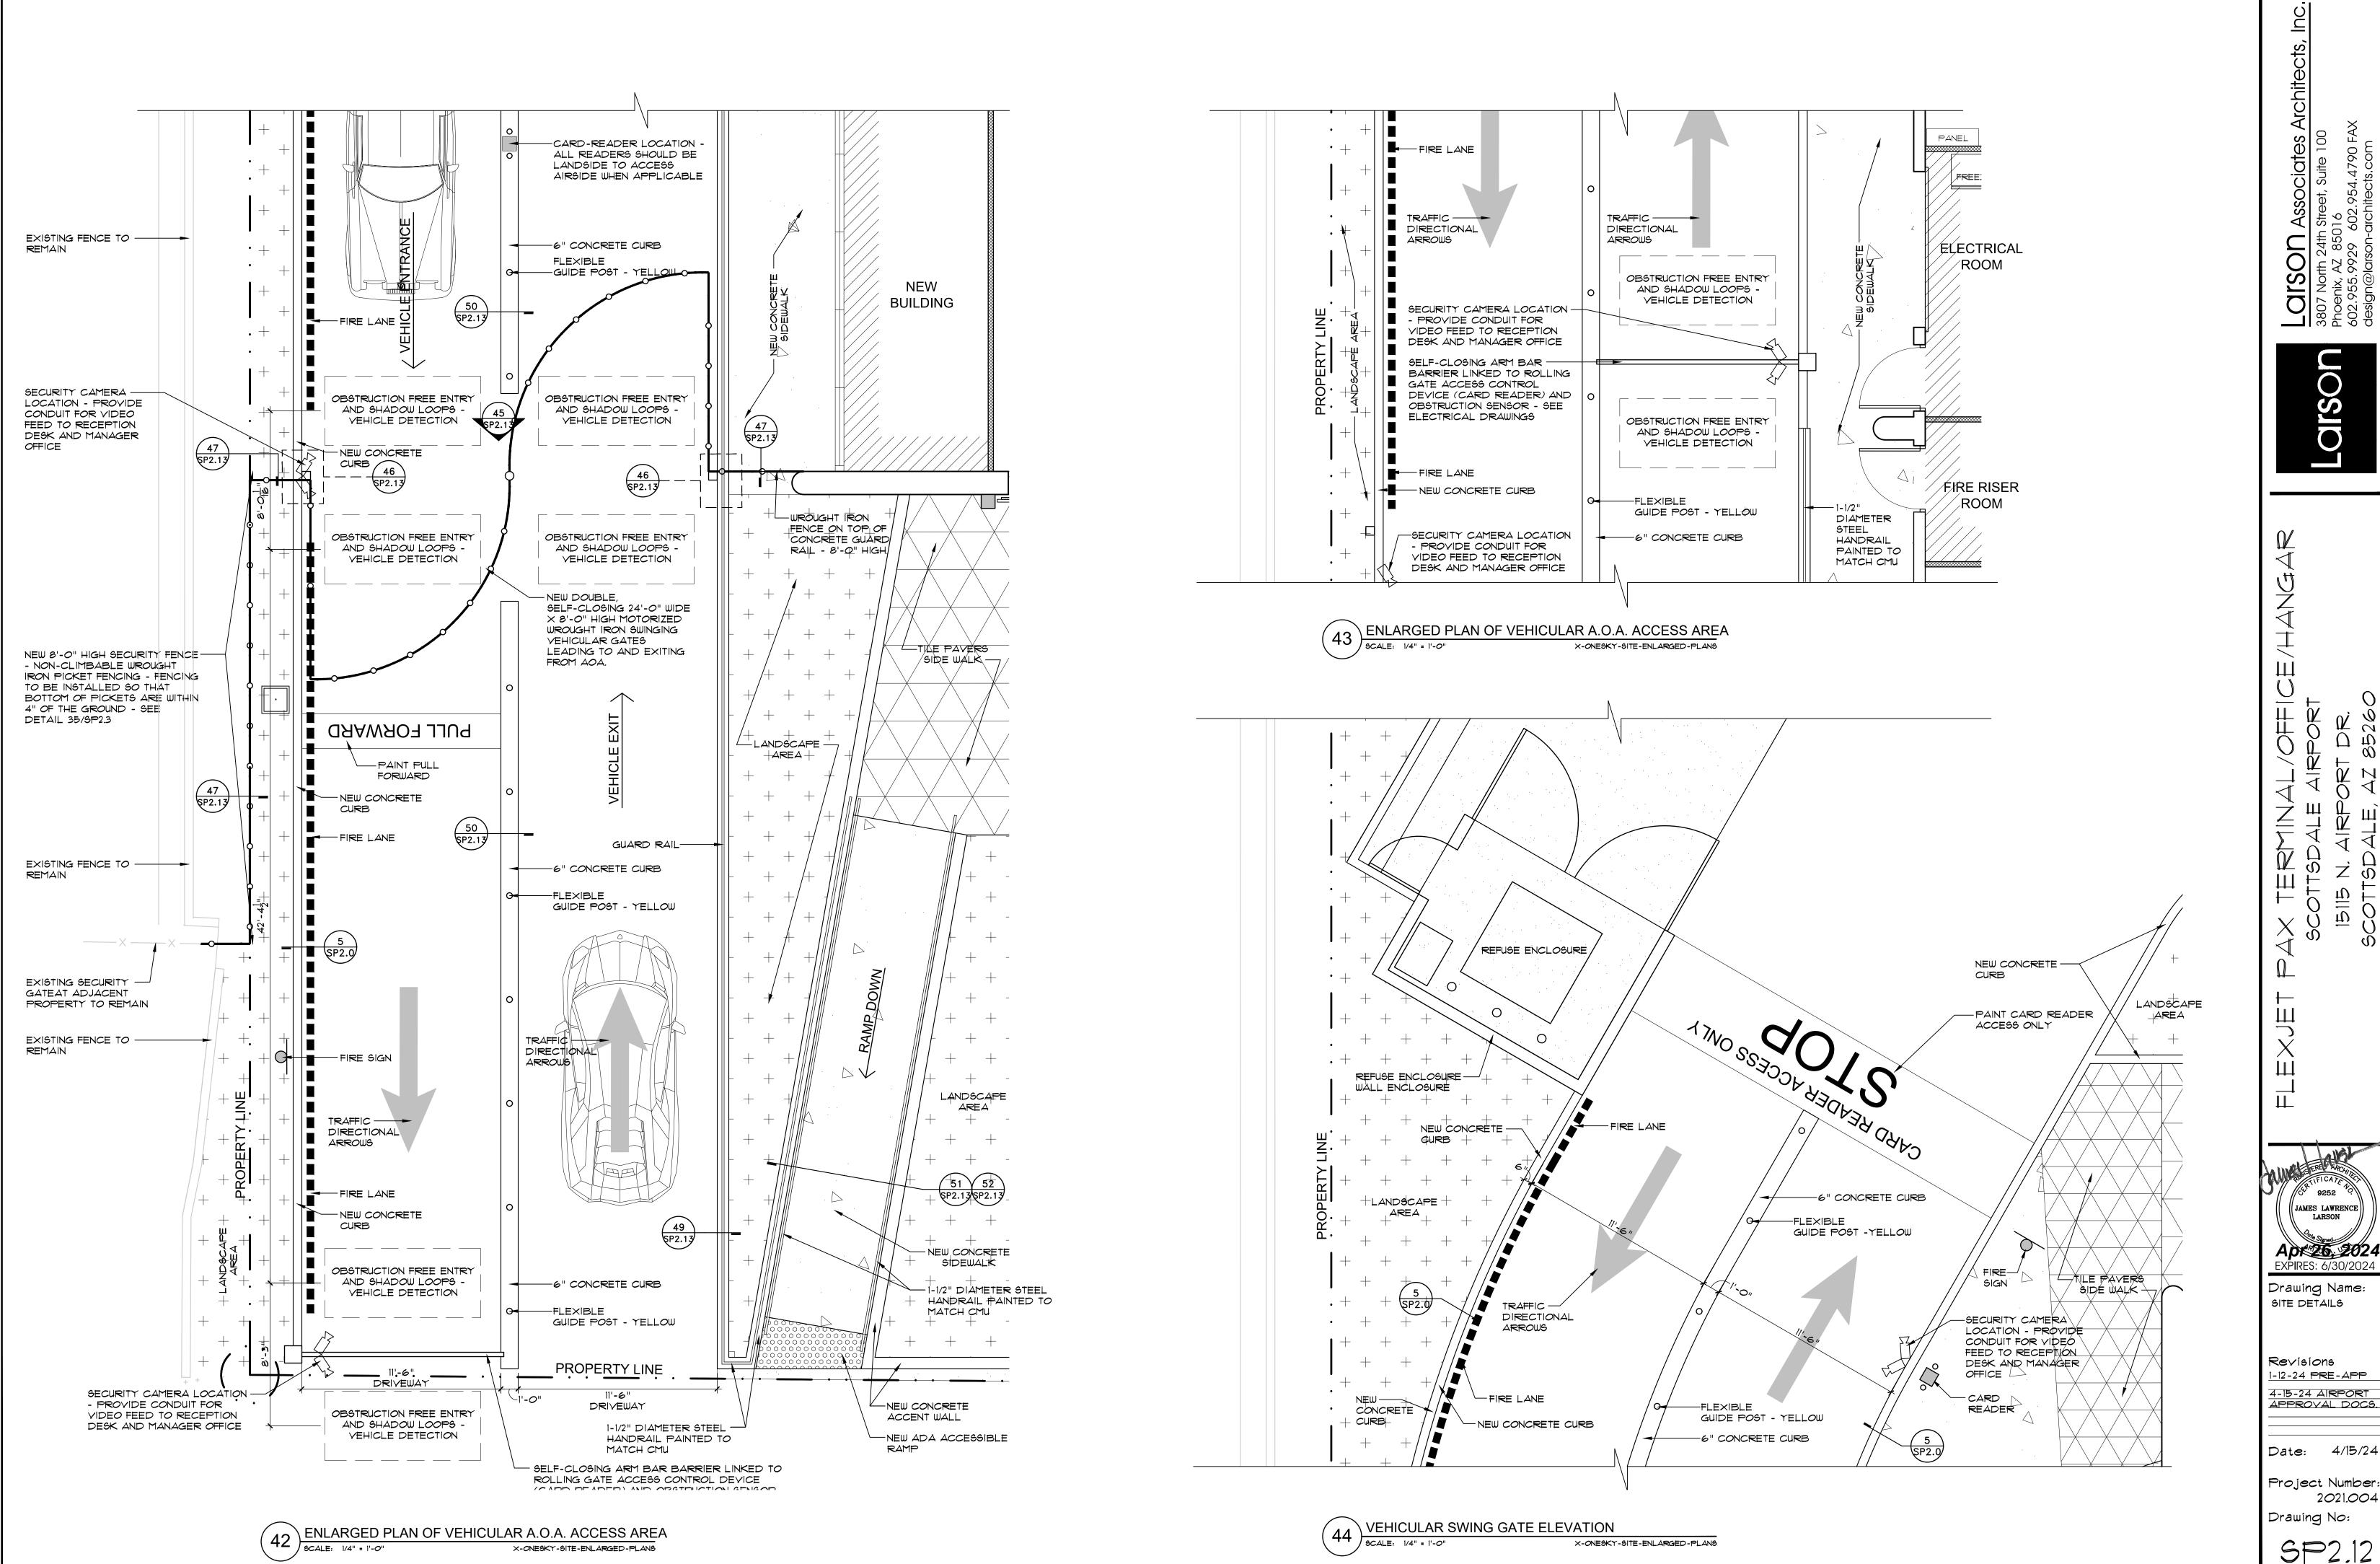

11-DR-2024 5/16/2024

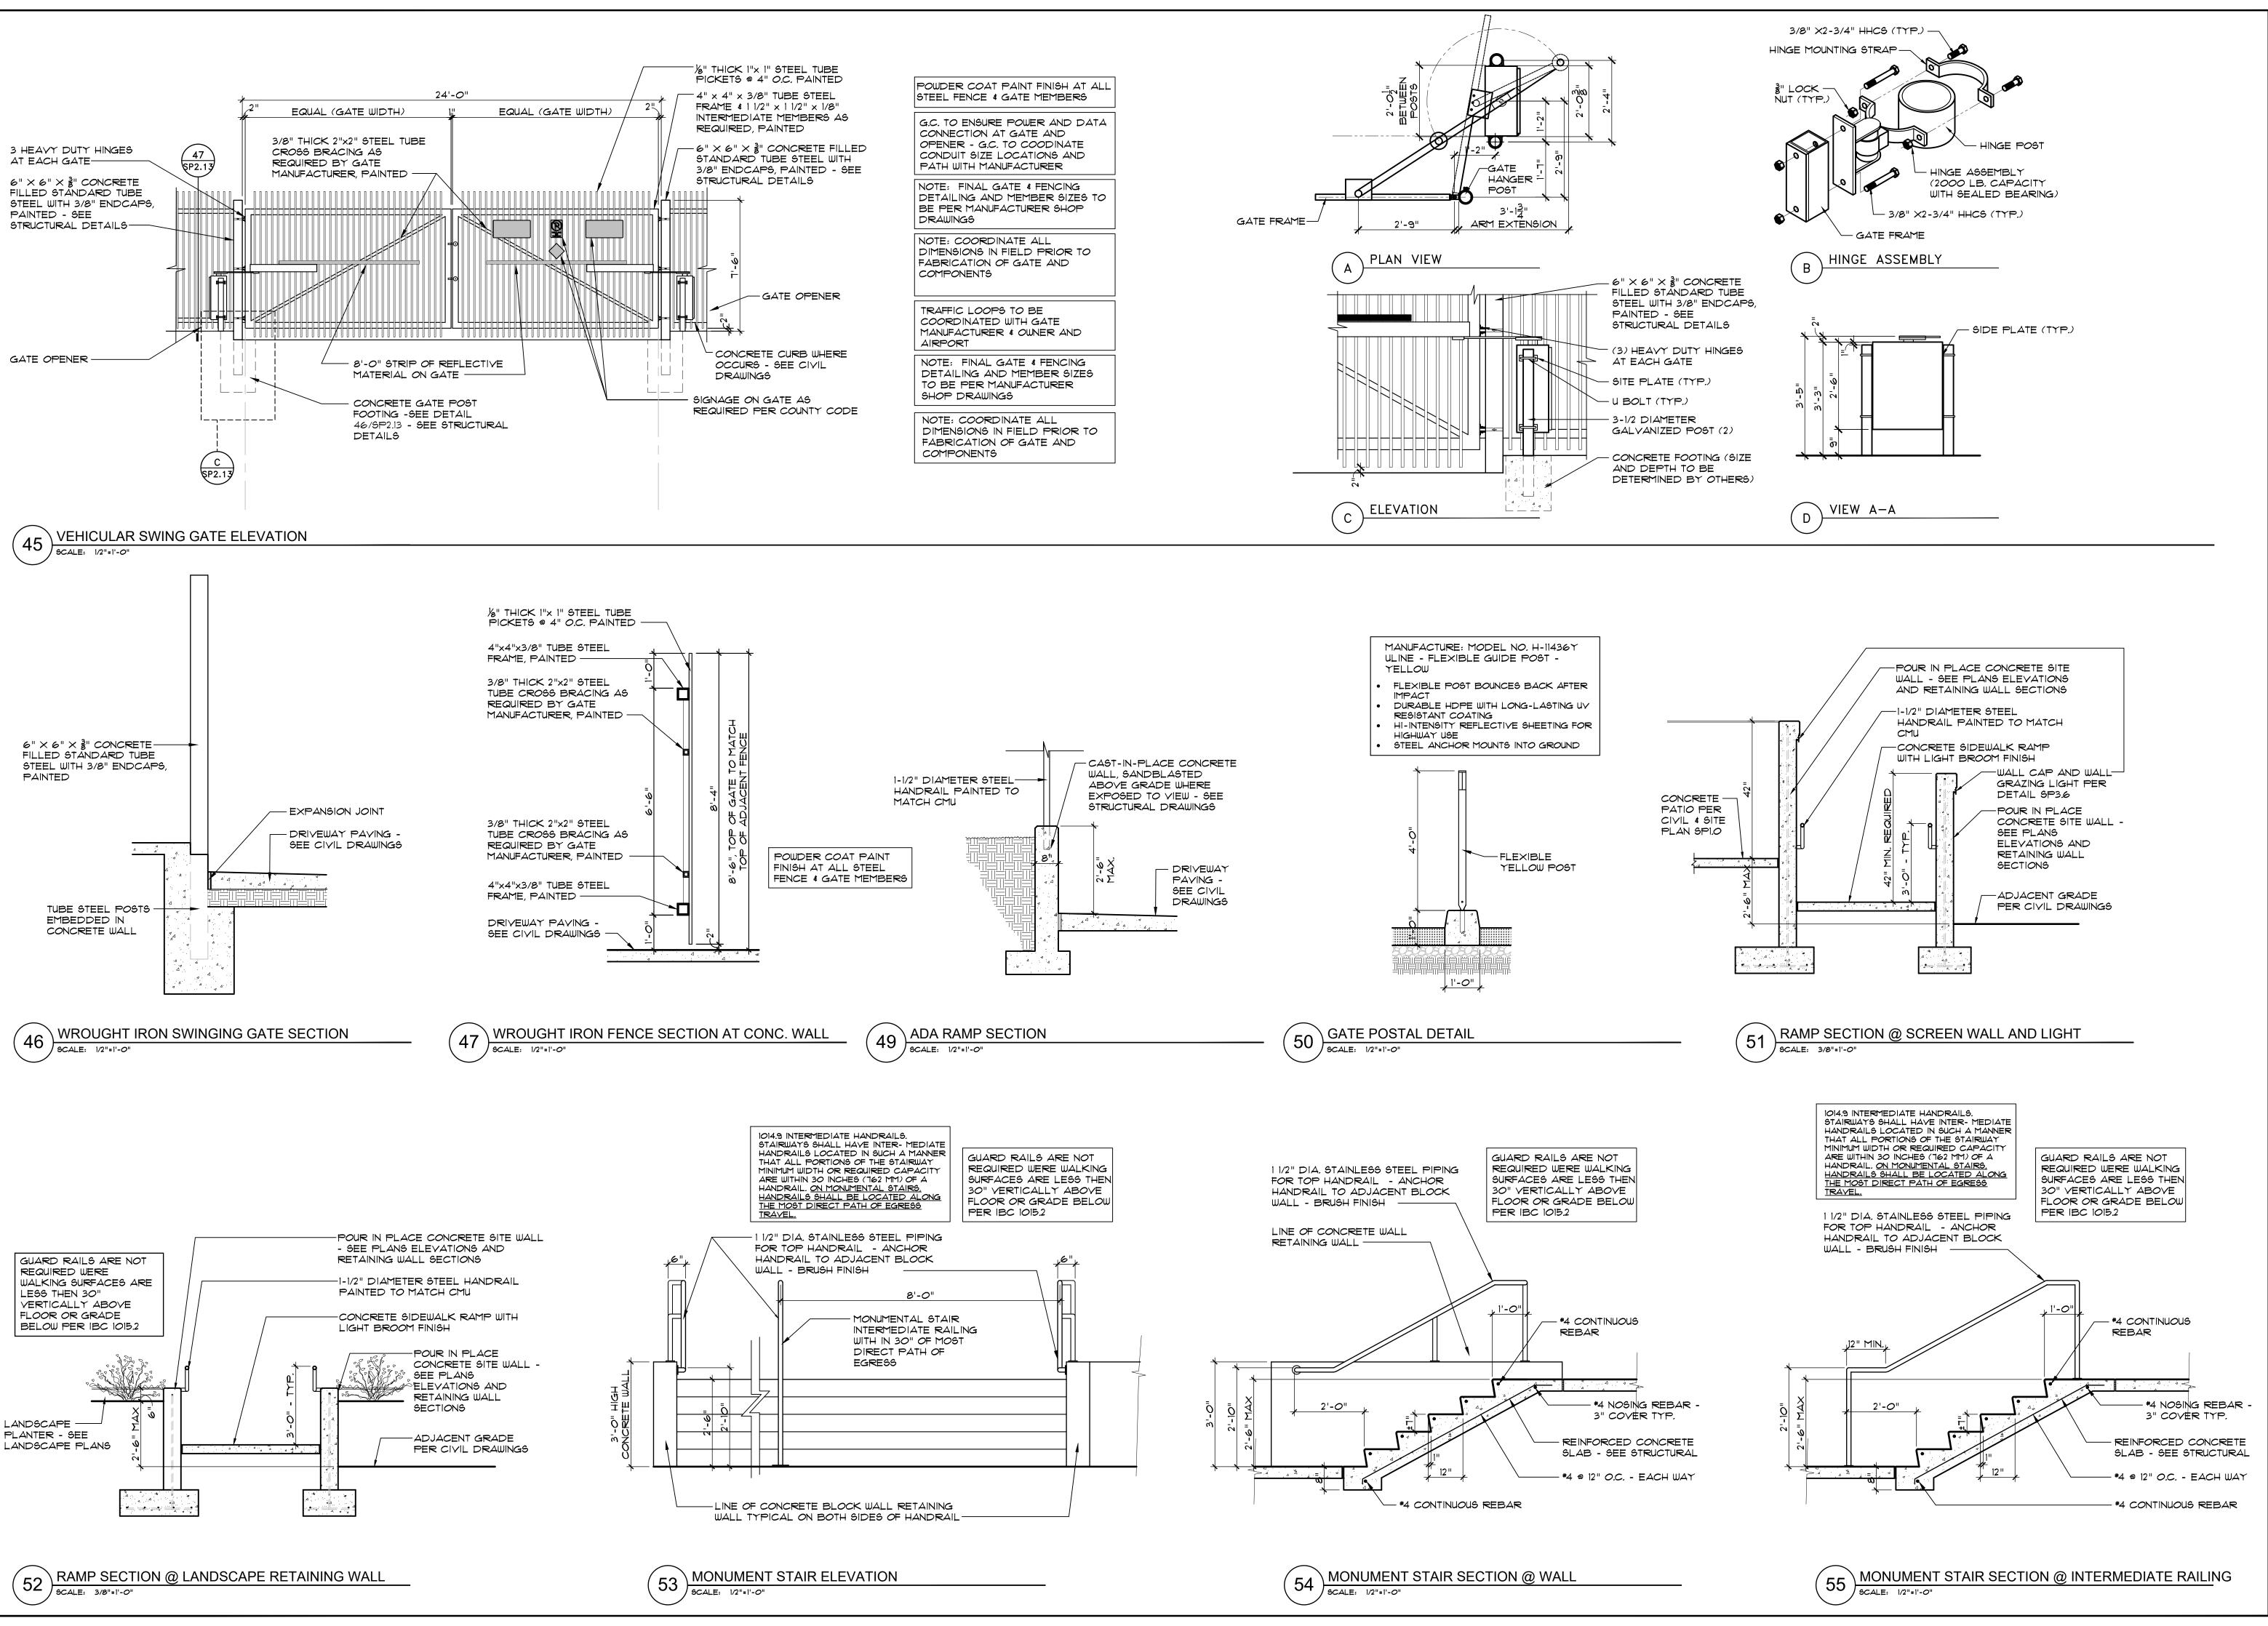

TERMINAL/OFFICE/HANGAR

OTTSDALE AIRPORT

OTSDALE AIRPORT

11-DR-2024 5/16/2024

9252

JAMES LAWRENCE

LARSON

Apr 26, 2024

EXPIRES: 6/30/2024

Drawing Name:

1-12-24 PRE-APP

4-15-24 AIRPORT

APPROVAL DOCS

Date: 4/15/24

Project Number

Drawing No:

2021.004

PLANS & ELEVATIONS

ENLARGED

Revisions

April 2024
EXPIRES: 6/30/2024
Drawing Name:
ENLARGED

ENLARGED PLANS & ELEVATIONS


Revisions 1-12-24 PRE-APP 4-15-24 AIRPORT


4-15-24 AIRPORT APPROVAL DOCS.

Date: 4/15/24
Project Number: 2021.004

Drawing No:


SP2.14

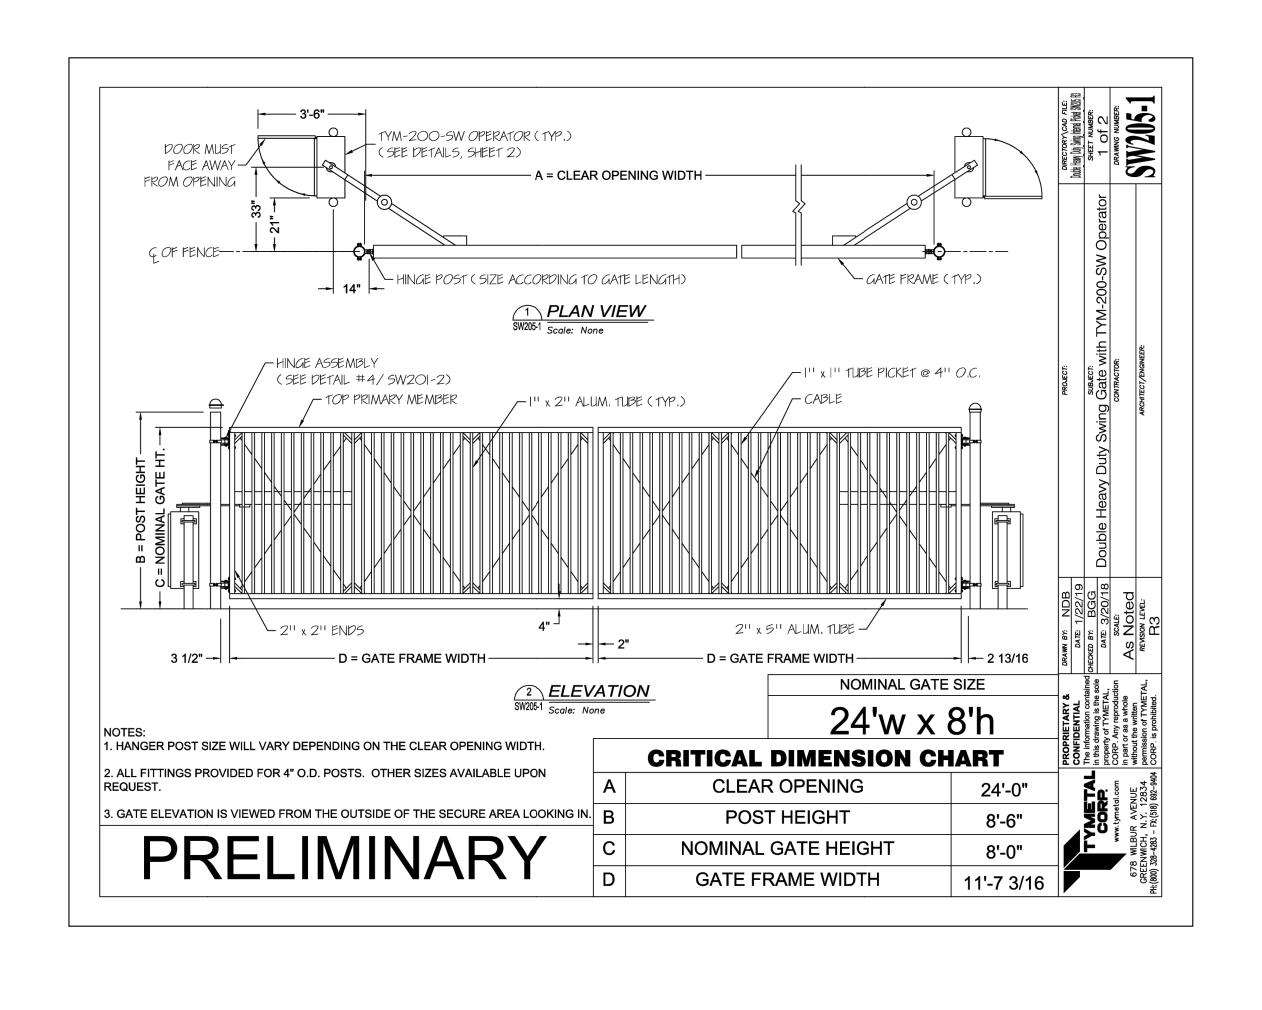

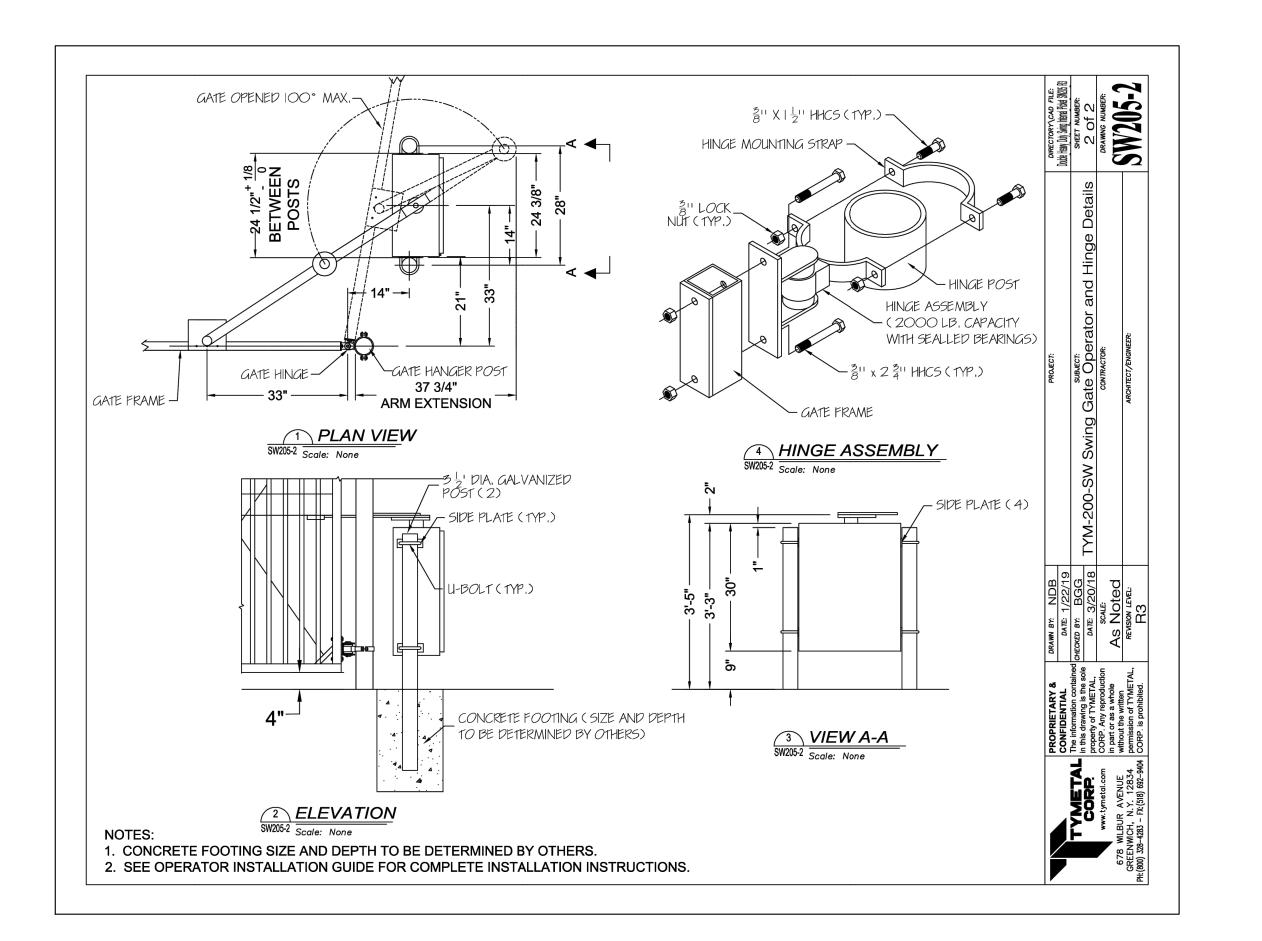


TYP. MANUFACTURE DWG FOR SWING GATE

SCALE: 1/2"=1'-O"

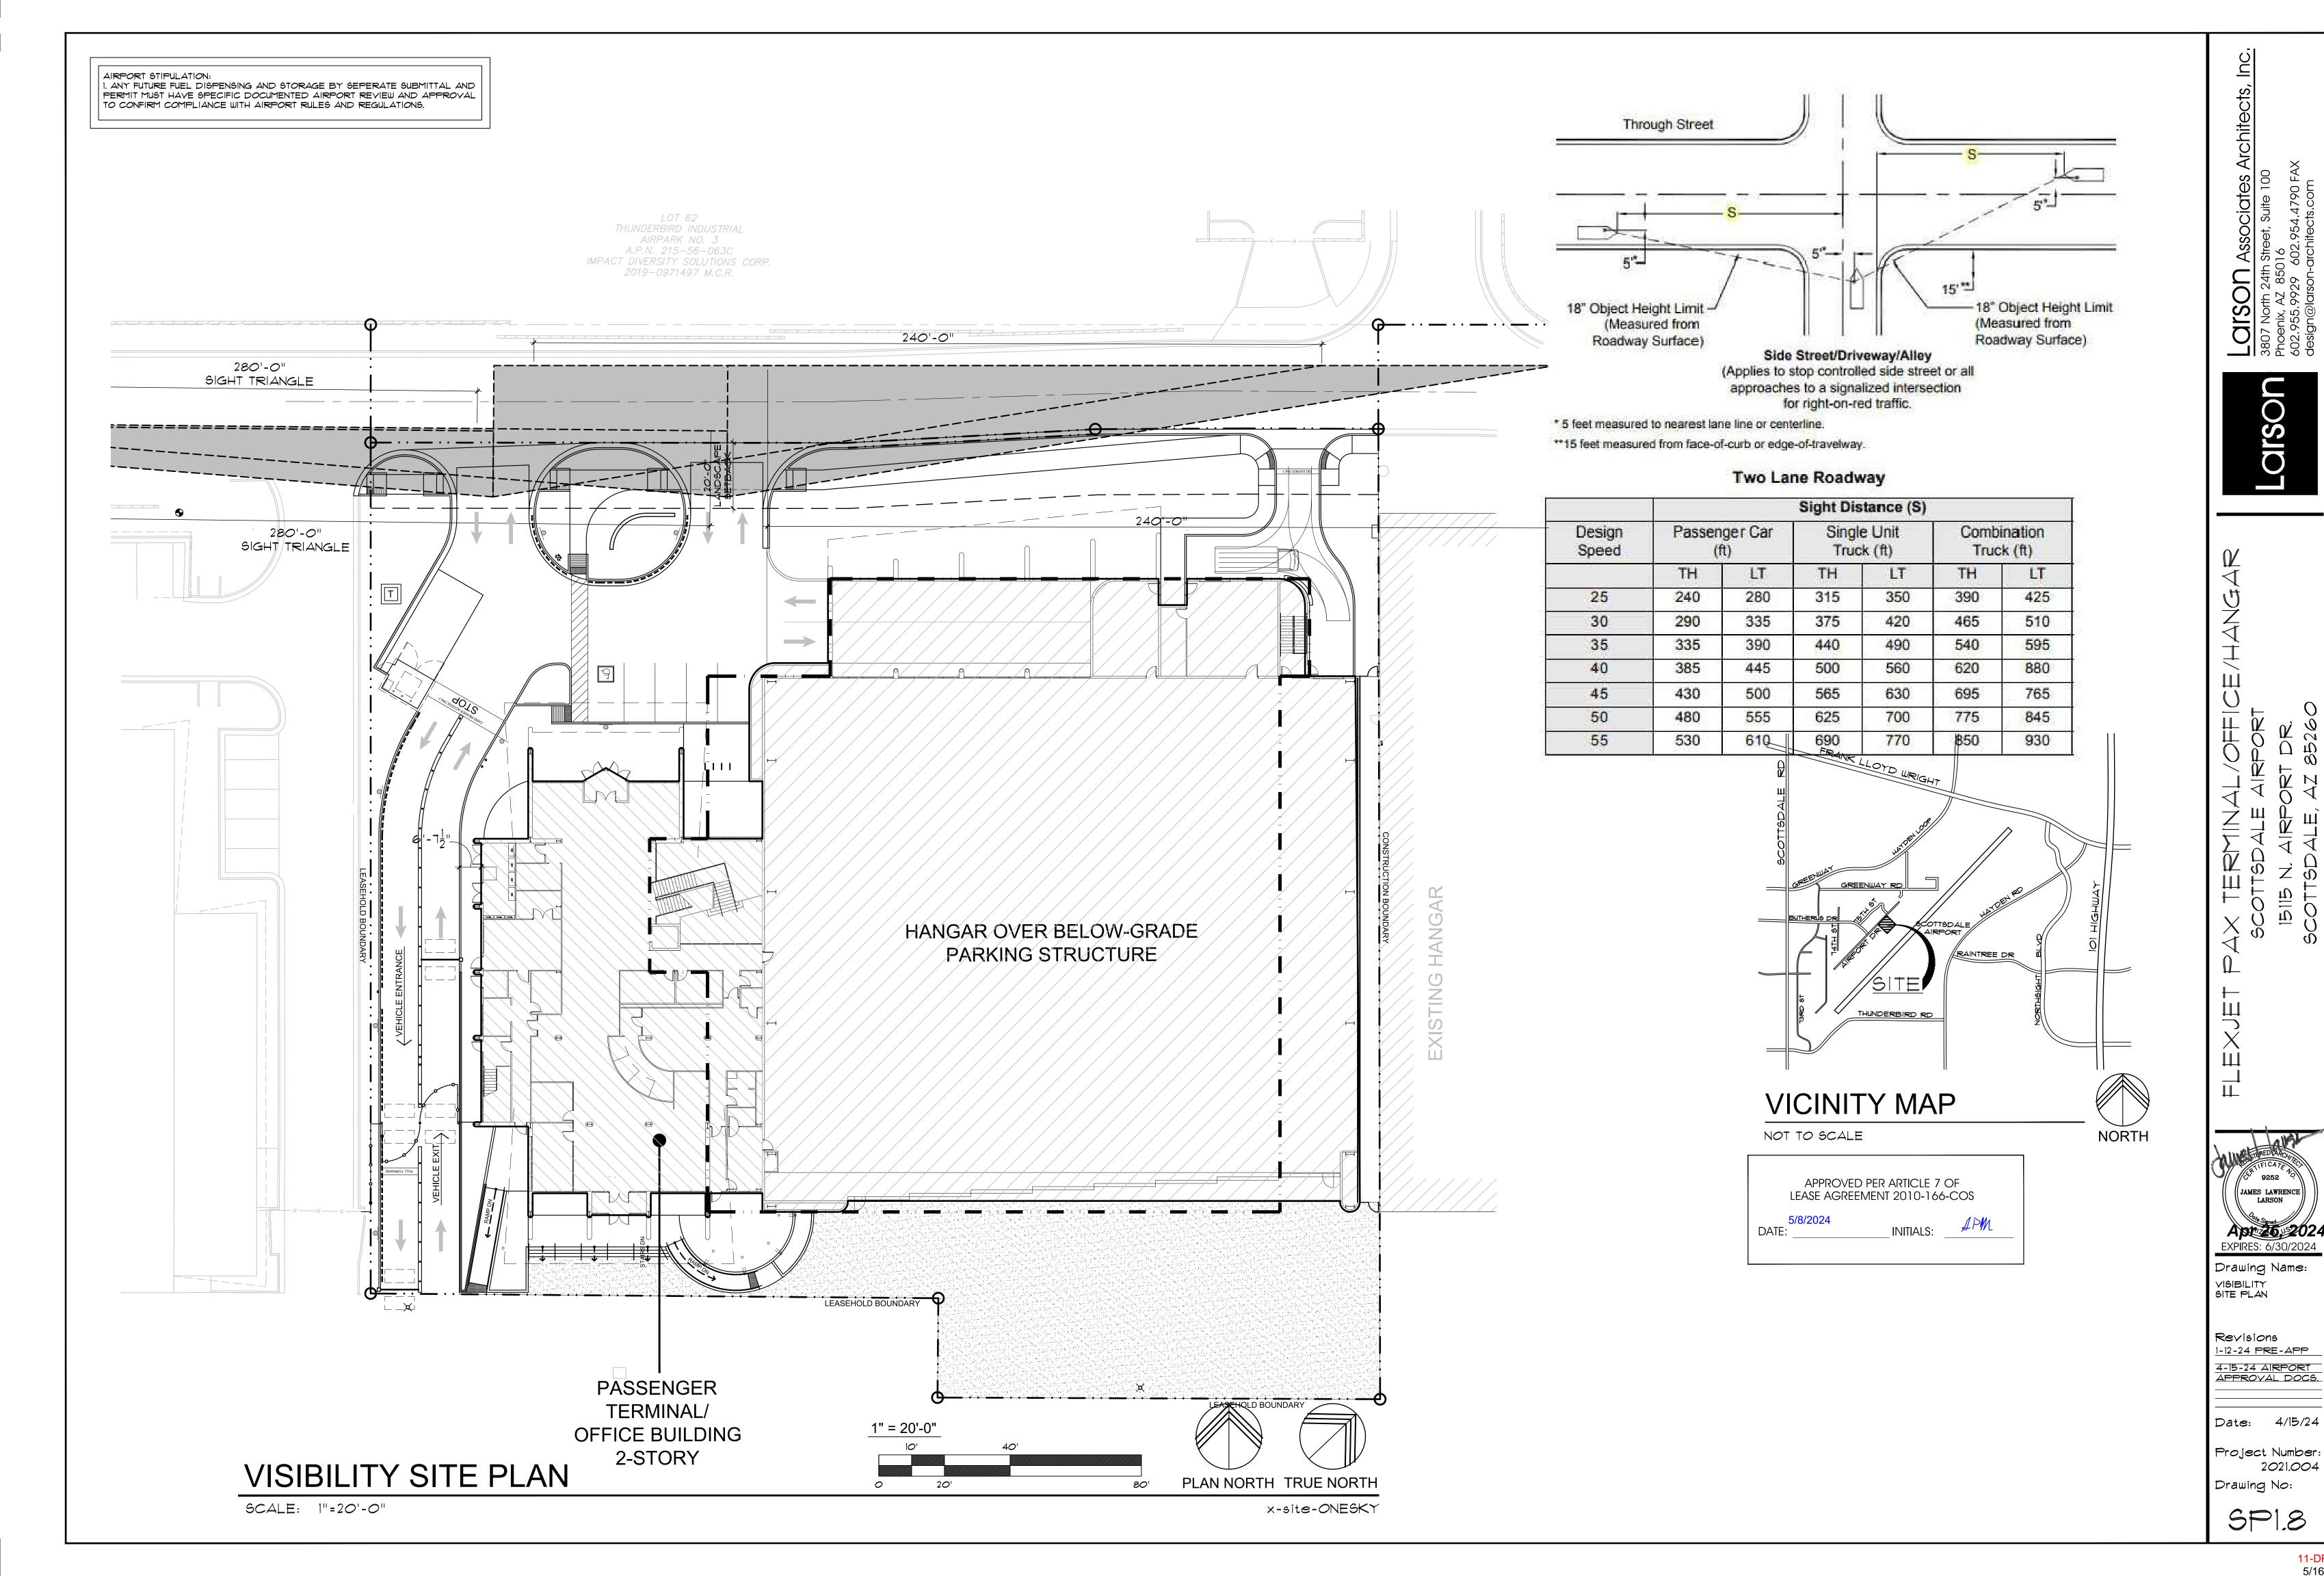

-----11-DR-2024 5/16/2024

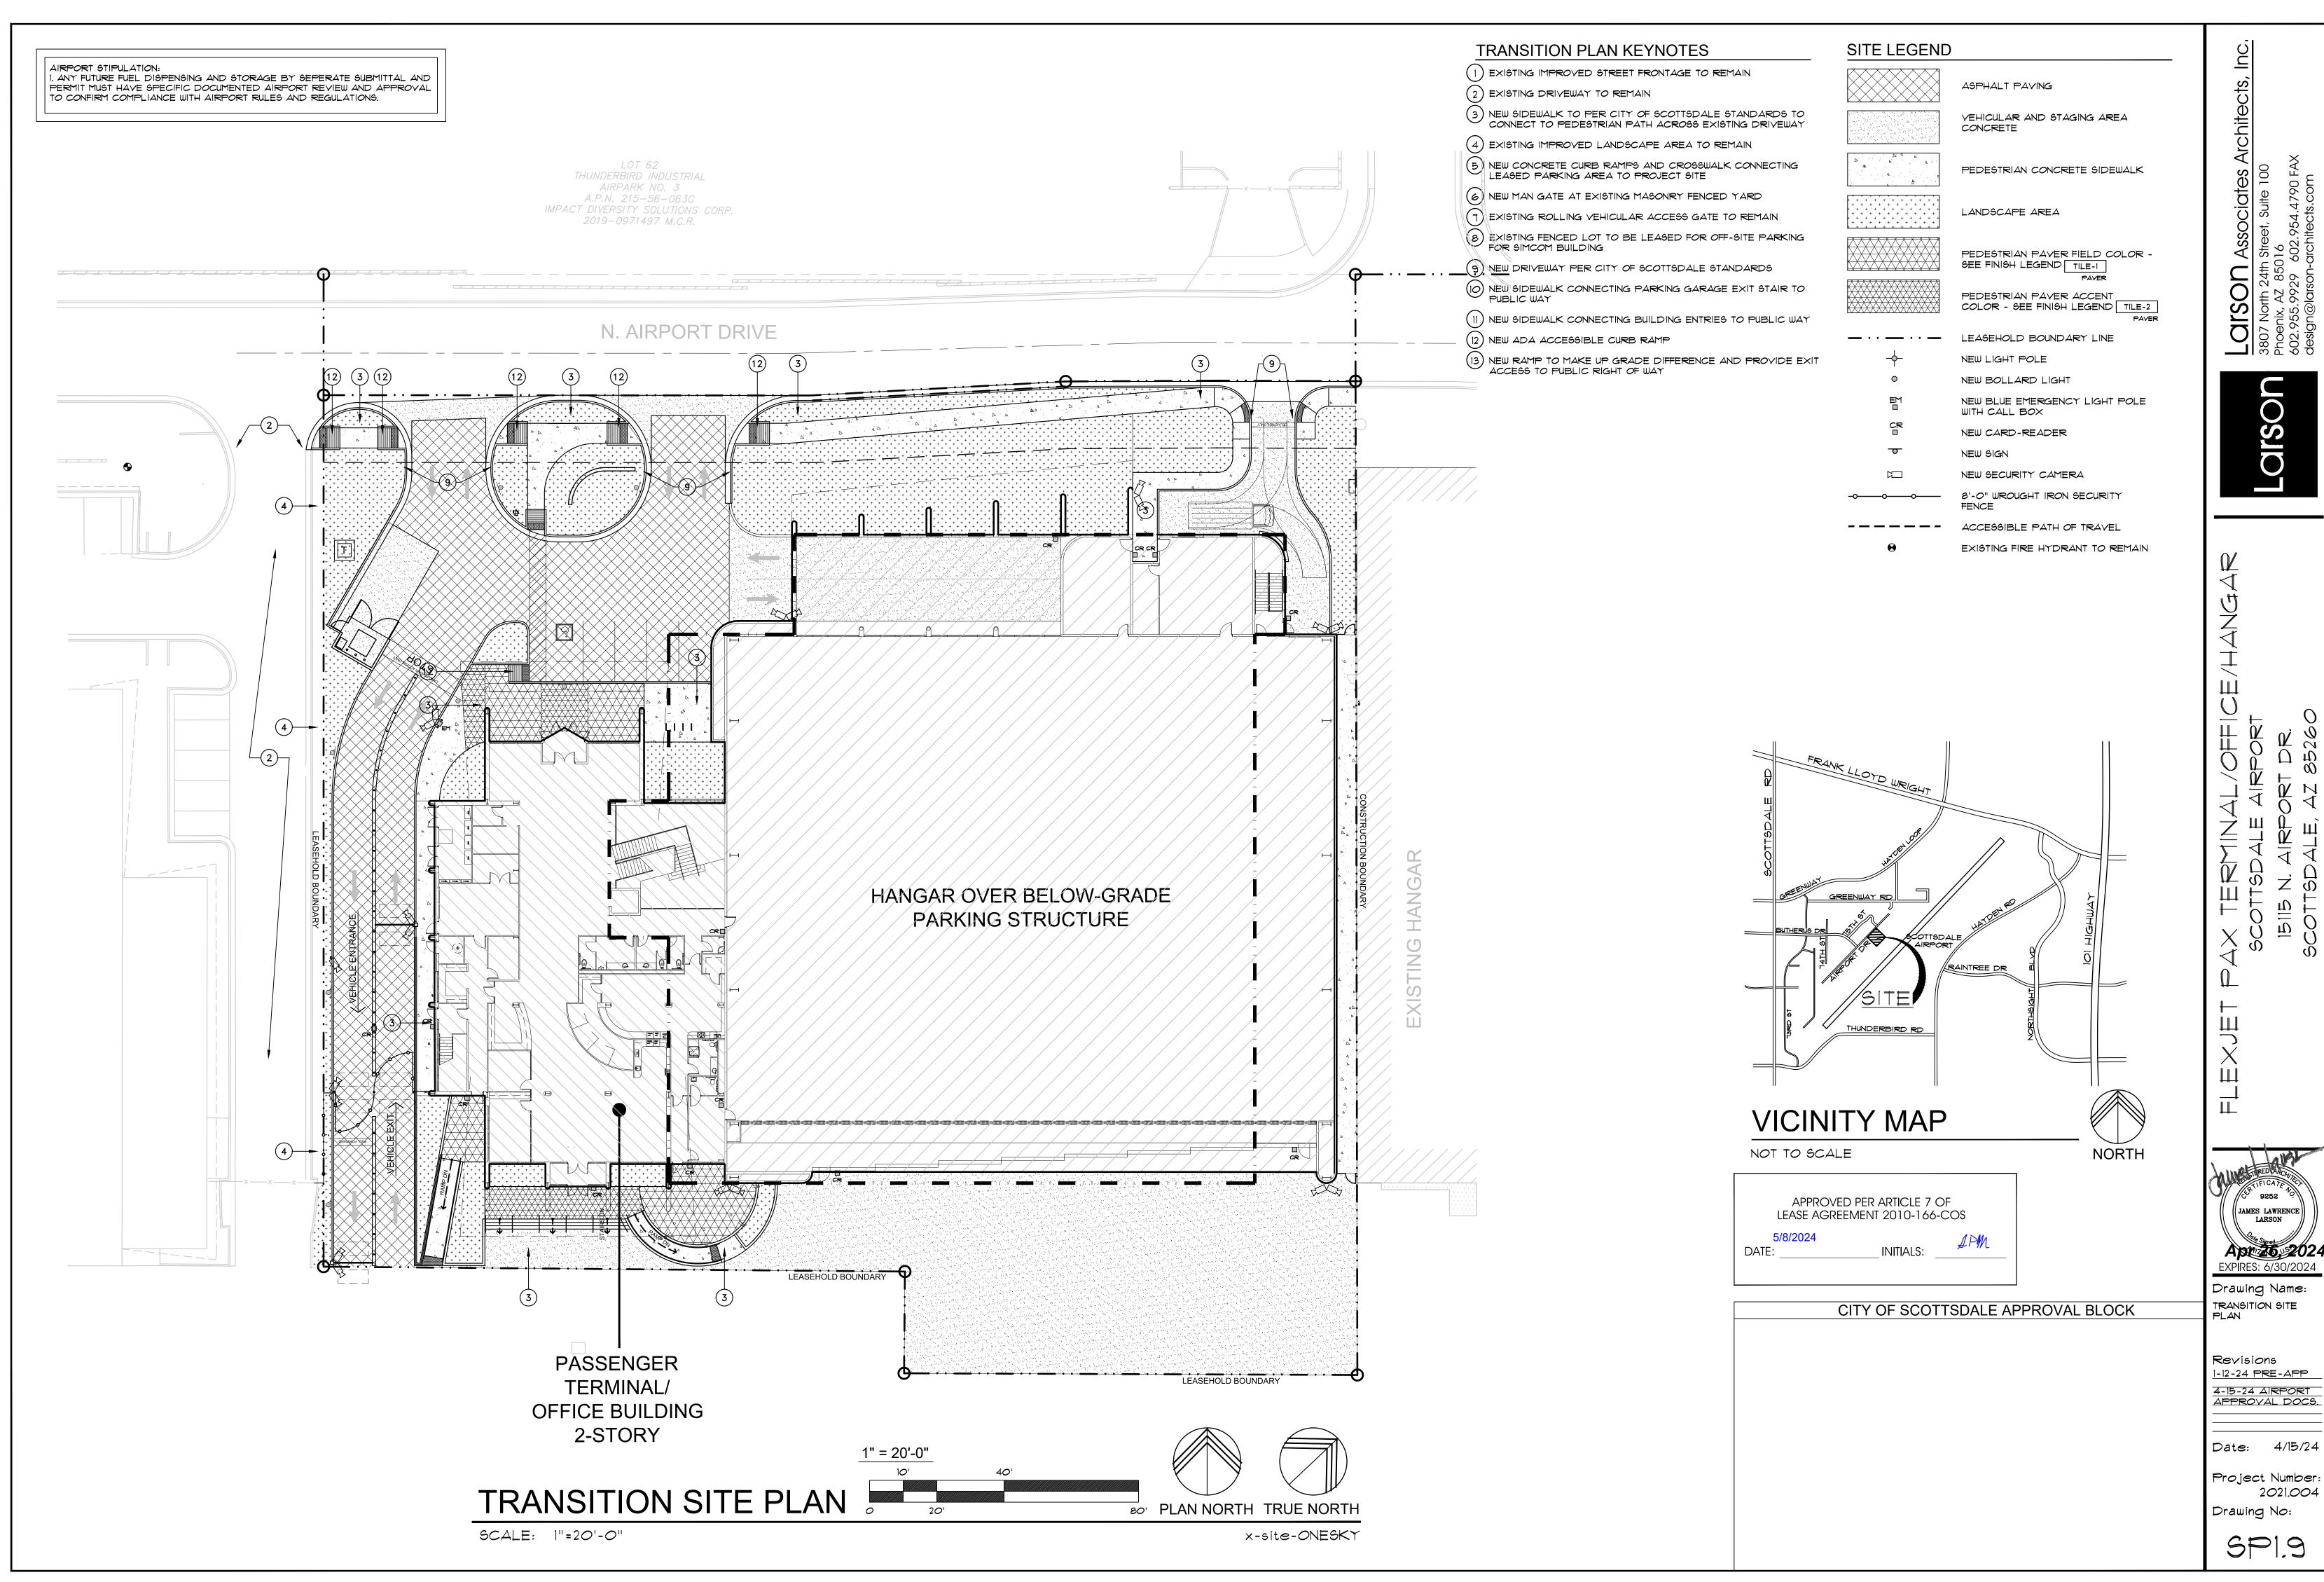

-----11-DR-2024 5/16/2024

IAMES AWRENCE OF TOTAL OF THE PROPERTY OF THE


Drawing Name: SURVEY FOR REFERENCE ONLY

Revisions

Date: 11/04/22

Project Number: 2021.04 Drawing No:

SP00

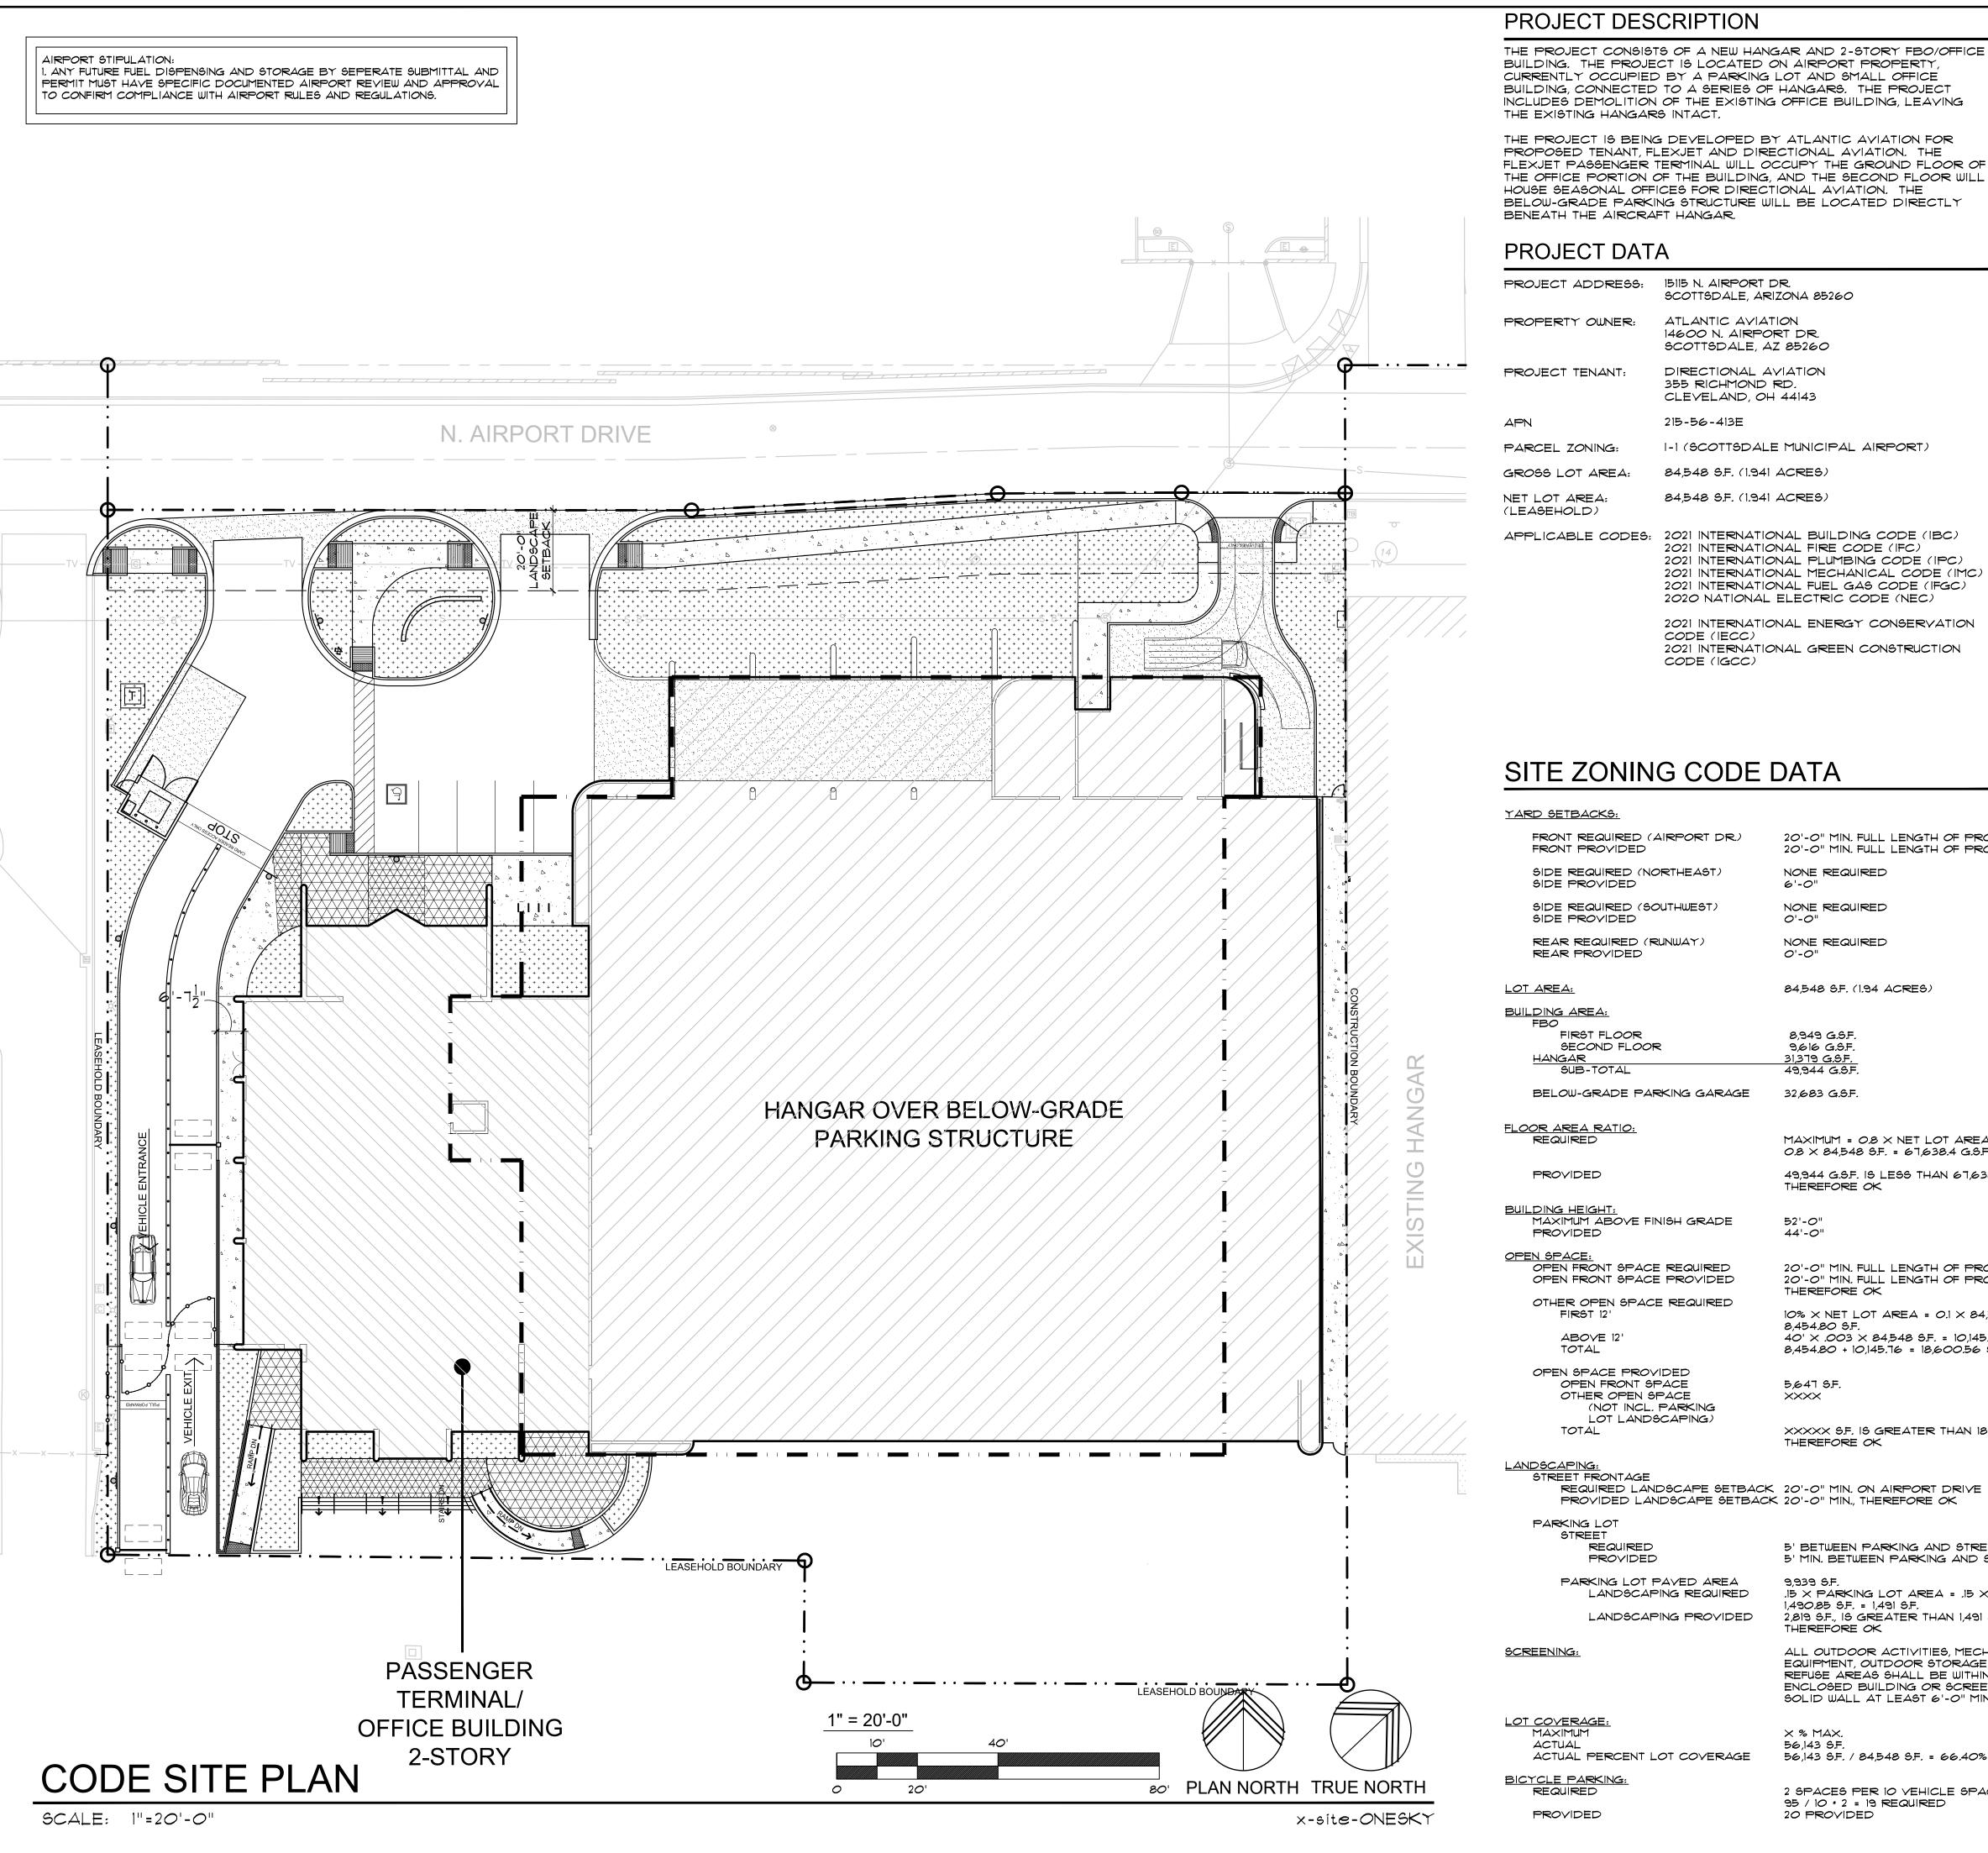

PROJECT DESCRIPTION

THE PROJECT CONSISTS OF A NEW HANGAR AND 2-STORY FBO/OFFICE BUILDING. THE PROJECT IS LOCATED ON AIRPORT PROPERTY, CURRENTLY OCCUPIED BY A PARKING LOT AND SMALL OFFICE BUILDING, CONNECTED TO A SERIES OF HANGARS. THE PROJECT INCLUDES DEMOLITION OF THE EXISTING OFFICE BUILDING, LEAVING THE EXISTING HANGARS INTACT.

THE PROJECT IS BEING DEVELOPED BY ATLANTIC AVIATION FOR PROPOSED TENANT, FLEXJET AND DIRECTIONAL AVIATION. THE FLEXJET PASSENGER TERMINAL WILL OCCUPY THE GROUND FLOOR OF THE OFFICE PORTION OF THE BUILDING, AND THE SECOND FLOOR WILL HOUSE SEASONAL OFFICES FOR DIRECTIONAL AVIATION. THE BELOW-GRADE PARKING STRUCTURE WILL BE LOCATED DIRECTLY BENEATH THE AIRCRAFT HANGAR.

PROJECT DATA

PROJECT ADDRESS: 15115 N. AIRPORT DR. SCOTTSDALE, ARIZONA 85260

> ATLANTIC AVIATION 14600 N. AIRPORT DR. SCOTTSDALE, AZ 85260

DIRECTIONAL AVIATION PROJECT TENANT: 355 RICHMOND RD. CLEVELAND, OH 44143

215-56-413E

PARCEL ZONING: I-I (SCOTTSDALE MUNICIPAL AIRPORT)

GROSS LOT AREA: 84,548 S.F. (1.941 ACRES) 84,548 S.F. (1.941 ACRES)

(LEASEHOLD)

APPLICABLE CODES: 2021 INTERNATIONAL BUILDING CODE (IBC)

2021 INTERNATIONAL FIRE CODE (IFC) 2021 INTERNATIONAL PLUMBING CODE (IPC) 2021 INTERNATIONAL MECHANICAL CODE (IMC) 2021 INTERNATIONAL FUEL GAS CODE (IFGC) 2020 NATIONAL ELECTRIC CODE (NEC)

2021 INTERNATIONAL ENERGY CONSERVATION CODE (IECC) 2021 INTERNATIONAL GREEN CONSTRUCTION CODE (IGCC)

SITE ZONING CODE DATA

YARD SETBACKS:

FRONT REQUIRED (AIRPORT DR.) 20'-0" MIN. FULL LENGTH OF PROPERTY FRONT PROVIDED 20'-0" MIN. FULL LENGTH OF PROPERTY

SIDE REQUIRED (NORTHEAST) NONE REQUIRED SIDE PROVIDED 6'-0" SIDE REQUIRED (SOUTHWEST) NONE REQUIRED SIDE PROVIDED 0'-0"

REAR REQUIRED (RUNWAY) NONE REQUIRED 0'-0"

84,548 S.F. (1.94 ACRES)

FIRST FLOOR

8,949 G.S.F. SECOND FLOOR 9,616 G.S.F. 31,379 G.S.F. 49,944 G.S.F.

REQUIRED

MAXIMUM = 0.8 X NET LOT AREA = $0.8 \times 84,548$ S.F. = 67,638.4 G.S.F.

32,683 G.S.F.

THEREFORE OK

8,454.80 S.F.

49,944 G.S.F. IS LESS THAN 67,638.4 G.S.F., THEREFORE OK

<u>BUILDING HEIGHT:</u> MAXIMUM ABOVE FINISH GRADE 52'-O" 44'-0"

PROVIDED

OPEN FRONT SPACE REQUIRED OPEN FRONT SPACE PROVIDED

OTHER OPEN SPACE REQUIRED FIRST 12'

TOTAL OPEN SPACE PROVIDED OPEN FRONT SPACE OTHER OPEN SPACE

LOT LANDSCAPING)

5,647 S.F. $\times\!\!\times\!\!\times\!\!\times$ (NOT INCL. PARKING

XXXXX S.F. IS GREATER THAN 18,600.56 S.F.

20'-0" MIN. FULL LENGTH OF PROPERTY

20'-0" MIN. FULL LENGTH OF PROPERTY

10% × NET LOT AREA = 0.1 × 84,548 S.F. =

40' × .003 × 84,548 S.F. = 10,145.76 S.F.

8,454.80 + 10,145.76 = 18,600.56 S.F.

5' BETWEEN PARKING AND STREET

5' MIN. BETWEEN PARKING AND STREET

.15 \times PARKING LOT AREA = .15 \times 9,939 S.F. =

ENCLOSED BUILDING OR SCREENED BY ,

SOLID WALL AT LEAST 6'-O" MIN. HEIGHT.

THEREFORE OK <u>LANDSCAPING:</u> STREET FRONTAGE

PROVIDED LANDSCAPE SETBACK 20'-0" MIN., THEREFORE OK

PARKING LOT

STREET REQUIRED PROVIDED

PARKING LOT PAVED AREA LANDSCAPING REQUIRED

> LANDSCAPING PROVIDED 2,819 S.F., IS GREATER THAN 1,491 S.F., THEREFORE OK ALL OUTDOOR ACTIVITIES, MECHANICAL EQUIPMENT, OUTDOOR STORAGE AND REFUSE AREAS SHALL BE WITHIN AN

1,490.85 S.F. = 1,491 S.F.

MAXIMUM \times % MA \times . 56,143 S.F. ACTUAL PERCENT LOT COVERAGE

<u>BICYCLE PARKING:</u> REQUIRED

56,143 S.F. / 84,548 S.F. = 66.40%

2 SPACES PER 10 VEHICLE SPACES 95 / 10 * 2 = 19 REQUIRED 20 PROVIDED

FLEXJET/DIRECTIONAL BUILDING DATA

BUILDING DESCRIPTION 2-STORY PRIVATE JET TERMINAL (FBO) AND OFFICES, HANGAR AND BELOW-GRADE PARKING

CONSTRUCTION TYPES: HANGAR FLOOR I-A (PER IBC. 412.4.2) OCCUPANCY GROUPS: S-1, S-2, B & A-3

<u>USE GROUPS:</u> LOWER LEVEL 5-2 ENCLOSED, BELOW-GRADE PARKING GA (PER IBC SEC. 4066) (PUBLIC GARAGE PER IBC SEC. 406.4)

FIRST FLOOR B - PRIVATE JET TERMINAL (FBO) (SPECIAL USE PER IBC SEC. 412) 5-1 - AIRCRAFT HANGAR HANGAR

B - OFFICE A-3 - ASSEMBLY EXECUTIVE CONFERENCE RM. OCCUPANCY SEPARATION: 1-HR. SEPARATION BETWEEN 5-2 (PARKING GARAGE) AND B & S-1 OCCUPANCIES

> 1-HR. SEPARATION BETWEEN A-3 AND B OCCUPANCIES (PER IBC TABLE 508.4) YES, ALL LEVELS FULLY SPRINKLED

PER IBC SEC. 903.2.10) FIRE-RESISTANCE RATING: SHAFT ENCLOSURES

1-HR, FIRE SPRINKLED (PER IBC SEC. 713)

EXTERIOR WALLS 1-HR GREATER THAN OR EQUAL TO 5 FT. \$
THAN 10 FT., 2-HR LESS THAN 5 FT. S-1, HANGAR I-HR LESS THAN 5' (PER IBC TABLE 6*0*2) B, OFFICE/FBO

FLOOR AREA CALCULATIONS

BELOW-GRADE PARKING GARAGE 32,494 G.S.F.

GARAGE BENEATH HANGAR

SECOND FLOOR

FIRE SPRINKLERS:

FIRST FLOOR HANGAR 29,919 G.S.F. 4,370 G.S.F. SHOP/RAMP TO GARAGE



APPROVED PER ARTICLE 7 OF LEASE AGREEMENT 2010-166-COS 5/8/2024

INITIALS:

CITY OF SCOTTSDALE APPROVAL BLOCK

9252 JAMES LAWRENCE Apr 26, 2024 EXPIRES: 6/30/2024

S

Drawing Name: CODE SITE PLAN


Revisions 1-12-24 PRE-APP

4-15-24 AIRPORT APPROVAL DOCS

4/15/24 Date: Project Number 2021.004

Drawing No:

SPO.

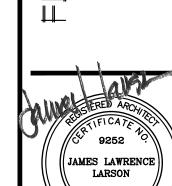

EXPIRES: 6/30/2024

Drawing Name:

EXTERIOR

EXTERIOR ELEVATIONS

Revisions
1-12-24 PRE-APP
4-15-24 AIRPORT
APPROVAL DOCS.

Date: 4/15/24
Project Number: 2021.004


Drawing No:

(19)(17)(16) 23) 3 5 3 18 18 23) (14) 18 18 5 3 18 14 18 23 18 23 44'-0" A.F.F. 1 T.O. PARAPET 40'-11-9/16" A.F.F. 1 T.O. ROOF 40'-0" AFF. 1 T.O. PARAPET 32'-0" AFF. 1 T.O. PARAPET 32'-O" A.F.F. 1 T.O. PARAPET 19 19'-6" A.F.F. 1 T.O. HAND RAIL 17'-1-13/32" A.F.F. 1 T.O. ROOE 12'-0" AFF. 1 T.O. DOOR 12'-0" A.F.F. 1 B.O. SOFFIT 8'-0" AFF. I 21) 2 1 5 10 18 7 18 5 6 5 6

NORTHWEST ELEVATION

SCALE: 3/32"=1'-0"

X-ONESKY-FJ-EXT-ELEV

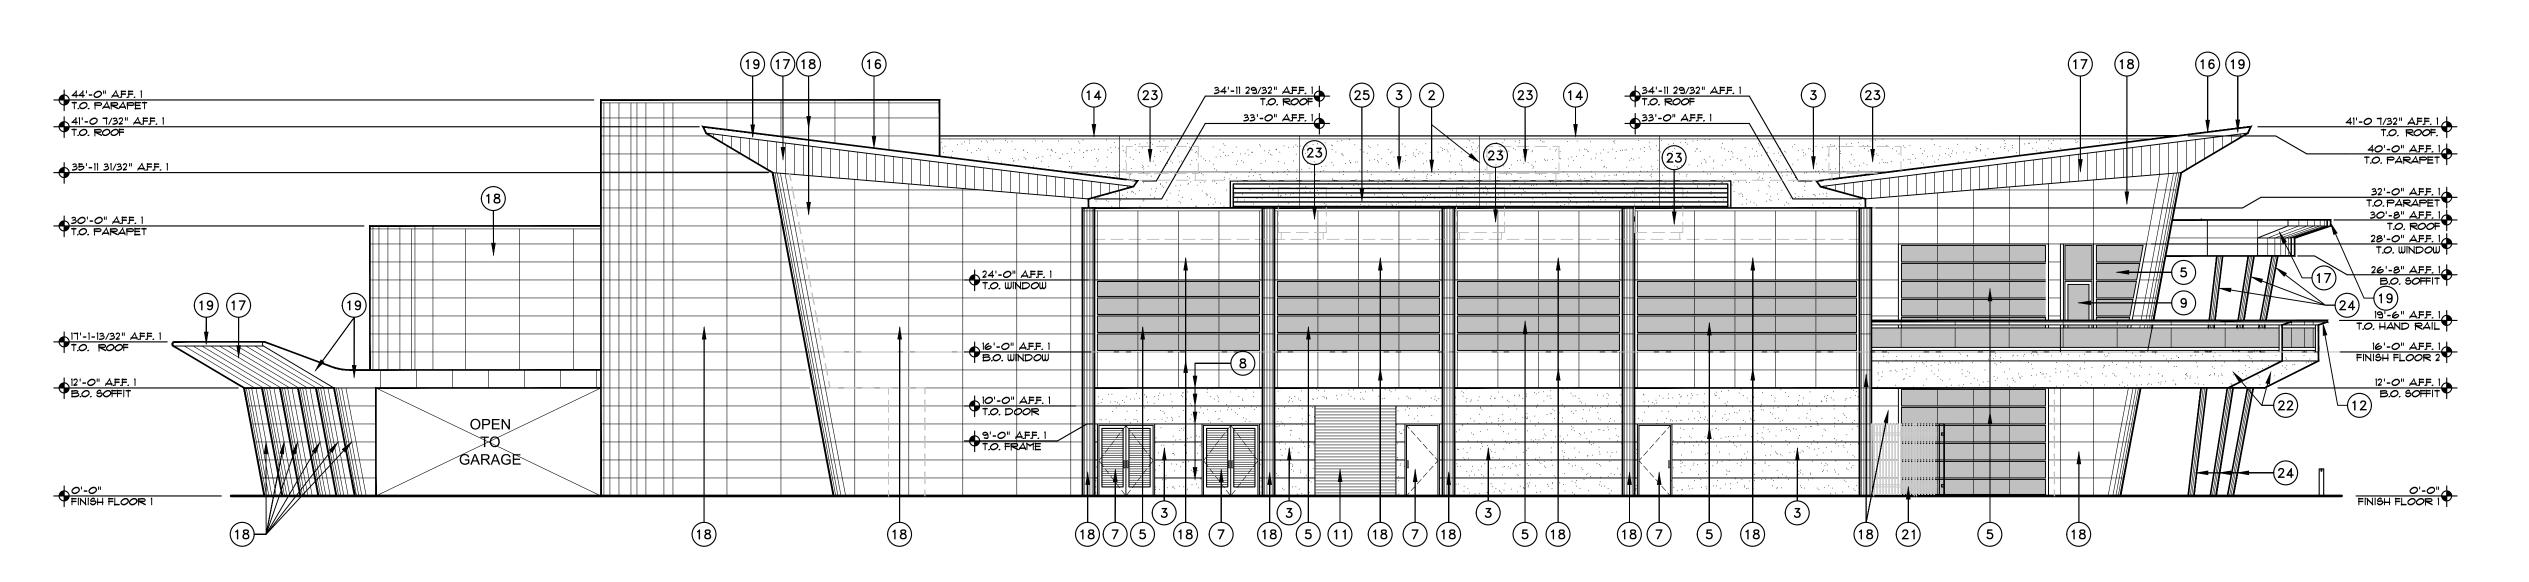

SOUTHWEST ELEVATION

SCALE: 3/32"=1'-O"

X-ONESKY-FJ-EXT-ELEV

		EXTERIOR	FINISH COLOR AND PRODUCT SCHEDULE		
ITEM	DESCRIPTION & LOCATION	MANUFACTURER	PRODUCT, COLOR & STYLE	SIZE	NOTES
TILE-1	PORCELAIN TILE PAVER - FIELD	DAL-TILE	DIGNITARY, NOTABLE BEIGE, DRO9, TEXTURED	24×48	
TILE-2	PORCELAIN TILE PAVER - ACCENT	DAL-TILE	NOMINEE, TAUPE, NMII, MATTE	24×24	
PT-1	FIELD PAINT - EIFS	DUNN EDWARDS	TUSCAN MOSAIC - DE6208		LVR 26
PT-2	CONCRETE TILT PANEL PIGMENT	DAVIS COLORS	MESA BUFF		G.C. TO PROVIDE TEST SAMPLE
PT-3	ACCENT PAINT - METAL ELEMENTS	DUNN EDWARDS	LEGENDARY GRAY DE6369 - LOW SHEEN		LVR 18
PT-4	ACCENT PAINT - SECURITY GATE AND FENCING	DUNN EDWARDS	RHINOCEROS DE6327 - LOW SHEEN		LVR 18
MTL-1	METAL WALL PANELS	PPG	PPG - DURANAR, SUNSTORM, PEWTER, UC143423F		+/- LVR 18
MTL-2	METAL SOFFIT PANELS, FASCIA	PPG	PPG - DURANAR, SUNSTORM, WEATHERED ZINC, UC143428F		+/- LVR 18
STONE-1	NATURAL GRANITE STONE - BUILDING WALL BASE		DARK GREY, POLISHED GRANITE SLAB,	VARIES - SEE ELEVATION	SLAB TO BE SELECTED BY OWNER AND ARCHITECT
R00F-1	STANDING SEAM METAL ROOFING	ATAS	2" FIELD LOK, MATCH PPG SUNSTORM WEATHERED ZINC	19 1/2" PANEL	+/- LVR 18
ROOF-2	TPO ROOFING	CARLISLE	WHITE		
DOOR-I	ALUMINUM MAIN ENTRANCE DOORS	OLDCASTLE	MATCH PPG SUNSTORM PEWTER		
WINDOW-1	CURTAIN WALL WINDOW FRAME SYSTEM	OLDCASTLE	EXTERIOR MATCH PPG SUNSTORM PEWTER INTERIOR WHITE	6"	
GL-1	REFLECTIVE BUILDING GLASS	OLDCASTLE	MEDIUM GRAY- I" DUAL PAINT INSULATED GLASS		EXTERIOR RAILING GLASS TO BE THE SAME COLOR AND TINT

ELEVATION KEYED NOTES

(14) GSM PARAPET CAP, PAINTED —

1) SLOPED ALUMINUM CURTAIN WALL FRAMING WITH TINTED, REFLECTIVE, BUTT-JOINED GLASS — WINDOW-1 GL-1
2 REVEAL IN STUCCO (1/2" WIDE X 1/2" DEEP "V" REVEAL) SEE DETAIL 8/A5.0
METAL STUD WALL WITH EIFS STUCCO FINISH, PAINTED PT-1
4 PIGMENTED AND SAND-BLASTED CONCRETE ACCENT WALL PT-4
5) ALUMINUM CURTAIN WALL FRAMING WITH TINTED, REFLECTIVE, BUTT-JOINED GLASS WINDOW-I GL-I
6 PIGMENTED AND SAND-BLASTED CONCRETE GUARD RAIL AT RAMP DOWN TO GARAGE PT-2
7) HOLLOW METAL DOOR AND FRAME PAINTED TO MATCH ADJACENT WALL
8 CLEAR ANODIZED EXTRUDED ALUMINUM STUCCO REVEAL
9 ALUMINUM ENTRANCE DOORS WITH TINTED, REFLECTIVE GLASS DOOR-1 GL-1
10 POLISHED GRANITE PANELSSTONE-I
PRE-FINISHED STEEL ROLL-UP DOOR, PAINTED PT-I
METAL PANEL HAND RAIL ASSEMBLY WITH GLASS GUARD RAIL MTL-1 GL-2
METAL STUD FRAMED HANGAR DOOR HEADER WITH METAL PANEL FINISH

PT-3

15) PRE-FINISHED MAN-DOOR IN HANGAR DOOR - BY HANGAR DOOR MANUFACTURER, FINISH TO MATCH HANGAR DOOR	
(16) PRE-FINISHED STANDING SEAM METAL ROOF PANELS — ROOF-I	
17) PRE-FINISHED METAL SOFFIT PANELSMTL-2	
(18) PRE-FINISHED METAL WALL PANELSMTL-1	
(19) PRE-FINISHED METAL FASCIA PANELSMTL-2	
(20) PRE-FINISHED HANGAR DOOR, PAINTED PT-2	
21) 8' IRON SECURITY FENCE, PAINTED PT-4	
(22) METAL STUD FRAMED SOFFIT WITH EIFS STUCCO FINISH — PT-I	
23) ROOF LINE AND MECHANICAL UNIT BEYOND - ALL MECHANICAL UNITS ARE TO BE SCREENED	
24) STEEL PIPE COLUMN, PAINTED PT-3	
(25) ROOF MOUNTED MECHANICAL UNIT SCREEN PAINTED - PT-1	6' 24'
	12' 48'
	12 40
	APPROVED PER ARTICLE 7 OF LEASE AGREEMENT 2010-166-COS
	LE, GE, ASIALLIVIEIVI 2010 100 000
DATE	5/8/2024 : INITIALS:

9252 (JAMES LAWRENCE)

Apr 25, 2024 EXPIRES: 6/30/2024 Drawing Name:


EXTERIOR ELEVATIONS


Revisions

1-12-24 PRE-APP 4-15-24 AIRPORT APPROVAL DOCS.

Date: 4/15/24 Project Number: 2021.004

Drawing No:

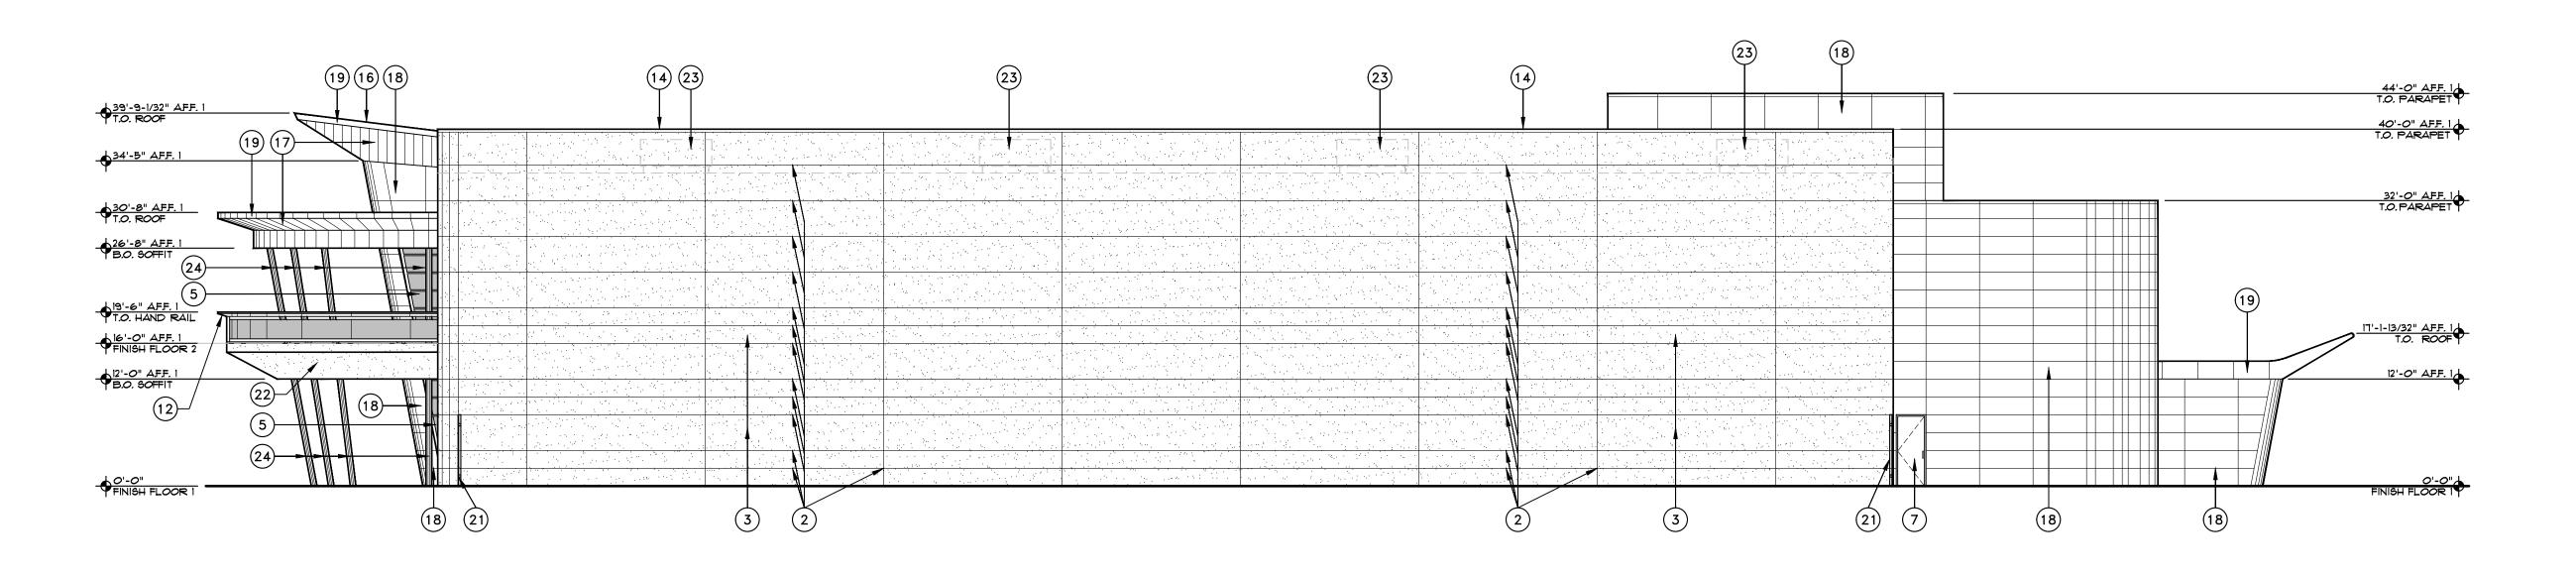

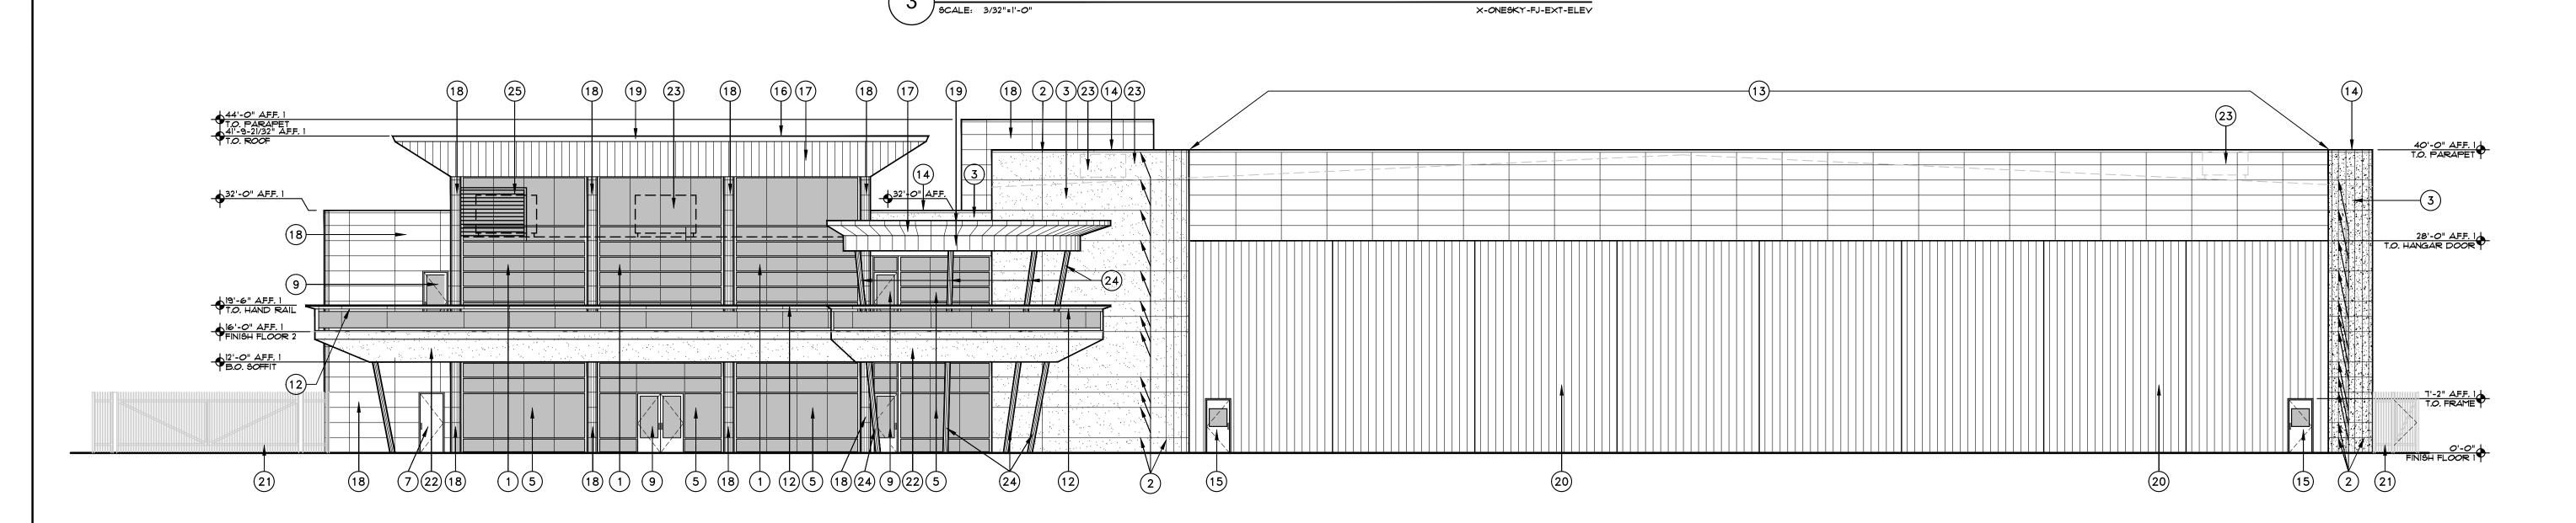

NORTHEAST ELEVATION

(_A `	\ SOUTHEAST ELEVATION	
(4	SCALE: 3/32"=1'-O"	X-ONESKY-FJ-EXT-ELEY
	,	

			FINISH COLOR AND PRODUCT SCHEDULE		
ITEM	DESCRIPTION & LOCATION	MANUFACTURER	PRODUCT, COLOR & STYLE	SIZE	NOTES
TILE-1	PORCELAIN TILE PAYER - FIELD	DAL-TILE	DIGNITARY, NOTABLE BEIGE, DRO9, TEXTURED	24×48	
TILE-2	PORCELAIN TILE PAVER - ACCENT	DAL-TILE	NOMINEE, TAUPE, NMII, MATTE	24×24	
PT-1	FIELD PAINT - EIFS	DUNN EDWARDS	TUSCAN MOSAIC - DE6208		LVR 26
PT-2	CONCRETE TILT PANEL PIGMENT	DAVIS COLORS	MESA BUFF		G.C. TO PROVIDE TEST SAMPLE
PT-3	ACCENT PAINT - METAL ELEMENTS	DUNN EDWARDS	LEGENDARY GRAY DE6369 - LOW SHEEN		LVR 18
PT-4	ACCENT PAINT - SECURITY GATE AND FENCING	DUNN EDWARDS	RHINOCEROS DE6327 - LOW SHEEN		LVR 18
MTL-1	METAL WALL PANELS	PPG	PPG - DURANAR, SUNSTORM, PEWTER, UC143423F		+/- LVR 18
MTL-2	METAL SOFFIT PANELS, FASCIA	PPG	PPG - DURANAR, SUNSTORM, WEATHERED ZINC, UC143428F		+/- LVR 18
STONE-1	NATURAL GRANITE STONE - BUILDING WALL BASE		DARK GREY, POLISHED GRANITE SLAB,	VARIES - SEE ELEVATION	SLAB TO BE SELECTED BY OWNER AND ARCHITEC
R00F-1	STANDING SEAM METAL ROOFING	ATAS	2" FIELD LOK, MATCH PPG SUNSTORM WEATHERED ZINC	19 1/2" PANEL	+/- LVR 18
ROOF-2	TPO ROOFING	CARLISLE	WHITE		
D00R-1	ALUMINUM MAIN ENTRANCE DOORS	OLDCASTLE	MATCH PPG SUNSTORM PEWTER		
WINDOW-1	CURTAIN WALL WINDOW FRAME SYSTEM	OLDCASTLE	EXTERIOR MATCH PPG SUNSTORM PEWTER INTERIOR WHITE	6"	
GL-1	BUILDING GLASS	OLDCASTLE	MEDIUM GRAY- 1" DUAL PAINT INSULATED GLASS		EXTERIOR RAILING GLASS TO BE THE SAME COLOR AND TIN

ELEVATION KEYED NOTES

1) SLOPED ALUMINUM CURTAIN WALL FRAMING WITH TINTED, REFLECTIVE, BUTT-JOINED GLASS WINDOW-1 GL	-1
2) REVEAL IN STUCCO (1/2" WIDE X 1/2" DEEP "V" REVEAL) SEE DETAIL 8/A5.0	
3) METAL STUD WALL WITH EIFS STUCCO FINISH, PAINTED PT.	-1
4) PIGMENTED AND SAND-BLASTED CONCRETE ACCENT WALL PT-	4
5) ALUMINUM CURTAIN WALL FRAMING WITH TINTED, REFLECTIVE, BUTT-JOINED GLASS WINDOW-1 GL	-1
6 PIGMENTED AND SAND-BLASTED CONCRETE GUARD RAIL AT RAMP DOWN TO GARAGE PT-	-2
7) HOLLOW METAL DOOR AND FRAME PAINTED TO MATCH ADJACENT WALL	
8 CLEAR ANODIZED EXTRUDED ALUMINUM STUCCO REVEAL	
9 ALUMINUM ENTRANCE DOORS WITH TINTED, REFLECTIVE GLASS DOORS WITH TINTED,	-1
(10) POLISHED GRANITE PANELSSTON	i E −1
11) PRE-FINISHED STEEL ROLL-UP DOOR, PAINTED PT. TO MATCH ADJACENT WALL	-1

(12) METAL PANEL HAND RAIL ASSEMBLY WITH GLASS
GUARD RAIL MTL-1 GL-2

MTL-1

PT-3

13) METAL STUD FRAMED HANGAR DOOR HEADER WITH METAL PANEL FINISH

(14) GSM PARAPET CAP, PAINTED -

(18) PRE-FINISHED METAL WALL PANELS -(19) PRE-FINISHED METAL FASCIA PANELS -(20) PRE-FINISHED HANGAR DOOR, PAINTED -(21) 8' IRON SECURITY FENCE, PAINTED -(22) METAL STUD FRAMED SOFFIT WITH EIFS STUCCO FINISH - PT-I 23) ROOF LINE AND MECHANICAL UNIT BEYOND - ALL MECHANICAL UNITS ARE TO BE SCREENED (24) STEEL PIPE COLUMN, PAINTED -(25) ROOF MOUNTED MECHANICAL UNIT SCREEN PAINTED - PT-1

15) PRE-FINISHED MAN-DOOR IN HANGAR DOOR - BY HANGAR DOOR MANUFACTURER, FINISH TO MATCH HANGAR DOOR

(17) PRE-FINISHED METAL SOFFIT PANELS -

(16) PRE-FINISHED STANDING SEAM METAL ROOF PANELS - ROOF-1

- MTL-2

MTL-1


MTL-2

PT-2

PT-4

PT-3

0

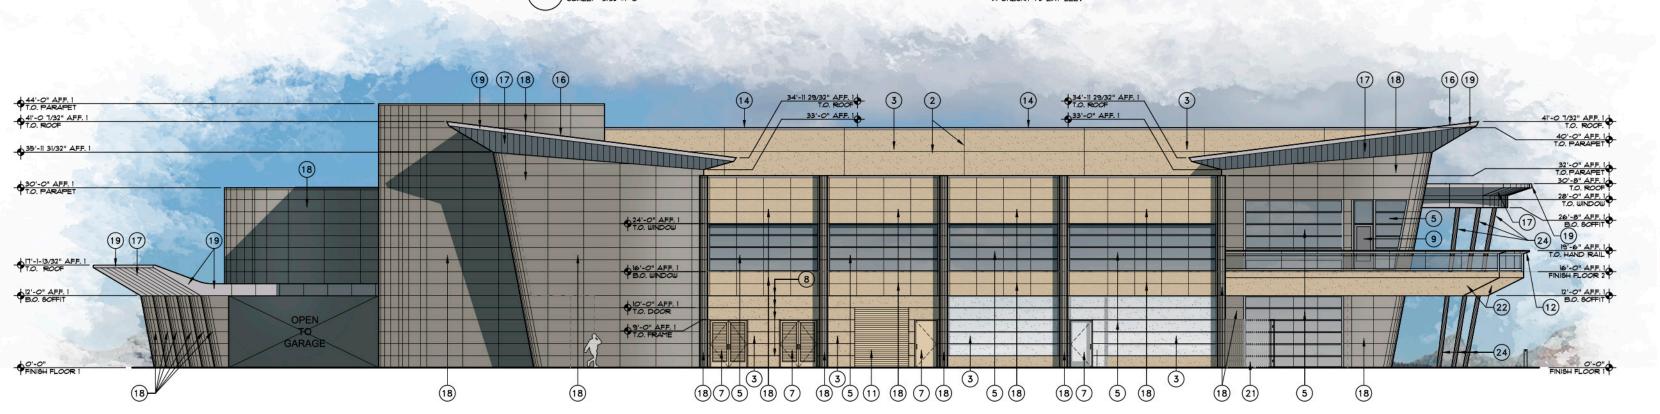

SOUTHWEST ELEVATION

GCALE: 3/32"=1'-O" X-ONESKY-FJ-EXT-ELEV

		EXTERIOR	FINISH COLOR AND PRODUCT SCHEDULE		
ITEM	DESCRIPTION & LOCATION	MANUFACTURER	PRODUCT, COLOR & STYLE	SIZE	NOTES
TILE-I	PORCELAIN TILE PAVER - FIELD	DAL-TILE	DIGNITARY, NOTABLE BEIGE, DROS, TEXTURED	24×48	
TILE-2	PORCELAIN TILE PAVER - ACCENT	DAL-TILE	NOMINEE, TAUPE, NMII, MATTE	24×24	
PT-I	FIELD PAINT - EIFS	DUNN EDWARDS	TUSCAN MOSAIC - DE6208		LVR 26
PT-2	CONCRETE TILT PANEL PIGMENT	DAVIS COLORS	MESA BUFF		G.C. TO PROVIDE TEST SAMPLE
PT-3	ACCENT PAINT - METAL ELEMENTS	DUNN EDWARDS	LEGENDARY GRAY DE6369 - LOW SHEEN		LVR 18
PT-4	ACCENT PAINT - SECURITY GATE AND FENCING	DUNN EDWARDS	RHINOCEROS DE6327 - LOW SHEEN		LVR 18
MTL-1	METAL WALL PANELS	PPG	PPG - DURANAR, SUNSTORM, PEWTER, UC143423F		+/- LVR 18
MTL-2	METAL SOFFIT PANELS, FASCIA	PPG	PPG - DURANAR, SUNSTORM, WEATHERED ZINC, UC143428F		+/- LVR 18
STONE-1	NATURAL GRANITE STONE - BUILDING WALL BASE		DARK GREY, POLISHED GRANITE SLAB,	VARIES - SEE ELEVATION	SLAB TO BE SELECTED BY OWNER AND ARCHITECT
ROOF-1	STANDING SEAM METAL ROOFING	ATAS	2" FIELD LOK, MATCH PPG SUNSTORM WEATHERED ZINC	19 1/2" PANEL	+/- LVR 18
ROOF-2	TPO ROOFING	CARLISLE	WHITE		
DOOR-I	ALUMINUM MAIN ENTRANCE DOORS	OLDCASTLE	MATCH PPG SUNSTORM PEWTER		
WINDOW-1	CURTAIN WALL WINDOW SYSTEM	OLDCASTLE	EXTERIOR MATCH PPG SUNSTORM PEWTER INTERIOR WHITE	6"	I" INSULATED STANDARD (TWO 1/4" PANES WITH 1/2" INSULATION GA
GL-1	MEDIUM GREY, REFLECTIVE BUILDING GLASS	OLDCASTLE	VANCEVA - DUAL-PANE, TEMPERED, LOW-E, LAMINATED		I" INSULATED STANDARD (TWO 1/4" PANES WITH 1/2" INSULATION GA
GL-3	DECK GUARD RAIL GLASS, LIGHT GREY	OLDCASTLE	VANCEVA - ½" TEMPERED, LAMINATED GLASS		
		_			

ELEVATION KEYED NOTES

14 GSM PARAPET CAP, PAINTED -

ELEVATION RETEDINOTES	
1) \$LOPED ALUMINUM CURTAIN WALL FRAMING WITH TINTED, REFLECTIVE, BUTT-JOINED GLASS WINDOW-I	GL-I
2 REVEAL IN STUCCO (1/2" WIDE X 1/2" DEEP "V" REVEAL) SEE DETAIL 8/45,0	
METAL STUD WALL WITH EIFS STUCCO FINISH, PAINTED	PT-I
4 PIGMENTED AND SAND-BLASTED CONCRETE ACCENT WALL	PT-4
5) ALUMINUM CURTAIN WALL FRAMING WITH TINTED, REFLECTIVE, BUTT-JOINED GLASS	GL-1
6 PIGMENTED AND SAND-BLASTED CONCRETE GUARD RAIL AT RAMP DOWN TO GARAGE	PT-2
7) HOLLOW METAL DOOR AND FRAME PAINTED TO MATCH ADJACENT WALL	
8 CLEAR ANODIZED EXTRUDED ALUMINUM STUCCO REVEAL	
9 ALUMINUM ENTRANCE DOORS WITH TINTED, REFLECTIVE GLASS	GL-1
10 POLISHED GRANITE PANELS	STONE-1
1) PRE-FINISHED STEEL ROLL-UP DOOR, PAINTED	PT-I
12) METAL PANEL HAND RAIL ASSEMBLY WITH GLASS GUARD RAIL MTL-I	GL-2
13) METAL STUD FRAMED HANGAR DOOR HEADER WITH METAL PANEL FINISH	MTL-1

PT-3

(15) PRE-FINISHED MAN-DOOR IN HANGAR DOOR - BY HANGAR DOOR MANUFACTURER, FINISH TO MATCH HANGAR DOOR	
(6) PRE-FINISHED STANDING SEAM METAL ROOF PANELS -	ROOF-1
7 PRE-FINISHED METAL SOFFIT PANELS	MTL-2
18) PRE-FINISHED METAL WALL PANELS	MTL-1
9 PRE-FINISHED METAL FASCIA PANELS	MTL-2
20) PRE-FINISHED HANGAR DOOR, PAINTED	PT-2
21) 8' IRON SECURITY FENCE, PAINTED -	PT-4

22 METAL STUD FRAMED SOFFIT WITH EIFS STUCCO FINISH - PT-1 23) NOT USED 24) STEEL PIPE COLUMN, PAINTED -

> APPROVED PER ARTICLE 7 OF LEASE AGREEMENT 2010-166-COS

DATE: /8/2024 _INITIALS: <u>APM</u>

Project Number:

2021.004 Drawing No: A2.0

Date: 4/15/24

EXPIRES: 6/30/2024 Drawing Name: EXTERIOR ELEVATIONS


Revisions 1-12-24 PRE-APP 4-15-24 AIRPORT APPROVAL DOCS.


AX TERMINAL/OFFICE/HANGAR SCOTTSDALE AIRPORT 15115 N. AIRPORT DR. SCOTTSDALE, AZ 85260 FLEXJET

LOTSON Associates Architects, In 3807 North 24th Street, Suite 100 Phoenix, AZ 85016 602.955.9929 602.954.4790 FAX design@larson-architects.com

Larson

5/16/2024

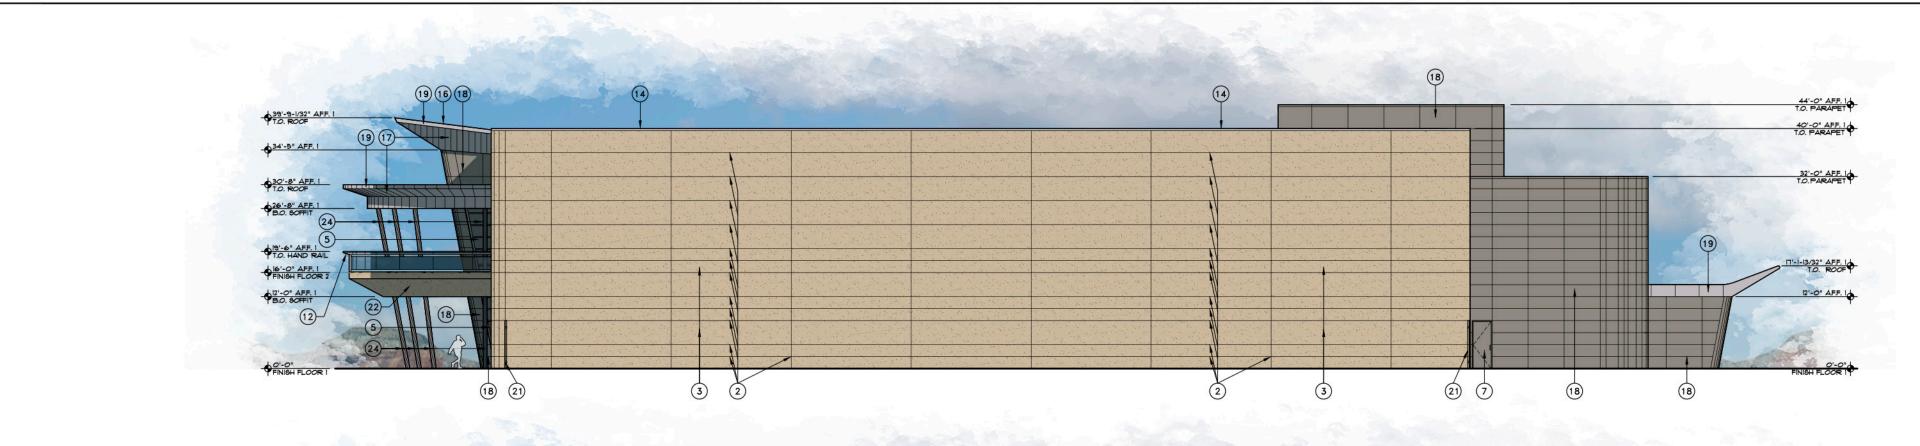

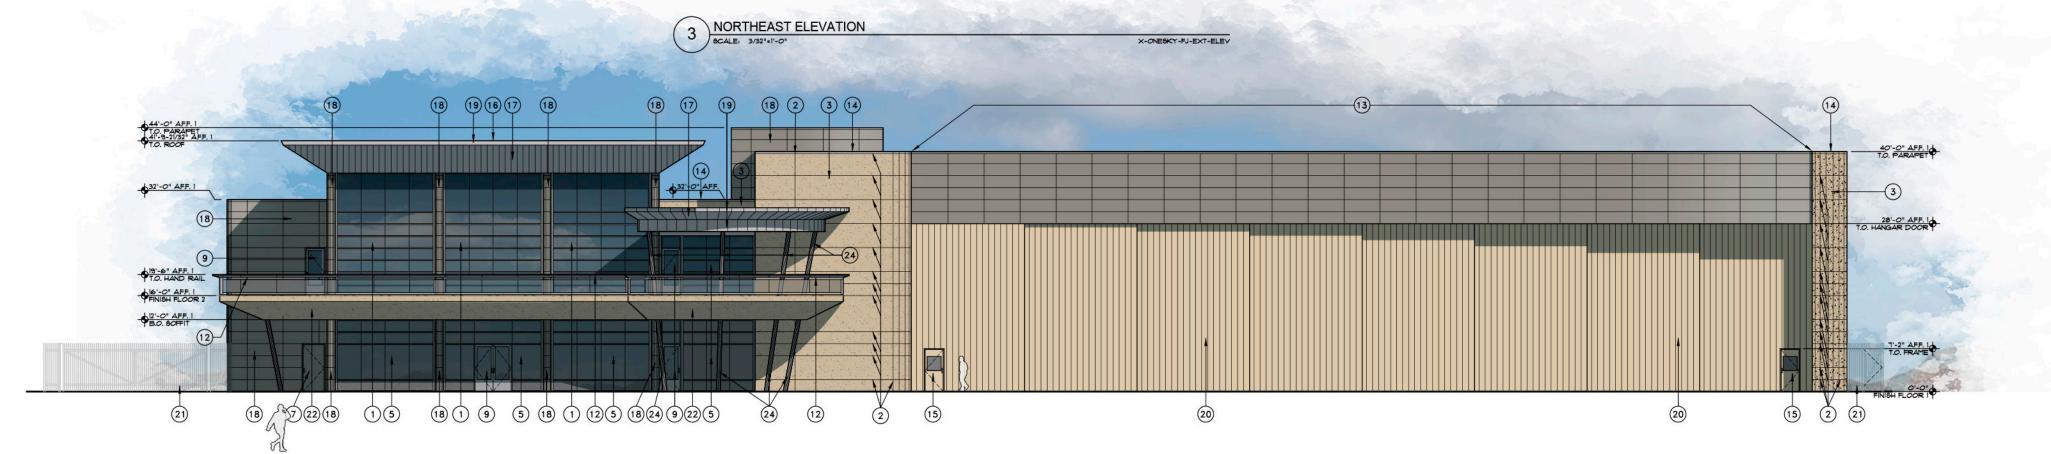

SOUTHEAST ELEVATION X-ONESKY-FJ-EXT-ELEV

	_	EXTERIOR	FINISH COLOR AND PRODUCT SCHEDULE		
ITEM	DESCRIPTION & LOCATION	MANUFACTURER	PRODUCT, COLOR & STYLE	SIZE	NOTES
TILE-1	PORCELAIN TILE PAVER - FIELD	DAL-TILE	DIGNITARY, NOTABLE BEIGE, DRO9, TEXTURED	24×48	
TILE-2	PORCELAIN TILE PAVER - ACCENT	DAL-TILE	NOMINEE, TAUPE, NMII, MATTE	24×24	
PT-I	FIELD PAINT - EIFS	DUNN EDWARDS	TUSCAN MOSAIC - DE6208		LVR 26
PT-2	CONCRETE TILT PANEL PIGMENT	DAVIS COLORS	MESA BUFF		G.C. TO PROVIDE TEST SAMPLE
PT-3	ACCENT PAINT - METAL ELEMENTS	DUNN EDWARDS	LEGENDARY GRAY DE6369 - LOW SHEEN		LVR 18
PT-4	ACCENT PAINT - SECURITY GATE AND FENCING	DUNN EDWARDS	RHINOCEROS DE6327 - LOW SHEEN		LVR 18
Net 1	NETA WALL BANK C	- I - I			
MTL-1	METAL WALL PANELS	PPG	PPG - DURANAR, SUNSTORM, PEWTER, UCI43423F		+/- LVR 18
MTL-2	METAL SOFFIT PANELS, FASCIA	PPG	PPG - DURANAR, SUNSTORM, WEATHERED ZINC, UC143428F		+/- LVR 18
STONE-1	NATURAL GRANITE STONE - BUILDING WALL BASE		DARK GREY, POLISHED GRANITE SLAB,	VARIES - SEE	SLAB TO BE SELECTED BY OWNER AND ARCHITECT
ROOF-1	STANDING SEAM METAL ROOFING	ATAS	2" FIELD LOK, MATCH PPG SUNSTORM WEATHERED ZINC	19 1/2" PANEL	+/- LVR 18
ROOF-2	TPO ROOFING	CARLISLE	WHITE		
DOOR-1	ALUMINUM MAIN ENTRANCE DOORS	OLDCASTLE	MATCH PPG SUNSTORM PEWTER		
20014	ALGERIA TENEDE DO TO	025070122	THE STATE OF		
WINDOW-1	CURTAIN WALL WINDOW SYSTEM	OLDCASTLE	EXTERIOR MATCH PPG SUNSTORM PEWTER INTERIOR WHITE	6"	I" INSULATED STANDARD (TWO 1/4" PANES WITH 1/2" INSULATION GAI
GL-I	MEDIUM GREY, REFLECTIVE BUILDING GLASS	OLDCASTLE	VANCEVA - DUAL-PANE, TEMPERED, LOW-E, LAMINATED		 " INSULATED STANDARD (TWO 1/4" PANES WITH 1/2" INSULATION GA
GL-3	DECK GUARD RAIL GLASS, LIGHT GREY	OLDCASTLE	VANCEVA - 1" TEMPERED, LAMINATED GLASS		

ELEVATION KEYED NOTES

(14) GSM PARAPET CAP, PAINTED -

1 SLOPED ALUMINUM CURTAIN WALL FRAMING WITH TINTED, REFLECTIVE, BUTT-JOINED GLASS	WINDOW-1 GL-1
2 REVEAL IN STUCCO (1/2" WIDE X 1/2" DEEP "V" REVEAL) SEE DETAIL 8/A5.0	
METAL STUD WALL WITH EIFS STUCCO FINISH, PAINTED	PT-I
4 PIGMENTED AND SAND-BLASTED CONCRETE ACCENT WALL	PT-4
5 ALUMINUM CURTAIN WALL FRAMING WITH TINTED, REFLECTIVE, BUTT-JOINED GLASS	WINDOW-1 GL-1
6) PIGMENTED AND SAND-BLASTED CONCRETE GUARD RAIL AT RAMP DOWN TO GARAGE ———	PT-2
7) HOLLOW METAL DOOR AND FRAME PAINTED TO MATCH ADJACENT WALL	
8 CLEAR ANODIZED EXTRUDED ALUMINUM STUCCO REVEAL	
9 ALUMINUM ENTRANCE DOORS WITH TINTED,	DOOP-1 GL-1

REFLECTIVE GLASS -DOOR-I GL-I (10) POLISHED GRANITE PANELS -STONE-I 12 METAL PANEL HAND RAIL ASSEMBLY WITH GLASS
GUARD RAIL MTL-1 GL-2 METAL STUD FRAMED HANGAR DOOR HEADER WITH METAL PANEL FINISH MTL-I

PT-3

(15) PRE-FINISHED MAN-DOOR IN HANGAR DOOR - BY HANGAR DOOR MANUFACTURER, FINISH TO MATCH HANGAR DOOR

(16) PRE-FINISHED STANDING SEAM METAL ROOF PANELS - ROOF-I 17) PRE-FINISHED METAL SOFFIT PANELS -MTL-1 (18) PRE-FINISHED METAL WALL PANELS (19) PRE-FINISHED METAL FASCIA PANELS -PT-2 (20) PRE-FINISHED HANGAR DOOR, PAINTED PT-4 (21) 8' IRON SECURITY FENCE, PAINTED -(22) METAL STUD FRAMED SOFFIT WITH EIFS STUCCO FINISH - PT-1 (23) NOT USED 24 STEEL PIPE COLUMN, PAINTED -PT-3

APPROVED PER ARTICLE 7 OF LEASE AGREEMENT 2010-166-COS

DATE: 5/8/2024

INITIALS:

2021.004 Drawing No:

Date: 4/15/24

Project Number:

EXPIRES: 6/30/2024

Drawing Name:

EXTERIOR ELEVATIONS

Revisions

1-12-24 PRE-APP 4-15-24 AIRPORT APPROVAL DOCS.

AX TERMINAL/OFFICE/HANGAR SCOTTSDALE AIRPORT H_XH_H

LOTSON Associates Architects, In 3807 North 24th Street, Suite 100 Phoenix, AZ 85016 602.955.9929 602.954.4790 FAX design@larson-architects.com

Larson

A2.1 5/16/2024


Drawing Name:

STREET ELEVATIONS

Revisions 1-12-24 PRE-APP 4-15-24 AIRPORT APPROVAL DOCS.

Date: 4/15/24

Project Number: 2021.004 Drawing No:

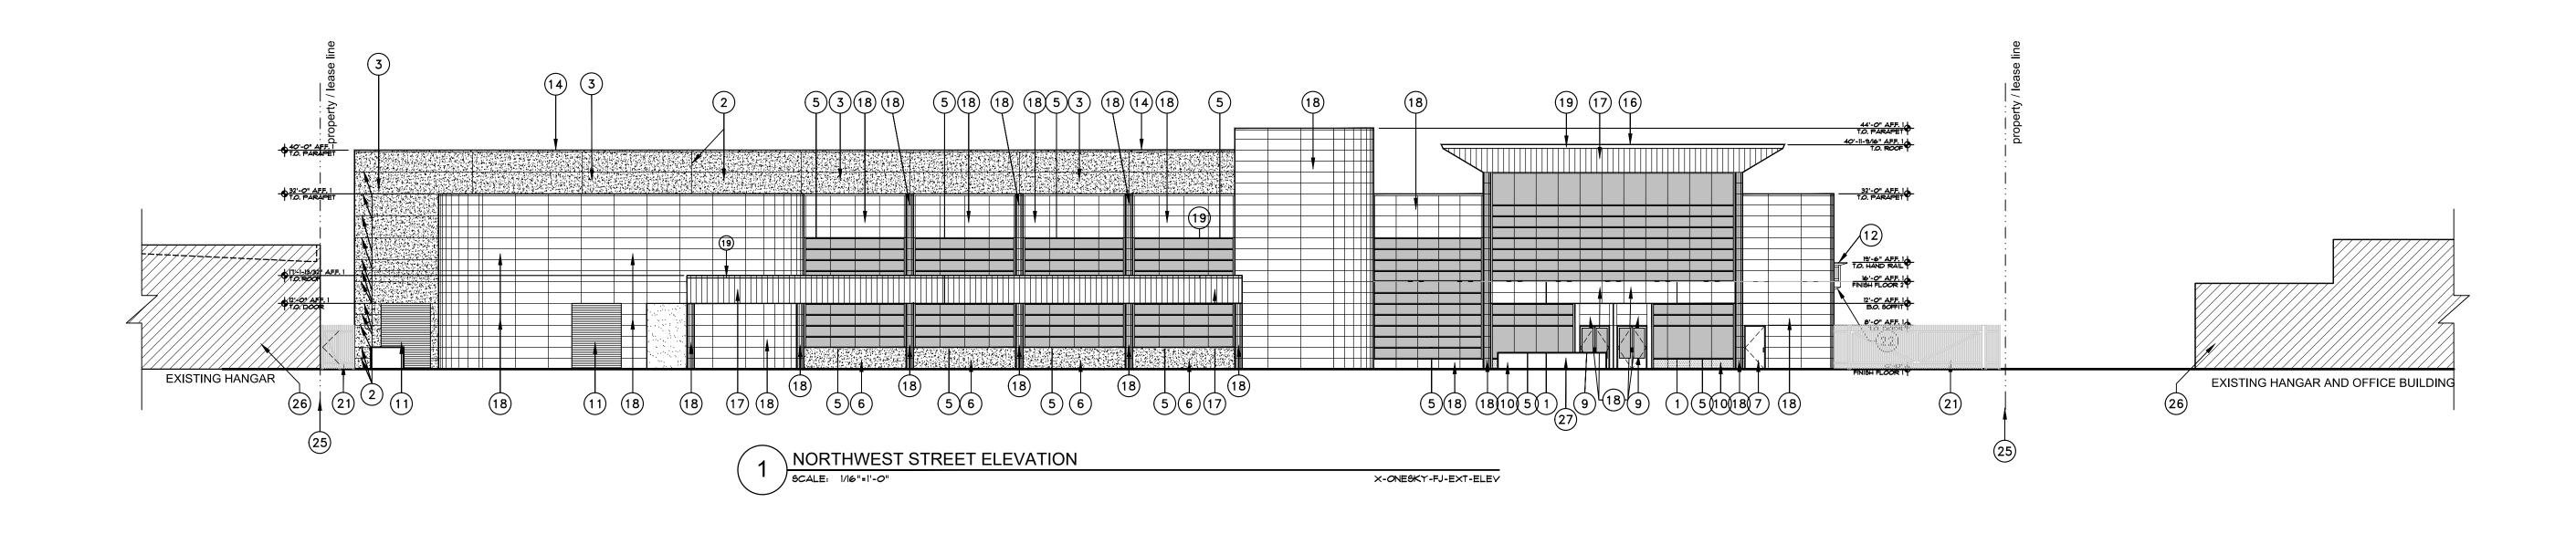


		EXTERIOR	FINISH COLOR AND PRODUCT SCHEDULE		
ITEM	DESCRIPTION & LOCATION	MANUFACTURER	PRODUCT, COLOR & STYLE	SIZE	NOTES
TILE-I	PORCELAIN TILE PAVER - FIELD	DAL-TILE	DIGNITARY, NOTABLE BEIGE, DRO9, TEXTURED	24×48	
TILE-2	PORCELAIN TILE PAVER - ACCENT	DAL-TILE	NOMINEE, TAUPE, NMII, MATTE	24×24	
PT-1	FIELD PAINT - EIFS	DUNN EDWARDS	TUSCAN MOSAIC - DE6208		LVR 26
PT-2	CONCRETE TILT PANEL PIGMENT	DAVIS COLORS	MESA BUFF		G.C. TO PROVIDE TEST SAMPLE
PT-3	ACCENT PAINT - METAL ELEMENTS	DUNN EDWARDS	LEGENDARY GRAY DE6369 - LOW SHEEN		LVR 18
PT-4	ACCENT PAINT - SECURITY GATE AND FENCING	DUNN EDWARDS	RHINOCEROS DE6327 - LOW SHEEN		LVR 18
MTL-1	METAL WALL PANELS	PPG	PPG - DURANAR, SUNSTORM, PEWTER, UC143423F		+/- LVR 18
MTL-2	METAL SOFFIT PANELS, FASCIA	PPG	PPG - DURANAR, SUNSTORM, WEATHERED ZINC, UC143428F		+/- LVR 18
STONE-1	NATURAL GRANITE STONE - BUILDING WALL BASE		DARK GREY, POLISHED GRANITE SLAB,	VARIES - SEE ELEVATION	SLAB TO BE SELECTED BY OWNER AND ARCHITECT
ROOF-1	STANDING SEAM METAL ROOFING	ATAS	2" FIELD LOK, MATCH PPG SUNSTORM WEATHERED ZINC	19 1/2" PANEL	+/- LVR 18
ROOF-2	TPO ROOFING	CARLIGLE	WHITE		
DOOR-I	ALUMINUM MAIN ENTRANCE DOORS	OLDCASTLE	MATCH PPG SUNSTORM PEWTER		
WINDOW-1	CURTAIN WALL WINDOW FRAME SYSTEM	OLDCASTLE	EXTERIOR MATCH PPG SUNSTORM PEWTER INTERIOR WHITE	6"	
GL-1	REFLECTIVE BUILDING GLASS	OLDCASTLE	MEDIUM GRAY- I" DUAL PAINT INSULATED GLASS		EXTERIOR RAILING GLASS TO BE THE SAME COLOR AND TINT

ELEVATION KEYED NOTES

WINDOW-1 GL-1	PRE-FINISHED MAN-DOOR IN HANGAR DOOR - BY HANGAR DOOR MANUFACTURER, FINISH TO MATCH HANGAR DOOR					
	(16) PRE-FINISHED STANDING SEAM METAL ROOF PANELS -	ROOF-1				
PT-I	17 PRE-FINISHED METAL SOFFIT PANELS	MTL-2				
	18) PRE-FINISHED METAL WALL PANELS	MTL-1				
PT-4	19 PRE-FINISHED METAL FASCIA PANELS	MTL-2				
WINDOW-1 GL-1	20 PRE-FINISHED HANGAR DOOR, PAINTED	PT-2				
	(21) 8' IRON SECURITY FENCE AND GATES, PAINTED -	PT-4				
PT-2	(22) METAL STUD FRAMED SOFFIT WITH EIFS STUCCO FINISH -	PT-1				
	23 NOT USED					
	24 STEEL PIPE COLUMN, PAINTED	PT-3				
	25) PROPERTY / LEASE LINE					
DOOR-1 GL-1	26 EXISTING BUILDINGS ON ADJACENT PROPERTY					
	27) CONCRETE PARKING LOT SCREEN WALL					
SISKE-I						





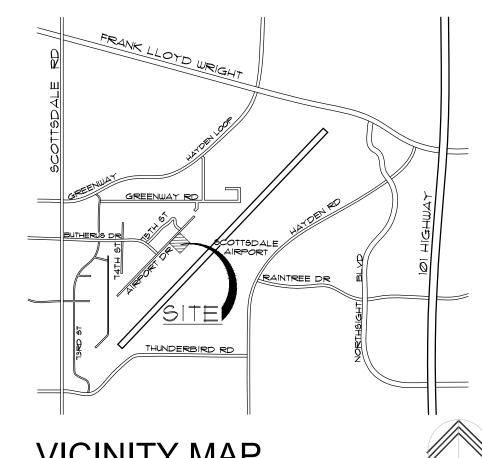

VICINITY MAP NOT TO SCALE

hillman

workshop

2901 e. highland ave

phoenix, az 85016

landscape architecture

PLANT SCHEDULE

SYMBOL	BOTANICAL NAME	COMMON NAME		SIZE	QTY	COMMENTS
	EXISTING TREES/CACTI					
	Existing Tree (To Remain)					
(•)						
V	TREES					
٠ ځ	Caesalpinia mexicana	Mexican Bird of Paradi	se	24" box/	4	Multi-Trunk
20	<i>></i>			1" cal.		Dense Canopy
				0.011.1	_	NA III T
7 / 1	Olneya tesota	Ironwood		36" box/ 2" cal.	5	Multi-Trunk Dense Canopy
	RELOCATED CACTI			Z Gai.		Denoe danopy
*	Relocated Ocotillo From Site				6	
	Relocated Saguaro From Site				6	
₹-	ACCENTS					
0	Agave parryi	Parry Agave	5 Gal.	50	As Pe	r Plan
0	Aloe 'Blue Elf'	'Blue Elf' Aloe	5 Gal.	116	As Pe	-
	Aloe Hercules	Aloe Hercules	24" Box	1	As Pe	
	Aloe Vera	Aloe (Yellow Flower)	5 Gal.	24	As Pe As Pe	
	Carnegiea gigantea Euphorbia antisyphilitica	Saguaro Candelilla	3', 4' & 5' 5 Gal.	9 37	As Pe As Pe	
. 🛈	Ferocactus wislizeni	Fishhook Barrel Cactus	5 Gal.	24	As Pe	
**	Hesperaloe 'Brakelights'	'Brakelights' Red Yucca	5 Gal.	9	As Pe	r Plan
*	Muhlenbergia 'Regal Mist'	'Regal Mist' Grass	5 Gal.	31	As Pe	r Plan
Θ	Opuntia rufida	'Blind' Prickly Pear	5 Gal.	12	As Pe	r Plan
	Pedilanthus bracteatus	Tall Slipper Plant	5 Gal.	12	As Pe	r Plan
	SHRUBS	T 1 01 1 D	501			Di
	Bougainvillea 'Torch Glow'	'Torch Glow' Bougainvillea	5 Gal.	13	As Pe	r Plan
	Callistemon 'Little John'	'Little John' Bottlebrush	5 Gal.	5	As Pe	
	Dodonaea viscosa	Hopseed Bush	5 Gal.	4	As Pe	r Plan
	Larrea tridentata	Creosote Bush	5 Gal.	14	As Pe	r Plan
	Justicia californica	Chuparosa	5 Gal.	24	As Pe	r Plan
\bigoplus	Leucophyllum langmaniae 'Lynns Legacy'	'Lynns Legacy' Sage	5 Gal.	36	As Pe	r Plan
	GROUND COVERS					
	Eremophila 'Outback Sunrise'	'Outback Sunrise' Emu	1-Gal	16	As Pe	r Plan
\oplus	Tetraneuris acaulis	Angelia Daisy	1-Gal	20	As Pe	r Plan
	MISCELLANEOUS					
DG	Decomposed Granite - (<u>Size:</u> 3 2" depth in all planting areas (t	8" Minus - <u>Color:</u> Mahogany Bro yp)	wn by RockP	ros)		
	Surface Select Granite Boulde 2', 3' & 4' Diameter	r		29		
	AREA CALCULATIONS					
	ONCITE LANDOCADE ADEA	0.677.CO.FT				

SCOTTSDALE LANDSCAPE NOTES

ONSITE LANDSCAPE AREA-

- 1. AREAS OF DECOMPOSED GRANITE WITHOUT PLANT MATERIAL/GROUNDCOVERS SHALL NOT EXCEED DIMENSIONS OF MORE THAN 7 FEET IN ANY ONE DIRECTION, MEASURED BETWEEN PLANT CANOPIES AND/OR COVERAGE. PROJECTS LOCATED WITHIN ELSO OR HD AREAS SHALL USE SALVAGED DESERT SURFACE SOIL IN LIEU OF DECOMPOSED GRANITE.
- 2. A MINIMUM OF 50 PERCENT OF THE PROVIDED TREES SHALL BE MATURE TREES, PURSUANT TO THE CITY OF SCOTTSDALE'S ZONING ORDINANCE ARTICLE X, SECTION 10.301, AS DEFINED IN THE CITY OF SCOTTSDALE'S ZONING ORDINANCE ARTICLE III, SECTION 3.100.

9,677 SQ FT

- 3. A SINGLE TRUNK TREE'S CALIPER SIZE, THAT IS TO BE EQUAL TO OR LESS THEN 4-INCHES, SHALL BE DETERMINED BY UTILIZING THE SMALLEST DIAMETER OF THE TRUNK 6-INCES ABOVE FINISHED GRADE ADJACENT TO THE TRUNK. A TREE'S CALIPER SIZE, FOR SINGLE TRUNK TREES THAT ARE TO HAVE A DIAMETER GREATER THAN 4-INCES, SHALL BE DETERMINED BY
- UTILIZING THE SMALLEST DIAMETER OF THE TRUNK 12-INCES ABOVE FINISHED GRADE ADJACENT TO THE TRUNK. A MULTIPLE TRUNK TREE'S CALIPER SIZE IS MEASURED AT 6-INCHES ABOVE THE LOCATION THAT THE TRUNK SPLITS ORIGINATES, OR 6-INCHES ABOVE FINISHED GRADE IF ALL TRUNKS ORIGINATE FROM THE SOIL.
- 4. AREA WITHIN THE SIGHT DISTANCE TRIANGLES IS TO BE CLEAR OF LANDSCAPING, SIGNS, OR OTHER VISIBILITY OBSTRUCTIONS WITH A HEIGHT GREATER THAN 2 FEET. TREES WITHIN THE SAFETY TRIANGLE SHALL HAVE A CANOPY THAT BEGINS AT 7 FEET IN HEIGHT UPON
- INSTALLATION. ALL HEIGHTS ARE MEASURED FROM NEAREST STREET LINE ELEVATION. RETENTION/DETENTION BASINS SHALL BE CONSTRUCTED SOLELY FROM THE APPROVED CIVIL PLANS. ANY ALTERATION OF THE APPROVED
- DESIGN (ADDITIONAL FILL, BOULDERS, ETC.) SHALL REQUIRE ADDITIONAL FINAL PLANS STAFF REVIEW AND APPROVAL. ALL RIGHTS-OF-WAY ADJACENT TO THIS PROJECT SHALL BE LANDSCAPED AND MAINTAINED BY THE PROPERTY OWNER. 7. PRIOR TO THE ESTABLISHMENT OF WATER SERVICE, NON-RESIDENTIAL PROJECTS WITH AN ESTIMATED ANNUAL WATER DEMAND OF TEN
- (10) ACRE-FEET OR MORE SHALL SUBMIT A CONSERVATION PLAN IN CONFORMANCE WITH SECTIONS 49-245 THROUGH 49-248 OF THE CITY CODE TO THE WATER CONSERVATION OFFICE.
- 8. TURF SHALL BE LIMITED TO THE MAXIMUM AREA SPECIFIED IN SECTIONS 49-245 THROUGH 29-248 OF THE CITY CODE AND SHALL BE SHOWN ON LANDSCAPE PLANS SUBMITTED AT THE TIME OF FINAL PLANS.
- 9. NO LIGHTING IS APPROVED WITH THE SUBMITTAL. 10. THE LANDSCAPE SPECIFICATION SECTION(S) OF THESE PLANS HAVE NOT BEEN REVIEWED AND SHALL NOT BE PART OF THE CITY OF
- SCOTTSDALE'S APPROVAL.
- 11. ALL SIGNS REQUIRE SEPARATE PERMITS AND APPROVALS.
- 12. NEW LANDSCAPING, INCLUDING SALVAGED PLANT MATERIAL, AND LANDSCAPING INDICATED TO REMAIN, WHICH IS DESTROYED, DAMAGED, OR EXPIRES DURING CONSTRUCTION SHALL BE REPLACED WITH LIKE SIZE, KIND, AND QUANTITY PRIOR TO THE ISSUANCE OF THE CERTIFICATE OF OCCUPANCY/LETTER OF ACCEPTANCE TO THE SATISFACTION OF THE INSPECTION SERVICES STAFF.
- 13. ALL REVEGETATED NAOS SHALL BE WATERED FOR 3 YEARS. AT THE END OF 3 YEARS, THE IRRIGATION SYSTEMS TO THE REVEGETATED NAOS SHALL BE PERMANENTLY DISCONNECTED.
- 14. NO IRRIGATION SHALL BE PROVIDED TO UNDISTURBED NATURAL AREA OPEN SPACE (NAOS) AREAS. 15. PROVIDE 8% SLOPE AWAY FROM WALK OR CURB FOR 5'-0" ALONG ALL STREETS.
- 16. SETBACK ALL SPRAY AND SPRAY TYPE IRRIGATION HEADS 1'-0" FROM BACK OF CURB OR SIDEWALK TO REDUCE OVERSPRAY.

03.25.24

Planting

L-1.0

1 of 1