



December 20, 2024

Scottsdale Water Campus New Laboratory Building

Pre-application Number: 298-PA-2024

Project Location: 8787 E Hualapai Dr, Scottsdale, AZ 85255

Lot Area: 90.73 acres

Project Area: 4.33 acres

Zone: O-S

Application Narrative

Introduction

Scottsdale Water – the city's municipal water utility – has provided drinking water and advanced water reclamation services to Scottsdale businesses and residents for over 50 years. The utility has been recognized as an industry leader with the Association of Metropolitan Water Agencies' Sustainable Water Utility Management Award – the highest industry recognition conferred to municipal water agencies – and as a Utility of the Future Today by the U.S. Environmental Protection Agency and its partners. The intent of the City of Scottsdale is to design and construct a new 19,000 sq ft Water Quality Laboratory adjacent to the existing administration building and upgraded parking to support the new building. The project is located at the Hualapai Campus at 8787 E Hualapai Drive, Scottsdale, AZ 85255.

This project has been designed in accordance with Section 1.904 of the Zoning Ordinance as follows:

1. The Board shall examine the design and theme of the application for consistency with the design and character components of the applicable guidelines, development standards, Design Standards and Policies Manual, master plans, character plan and General Plan

The proposed design incorporates character elements described in the Scottsdale General Plan. Additionally, the design team has been carefully guided by the Scottsdale Design Standards & Policies Manual Facility Standards for Capital Projects and the Office Design Guidelines. The Design team will continue to update the Facility Standards Checklist and

submit a copy of the checklist to the CPM Project Manager prior to 75% completion.
Specifications for the project include the Building Supplemental Instructions.

2. The architectural character, landscaping, and site design of the proposed development shall:

- a) Promote a desirable relationship of structures to one another, to open spaces and topography, both on the site and in the surrounding neighborhood.**

The proposed Laboratory building design includes features that resemble the existing Administration building design, including batten-seam metal mansard roofs and vertical shade fins. The stucco color was selected to match the color of the existing masonry walls. Raised planters with desert-colored stone veneer aid in bringing down the visual height of the new building, maintaining the proportions of the existing surrounding structures, and helping the building stay connected to the surrounding landscape.

No other buildings are in visual proximity to the proposed Laboratory building. An existing masonry site wall will be modified to connect and enclose the Water Campus at the west corner of the new laboratory. The new wall and secure gate will match the existing. The only surrounding neighborhood is the Grayhawk Condominiums north of Hualapai Dr. which also have a desert-style theme; though more modern in appearance and lighter in color to the water campus, the Laboratory building will maintain the current colors and textures of the existing water campus facility

- b) Avoid excessive variety and monotonous repetition.**

The proposed design hits the sweet spot between variety and repetition to create a pleasing blend of materials and shapes. The front façade includes mansard-style roofs, shade fins, and stucco walls resembling the existing admin building on the east and west sides, which are broken up in the middle by a metal panel wall extending beyond the roof to a vertical parapet.

- c) Recognize the unique climatic and other environmental factors of this region to respond to the Sonoran Desert environment, as specified in the Sensitive Design Principles**

The design team selected stucco, masonry, and metal materials that resemble the surrounding colors and textures found in the Sonoran Desert and the surrounding natural landscape. The shape of the building mirrors the shape of the existing topography and surrounding desert. The layout of the site includes a new sidewalk for pedestrian connection and new bicycle parking and EV charging stations will be provided to integrate alternative modes of transportation.

Building masses such as mansard roofs and landscaping provide shade and create a sense of human scale.

The building has been designed to include LEED principles to the greatest extent possible for this type of facility.

Each occupied space within the new Laboratory building is provided with ample access to natural light through the use of shaded windows to help reduce glare and conserve energy

d) Incorporate unique or characteristic architectural features, including building height, size, shape, color, texture, setback or architectural details, in the Historic Property Overlay District.

The Water Campus is located along a Scenic Corridor. The design of the new visitor parking lot honors this Scenic Corridor by providing landscape elements that enhance the streetscape appearance and provide views of natural features. This extra buffer has been incorporated into the parking layout as represented in the attached Streetscape Elevation. Site walls have been provided to block unwanted light pollution from the headlights of parked vehicles facing Hualapai Drive. Walkable access to the entrance of the Water Campus is also being provided via a new sidewalk connection to the public sidewalk along the drive. The proposed landscape design introduces trees and plants that help reduce the heat island effect, promote water conservation, and follow the requirements outlined in the Design Standards and Policies Manual. Additionally, native plants will be protected as shown in the attached Native Plant Inventory

e) Ingress, egress, internal traffic circulation, off-street parking facilities, loading and service areas and pedestrian ways shall be designed as to promote safety and convenience.

The proposed development enhances the ingress and egress from the site by adding an additional driveway along Hualapai. This increases the ease of flow through the visitor parking and reduces safety risks. A new sidewalk connecting the entrance to Hualapai enhances pedestrian circulation and striped ADA paths and ramps.

f) If provided, mechanical equipment, appurtenances and utilities, and their associated screening shall be integral to the building design.

All rooftop mechanical equipment is designed to be screened by either parapet walls or rooftop screen walls similar in color and material to the existing screen walls on the administrative building and surrounding buildings. A mechanical yard has been proposed behind the new lab building for all the new ground-mounted mechanical equipment, and it is protected by 12-foot-tall masonry walls. An electrical yard for the SES and generators has been provided and screened using a combination of masonry wall and metal screen wall. All mechanical and utility equipment has been located to avoid conflict with on-site circulation.

If you have any questions or concerns, feel free to contact us at:

Architect Contact

Bob Eardley
Project Architect
Arrington Watkins Architects
3003 N Central Ave, Suite 2400
Phoenix, AZ 85012
(480) 399-9230

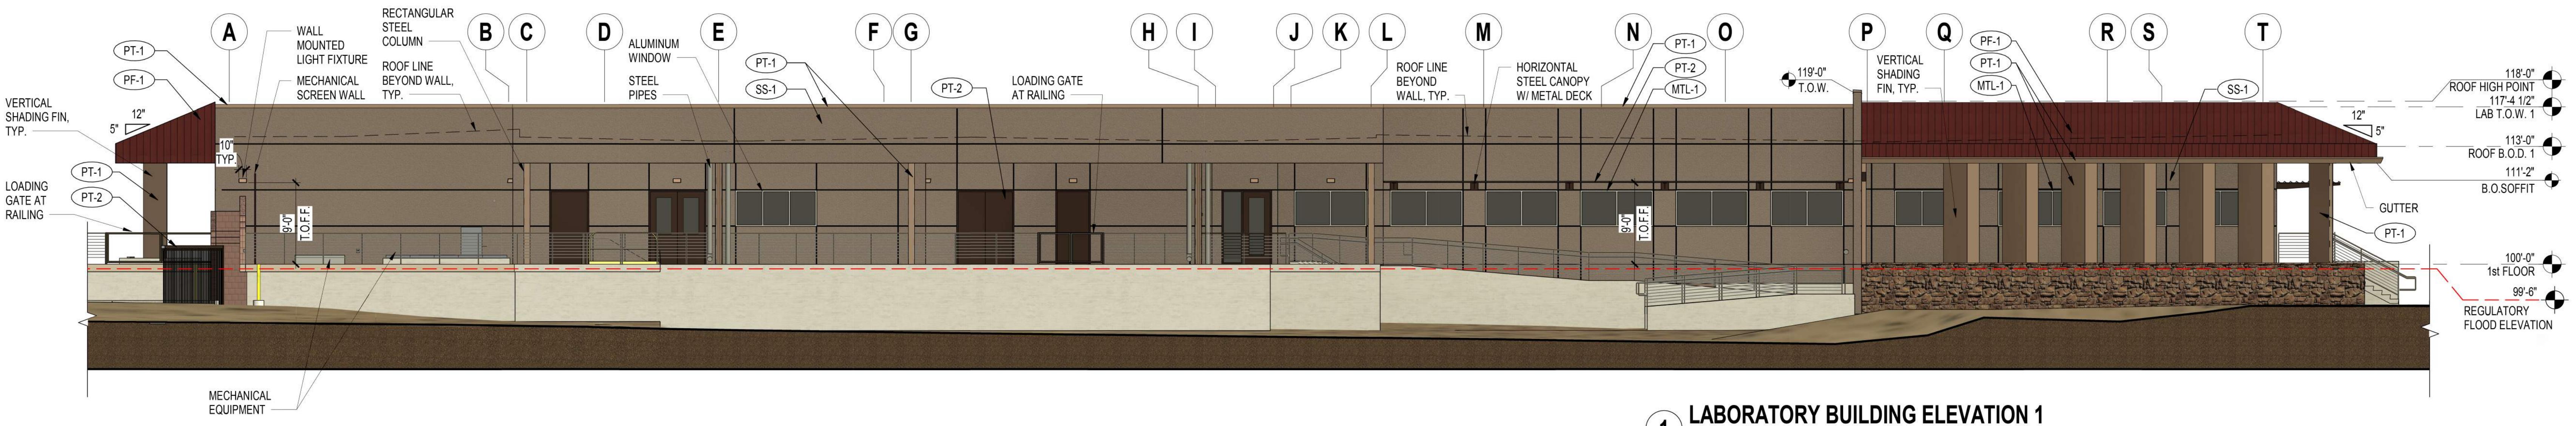
City of Scottsdale Contact

Nathan Crowell
Project Manager
City of Scottsdale
3939 N. Drinkwater Blvd.
Scottsdale, AZ 85251
(480) 312-2367


Best regards,
Arrington Watkins Architects




Bob Eardley
Project Architect

PRELIMINARY NOT
FOR CONSTRUCTIONScottsdale Water Campus
8787 E Hualapai Drive, Scottsdale, AZ 85255

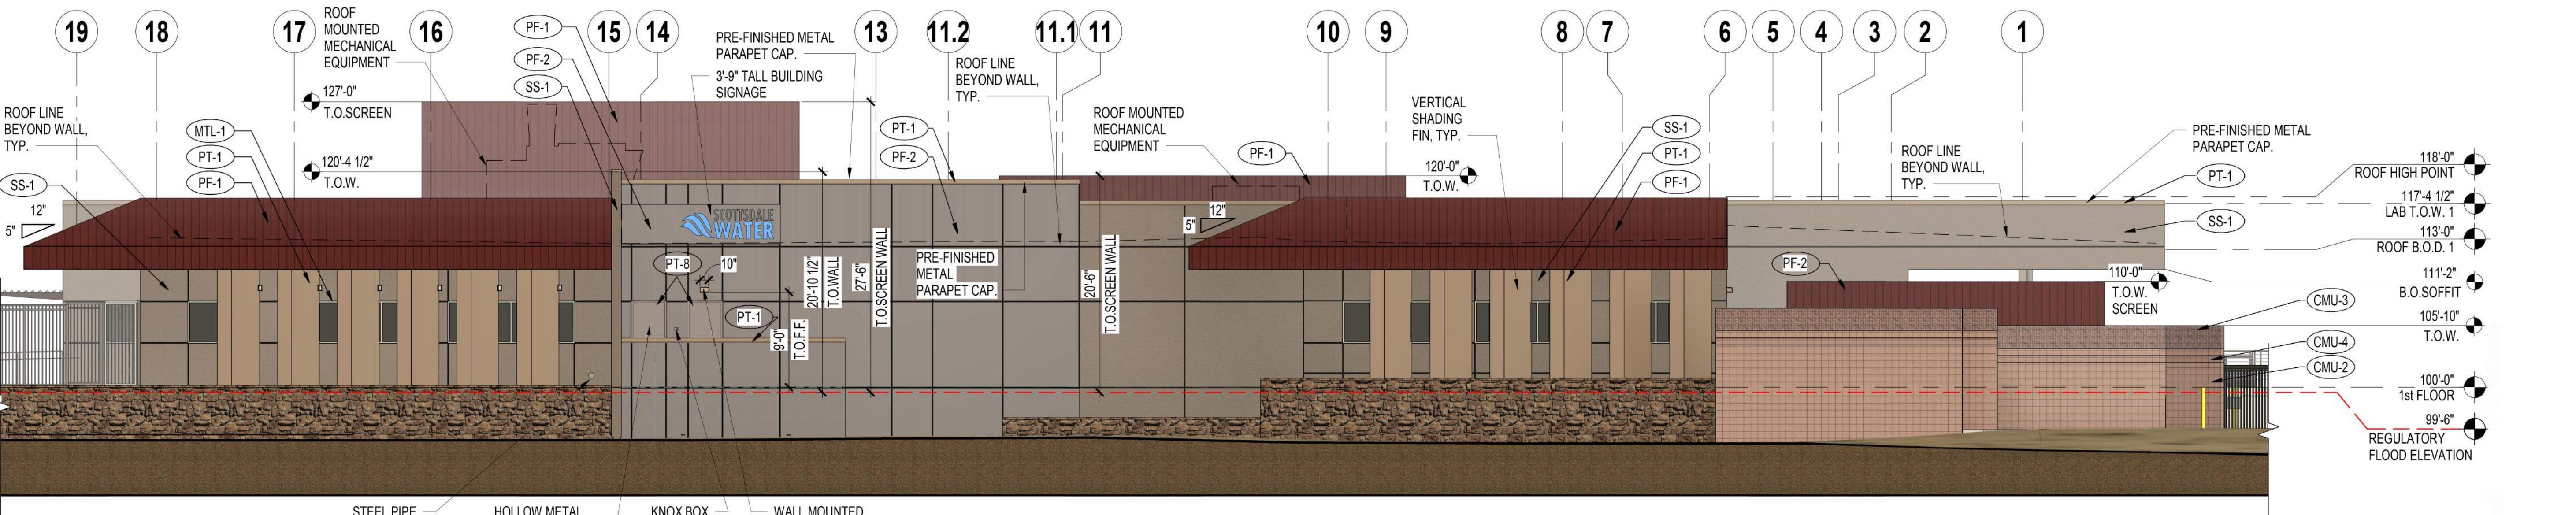
1 LABORATORY BUILDING ELEVATION 1
1/8" = 1'-0"



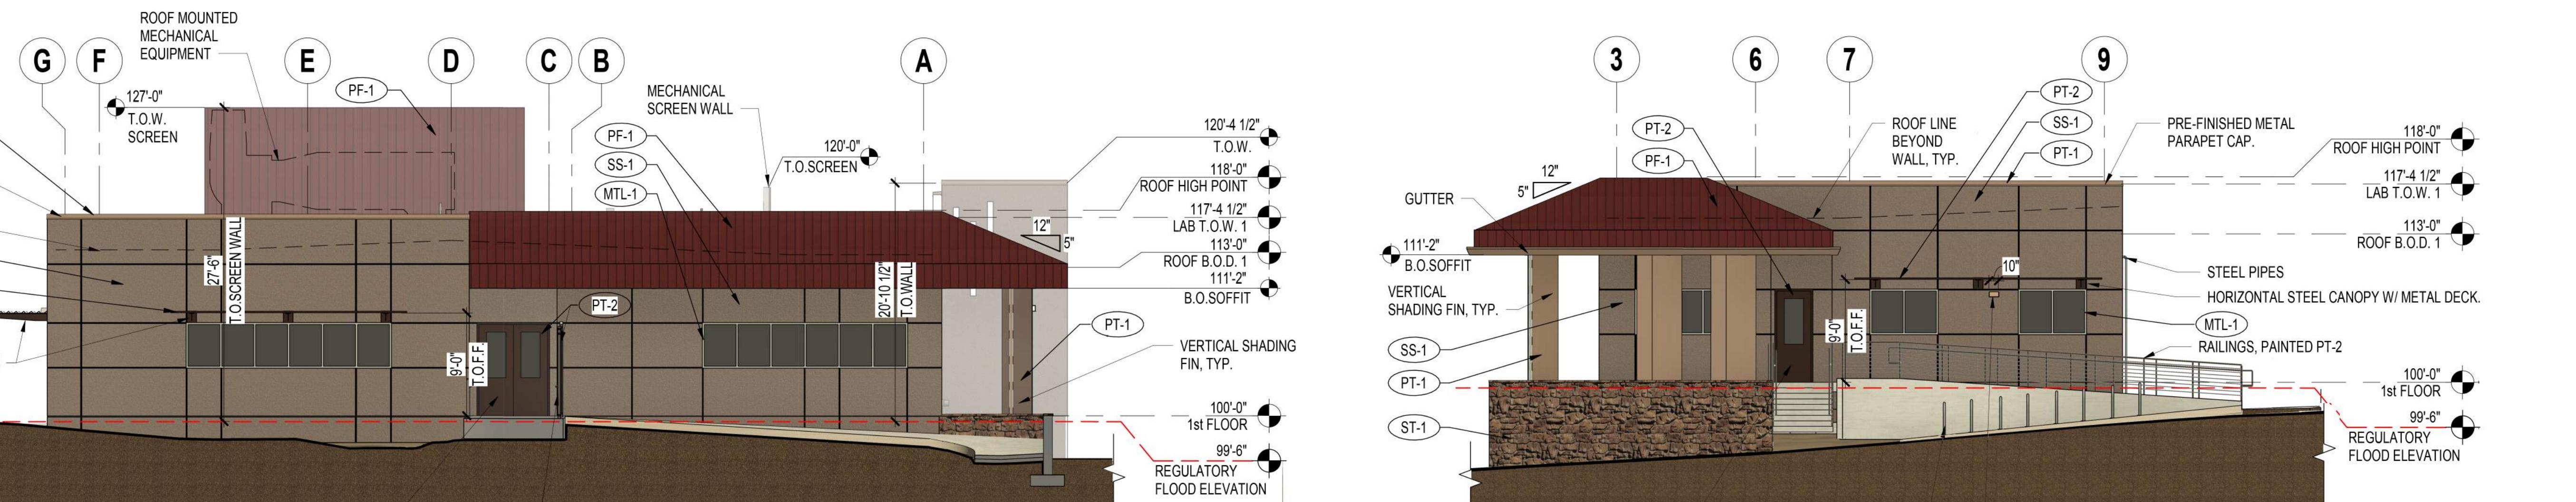
2 LABORATORY BUILDING ELEVATION 2
1/8" = 1'-0"



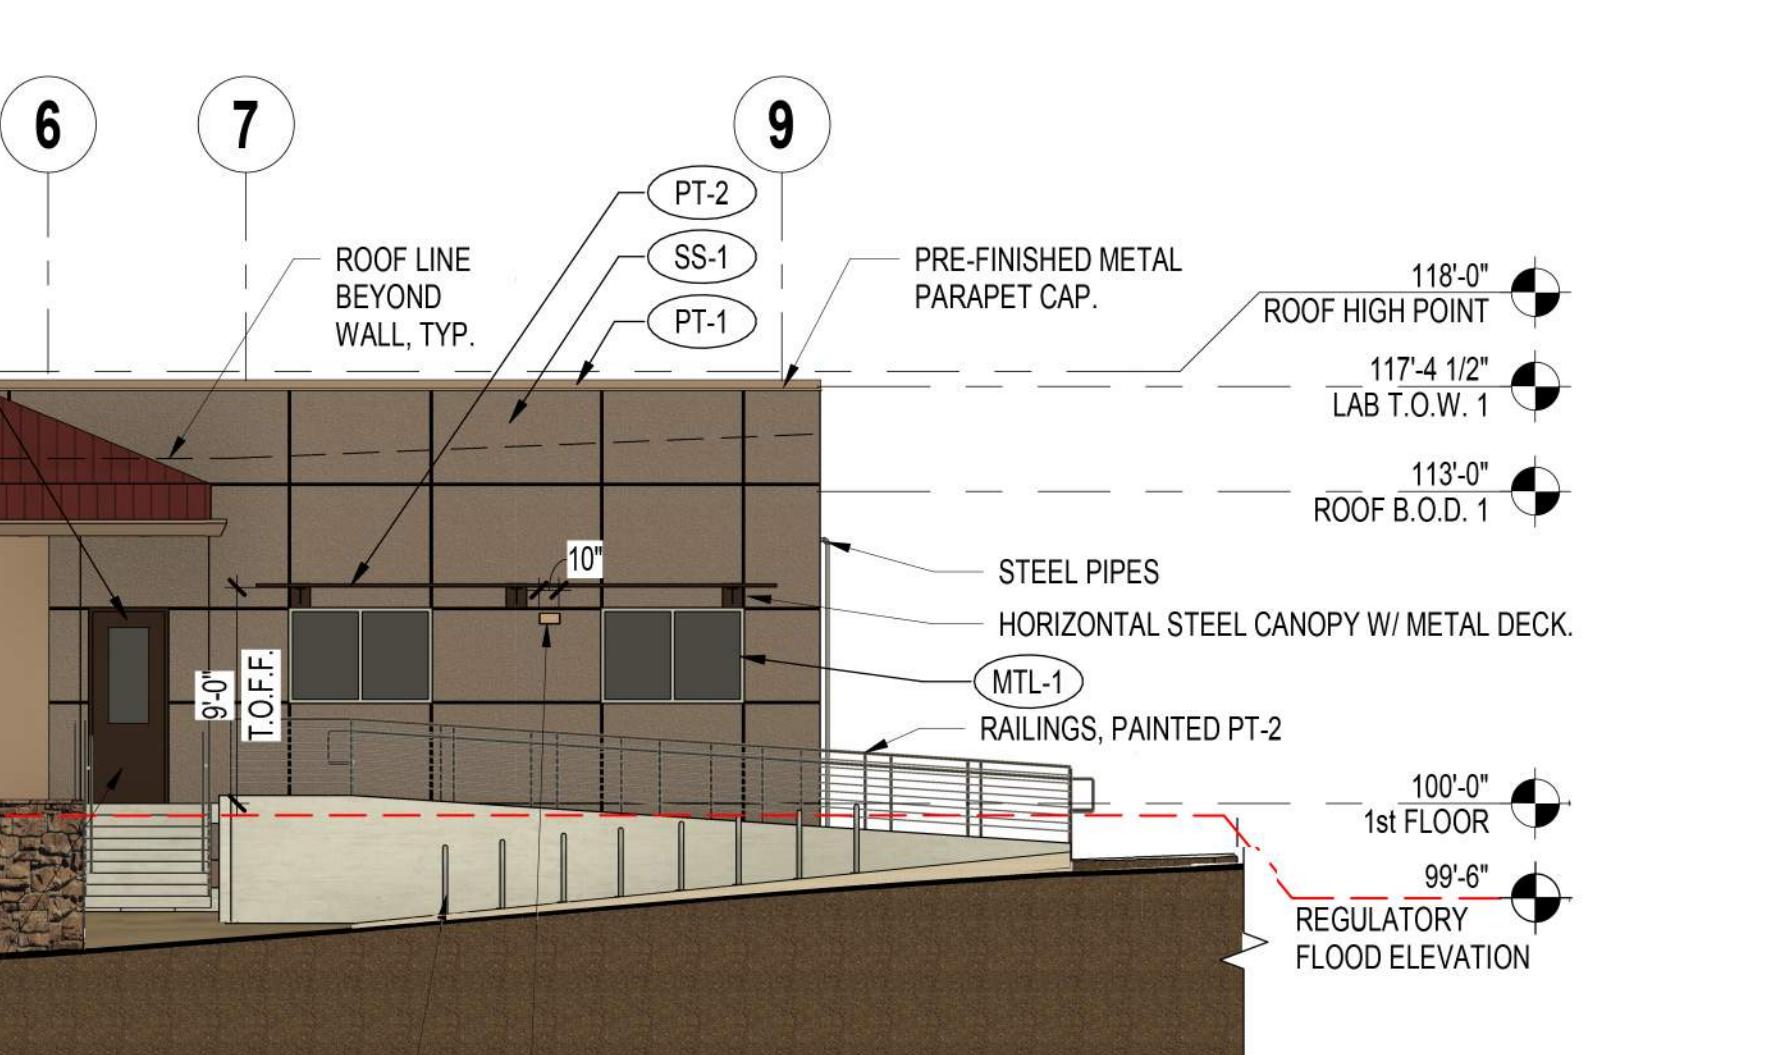4 LABORATORY BUILDING ELEVATION 4
1/8" = 1'-0"



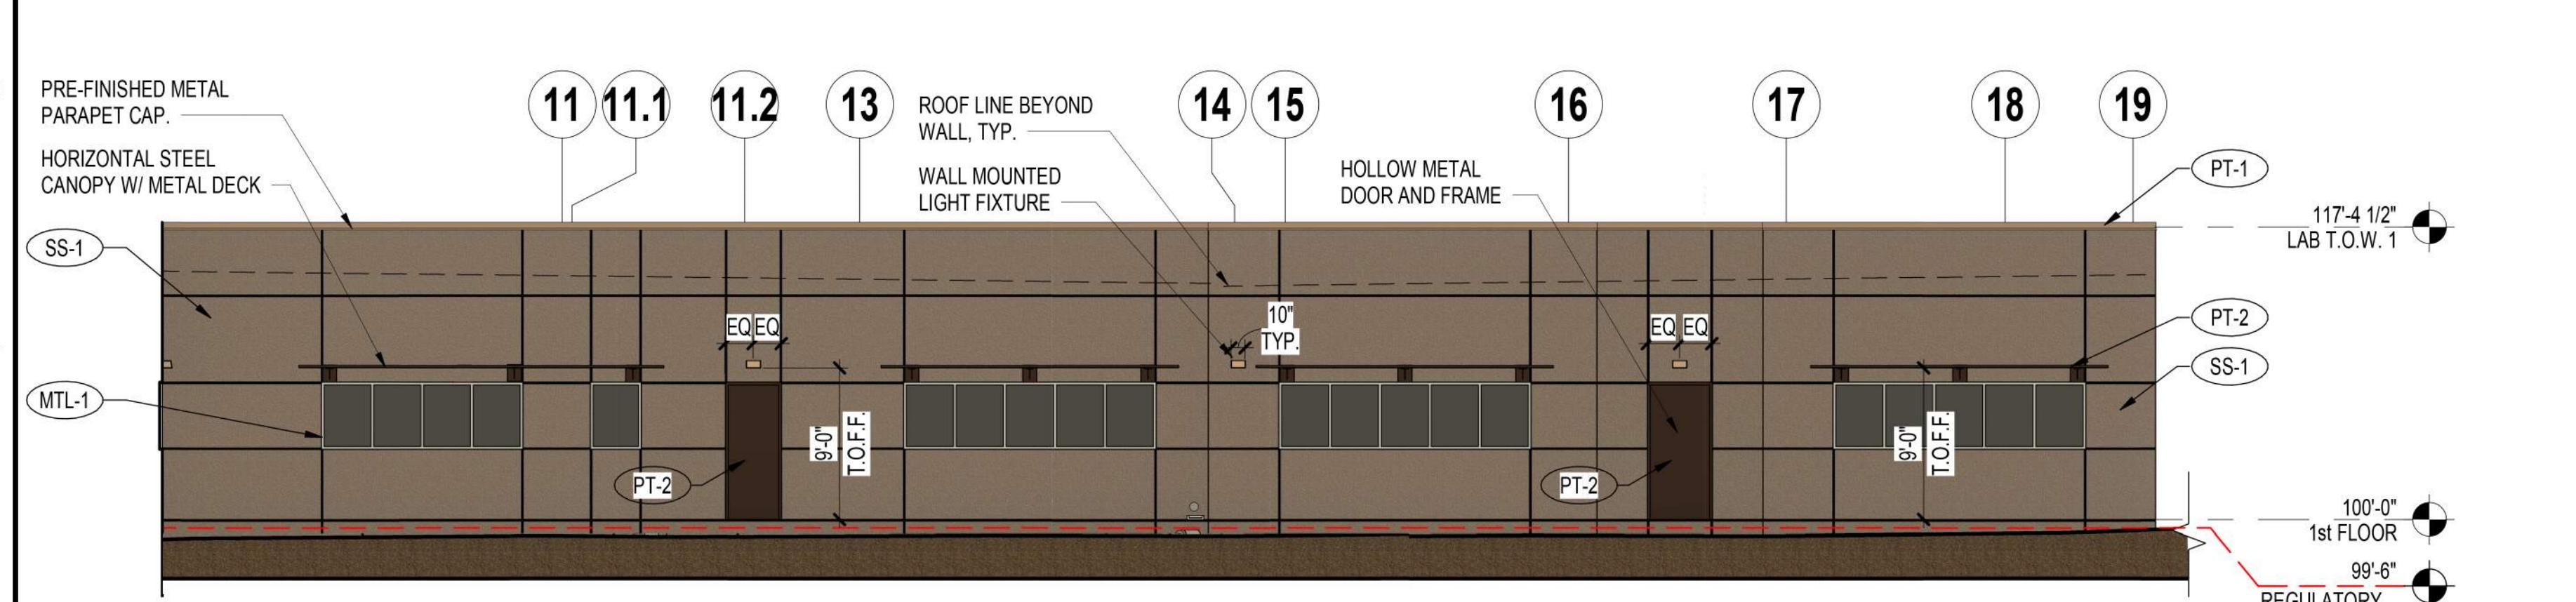3 LABORATORY BUILDING ELEVATION 3
1/8" = 1'-0"










5 LABORATORY BUILDING ELEVATION 5
1/8" = 1'-0"

| XXXX | | FINISH SCHEDULE - EXTERIOR | |
|-------|---|------------------------------|--|
| CODE | DESCRIPTION | MANUFACTURER | PRODUCT INFO |
| CMU-1 | CMU RUNNING BOND - 8"x8"x16" | ECHELON | INTEGRALLY COLORED - SMOOTH FACE - PLUM |
| CMU-2 | CMU RUNNING BOND - ONE SCORE - 8"x8"x16" | ECHELON | GROUND FACE - TRENDSTONE - PURPLE HART |
| CMU-3 | CMU RUNNING BOND - FLUTED BOND (FL1S DCBB*) - 9"x8"x16" | ECHELON | INTEGRALLY COLORED - SPLIT FACE - PURPLE HART |
| CMU-4 | CMU RUNNING BOND - ONE SCORE - 12"x8"x16" | ECHELON | INTEGRALLY COLORED - SPLIT FACE - PURPLE HART |
| MTL-1 | ANODIZED ALUMINUM FRAME | OLDCASTLE BUILDING ENVELOPE | 215 CLEAR CLASS |
| PF-1 | BOARD & BATTEEN, INSULATED METAL PANEL | WESTERN STATES METAL ROOFING | BATTEN SEAM METAL ROOF - WEATHERED RUSTIC |
| PF-2 | METAL COMPOSITE MATERIAL PANEL | ATAS | STERRACORE PANEL - CLIP & SEAL - ASH GREY (33) |
| PT-1 | PAINT - EXTERIOR | DUNN EDWARDS | SEMI-GLOSS - DE6040 CAVE OF THE WINDS |
| PT-2 | PAINT - EXTERIOR | DUNN EDWARDS | SEMI-GLOSS - DEA161 WILD MUSTANG |
| PT-8 | PAINT - EXTERIOR - HM DOOR PANEL / FRAME | DUNN EDWARDS | SEMI-GLOSS - DE6060 TWILIGHT TAUPE |
| SS-1 | COMMERCIAL CEMENT PLASTER 3 | DRYVIT | 306 SWISS MOCHA - 533 SANDBLAST FINISH |
| ST-1 | MANUFACTURED STONE VENEER | APACHE STONE | DRESSED FIELDSTONE - SEVILLA |

| | | |
|----------------------------------|----------|------|
| NO. | REVISION | DATE |
| PROJECT NO.: 2021.067 | | |
| DATE: 12/23/2024 | | |
| DESIGNED BY: | | |
| DRAWN BY: | | |
| APPROVED BY: | | |
| SHEET TITLE: EXTERIOR ELEVATIONS | | |
| SHEET NUMBER: FIG-40.1 | | |

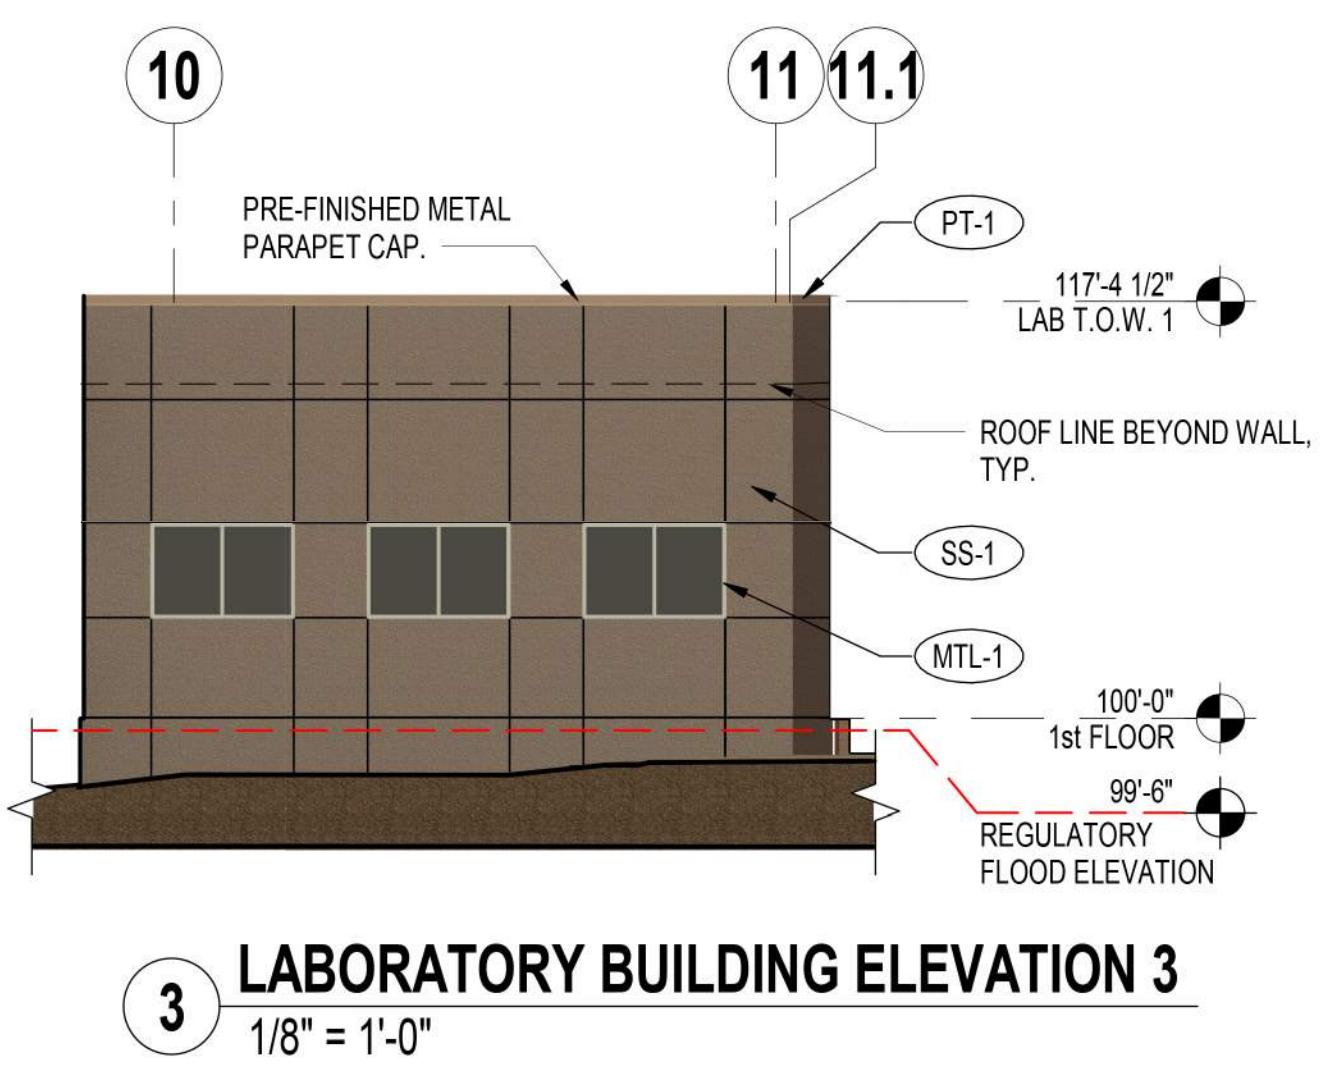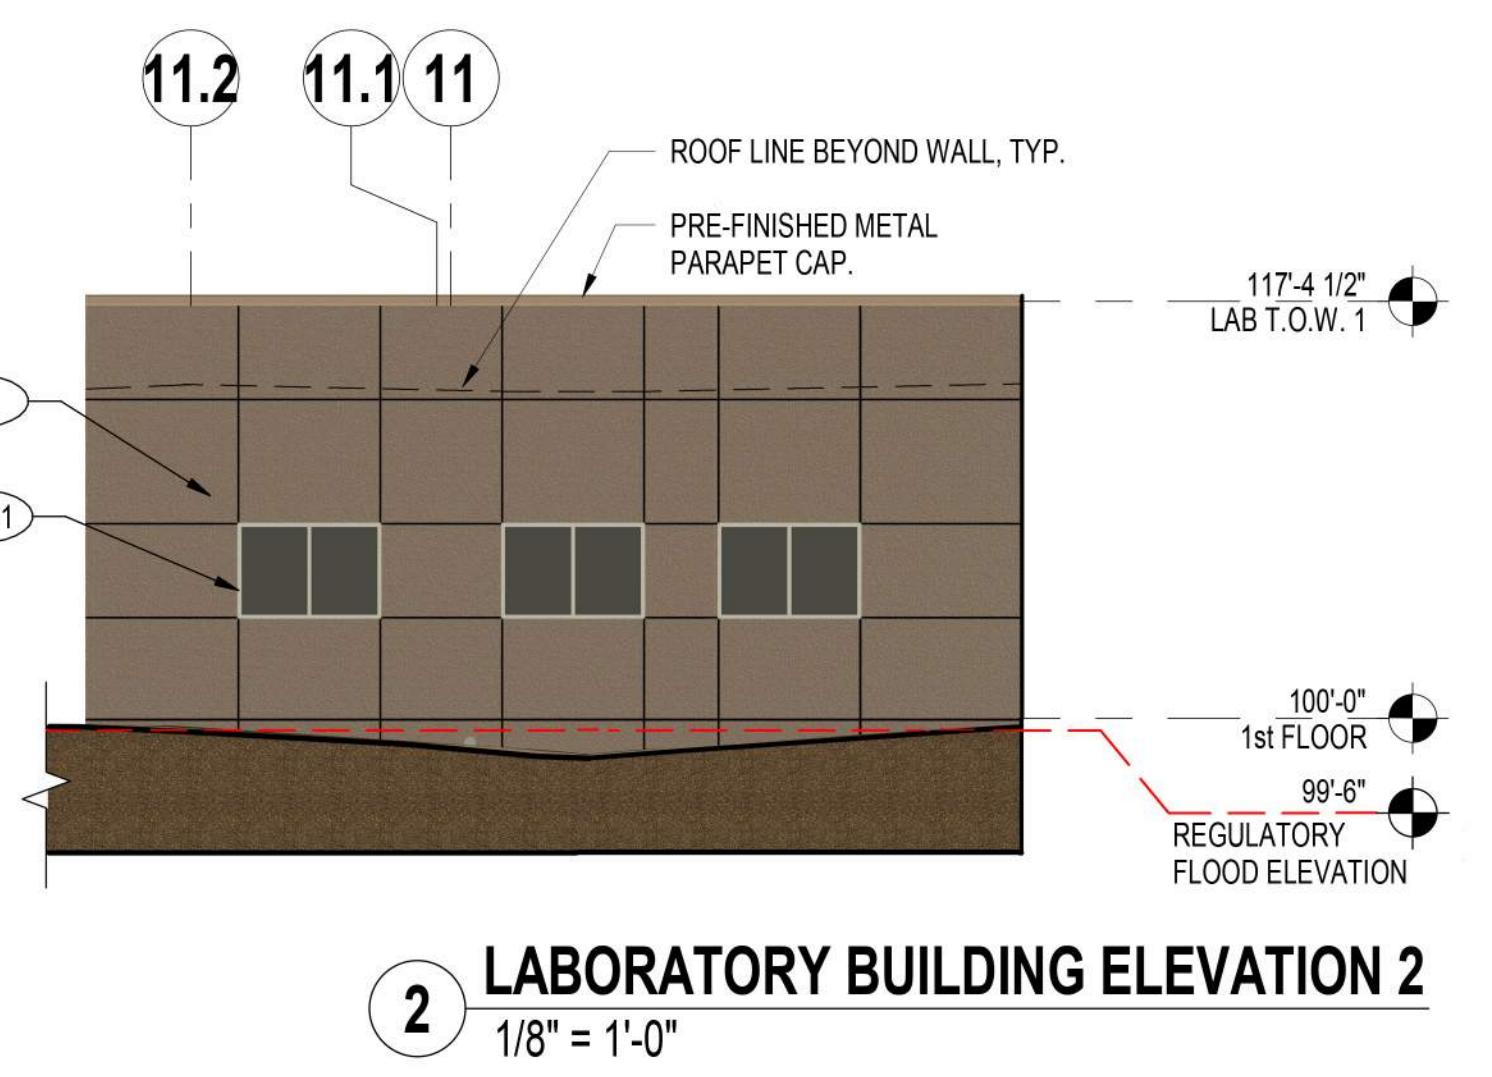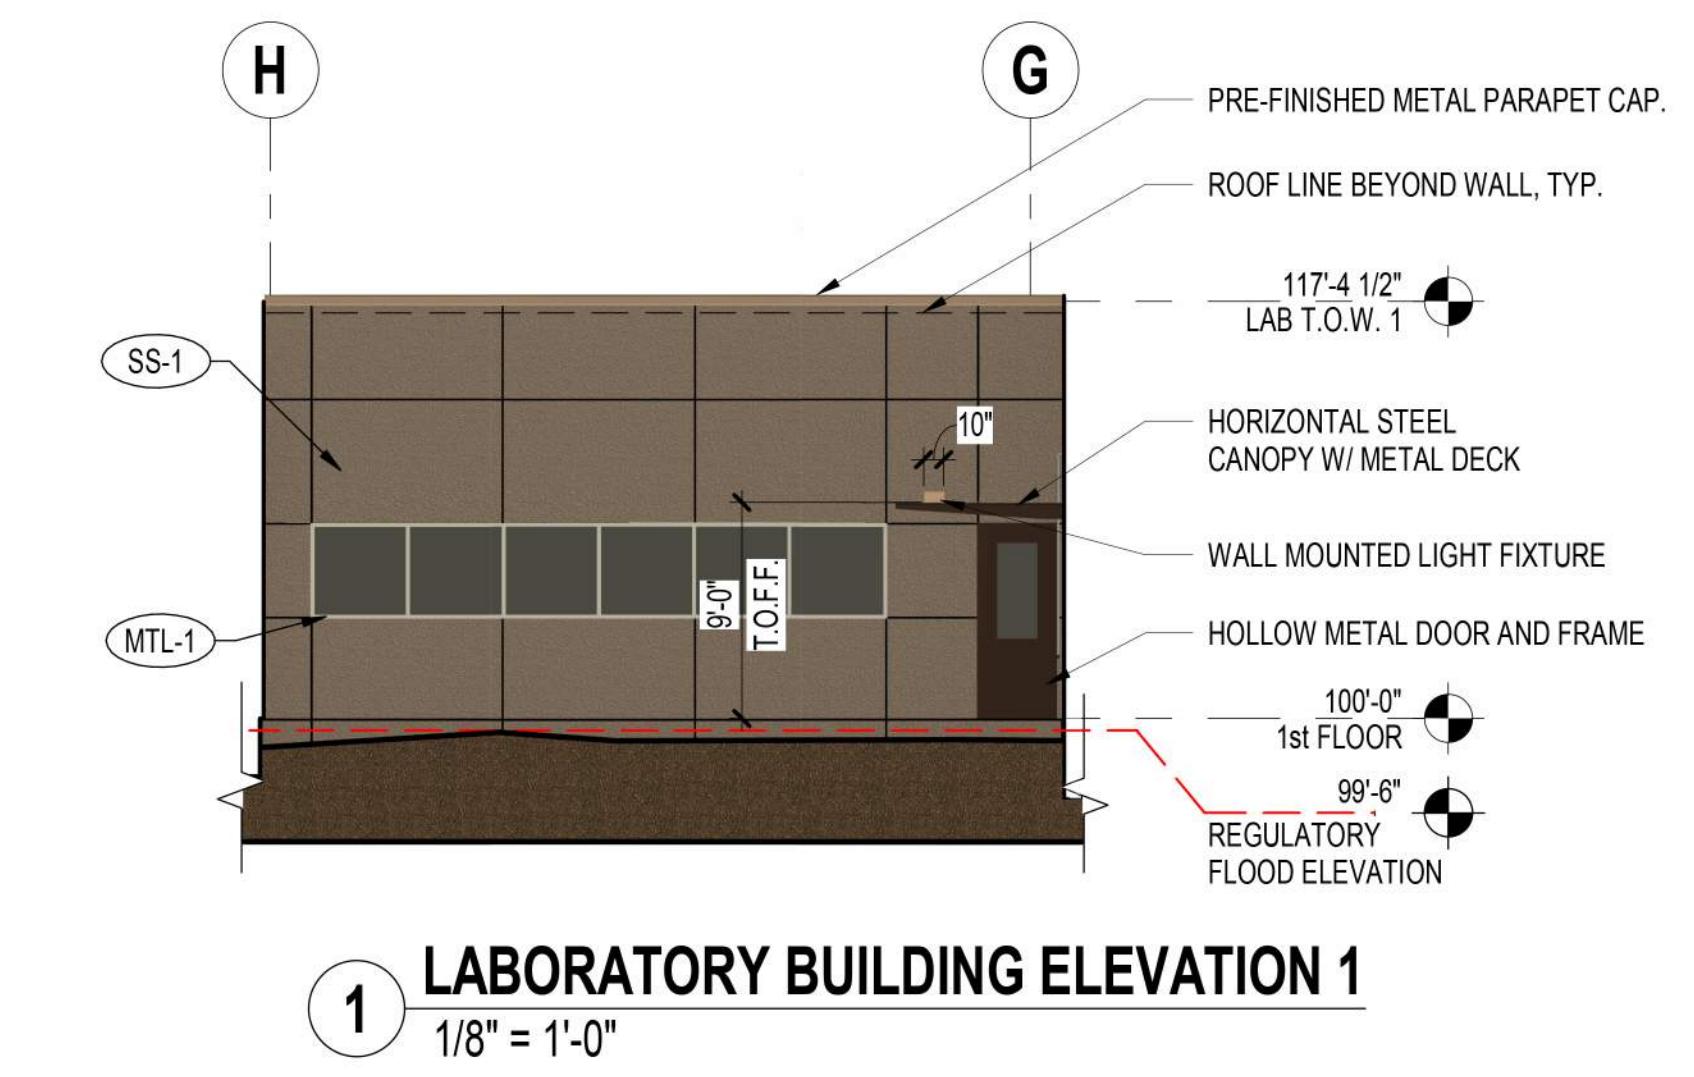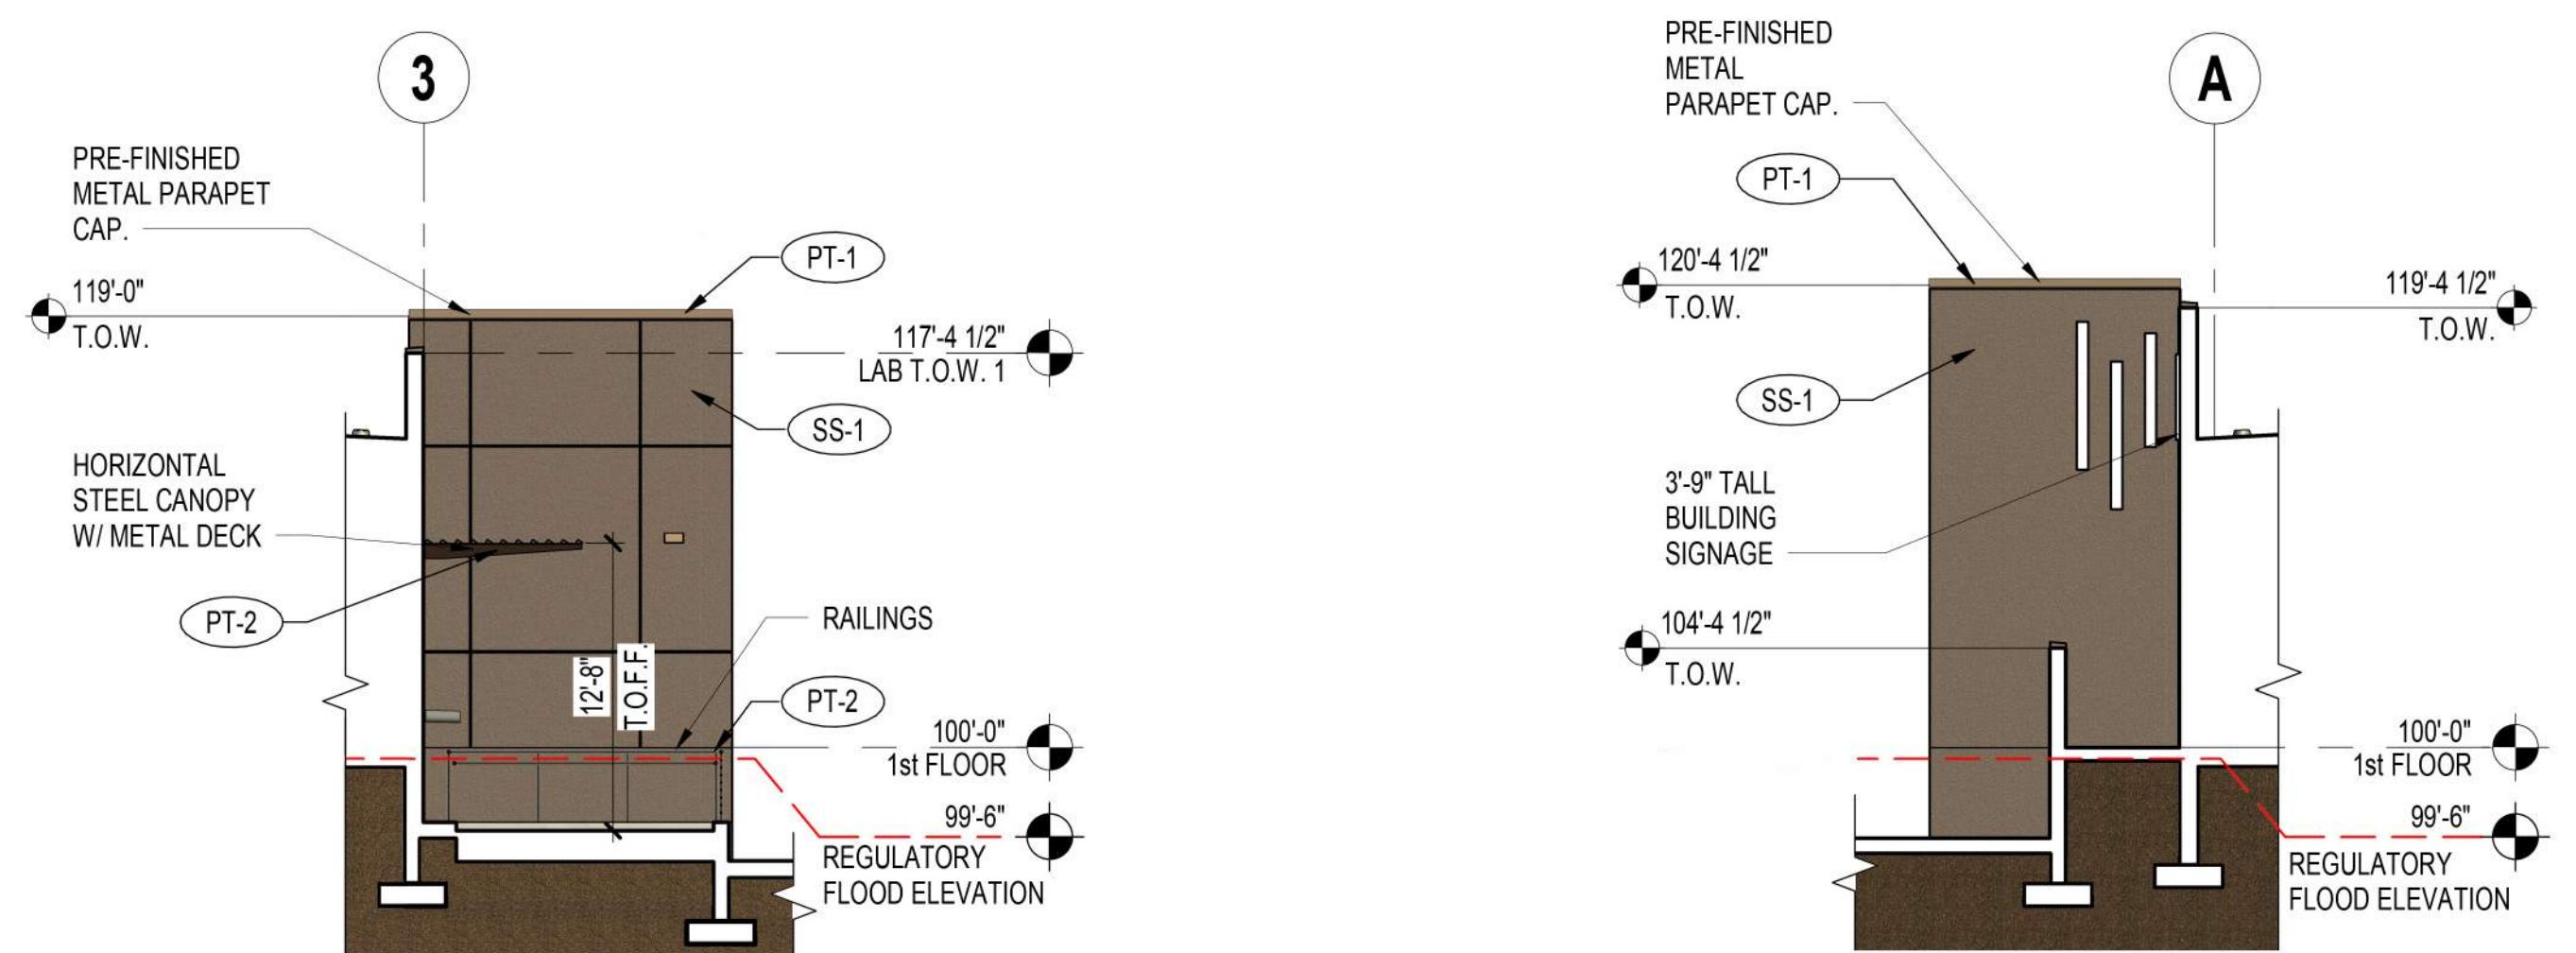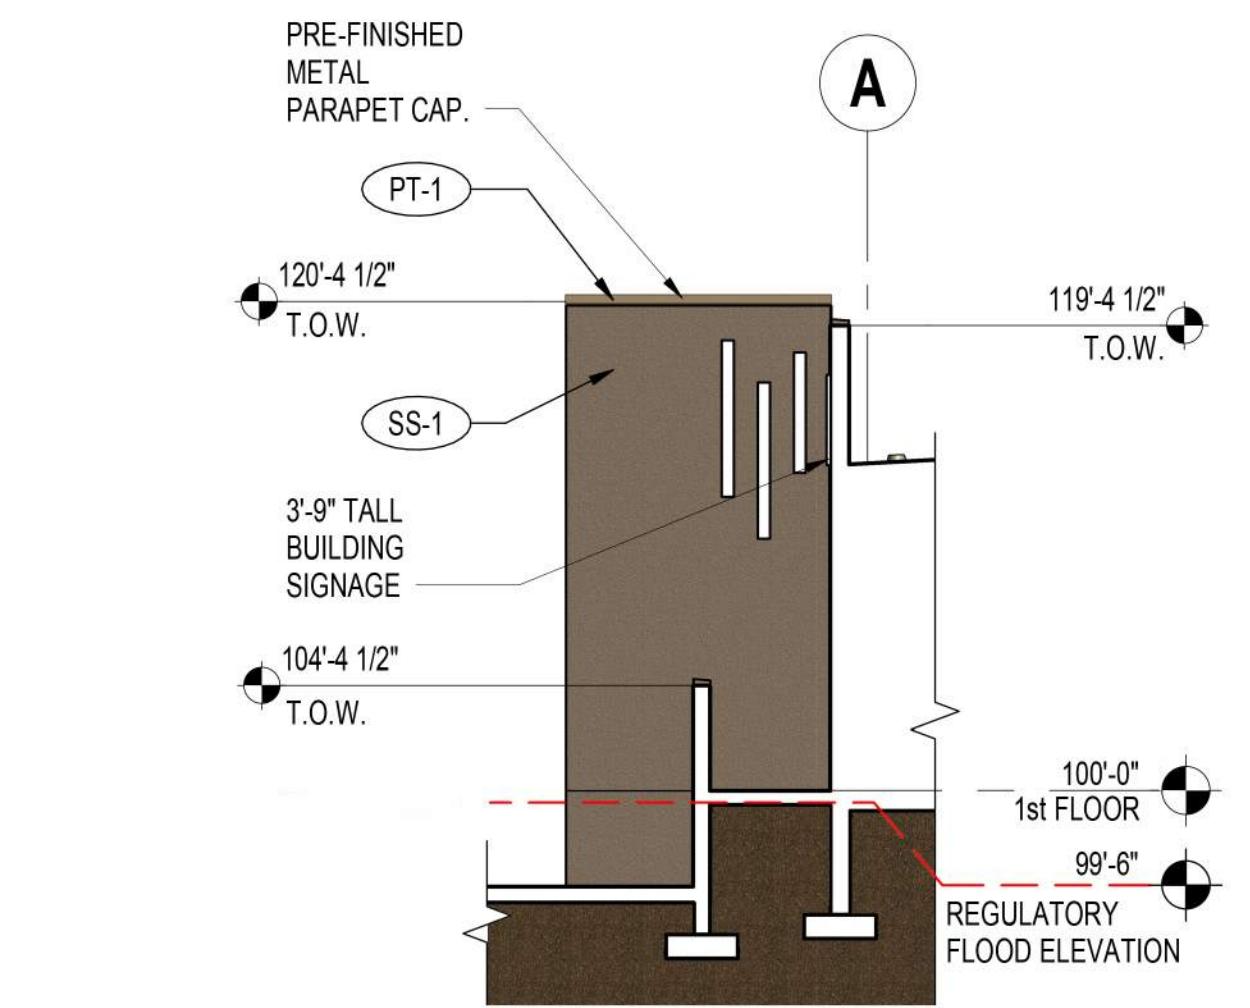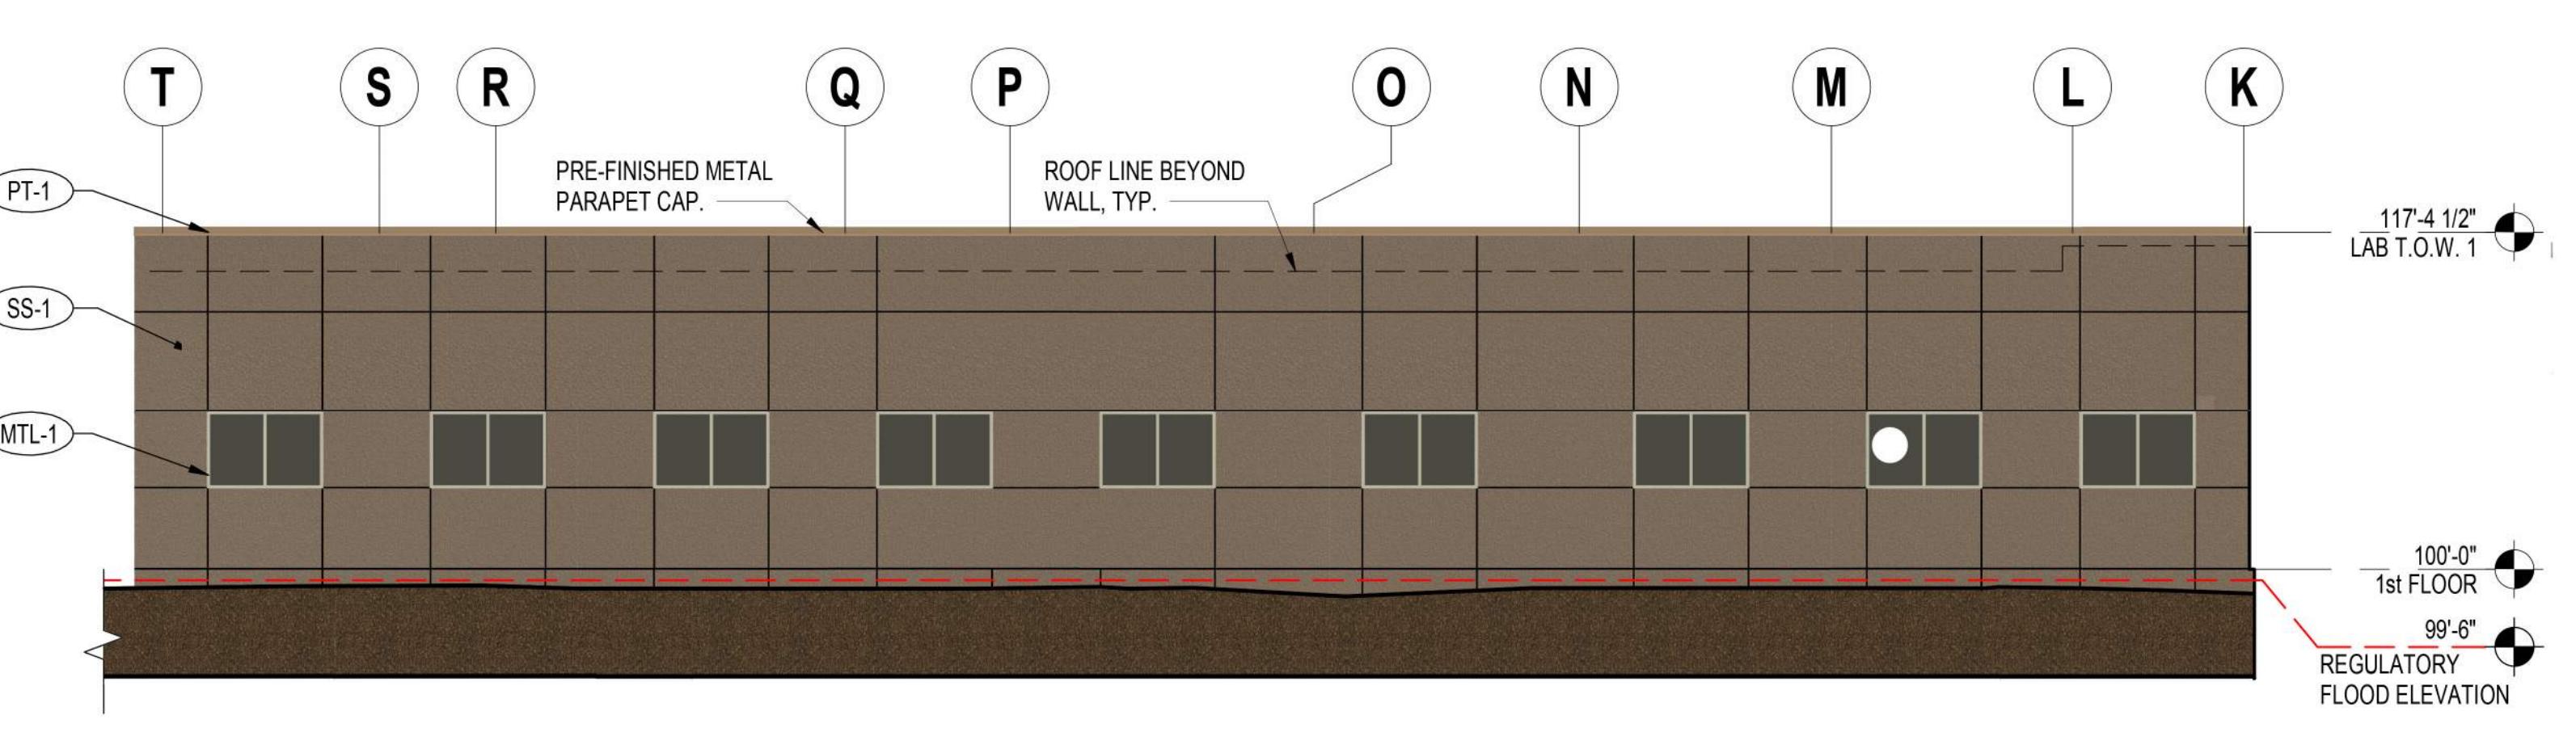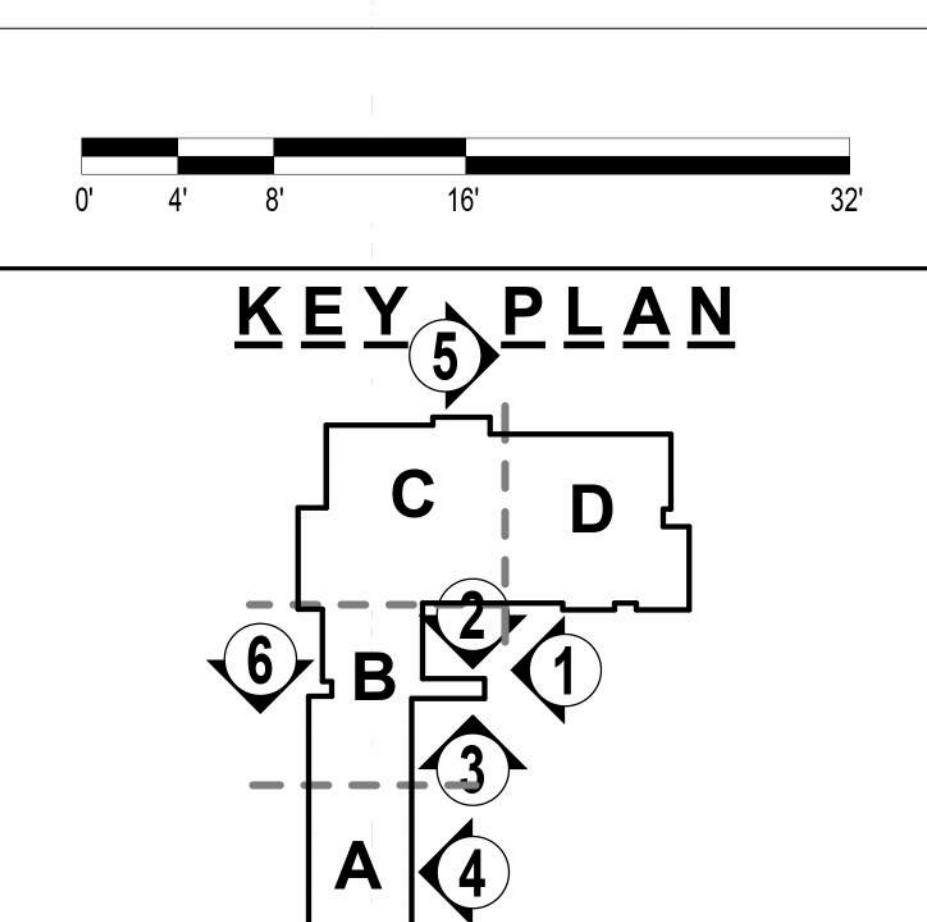PRELIMINARY NOT FOR CONSTRUCTION

Scottsdale Water Campus
8787 E Hualapai Drive, Scottsdale, AZ 852553 LABORATORY BUILDING ELEVATION 3
1/8" = 1'-0"2 LABORATORY BUILDING ELEVATION 2
1/8" = 1'-0"1 LABORATORY BUILDING ELEVATION 1
1/8" = 1'-0"6 LABORATORY BUILDING ELEVATION 6
1/8" = 1'-0"5 LABORATORY BUILDING ELEVATION 5
1/8" = 1'-0"4 LABORATORY BUILDING ELEVATION 4
1/8" = 1'-0"

| NO. | REVISION | DATE |
|---------------------|------------|------|
| PROJECT NO.: | 2021.067 | |
| DATE: | 12/23/2024 | |
| DESIGNED BY: | | |
| DRAWN BY: | | |
| APPROVED BY: | | |
| SHEET TITLE: | | |
| EXTERIOR ELEVATIONS | | |
| SHEET NUMBER: | | |
| FIG-40.2 | | |

| XXX | | FINISH SCHEDULE - EXTERIOR | |
|-------|---|------------------------------|--|
| CODE | DESCRIPTION | MANUFACTURER | PRODUCT INFO |
| CMU-1 | CMU RUNNING BOND - 8"x8"x16" | ECHELON | INTEGRALLY COLORED - SMOOTH FACE - PLUM |
| CMU-2 | CMU RUNNING BOND - ONE SCORE - 8"x8"x16" | ECHELON | GROUND FACE - TRENDSTONE - PURPLE HART |
| CMU-3 | CMU RUNNING BOND - FLUTED BOND (FL1S DCBB*) - 9"x8"x16" | ECHELON | INTEGRALLY COLORED - SPLIT FACE - PURPLE HART |
| CMU-4 | CMU RUNNING BOND - ONE SCORE - 12"x8"x16" | ECHELON | INTEGRALLY COLORED - SPLIT FACE - PURPLE HART |
| MTL-1 | ANODIZED ALUMINUM FRAME | OLDCASTLE BUILDING ENVELOPE | 215 CLEAR CLASS |
| PF-1 | BOARD & BATTEEN, INSULATED METAL PANEL | WESTERN STATES METAL ROOFING | BATTEN SEAM METAL ROOF - WEATHERED RUSTIC |
| PF-2 | METAL COMPOSITE MATERIAL PANEL | ATAS | STERRACORE PANEL - CLIP & SEAL - ASH GREY (33) |
| PT-1 | PAINT - EXTERIOR | DUNN EDWARDS | SEMI-GLOSS - DE6040 CAVE OF THE WINDS |
| PT-2 | PAINT - EXTERIOR | DUNN EDWARDS | SEMI-GLOSS - DEA161 WILD MUSTANG |
| PT-8 | PAINT - EXTERIOR - HM DOOR PANEL / FRAME | DUNN EDWARDS | SEMI-GLOSS - DE6060 TWILIGHT TAUPE |
| SS-1 | COMMERCIAL CEMENT PLASTER 3 | DRYVIT | 306 SWISS MOCHA - 533 SANDBLAST FINISH |
| ST-1 | MANUFACTURED STONE VENEER | APACHE STONE | DRESSED FIELDSTONE - SEVILLA |



Arrington Watkins Architects

3003 N Central Ave, Suite 2400
Phoenix, Arizona 85012
Telephone: (602) 279-4373
Fax: (602) 279-9110

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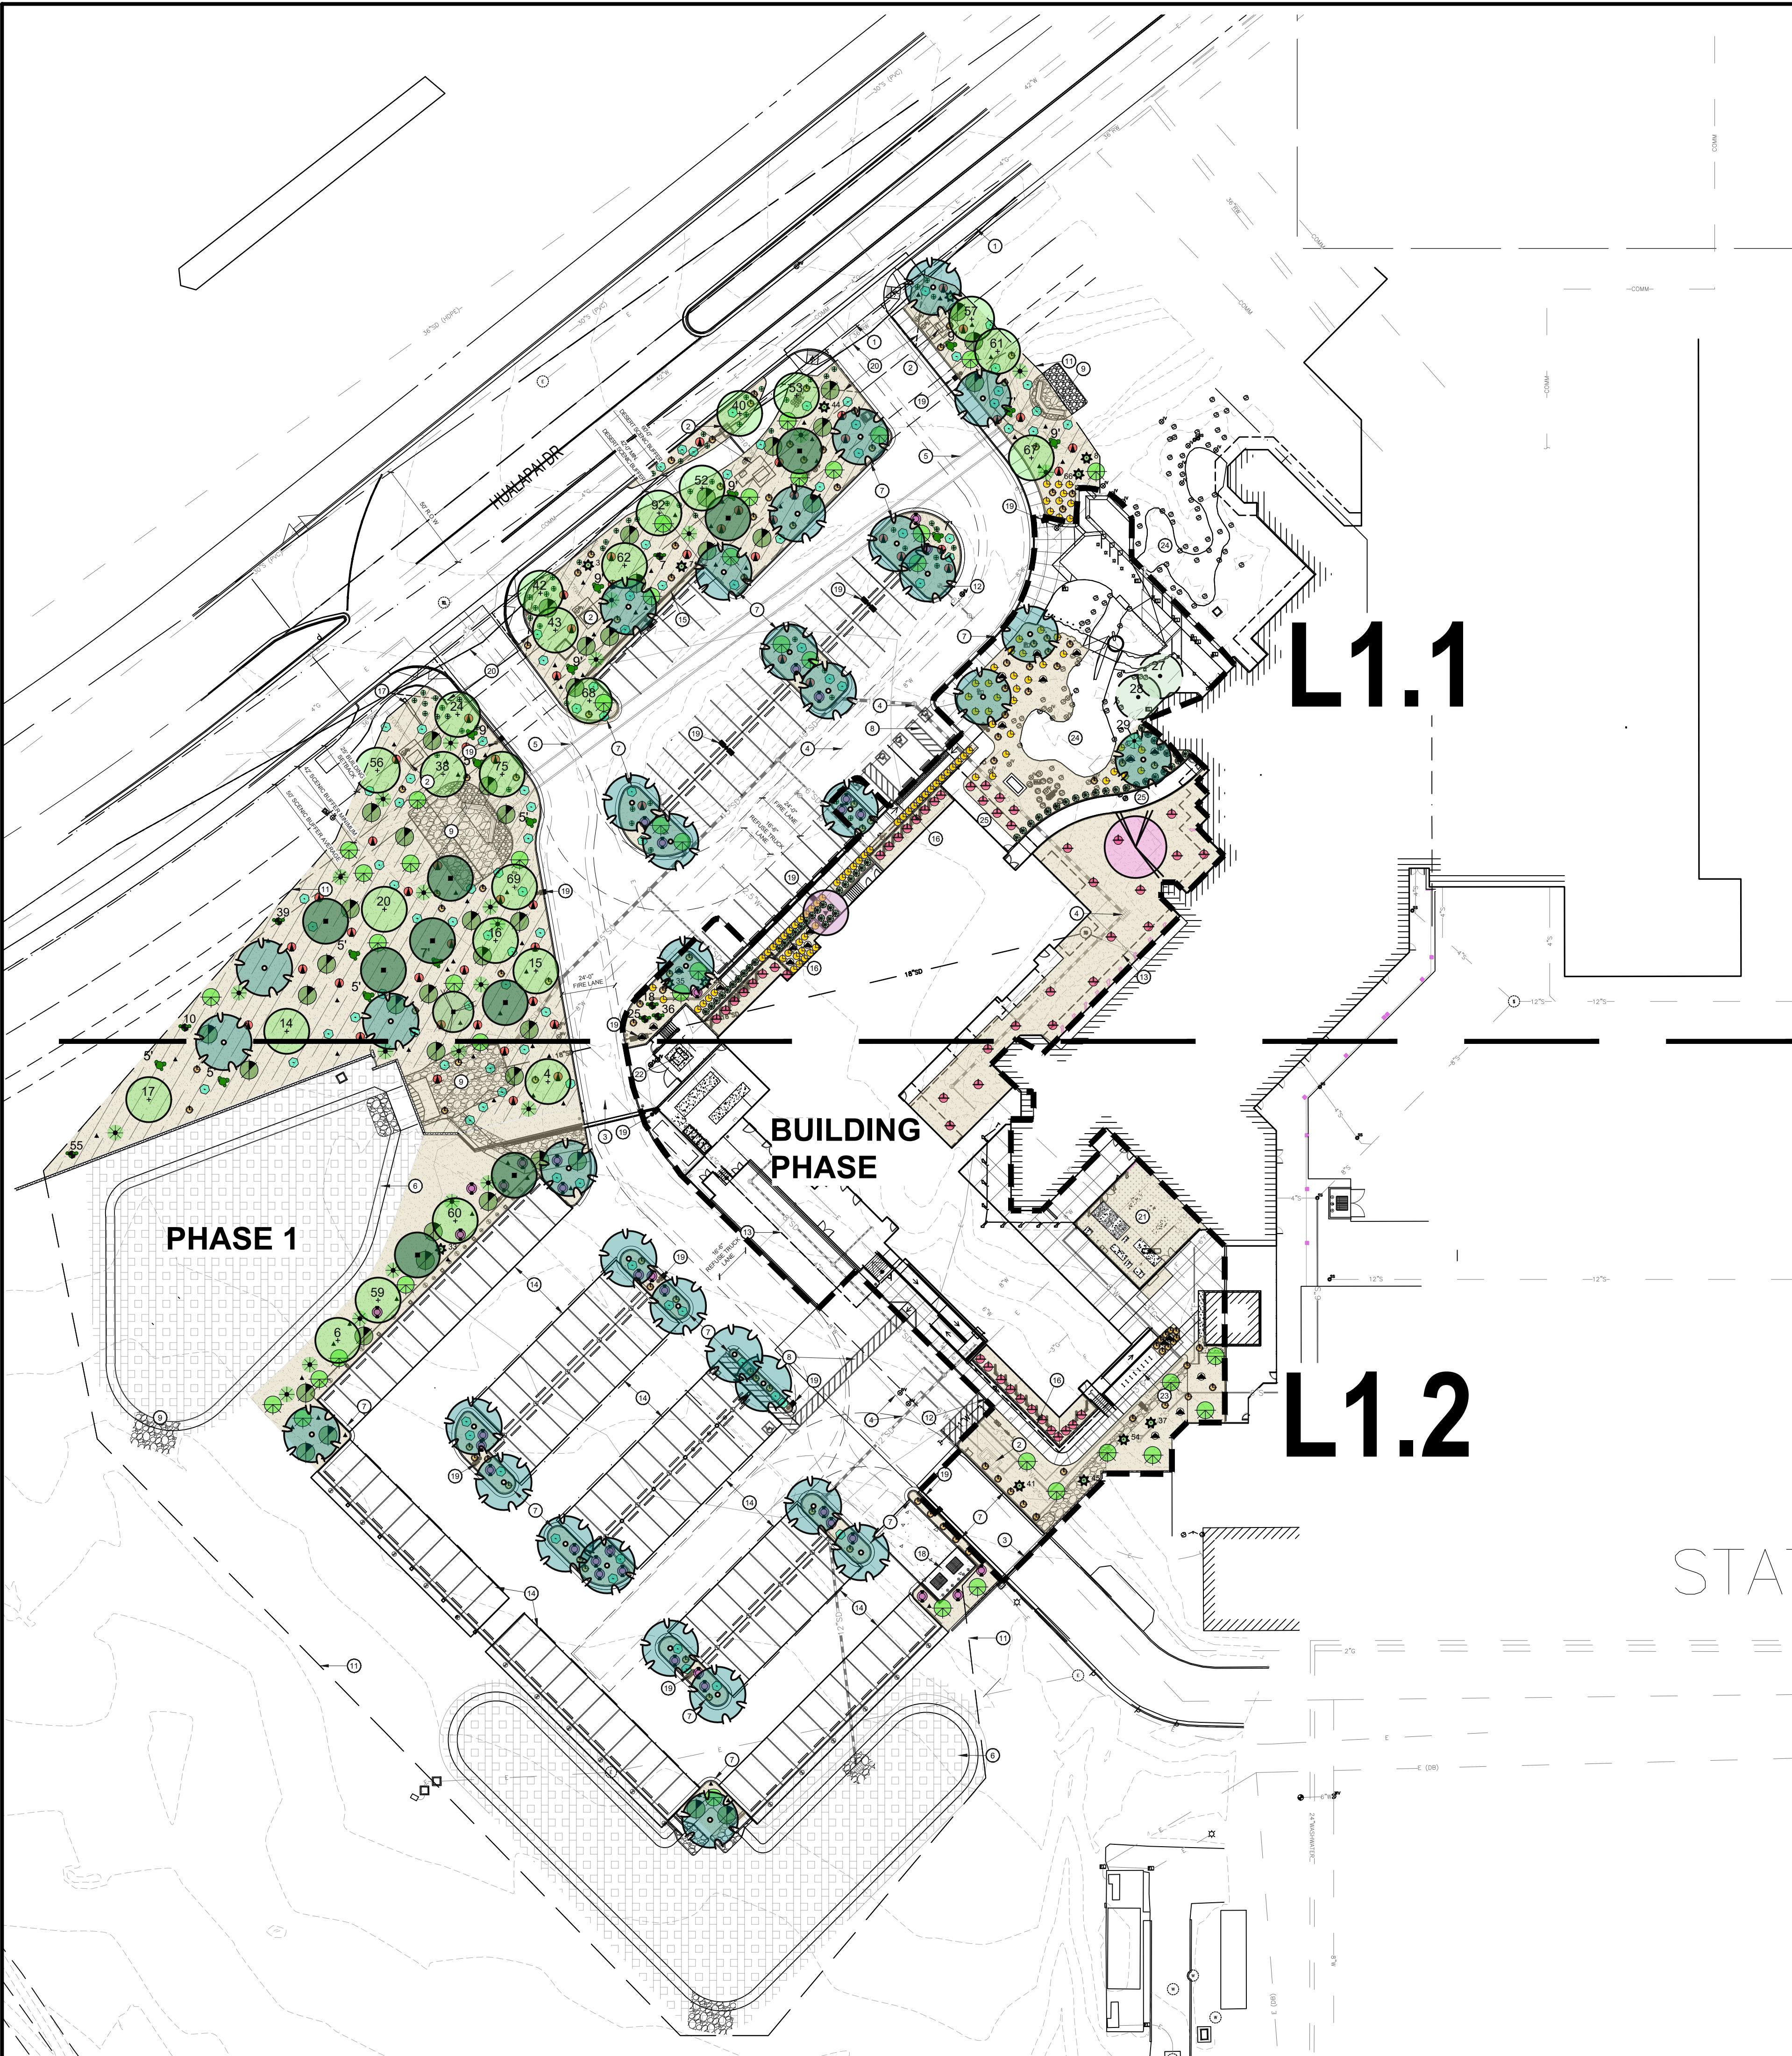
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1425 N. First Street
Second Floor
Phoenix, AZ 85004

602.462.1425 P
602.462.1427 F

SCOTTSDALE WATER CAMPUS
8787 E HUALAPAI DR
SCOTTSDALE, AZ 85255



PLANT LEGEND

BOTANICAL NAME
SYM. COMMON NAME

SIZE

MIN. CAL
HT X W

PHASE 1
QTY.

BUILDING
QTY.

TREES

EXISTING TREE TO
REMAIN IN PLACE

0 2

XX




Arrington Watkins Architects

3003 N Central Ave, Suite 2400
Phoenix, Arizona 85012
Telephone: (602) 279-4373
Fax: (602) 279-9110

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1425 N. First Street
Second Floor
Phoenix, AZ 85004602.462.1425 P
602.462.1427 F

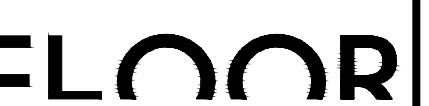SCOTTSDALE WATER CAMPUS
8787 E HUALAPAI DR
SCOTTSDALE, AZ 85255

**KEYNOTES**

- (1) PROPERTY / R.O.W. LINE
- (2) EXISTING UTILITIES. SEE CIVIL DRAWINGS.
- (3) SECURITY WALL AND GATE. SEE ARCH.
- (4) UNDERGROUND UTILITY. SEE CIVIL DRAWINGS.
- (5) BOX CULVERT. SEE CIVIL DRAWINGS.
- (6) RETENTION BASIN. SEE CIVIL DRAWINGS.
- (7) RAISED CONCRETE CURB. SEE CIVIL DRAWINGS.
- (8) ADA ACCESS PATH
- (9) RIP RAP. SEE CIVIL
- (10) EXISTING ENTRY DRIVE TO REMAIN WORK. SEE CIVIL.
- (11) CONSTRUCTION FENCE/ LIMIT OF FIRE HYDRANT. SEE CIVIL
- (12) FIRE HYDRANT. SEE CIVIL
- (13) BUILDING OVERHANG. SEE ARCH.
- (14) OVERHEAD SHADE CANOPY. SEE ARCH
- (15) NEW SCREEN WALL. SEE ARCH
- (16) RAISED PLANTER. SEE ARCH
- (17) EXISTING SIGN TO REMAIN
- (18) REFUSE ENCLOSURE
- (19) OVERHEAD SITE LIGHTING - SEE ELECTRICAL
- (20) SITE VISIBILITY TRIANGLE
- (21) MECHANICAL YARD. SEE ARCH.
- (22) NEW ELECTRICAL TRANSFORMER. SEE ELECTRICAL DRAWINGS
- (23) BIKE RACKS. SEE ARCH.
- (24) EXISTING WATER FEATURE TO REMAIN
- (25) PEDESTRIAN CONNECTION WALK. SEE ARCH.

NOTE:
TAG # 27,28, & 29 TO REMAIN IN PLACE.

| TAG # | COMMON NAME | CALIPER (IN.) |
|-------|----------------------|---------------|
| 4 | FOOTHILLS PALO VERDE | 22 |
| 6 | MESQUITE | 10 |
| 14 | FOOTHILLS PALO VERDE | 10 |
| 15 | MESQUITE | 20 |
| 16 | FOOTHILLS PALO VERDE | 18 |
| 17 | FOOTHILLS PALO VERDE | 4 |
| 20 | FOOTHILLS PALO VERDE | 14 |
| 24 | MESQUITE | 20 |
| 38 | FOOTHILLS PALO VERDE | 14 |
| 40 | MESQUITE | 5 |
| 42 | MESQUITE | 12 |
| 43 | MESQUITE | 16 |
| 52 | MESQUITE | 9 |
| 53 | MESQUITE | 13 |
| 56 | FOOTHILLS PALO VERDE | 20 |
| 57 | FOOTHILLS PALO VERDE | 20 |
| 59 | BLUE PALO VERDE | 4 |
| 60 | BLUE PALO VERDE | 4 |
| 61 | FOOTHILLS PALO VERDE | 10 |
| 62 | MESQUITE | 18 |
| 67 | FOOTHILLS PALO VERDE | 14 |
| 68 | BLUE PALO VERDE | 16 |
| 69 | FOOTHILLS PALO VERDE | 18 |
| 75 | BLUE PALO VERDE | 18 |
| 77 | BARREL | 4 |
| 92 | MESQUITE | 7 |

SALVAGE CACTI

| TAG # | COMMON NAME | LENGTH (FT) | ARMS |
|-------|-------------|-------------|------|
| 3 | BARREL | 4 | |
| 5 | BARREL | 4 | |
| 7 | SAGUARO | 12 | |
| 8 | BARREL | 3 | |
| 10 | SAGUARO | 12 | |
| 18 | SAGUARO | 29 | 3 |
| 25 | SAGUARO | 22 | 2 |
| 29 | OCOTILLO | 14 | |
| 33 | BARREL | 3 | |
| 35 | BARREL | 5 | |
| 36 | SAGUARO | 39 | 7 |
| 37 | BARREL | 4 | |
| 39 | SAGUARO | 14 | 2 |
| 41 | BARREL | 5 | |
| 44 | BARREL | 6 | |
| 45 | BARREL | 4 | |
| 54 | BARREL | 3 | |
| 55 | SAGUARO | 12 | |
| 66 | BARREL | 4 | |
| 71 | BARREL | 4 | |

| PLANT LEGEND | SYMBOL | BOTANICAL NAME | COMMON NAME | SIZE | MIN. CAL HT X W | PHASE 1 QTY. | BUILDING QTY. |
|-------------------------|-------------------|--|----------------------------------|---------------------------|-----------------|--------------|---------------|
| TREES | | | | | | | |
| | - | - | EXISTING TREE TO REMAIN IN PLACE | - | - | 0 | 2 |
| | - | - | SALVAGED TREES | - | - | 25 | 0 |
| | 48" BOX MULTI | PARKINSONIA FLORIDUM | BLUE PALO VERDE | 4" CAL MIN 12' H X 10' W | 30 | 5 | |
| | 36" BOX MULTI | PARKINSONIA MICROPHYLLA | FOOTHILLS PALO VERDE | 2.5" CAL MIN 8' H X 6' W | 1 | 0 | |
| | 36" BOX MULTI | PROSOPIS VELUTINA | ARIZONA MESQUITE | 2.5" CAL MIN 8' H X 6' W | 9 | 0 | |
| | 36" BOX MULTI | CHILOPSIS LINEARIS 'BUBBA' | DESERT WILLOW 'BUBBA' | 2" CAL MIN 8' H X 6' W | 0 | 1 | |
| | 60" BOX MULTI | OLNEYA TESOTA | DESERT IRONWOOD | 12" CAL MIN 15' H X 15' W | 0 | 1 | |
| SHRUBS | | | | | | | |
| | 1 GAL | AMBROSIA DELTOIDEA | BURSAGE | 63 | 2 | | |
| | 5 GAL | ASCLEPIAS SUBULATA | RUSH MILKWEED | 66 | 44 | | |
| | 5 GAL | CALLIANDRA CALIFORNICA | BAJA FAIRY DUSTER | 56 | 0 | | |
| | 1 GAL | ENCELIA FARINOSA | BRITTLEBUSH | 97 | 0 | | |
| | 5 GAL | LARREA TRIDENTATA | CREOSOTE | 45 | 0 | | |
| | 5 GAL | LUCEOPHYLLUM LAEVIGATUM | CHIHUAHUA SAGE | 33 | 4 | | |
| | 5 GAL | SIMMONDSIA CHINENSIS | JOJOBA | 34 | 9 | | |
| | 5 GAL | JUSTICIA CALIFORNICA | CHUPAROSA | 0 | 52 | | |
| | 5 GAL | LANTANA 'NEW GOLD' | NEW GOLD LANTANA | 0 | 80 | | |
| | 5 GAL | MUHLENBERGIA DUBIA | PINE MUHLY | 0 | 56 | | |
| ACCENTS | | | | | | | |
| | VARIES - SEE PLAN | CARNEA GIGANTEA | SAGUARO | 15 TOTAL | | | |
| | 5' SPEAR | | | 6 | | | |
| | 7' SPEAR | | | 3 | | | |
| | 9' SPEAR | | | 6 | | | |
| | XX | SALVAGED SAGUARO | | 4 | 3 | | |
| | XX | SALVAGED CACTUS | | 7 | 6 | | |
| | 24" BOX | FOUQUIERA SPLENDENS | OCOTILLO | 24 | 0 | | |
| | 24" BOX | EXISTING FOUQUIERA SPLENDENS | OCOTILLO (TO REMAIN IN PLACE) | 0 | 1 | | |
| | 5 GAL | OPUNTIA ENGELMANNII | ENGELMANN'S PRICKLY PEAR | 67 | 0 | | |
| | 5 GAL | OPUNTIA ELLISIANA | SPINELESS PRICKLY PEAR | 0 | 20 | | |
| REVEGETATION MIX | | | | | | | |
| | LBS/ACRE | AMBROSIA DELTOIDEA (BURSAGE) | 0.75 | | | | |
| | | CALLIANDRA ERIOPHYLLA (FAIRY DUSTER) | 0.75 | | | | |
| | | CYLINDROPUNTIA BEGELOVII (TEDDY BEAR CHOLLA) | 0.25 | | | | |
| | | ERICAMERA LARICIFOLIA (TURPENTINE BUSH) | 1.00 | | | | |
| | | LARREA TRIDENTATA (CREOSOTE) | 0.25 | | | | |
| | | SENNIA COEVI (DESERT SENNA) | 0.25 | | | | |
| | | SIMMONDSIA CHINENSIS (JOJOBA) | 1.00 | | | | |
| | | SPHAERALcea AMBIGUA (GLOBEMALLOW) | 0.25 | | | | |

NOTE:
HAND BROADCAST / DRY SCATTER SEED MIX PRIOR TO FINAL APPLICATION OF NATIVE SOIL TOPDRESS, IN ALL AREAS DISTURBED BY CONSTRUCTION UON

TOPDRESS / DUST CONTROL -
1/4" MINUS COMPACTED DECOMPOSED GRANITE; 2" MIN. DEPTH.
COLOR: MADISON GOLD BY PIONEER OR APPROVED EQUAL TO MATCH EXISTING.
WWW.PIONEERCO.COM

3/4" MINUS DECOMPOSED GRANITE 2" MIN. DEPTH.
COLOR: MADISON GOLD BY PIONEER OR APPROVED EQUAL TO MATCH EXISTING.
WWW.PIONEERCO.COM

1" SCREENED DECOMPOSED GRANITE IN ALL PLANTING AREAS; 2" MIN. DEPTH. COLOR: MADISON GOLD BY PIONEER OR APPROVED EQUAL TO MATCH EXISTING.
WWW.PIONEERCO.COM

0 SF 1,650 SF

46,750 SF 17,030 SF

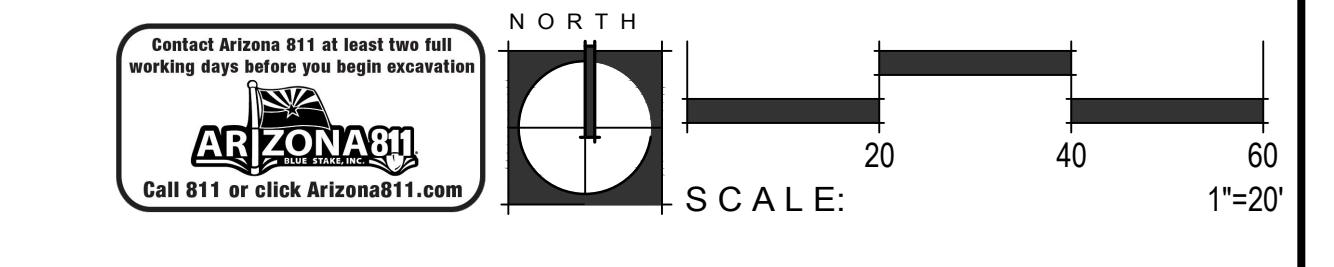
0 SF 34,680 SF

SITE CALCULATIONS

TOTAL LANDSCAPE AREA: 63,780 SQFT

LANDSCAPE AREA WITHIN RIGHT-OF-WAY: 0 SQFT

LANDSCAPE AREA AT PARKING LOT: 17,680 SQFT



| NO. | REVISION | DATE |
|--|----------|----------|
| 1 | DRB | 12/20/24 |
| PROJECT NO.: _____ | | |
| DATE: 12/20/2024 | | |
| DESIGNED BY: EF/MS | | |
| DRAWN BY: _____ | | |
| APPROVED BY: _____ | | |
| SHEET TITLE: PARTIAL LANDSCAPE PLAN | | |
| SHEET NUMBER: L1.1 DESIGN REVIEW BOARD | | |

Contact Arizona 811 at least two full working days before you begin excavation

Arizona 811 Call 811 or click Arizona811.com



Arrington Watkins Architects

3003 N Central Ave, Suite 2400
Phoenix, Arizona 85012
Telephone: (602) 279-4373
Fax: (602) 279-0110
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PRELIMINARY NOT FOR CONSTRUCTION



FLOOR associates

1425 N. First Street | 602.462.1425 P
Second Floor | 602.462.1427 F
Phoenix, AZ 85004

SCOTTSDALE WATER CAMPUS
8787 E HUALAPAI DR
SCOTTSDALE, AZ 85255

MATCHLINE : SEE L1.1


KEYNOTES

- ① PROPERTY / R.O.W. LINE
- ② EXISTING UTILITIES. SEE CIVIL DRAWINGS.
- ③ SECURITY WALL AND GATE. SEE ARCH.
- ④ UNDERGROUND UTILITY. SEE CIVIL DRAWINGS.
- ⑤ BOX CULVERT. SEE CIVIL DRAWINGS.
- ⑥ RETENTION BASIN. SEE CIVIL DRAWINGS.
- ⑦ RAISED CONCRETE CURB. SEE CIVIL DRAWINGS.
- ⑧ ADA ACCESS PATH
- ⑨ RIP RAP. SEE CIVIL
- ⑩ EXISTING ENTRY DRIVE TO REMAIN
- ⑪ CONSTRUCTION FENCE/ LIMIT OF WORK. SEE CIVIL.
- ⑫ FIRE HYDRANT. SEE CIVIL
- ⑬ BUILDING OVERHANG. SEE ARCH.
- ⑭ OVERHEAD SHADE CANOPY. SEE ARCH
- ⑮ NEW SCREEN WALL. SEE ARCH
- ⑯ RAISED PLANTER. SEE ARCH
- ⑰ EXISTING SIGN TO REMAIN
- ⑱ REFUSE ENCLOSURE
- ⑲ OVERHEAD SITE LIGHTING - SEE ELECTRICAL
- ⑳ SITE VISIBILITY TRIANGLE
- ㉑ MECHANICAL YARD. SEE ARCH.
- ㉒ NEW ELECTRICAL TRANSFORMER. SEE ELECTRICAL DRAWINGS
- ㉓ BIKE RACKS. SEE ARCH.
- ㉔ EXISTING WATER FEATURE TO REMAIN
- ㉕ PEDESTRIAN CONNECTION WALK. SEE ARCH.

PLANT LEGEND

BOTANICAL NAME
SYM COMMON NAME

| SIZE | MIN. CAL | HT X W | PHASE 1 QTY. | BUILDING QTY. |
|------|----------|--------|--------------|---------------|
|------|----------|--------|--------------|---------------|

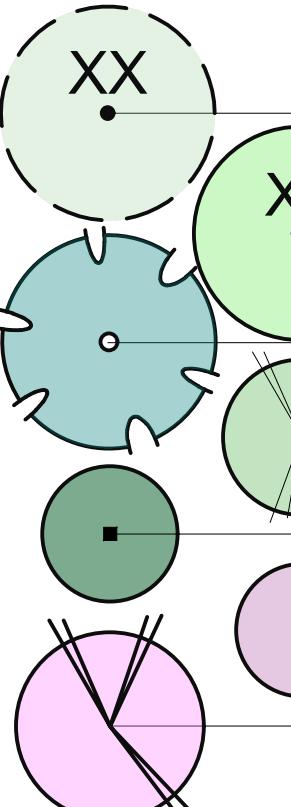

TREES

EXISTING TREE TO REMAIN IN PLACE

0 2

SALVAGED TREES

25 0

PARKINSONIA FLORIDUM
BLUE PALO VERDE

48" BOX
MULTI

4" CAL MIN
12' H X 10' W

30 5

PARKINSONIA MICROPHYLLA
FOOTHILLS PALO VERDE

36" BOX
MULTI

2.5" CAL MIN
8' H X 6' W

1 0

PROSOPIS VELUTINA
ARIZONA MESQUITE

36" BOX
MULTI

2.5" CAL MIN
8' H X 6' W

9 0

CHILOPSIS LINEARIS 'BUBBA'
DESERT WILLOW 'BUBBA'

36" BOX
MULTI

2" CAL MIN
8' H X 6' W

0 1

OLNEYA TESOTA
DESERT IRONWOOD

60" BOX
MULTI

12" CAL MIN
15' H X 15' W

0 1

SHRUBS

AMBROSIA DELTOIDEA
BURSAGE

1 GAL

63 2

ASCLEPIAS SUBULATA
RUSH MILKWEED

5 GAL

66 44

CALLANDRA CALIFORNICA
BAJA FAIRY DUSTER

5 GAL

56 0

ENCelia FARINOSA
BRITTLEBUSH

1 GAL

97 0

LARREA TRIDENTATA
CREOSOTE

5 GAL

45 0

LUECOPHYLLA LAEVIGATUM
CHIHUAHUA SAGE

5 GAL

33 4

SIMMONDSIA CHINENSIS
JOJOBA

5 GAL

34 9

JUSTICIA CALIFORNICA
CHUPAROSA

5 GAL

0 52

LANTANA 'NEW GOLD'
NEW GOLD LANTANA

5 GAL

0 0

MUhlenbergia dubia
PINE MUHY

5 GAL

VARIES - SEE PLAN

15 TOTAL

5' SPEAR - 6

7' SPEAR - 3

9' SPEAR - 6

4 3

XX SALVAGED SAUARO

XX SALVAGED CACTUS

7 6

FOUQUIERA SPLENDENS
OCOTILLO

24" BOX

24 0

EXISTING FOUQUIERA SPLENDENS
OCOTILLO (TO REMAIN IN PLACE)

0 1

OPUNTIA ENGEMLIANII
ENGELMANN'S PRICKLY PEAR

5 GAL

67 0

OPUNTIA ELIJUANIA
SPINELESS PRICKLY PEAR

5 GAL

0 20

1" SCREENED DECOMPOSED GRANITE IN ALL
PLANTING AREAS 2" MIN. DEPTH. COLOR: MADISON

GOLD BY PIONEER OR APPROVED EQUAL TO
MATCH EXISTING.
WWW.PIONEERCO.COM

46,750 SF 17,030 SF

0 SF 34,680 SF

1" SCREENED DECOMPOSED GRANITE IN ALL
PLANTING AREAS 2" MIN. DEPTH. COLOR: MADISON

GOLD BY PIONEER OR APPROVED EQUAL TO MATCH EXISTING.
WWW.PIONEERCO.COM

0 SF 20 40 60

1"-20"

NORTH

SCALE:

BUILDING PHASE

PHASE LINE

REFUSE LINE

16'6" FT

12' SD

8' SD

6' W

6' W

3' 6"

3' 6"

2' SD

1' 2"

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PRELIMINARY NOT FOR CONSTRUCTION

SCOTTSDALE WATER CAMPUS
8787 E Hualapai Drive, Scottsdale, AZ 85255