

AT&T Mobility 1355 W. University Mesa, AZ 85201

February 8, 2024

RE: AT&T Mobility's Existing and Proposed Wireless Facility Narrative

AT&T proposes A 50-foot-tall temporary pole with antennas will be installed within the public right-of-way on the south side of E. Dynamite Bl., west of N. Scottsdale Rd to provide continued coverage during the duration of the street improvement project until the roundabout and new street lighting are installed.

AT&T will then collocate antennas on the streetlight pole and remove the temporary pole. Also, the associated existing AT&T equipment vault location conflicts with the planned roundabout and will need to be removed and replaced with at-grade, equipment placed within the public right-of-way on the south side of E. Dynamite BI., west of N. Scottsdale Rd. which will be screened by decorative patina to minimize visual impact.

If there are any questions please reach out to me, Andrew Silvernail at asilvernail@clinellc.com

Best Regards,

Andrew Silvernail
asilvernail@clinellc.com
Centerline Communications

CODE COMPLIANCE

ALL WORK AND MATERIALS SHALL BE PERFORMED AND INSTALLED IN ACCORDANCE WITH THE CURRENT EDITIONS OF THE FOLLOWING CODES AS ADOPTED BY THE LOCAL GOVERNING AUTHORITIES. NOTHING IN THESE PLANS IS TO BE CONSTRUED TO PERMIT WORK NOT CONFORMING TO THESE CODES.

2018 INTERNATIONAL BUILDING CODE WITH LOCAL AMENDMENTS

2018 INTERNATIONAL FUEL GAS CODE (IFGC) 2018 INTERNATIONAL PLUMBING CODE (IPC)

2018 INTERNATIONAL MECHANICAL CODE

2018 INTERNATIONAL ENERGY CONSERVATION CODE (IECC)

2018 INTERNATIONAL FIRE CODE (IFC)

2017 INTERNATIONAL ELECTRICAL CONSERVATION CODE (IEC)



NEW SITE BUILD

1C PACE ID: MRANM053598 WSANM0027974

USID: 328886 FA CODE:

SITE NUMBER: AZL05904

SITE NAME: SCOTTSDALE RELO TEMP

STEEL POLE/ WUC SITE TYPE: **ADDRESS**:

7191 E DYNAMITE BLVD. SCOTTSDALE, AZ 85266

IWM ID:

16322547

PARCEL ID:

212-10-266A

PROJECT DESCRIPTION LOCAL MAP PROJECT TEAM VICINITY MAP

APPLICANT / LESSEE:

PROJECT MANAGER:

AT&T MOBILITY J5 INFRASTRUCTURE PARTNERS CONTACT: SARA MITCHELL 1335 W. UNIVERSITY, FLR 3 MASE, AZ 85201 CONTACT: KAREN MENNENGA

EMAIL: samitchell@clinellc.com PH: (971) 281-1422 EMAIL: KM3168@att.com

ZONING:

CONSTRUCTION MANAGER:

SITE ACQUISITION:

CONTACT: DEAN LASATER **J5 INFRASTRUCTURE PARTNERS** EMAIL: DL5855@att.com CONTACT: ANDREW SILVERNAIL EMAIL: asilvernail@clinellc.com

PH: (251) 604-0404

A&E MANAGER:

J5 INFRASTRUCTURE PARTNERS CONTACT: KEVIN MILLER

EMAIL: Kmiller@pmass.com

J5 INFRASTRUCTURE PARTNERS CONTACT: ANDREW SILVERNAIL EMAIL: asilvernail@clinellc.com PH: (251) 604-0404

PROPERTY OWNER:

PH: (720) 296-6180

RIGHT OF WAY - CITY OF SCOTTSDALE





PROPOSED SITE BUILD OF AN UNMANNED TELECOMMUNICATIONS FACILITY, CONSISTING OF THE FOLLOWING:

TOWER/ANTENNA SOW:

- •• INSTALLATION OF (1) AT&T 50'-0" HIGH TEMPORARY STEEL POLE
- •• INSTALLATION OF (3) AT&T PANEL ANTENNAS
- •• INSTALLATION OF (6) AT&T REMOTE RADIO HEADS (RRH'S)
- •• INSTALLATION OF (6) AT&T TRIPLEXERS
- •• INSTALLATION OF (6) AT&T TMAS •• INSTALLATION OF (1) MSFAA MOUNT

EQUIPMENT SOW:

- •• INSTALLATION OF (1) AT&T UL LISTED 3-BAY WALK-UP-CABINET (WUC) - CEQ.54298 VERTIV, F2020030,,, VERTIV WUC 3-BAY CABINET 6KW HEX ON (P) CONCRETE PAD
- •• INSTALLATION OF (1) AT&T EMERSON POWER PLANT RACK W/ 2 STRINGS OF BATTERIES (8) BATTERIES @ -48VDC
- •• INSTALLATION OF (1) A T&T NEQ.44444 20KW (ALL STATES) 48VDC
- GENERATOR WITH 54G DIESEL TANK ON (P) CONCRETE PAD •• INSTALLATION OF (1) AT&T NEQ.54898: RAYCAP INC., DC50-48-60-96-50F,,,,HIGH CAPACITY 50 DC POSITIONS FOR RRU/RRH, 96 LC-LC CONNECTIONS IN ALUMINUM
- •• INSTALLATION OF (1) AT&T FIBER BOX
- •• INSTALLATION OF (1) METER & DISCONNECT ON METAL WALL •• INSTALLATION OF (24) AT&T 7/8" COAX TRUNK CABLES

SHEET INDEX

- •• INSTALLATION OF (9) AT&T -48V RECTIFIERS AND
- (6) -48VDC/58VDC CONVERTERS
- •• INSTALLATION OF (1) AT&T FSM4 UNIT •• INSTALLATION OF (1) AT&T GPS ANTENNA

PROJECT AREA:

•• 10'-0" x 20'-0" (200 SQ. FT.) LEASE AREA

FUTURE ELEVATIONS

•• 10'-0" x 10'-0" (100 SQ. FT.) LEASE AREA

GENERAL CONTRACTOR NOTES SITE INFORMATION DO NOT SCALE DRAWINGS

WIND LOADS: 105 MPH (3-SECOND GUST) EXPOSURE CATEGORY: C SEISMIC ZONE:

JURISDICTION:

FLOOD ZONE: PARCEL ID #: 212-10-266A R1-70 ESL FO ZONING:

LATITUDE (NAD 83): 33°44'27.758"N (33.741044) LONGITUDE (NAD 83): 111°55'36.141"W (-111.926706)

COMPOUND AREA: 2675 SQ. FT LEASE AREA: 420 SQ. FT BASE OF PROPOSED STRUCTURE: ± 0 A.G.L.

TOP OF PROPOSED STRUCTURE: ± 50'-0" A.G.L.

ACCESSIBILITY REQUIREMENTS: FACILITY IS AN UNMANNED EQUIPMENT SPACE NOT INTENDED FOR HUMAN HABITATION AND ONLY FREQUENTLY VISITED BY MAINTENANCE PERSONAL. ACCESSIBILITY IS NOT REQUIRED PER IBC 2018, SECTION 1103.2.9 (EQUIPMENT SPACES)

CITY OF SCOTTSDALE

THESE PLANS ARE FORMATTED TO BE FULL SIZE AT 24" X 36". CONTRACTORS SHALL VERIFY ALL PLANS AND EXISTING DIMENSIONS AND CONDITIONS ON THE JOB SITE AND SHALL IMMEDIATELY NOTIFY THE ARCHITECT/ENGINEER IN WRITING OF ANY DISCREPANCIES BEFORE PROCEEDING WITH THE WORK OR MATERIAL ORDERS OR BE RESPONSIBLE FOR THE SAME.

GENERAL NOTES

THE FACILITY IS UNMANNED AND NOT FOR HUMAN HABITATION. A TECHNICIAN WILL VISIT THE SITE AS REQUIRED FOR ROUTINE MAINTENANCE. THE PROJECT WILL NOT RESULT IN ANY SIGNIFICANT DISTURBANCE OR EFFECT ON DRAINAGE; NO SANITARY SEWER SERVICE, POTABLE WATER, OR TRASH DISPOSAL IS REQUIRED AND NO COMMERCIAL SIGNAGE IS PROPOSED.

STATEMENTS

STRUCTURAL ANALYSIS IS NOT WITHIN THE SCOPE OF WORK CONTAINED IN THIS DRAWINGS SET. FOR ANALYSIS OF EXISTING AND/OR PROPOSED COMPONENTS, REFER TO STRUCTURAL ANALYSIS PROVIDED UNDER SEPARATE COVER.

ANTENNA MOUNT ANALYSIS IS NOT WITHIN THE SCOPE OF WORK CONTAINED IN THIS DRAWING SET. FOR ANALYSIS OF MOUNT TO SUPPORT EXISTING AND/OR PROPOSED COMPONENTS, REFER TO ANTENNA MOUNT STRUCTURAL ANALYSIS PROVIDED UNDER SEPARATE COVER.

DRIVING DIRECTIONS

DIRECTIONS FROM SKY HARBOR AIRPORT (3400 EAST SKY HARBOR BOULEVARD, PHOENIX, AZ 85034):

- HEAD EAST ON SKY HBR BLVD
- 2. USE THE LEFT LANE TO STAY ON SKY HBR BLVD
- 3. SLIGHT LEFT TOWARD SKY HBR BLVD W
- 4. TURN LEFT ONTO SKY HBR BLVD W
- 5. KEEP LEFT TO STAY ON SKY HBR BLVD W, FOLLOW SIGNS FOR DOWNTOWN/PHOENIX/I-10 W/AZ-51/AZ-202 LOOP
- USE THE RIGHT 2 LANES TO TAKE EXIT 147A-B FOR AZ-51 N


6. MERGE ONTO I-10 W

- 8. CONTINUE ONTO AZ-51 N
- 9. USE THE RIGHT 2 LANES TO TAKE EXIT 15A TO MERGE ONTO AZ-101 LOOP E
- 10. TAKE EXIT 34 FOR SCOTTSDALE RD
- 11. USE THE LEFT 3 LANES TO TURN LEFT ONTO N SCOTTSDALE RD
- 12. TURN RIGHT ONTO E DYNAMITE BLVD

TOWER OWNER: AT&T POWER AGENCY: APS TELCO PROVIDER: COX ENGINEERS NOTE: RFDS FOR AZL00362 BEING UTILIZED FOR AZL05904 PER AT&T DIRECTION.

RFDS NAME: AZL00362 ISSUE: 1.0 **REVISION:** V1.0 DATE: 3/2/2021 RFDS VERSION: RFDS ID: 3702344 UPDATED BY: AA380J DATE/TIME UPDATED: 5/13/21

1:59:31 PM

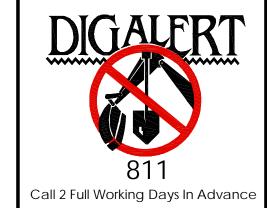

TITLE SHEET GN-1 **GENERAL NOTES** GENERAL NOTES Licensor: SURVEY TEMP SITE PLAN ENLARGED SITE PLAN & COMPOUND PLAN ANTENNA PLAN & SCHEDULE & EQUIPMENT PLAN **ELEVATIONS** FUTURE INTERSECTION EXHIBIT SITE PLAN

Sheet Title:

REV

TITLE SHEET

PREPARED FOR

STAT&T

1355 W. UNIVERSITY

MESA, ARIZONA 85201

15 INFRASTRUCTURE

23 MAUCHLY #110

IRVINE, CA 92618

J5 PROJECT ID: P-097567

AZL05904

SCOTTSDALE RELO TEMP

FA: 16322547

USID: 328886

7191 E DYNAMITE BLVD.

SCOTTSDALE, AZ 85266

PARCEL ID: 212-10-266A

THE INFORMATION CONTAINED

IN THE SET OF DRAWINGS IS

PROPRIETARY & CONFIDENTIA

TO AT&T WIRELESS ANY USE OR

DISCLOSURE OTHER THAN AS IT

RELATES TO AT&T WIRELESS IS

STRICTLY PROHIBITED

REV DATE BY DESCRIPTION

2/6/24 RT 90%ZD

A 1/18/24 SLM 90%ZD

DRAWN BY: SLM

CHECKED BY: KM

Vendor:

Issued For:

Sheet Number:

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2-DR-2024 2/27/24

GENERAL CONSTRUCTION NOTES:

- 1. PLANS ARE INTENDED TO BE DIAGRAMMATIC OUTLINE ONLY, UNLESS NOTED OTHERWISE. THE WORK SHALL INCLUDE FURNISHING MATERIALS, EQUIPMENT, APPURTENANCES AND LABOR NECESSARY TO COMPLETE ALL INSTALLATIONS AS INDICATED ON THE DRAWINGS.
- 2. THE CONTRACTOR SHALL OBTAIN, IN WRITING, AUTHORIZATION TO PROCEED BEFORE STARTING WORK ON ANY ITEM NOT CLEARLY DEFINED OR IDENTIFIED BY THE CONTRACT DOCUMENTS.
- 3. CONTRACTOR SHALL CONTACT USA (UNDERGROUND SERVICE ALERT) AT (800) 227-2600, FOR UTILITY LOCATIONS, 48 HOURS BEFORE PROCEEDING WITH ANY EXCAVATION. SITE WORK OR CONSTRUCTION
- 4. THE CONTRACTOR SHALL INSTALL ALL EQUIPMENT AND MATERIALS IN ACCORDANCE WITH MANUFACTURER'S RECOMMENDATIONS UNLESS SPECIFICALLY INDICATED OTHERWISE, OR WHERE LOCAL CODES OR REGULATIONS TAKE PRECEDENCE.
- 5. ALL CONSTRUCTION SHALL BE IN ACCORDANCE WITH THE IBC / UBC'S REQUIREMENTS REGARDING EARTHQUAKE RESISTANCE, FOR, BUT NOT LIMITED TO, PIPING, LIGHT FIXTURES, CEILING GRID, INTERIOR PARTITIONS, AND MECHANICAL EQUIPMENT. ALL WORK MUST COMPLY WITH LOCAL EARTHQUAKE CODES AND REGULATIONS.
- REPRESENTATIONS OF TRUE NORTH, OTHER THAN THOSE FOUND ON THE PLOT OF SURVEY DRAWINGS, SHALL NOT BE USED TO IDENTIFY OR ESTABLISH BEARING OF TRUE NORTH AT THE SITE. THE CONTRACTOR SHALL RELY SOLELY ON THE PLOT OF SURVEY DRAWING AND ANY SURVEYOR'S MARKINGS AT THE SITE FOR THE ESTABLISHMENT OF TRUE NORTH, AND SHALL NOTIFY THE ARCHITECT / ENGINEER PRIOR TO PROCEEDING WITH THE WORK IF ANY DISCREPANCY IS FOUND BETWEEN THE VARIOUS ELEMENTS OF THE WORKING DRAWINGS AND THE TRUE NORTH ORIENTATION AS DEPICTED ON THE CIVIL SURVEY. THE CONTRACTOR SHALL ASSUME SOLE LIABILITY FOR ANY FAILURE TO NOTIFY THE ARCHITECT / ENGINEER.
- THE BUILDING DEPARTMENT ISSUING THE PERMITS SHALL BE NOTIFIED AT LEAST TWO WORKING DAYS PRIOR TO THE COMMENCEMENT OF WORK, OR AS OTHERWISE STIPULATED BY THE CODE ENFORCEMENT OFFICIAL HAVING JURISDICTION.
- 8. DO NOT EXCAVATE OR DISTURB BEYOND THE PROPERTY LINES OR LEASE LINES, UNLESS OTHERWISE NOTED.
- 9. ALL EXISTING UTILITIES, FACILITIES, CONDITIONS, AND THEIR DIMENSIONS SHOWN ON THE PLAN HAVE BEEN PLOTTED FROM AVAILABLE RECORDS. THE ARCHITECT / ENGINEER AND THE OWNER ASSUME NO RESPONSIBILITY WHATSOEVER AS TO THE SUFFICIENCY OR THE ACCURACY OF THE INFORMATION SHOWN ON THE PLANS. OR THE MANNER OF THEIR REMOVAL OR ADJUSTMENT. CONTRACTORS SHALL BE RESPONSIBLE FOR DETERMINING EXACT LOCATION OF ALL EXISTING UTILITIES AND FACILITIES PRIOR TO START OF CONSTRUCTION. CONTRACTORS SHALL ALSO OBTAIN FROM EACH UTILITY COMPANY DETAILED INFORMATION RELATIVE TO WORKING SCHEDULES AND METHODS OF REMOVING OR ADJUSTING EXISTING UTILITIES.
- 10. CONTRACTOR SHALL VERIFY ALL EXISTING UTILITIES, BOTH HORIZONTAL AND VERTICALLY, PRIOR TO THE START OF CONSTRUCTION. ANY DISCREPANCIES OR DOUBTS AS TO THE INTERPRETATION OF PLANS SHOULD BE IMMEDIATELY REPORTED TO THE ARCHITECT / ENGINEER FOR RESOLUTION AND INSTRUCTION, AND NO FURTHER WORK SHALL BE PERFORMED UNTIL THE DISCREPANCY IS CHECKED AND CORRECTED BY THE ARCHITECT / ENGINEER. FAILURE TO SECURE SUCH INSTRUCTION MEANS CONTRACTOR WILL HAVE WORKED AT HIS/HER OWN RISK AND EXPENSE
- 11. ALL NEW AND EXISTING UTILITY STRUCTURES ON SITE AND IN AREAS TO BE DISTURBED BY CONSTRUCTION SHALL BE ADJUSTED TO FINISH ELEVATIONS PRIOR TO FINAL INSPECTION OF WORK.
- 12. ANY DRAIN AND/OR FIELD TILE ENCOUNTERED / DISTURBED DURING CONSTRUCTION SHALL BE RETURNED TO IT'S ORIGINAL CONDITION PRIOR TO COMPLETION OF WORK. SIZE, LOCATION AND TYPE OF ANY UNDERGROUND UTILITIES OR IMPROVEMENTS SHALL BE ACCURATELY NOTED AND PLACED ON "AS-BUILT" DRAWINGS BY GENERAL CONTRACTOR. AND ISSUED TO THE ARCHITECT / ENGINEER AT COMPLETION OF PROJECT.
- 13. ALL TEMPORARY EXCAVATIONS FOR THE INSTALLATION OF FOUNDATIONS, UTILITIES, ETC., SHALL BE PROPERLY LAID BACK OR BRACED IN ACCORDANCE WITH CORRECT OCCUPATIONAL SAFETY AND HEALTH ADMINISTRATION (OSHA) REQUIREMENTS.
- 14. INCLUDE MISC. ITEMS PER AT&T SPECIFICATIONS
- 15. IT IS A VIOLATION OF LAW FOR ANY PERSONS, UNLESS THEY ARE ACTING UNDER THE DIRECTION OF A LICENSED PROFESSIONAL ENGINEER, TO ALTER THIS DOCUMENT
- 16. ALL (N) CABLING AND EQUIPMENT MUST BE INSTALLED AND USED IN ACCORDANCE WITH THE PRODUCT'S INCLUDED INSTRUCTIONS, LISTING AND/OR LABELING REQUIREMENTS. PER NEC SECTION 110.3(B)
- 17. THE FACILITY IS UNMANNED AND NOT FOR HUMAN HABITATION. A TECHNICIAN WILL VISIT THE SITE AS REQUIRED FOR ROUTINE MAINTENANCE. THE PROJECT WILL NOT RESULT IN ANY SIGNIFICANT DISTURBANCE OR EFFECT ON DRAINAGE; NO SANITARY SEWER SERVICE, POTABLE WATER, OR TRASH DISPOSAL IS REQUIRED AND NO COMMERCIAL SIGNAGE IS PROPOSED.
- 18. PENETRATIONS SHALL BE FIRE-STOPPED AND OPENINGS SHALL BE PROTECTED THROUGH FIRE-RATED WALLS, FLOOR, ROOF AND CEILING ASSEMBLIES AS REQUIRED BY THE 20 18 IBC CHAPTER 7.
- 19. STRUCTURAL ANALYSIS IS NOT WITHIN THE SCOPE OF WORK CONTAINED IN THIS DRAWINGS SET. FOR ANALYSIS OF EXISTING AND/OR PROPOSED COMPONENTS, REFER TO STRUCTURAL ANALYSIS PROVIDED BY J5 UNDER SEPARATE COVER.
- 20. ANTENNA MOUNT ANALYSIS IS NOT WITHIN THE SCOPE OF WORK CONTAINED IN THIS DRAWING SET. FOR ANALYSIS OF MOUNT TO SUPPORT PROPOSED
- 21. TOWER ANALYSIS TO BE CONDUCTED AND PROVIDED BY TOWER OWNER. FOR ANALYSIS OF EXISTING AND/OR PROPOSED COMPONENTS, REFER TO TOWER STRUCTURAL ANALYSIS UNDER SEPARATE COVER.

APPLICABLE CODES, REGULATIONS AND STANDARDS:

- 1. SUBCONTRACTOR'S WORK SHALL COMPLY WITH ALL APPLICABLE NATIONAL, STATE, AND LOCAL CODES AS ADOPTED BY THE LOCAL AUTHORITY HAVING JURISDICTION (AHJ) FOR THE LOCATION.
- 2. THE EDITION OF THE AHJ ADOPTED CODES AND STANDARDS IN EFFECT ON THE DATE OF CONTRACT AWARD SHALL GOVERN THE DESIGN.
- 3. SUBCONTRACTOR'S WORK SHALL COMPLY WITH THE LATEST EDITION OF THE FOLLOWING STANDARDS:
- 3.1. AMERICAN CONCRETE INSTITUTE (ACI) 318, BUILDING CODE REQUIREMENTS FOR STRUCTURAL CONCRETE

COMPONENTS, REFER TO ANTENNA MOUNT STRUCTURAL ANALYSIS PROVIDED BY J5 UNDER SEPARATE COVER.

AMERICAN INSTITUTE OF STEEL CONSTRUCTION (AISC), MANUAL OF STEEL CONSTRUCTION, LRFD, FOURTEENTH EDITION

IEEE 1100 (1999) RECOMMENDED PRACTICE FOR POWERING AND GROUNDING OF ELECTRICAL EQUIPMENT.

- 3.3. TELECOMMUNICATIONS INDUSTRY ASSOCIATION (TIA/EIA) 222-H, STRUCTURAL STANDARD FOR ANTENNA SUPPORTING STRUCTURES AND ANTENNAS
- 3.4. INSTITUTE FOR ELECTRICAL AND ELECTRONICS ENGINEERS (IEEE) 81, GUIDE FOR MEASURING EARTH RESISTIVITY, GROUND IMPEDANCE, AND EARTH SURFACE POTENTIALS OF A GROUND SYSTEM
- IEEE C62.41, RECOMMENDED PRACTICES ON SURGE VOLTAGES IN LOW VOLTAGE AC POWER CIRCUITS (FOR LOCATION CATEGORY "C3" AND "HIGH SYSTEM EXPOSURE")
- TIA 607 COMMERCIAL BUILDING GROUNDING AND BONDING REQUIREMENTS FOR TELECOMMUNICATIONS TELCORDIA GR-63 NETWORK
- 3.7. EQUIPMENT-BUILDING SYSTEM (NEBS): PHYSICAL PROTECTION
- TELCORDIA GR-347 CENTRAL OFFICE POWER WIRING
- TELCORDIA GR-1275 GENERAL INSTALLATION REQUIREMENTS 3.9.
- TELCORDIA GR-1503 COAXIAL CABLE CONNECTIONS
- 3.11. ANY AND ALL OTHER LOCAL & STATE LAWS AND REGULATIONS
- 3.12. FOR ANY CONFLICTS BETWEEN SECTIONS OF LISTED CODES AND STANDARDS REGARDING MATERIAL, METHODS OF CONSTRUCTION, OR OTHER REQUIREMENTS, THE MOST RESTRICTIVE SHALL GOVERN. WHERE THERE IS CONFLICT BETWEEN A GENERAL REQUIREMENT AND A SPECIFIC REQUIREMENT, THE SPECIFIC REQUIREMENT SHALL GOVERN.

ABBREVIATIONS:

		ABBR	REVIATIONS:
A.B.	ANCHOR BOLT	FDN.	FOUNDATION
ABV.	ABOVE	F.O.C.	FACE OF CONCRETE
ACCA	ANTENNA CABLE COVER ASSEMBLY	F.O.M.	FACE OF MASONRY
ADD'L	ADDITIONAL	F.O.S.	FACE OF STUD
A.F.F.	ABOVE FINISHED FLOOR	F.O.W.	FACE OF WALL
A.F.G.	ABOVE FINISHED GRADE	F.S.	FINISH SURFACE
ALUM.	ALUMINUM	FT.(')	FOOT (FEET)
ALT.	ALTERNATE	FTĞ.	FOOTING
ANT.	ANTENNA	G.	GROWTH (CABINET)
APPRX.	APPROXIMATE(LY)	GA.	GAUGE
ARCH.	ARCHITECT(URAL)	Gl.	GALVANIZE(D)
AWG.	AMERICAN WIRE GAUGE	G.F.I.	GROUND FAULT CIRCUIT
BLDG.	BUILDING	INTERRHPTER	
BLK.	BLOCK	GLB. (GLU-LAM)	GLUE LAMINATED BEAM
BLKG.	BLOCKING	GPS `	GLOBAL POSITIONING SYSTEM
BM.	BEAM	GRND.	GROUND
B.N.	BOUNDARY NAILING	HDR.	HEADER
BTCW.	BARE TINNED COPPER WIRE	HGR.	HANGER
B.O.F.	BOTTOM OF FOOTING	HT.	HEIGHT
B/U	BACK-UP CABINET	ICGB.	ISOLATED COPPER GROUND BUS
CAB.	CABINET	IN. (")	INCH(ES)
CANT.	CANTILEVER(ED)	INT.	INTERIOR
C.I.P.	CAST IN PLACE	LB.(#)	POUND(S)
CLG.	CEILING	L.B.	LAG BOLTS
CLR.	CLEAR	L.F.	LINEAR FEET (FOOT)
COL.	COLUMN	L.	LONG(ITUDINAL)
CONC.	CONCRETE	MAS.	MASONRY
CONN.	CONNECTION(OR)	MAX.	MAXIMUM
CONST.	CONSTRUCTION	M.B.	MACHINE BOLT
CONT.	CONTINUOUS	MECH.	MECHANICAL
d	PENNY (NAILS)	MFR.	MANUFACTURER
DBL.	DOUBLE	MIN.	MINIMUM
DEPT.	DEPARTMENT	MISC.	MISCELLANEOUS
D.F.	DOUGLAS FIR	MTL.	METAL
DIA.	DIAMETER	(N)	NEW
DIAG.	DIAGONAL	NO.(#)	NUMBER
DIM.	DIMENSION	N.T.S.	NOT TO SCALE
DWG.	DRAWING(S)	O.C.	ON CENTER
DWL.	DOWEL(S)	OPNG.	OPENING
EA.	EACH	P/C	PRECAST CONCRETE
EL.	ELEVATION	PCS	PERSONAL COMMUNICATION
ELEC.	ELECTRICAL	SERVICES	
ELEV.	ELEVATOR	PLY.	PLYWOOD
EMT.	ELECTRICAL METALLIC TUBING	PPC	POWER PROTECTION CABINET
E.N.	EDGE NAIL	PRC	PRIMARY RADIO CABINET
ENG.	ENGINEER	P.S.F.	POUNDS PER SQUARE FOOT
EQ.	EQUAL	P.S.I.	POUNDS PER SQUARE INCH
EXP.	EXPANSION	P.T.	PRESSURE TREATED
EXST.(E)	EXISTING	PWR.	POWER (CABINET)
EXT.	EXTERIOR	QTY.	QUANTITY
FAB.	FABRICATION(OR)	RAD.(R)	RADIUS
F.F.	FINISH FLOOR	REF.	REFERENCE
F.G.	FINISH GRADE	REINF.	REINFORCEMENT(ING)
FINI	FINISH(FD)	PF∩'D/	DE O LIIDED

FINISH(ED)

FLOOR

SCHEDULE
SHEET
SIMILAR
SPECIFICATIONS
SQUARE
STAINLESS STEEL
STANDARD
STEEL
STRUCTURAL
TEMPORARY
THICK(NESS)
TOE NAIL
TOP OF ANTENNA
TOP OF CURB
TOP OF FOUNDATION
Top of plate (parapet)
TOP OF STEEL
TOP OF WALL
TYPICAL
UNDER GROUND
UNDERWRITERS LABORATORY
UNLESS NOTED OTHERWISE
VERIFY IN FIELD
WIDE (WIDTH)
WITH
WOOD
WEATHERPROOF
WEIGHT
CENTERLINE
PLATE, PROPERTY LINE

SCH.

SHT.

SIM.

SPEC.

SQ.

S.S.

STD.

STL.

STRUC

TEMP.

THK.

T.N.

T.O.A

T.O.C

T.O.F.

T.O.P.

T.O.S.

T.O.W

TYP.

U.G.

U.L.

U.N.O

V.I.F.

WD.

W.P.

SYMBOLS LEGEND:


OFFICE

REQUIRED

RIGID GALVANIZED STEEL

ROOM NAME ROOM NUMBER

REQ'D/

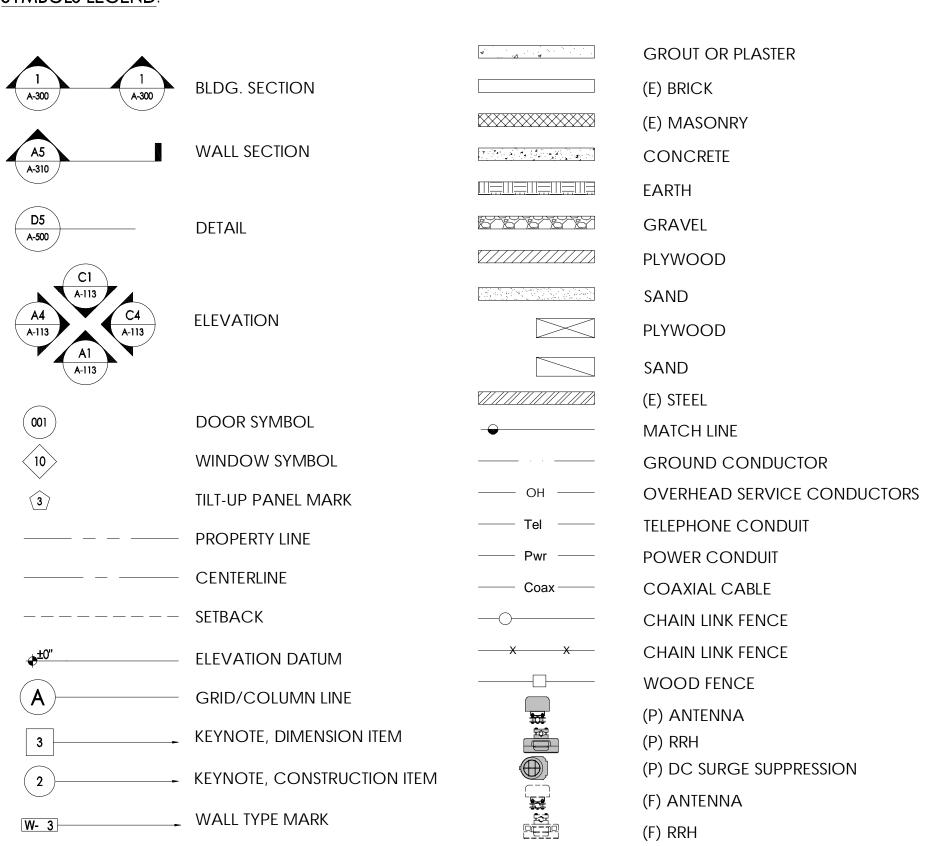

(E) EQUIPMENT

PREPARED FOR 1355 W. UNIVERSITY MESA, ARIZONA 85201 Vendor: "

| INFRASTRUCTURE 23 MAUCHLY #110 IRVINE, CA 92618 J5 PROJECT ID: P-097567 Issued For: **AZL05904** SCOTTSDALE RELO TEMP FA: 16322547 USID: 328886 7191 E DYNAMITE BLVD. SCOTTSDALE, AZ 85266 PARCEL ID: 212-10-266A DRAWN BY: SLM CHECKED BY: KM THE INFORMATION CONTAINED IN THE SET OF DRAWINGS IS PROPRIETARY & CONFIDENTIAL TO AT&T WIRELESS ANY USE OR DISCLOSURE OTHER THAN AS IT RELATES TO AT&T WIRELESS IS STRICTLY PROHIBITED REV DATE BY DESCRIPTION A 1/18/24 SLM 90%ZD 2/6/24 RT 90%ZD Licensor:

Sheet Title:

Sheet Number:

GENERAL NOTES

GN-1

SITE WORK GENERAL NOTES:

- 1. THE SUBCONTRACTOR SHALL CONTRACT UTILITY LOCATING SERVICES PRIOR TO THE START OF CONSTRUCTION.
- ALL EXISTING ACTIVE SEWER, WATER, GAS, ELECTRIC, AND OTHER UTILITIES WHERE ENCOUNTERED IN THE WORK, SHALL BE PROTECTED AT ALL TIMES AND WHERE REQUIRED FOR THE PROPER EXECUTION OF THE WORK, SHALL BE RELOCATED AS DIRECTED BY CONTRACTOR. EXTREME CAUTION SHOULD BE USED BY THE SUBCONTRACTOR WHEN EXCAVATING OR DRILLING PIERS AROUND OR NEAR UTILITIES, SUBCONTRACTOR SHALL PROVIDE SAFETY TRAINING FOR THE WORKING CREW. THIS WILL INCLUDE BUT NOT BE LIMITED TO A.) FALL PROTECTION B.) CONFINED SPACE C.) ELECTRICAL SAFETY D.) TRENCHING AND EXCAVATION.
- 3. ALL SITE WORK SHALL BE AS INDICATED ON THE STAMPED CONSTRUCTION DRAWINGS AND PROJECT SPECIFICATIONS.
- 4. IF NECESSARY, RUBBISH, STUMPS, DEBRIS, STICKS, STONES, AND OTHER REFUSE SHALL BE REMOVED FROM THE SITE AND DISPOSED OF LEGALLY.
- 5. ALL EXISTING INACTIVE SEWER, WATER, GAS, ELECTRIC, AND OTHER UTILITIES, WHICH INTERFERE WITH THE EXECUTION OF THE WORK, SHALL BE REMOVED AND/OR CAPPED, PLUGGED, OR OTHERWISE DISCONNECTED AT POINTS WHICH WILL NOT INTERFERE WITH THE EXECUTION OF THE WORK, SUBJECT TO THE APPROVAL OF CONTRACTOR, OWNER, AND/OR LOCAL UTILITIES.
- 6. THE SUBCONTRACTOR SHALL PROVIDE SITE SIGNAGE IN ACCORDANCE WITH THE TECHNICAL SPECIFICATION FOR SITE SIGNAGE.
- 7. THE SITE SHALL BE GRADED TO CAUSE SURFACE WATER TO FLOW AWAY FROM THE BTS EQUIPMENT AND TOWER AREAS.
- 8. NO FILL OR EMBANKMENT MATERIAL SHALL BE PLACED ON FROZEN GROUND. FROZEN MATERIALS, SNOW, OR ICE SHALL BE PLACED IN ANY FILL OR EMBANKMENT
- 9. THE SUB GRADE SHALL BE COMPACTED AND BROUGHT TO A SMOOTH UNIFORM GRADE PRIOR TO FINISHED SURFACE APPLICATION.
- 10. THE AREAS OF THE OWNERS PROPERTY DISTURBED BY THE WORK AND NOT COVERED BY THE TOWER, EQUIPMENT, OR DRIVEWAY, SHALL BE GRADED TO A UNIFORM SLOPE AND STABILIZED TO PREVENT EROSION AS SPECIFIED ON THE PROJECT SPECIFICATIONS.
- 11. SUBCONTRACTOR SHALL MINIMIZE DISTURBANCE TO EXISTING SITE DURING CONSTRUCTION. EROSION CONTROL MEASURES, IF REQUIRED DURING CONSTRUCTION, SHALL BE IN CONFORMANCE WITH THE LOCAL GUIDELINES FOR EROSION AND SEDIMENT CONTROL.
- 12. NOTICE TO PROCEED NO WORK TO COMMENCE PRIOR TO COMPANY'S WRITTEN NOTICE TO PROCEED AND THE ISSUANCE OF A PURCHASE ORDER.
- 13. ALL CONSTRUCTION MEANS AND METHODS: INCLUDING BUT NOT LIMITED TO, ERECTION PLANS, RIGGING PLANS, CLIMBING PLANS, AND RESCUE PLANS SHALL BE THE RESPONSIBILITY OF THE GENERAL CONTRACTOR RESPONSIBLE FOR THE EXECUTION OF THE WORK CONTAINED HEREIN AND SHALL ADHERE TO ANSI/TIA-1019 (LATEST EDITION) INCLUDING THE REQUIRED INVOLVEMENT OF A QUALIFIED ENGINEER FOR CLASS IV CONSTRUCTION.

CONCRETE AND REINFORCING STEEL NOTES:

- 1. ALL CONCRETE WORK SHALL BE IN ACCORDANCE WITH THE ACI 301, ACI 318, ACI 336, ASTM A184, ASTM A185, AND THE DESIGN AND CONSTRUCTION SPECIFICATION FOR CAST-IN-PLACE CONCRETE.
- 2. ALL CONCRETE SHALL HAVE A MINIMUM COMPESSIVE STRENGTH OF 2,500 PSI AT 28 DAYS, UNLESS NOTED OTHERWISE. SLAB FOUNDATION DESIGN ASSUMING ALLOWABLE SOIL BEARING PRESSURE OF 2000 PSF.
- 3. REINFORCING STEEL SHALL CONFORM TO ASTM A615, GRADE 60, DEFORMED UNLESS NOTED OTHERWISE. WELDED WIRE FABRIC SHALL CONFORM TO ASTM A185 WELDED STEEL WIRE FABRIC UNLESS NOTED OTHERWISE. SPLICES SHALL BE CLASS "B" AND ALL HOOKS SHALL BE STANDARD. UNO.
- 4. THE FOLLOWING MINIMUM CONCRETE COVER SHALL BE PROVIDED FOR REINFORCING STEEL UNLESS SHOWN OTHERWISE ON DRAWINGS.
- 4.1. CONCRETE CAST AGAINST EARTH: 3" MIN.
- 4.2. CONCRETE EXPOSED TO WEATHER:
- 4.2.1. #6 AND LARGER -
- 2" MIN. 1 1/2" MIN. 4.2.2. #5 AND SMALLER & WWF. -
- 4.3. CONCRETE NOT EXPOSED TO WEATHER OR NOT CAST AGAINST THE GROUND:
- 4.3.1. SLAB AND WALLS
- 3/4" MIN. 1 1/2" MIN. 4.3.2. BEAMS AND COLUMNS
- 5. A 3/4" CHAMFER SHALL BE PROVIDED AT ALL EXPOSED EDGES OF CONCRETE, UNLESS NOTED OTHERWISE, IN ACCORDANCE WITH ACI 301 SECTION 4.2.4

GENERAL NOTES:

- 1. FOR THE PURPOSE OF CONSTRUCTION DRAWING, THE FOLLOWING DEFINITIONS SHALL APPLY: **CONTRACTOR** -J5 INFRASTRUCTURE PARTNERS SUBCONTRACTOR - GENERAL CONTRACTOR (CONSTRUCTION)
 - CARRIER OEM -ORIGINAL EQUIPMENT MANUFACTURER
- 2. PRIOR TO THE SUBMISSION OF BIDS, THE BIDDING SUBCONTRACTOR SHALL VISIT THE CELL SITE TO FAMILIARIZE THEMSELVES, WITH THE EXISTING CONDITIONS AND TO CONFIRM THAT THE WORK CAN BE ACCOMPLISHED AS SHOWN ON THE CONSTRUCTION DRAWINGS. ANY DISCREPANCY FOUND SHALL BE BROUGHT TO THE ATTENTION OF THE CONTRACTOR AND
- ALL MATERIALS FURNISHED AND INSTALLED SHALL BE IN STRICT ACCORDANCE WITH ALL APPLICABLE CODES, REGULATIONS, AND ORDINANCES. SUBCONTRACTOR SHALL ISSUE ALL APPROPRIATE NOTICES AND COMPLY WITH ALL LAWS, ORDINANCES, RULES, REGULATIONS AND LAWFUL ORDERS OF ANY PUBLIC AUTHORITY REGARDING THE PERFORMANCE OF THE WORK. ALL WORK CARRIED OUT SHALL COMPLY WITH ALL APPLICABLE MUNICIPAL AND UTILITY COMPANY SPECIFICATIONS, AND LOCAL JURISDICTIONAL CODES, ORDINANCES AND APPLICABLE REGULATIONS.
- DRAWINGS PROVIDED HERE ARE NOT TO SCALE AND ARE INTENDED TO SHOW OUTLINE ONLY.
- 5. UNLESS NOTED OTHERWISE, THE WORK SHALL INCLUDE FURNISHING MATERIALS, EQUIPMENT, APPURTENANCES AND LABOR NECESSARY TO COMPLETE ALL INSTALLATIONS AS INDICATED ON THE DRAWINGS.
- 6. 'KITTING LIST' SUPPLIED WITH THE BID PACKAGE IDENTIFIES ITEMS THAT WILL BE SUPPLIED BY CONTRACTOR. ITEMS NOT INCLUDED IN THE BILL OF MATERIALS AND KITTING LIST SHALL BE SUPPLIED BY THE SUBCONTRACTOR.
- THE SUBCONTRACTOR SHALL INSTALL ALL EQUIPMENT AND MATERIALS IN ACCORDANCE WITH MANUFACTURER'S RECOMMENDATIONS UNLESS SPECIFICALLY STATED OTHERWISE.
- 8. IF THE SPECIFIED EQUIPMENT CAN NOT BE INSTALLED AS SHOWN ON THESE DRAWINGS. THE SUBCONTRACTOR SHALL PROPOSE AN ALTERNATIVE INSTALLATION FOR APPROVAL BY THE CONTRACTOR AND AT&T PRIOR TO PROCEEDING WITH ANY SUCH CHANGE OF INSTALLATION.
- 9. SUBCONTRACTOR SHALL DETERMINE ACTUAL ROUTING OF CONDUIT, POWER AND T1 CABLES, GROUNDING CABLES AS SHOWN ON THE POWER, GROUNDING AND TELCO PLAN DRAWINGS.
- 10. THE SUBCONTRACTOR SHALL PROTECT EXISTING IMPROVEMENTS, PAVEMENTS, CURBS, LANDSCAPING AND STRUCTURES. ANY DAMAGED PART SHALL BE REPAIRED AT THE SUBCONTRACTOR'S EXPENSE; TO THE SATISFACTION OF THE OWNER.
- 11. SUBCONTRACTOR SHALL LEGALLY AND PROPERLY DISPOSE OF ALL SCRAP MATERIALS SUCH AS COAXIAL CABLES AND OTHER ITEMS REMOVED FROM THE EXISTING FACILITY. ANTENNAS REMOVED SHALL BE RETURNED TO THE OWNER'S DESIGNATED LOCATION.
- 12. SUBCONTRACTOR SHALL LEAVE PREMISES IN CLEAN CONDITION, TRASH AND DEBRIS SHOULD BE REMOVED FROM SITE ON A DAILY BASIS.

PREPARED FOR



1355 W. UNIVERSITY MESA, ARIZONA 85201

Vendor:



23 MAUCHLY #110 IRVINE, CA 92618

J5 PROJECT ID: P-097567

Issued For:

AZL05904

SCOTTSDALE RELO TEMP FA: 16322547 USID: 328886

7191 E DYNAMITE BLVD. SCOTTSDALE, AZ 85266 PARCEL ID: 212-10-266A

DRAWN BY: SLM

CHECKED BY: KM

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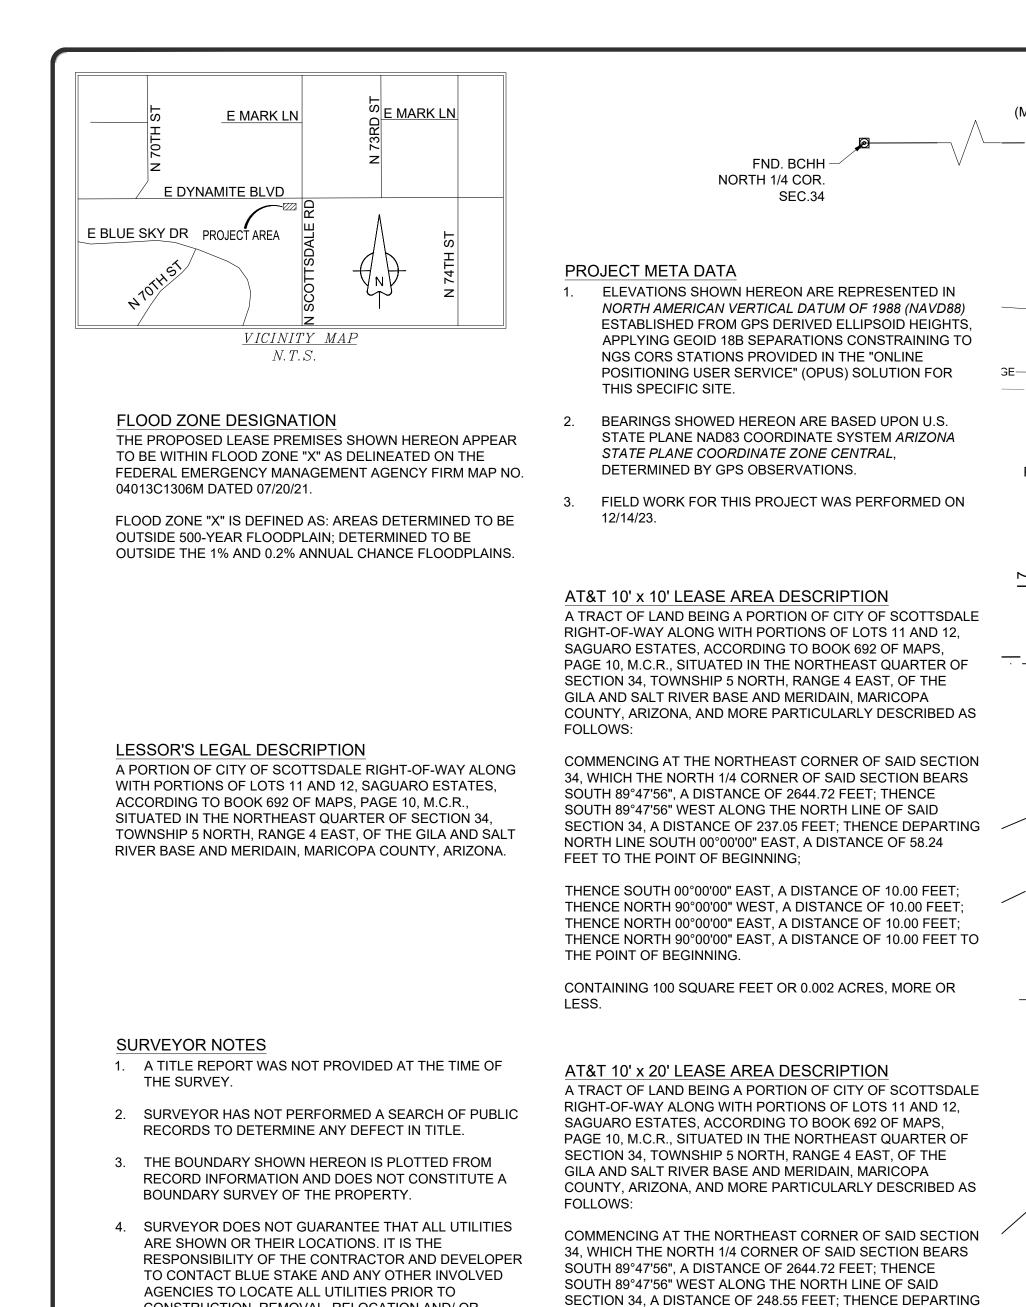
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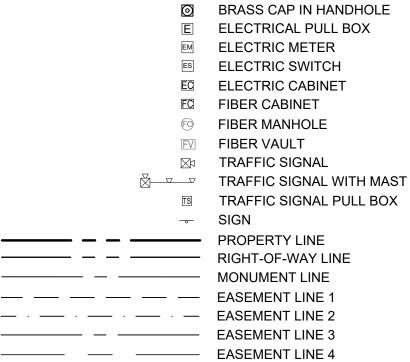
GENERAL NOTES

Sheet Number:



CONSTRUCTION. REMOVAL, RELOCATION AND/ OR REPLACEMENT IS THE RESPONSIBILITY OF THE CONTRACTOR.

LEGEND



NORTH


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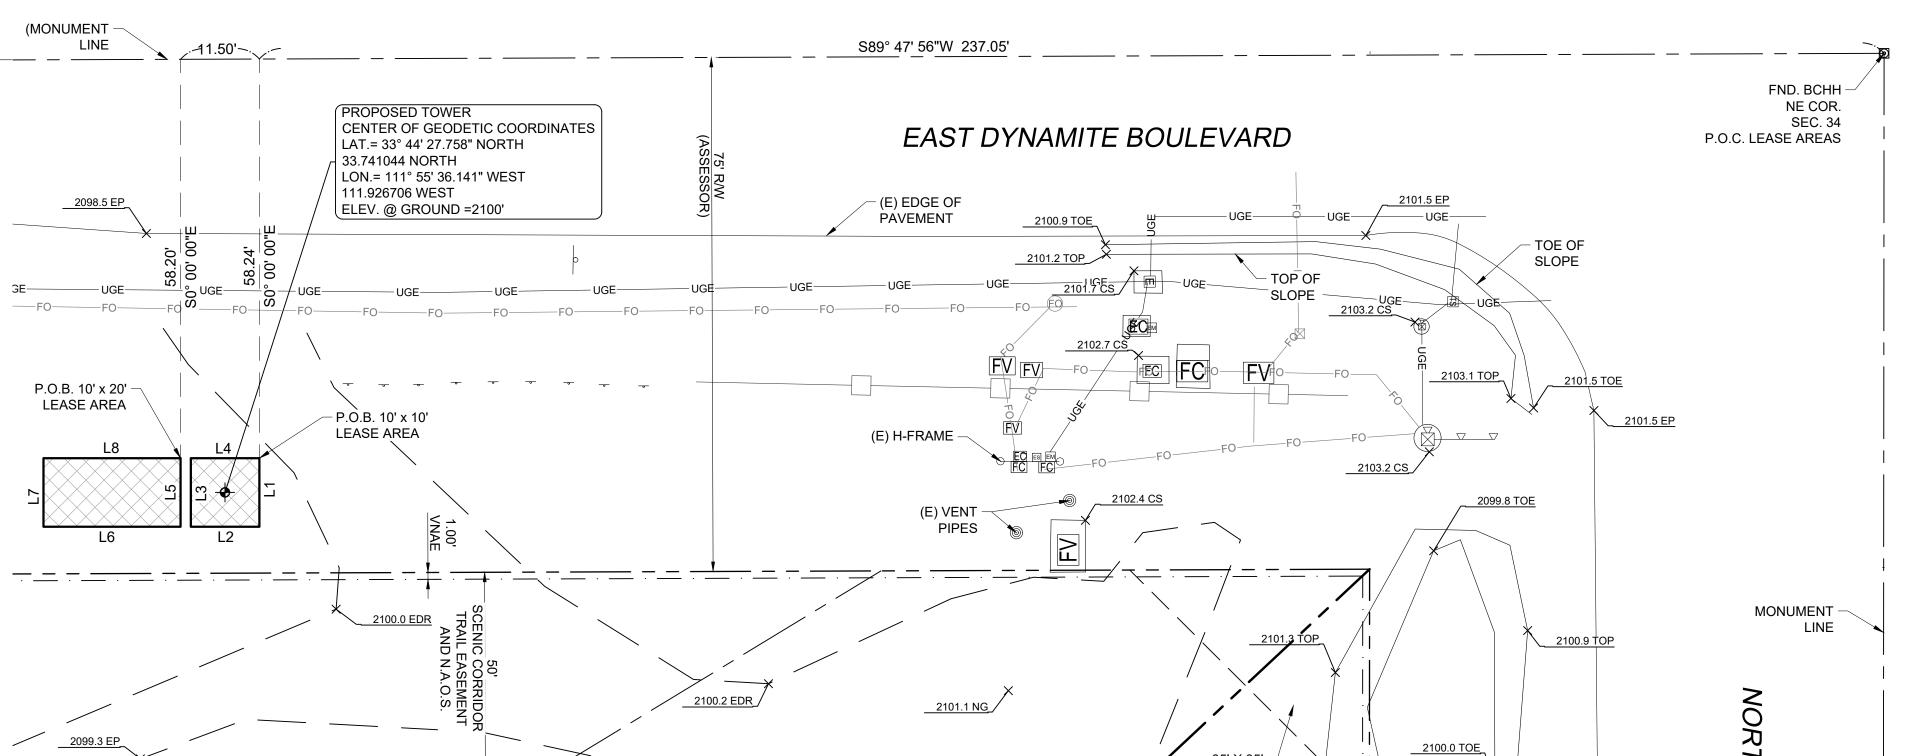
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THE POINT OF BEGINNING.



SEC.34



PARCEL

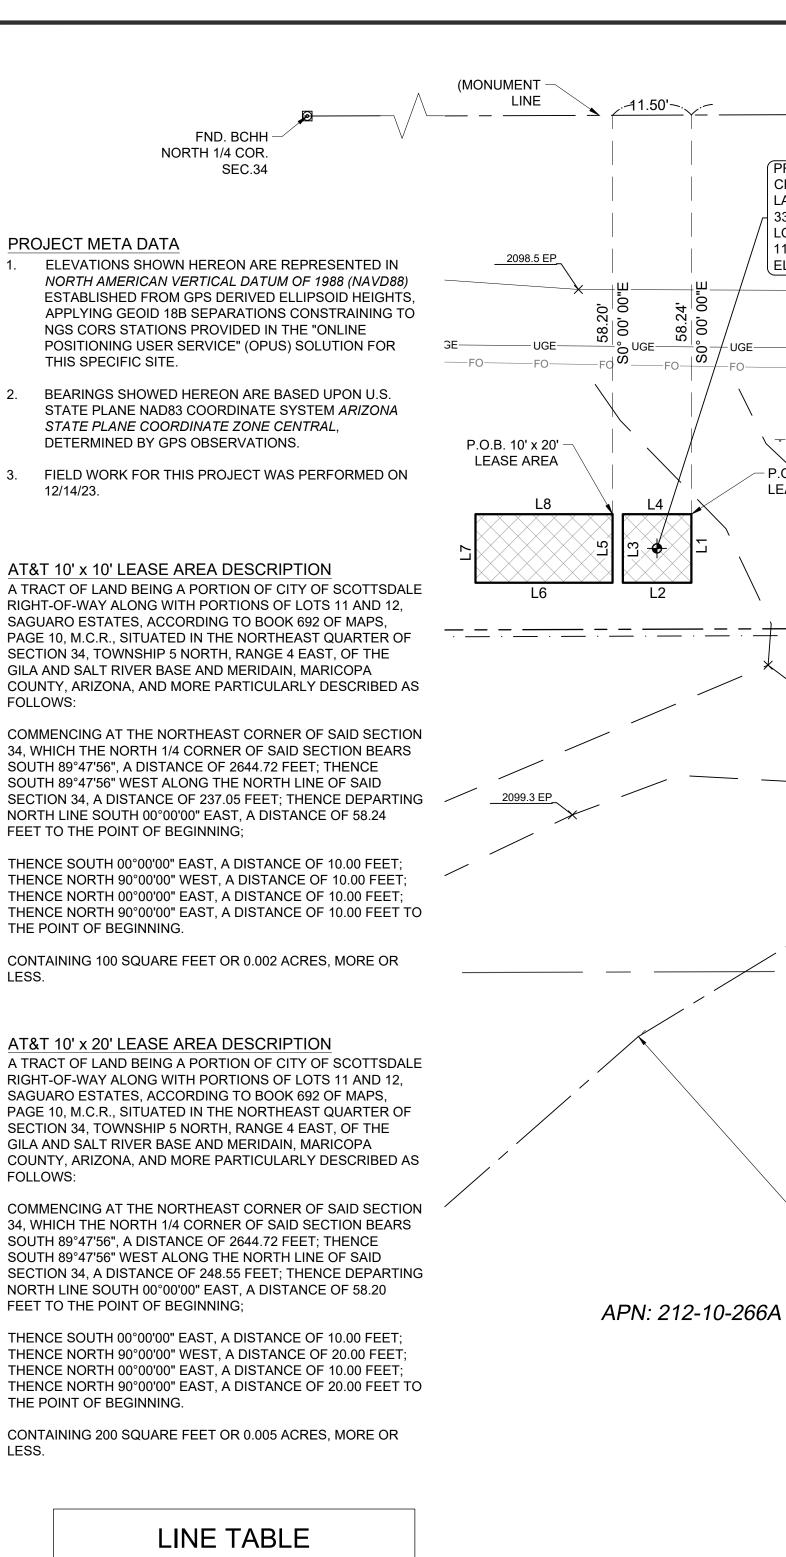2099.6 NG

2099.0 NG

35' X 35' -

V.T.E.

TOP OF -

SLOPE

SCENIC CORRIDOR

TRAIL EASEMENT

AND N.A.O.S.

2100.9 EDR

(E) EDGE OF

DIRT ROAD

TOE OF

SLOPE

2101.3 TOP

___2100.6 EP

ر_2101.4 NG

____2098.5 TOE

2099.0 TOE






FIELD BY:	TG
DRAWN BY:	JMM
CHECKED BY:	RLF

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PROJECT No.	
23013003	
SITE NAME:	
AZL05904	


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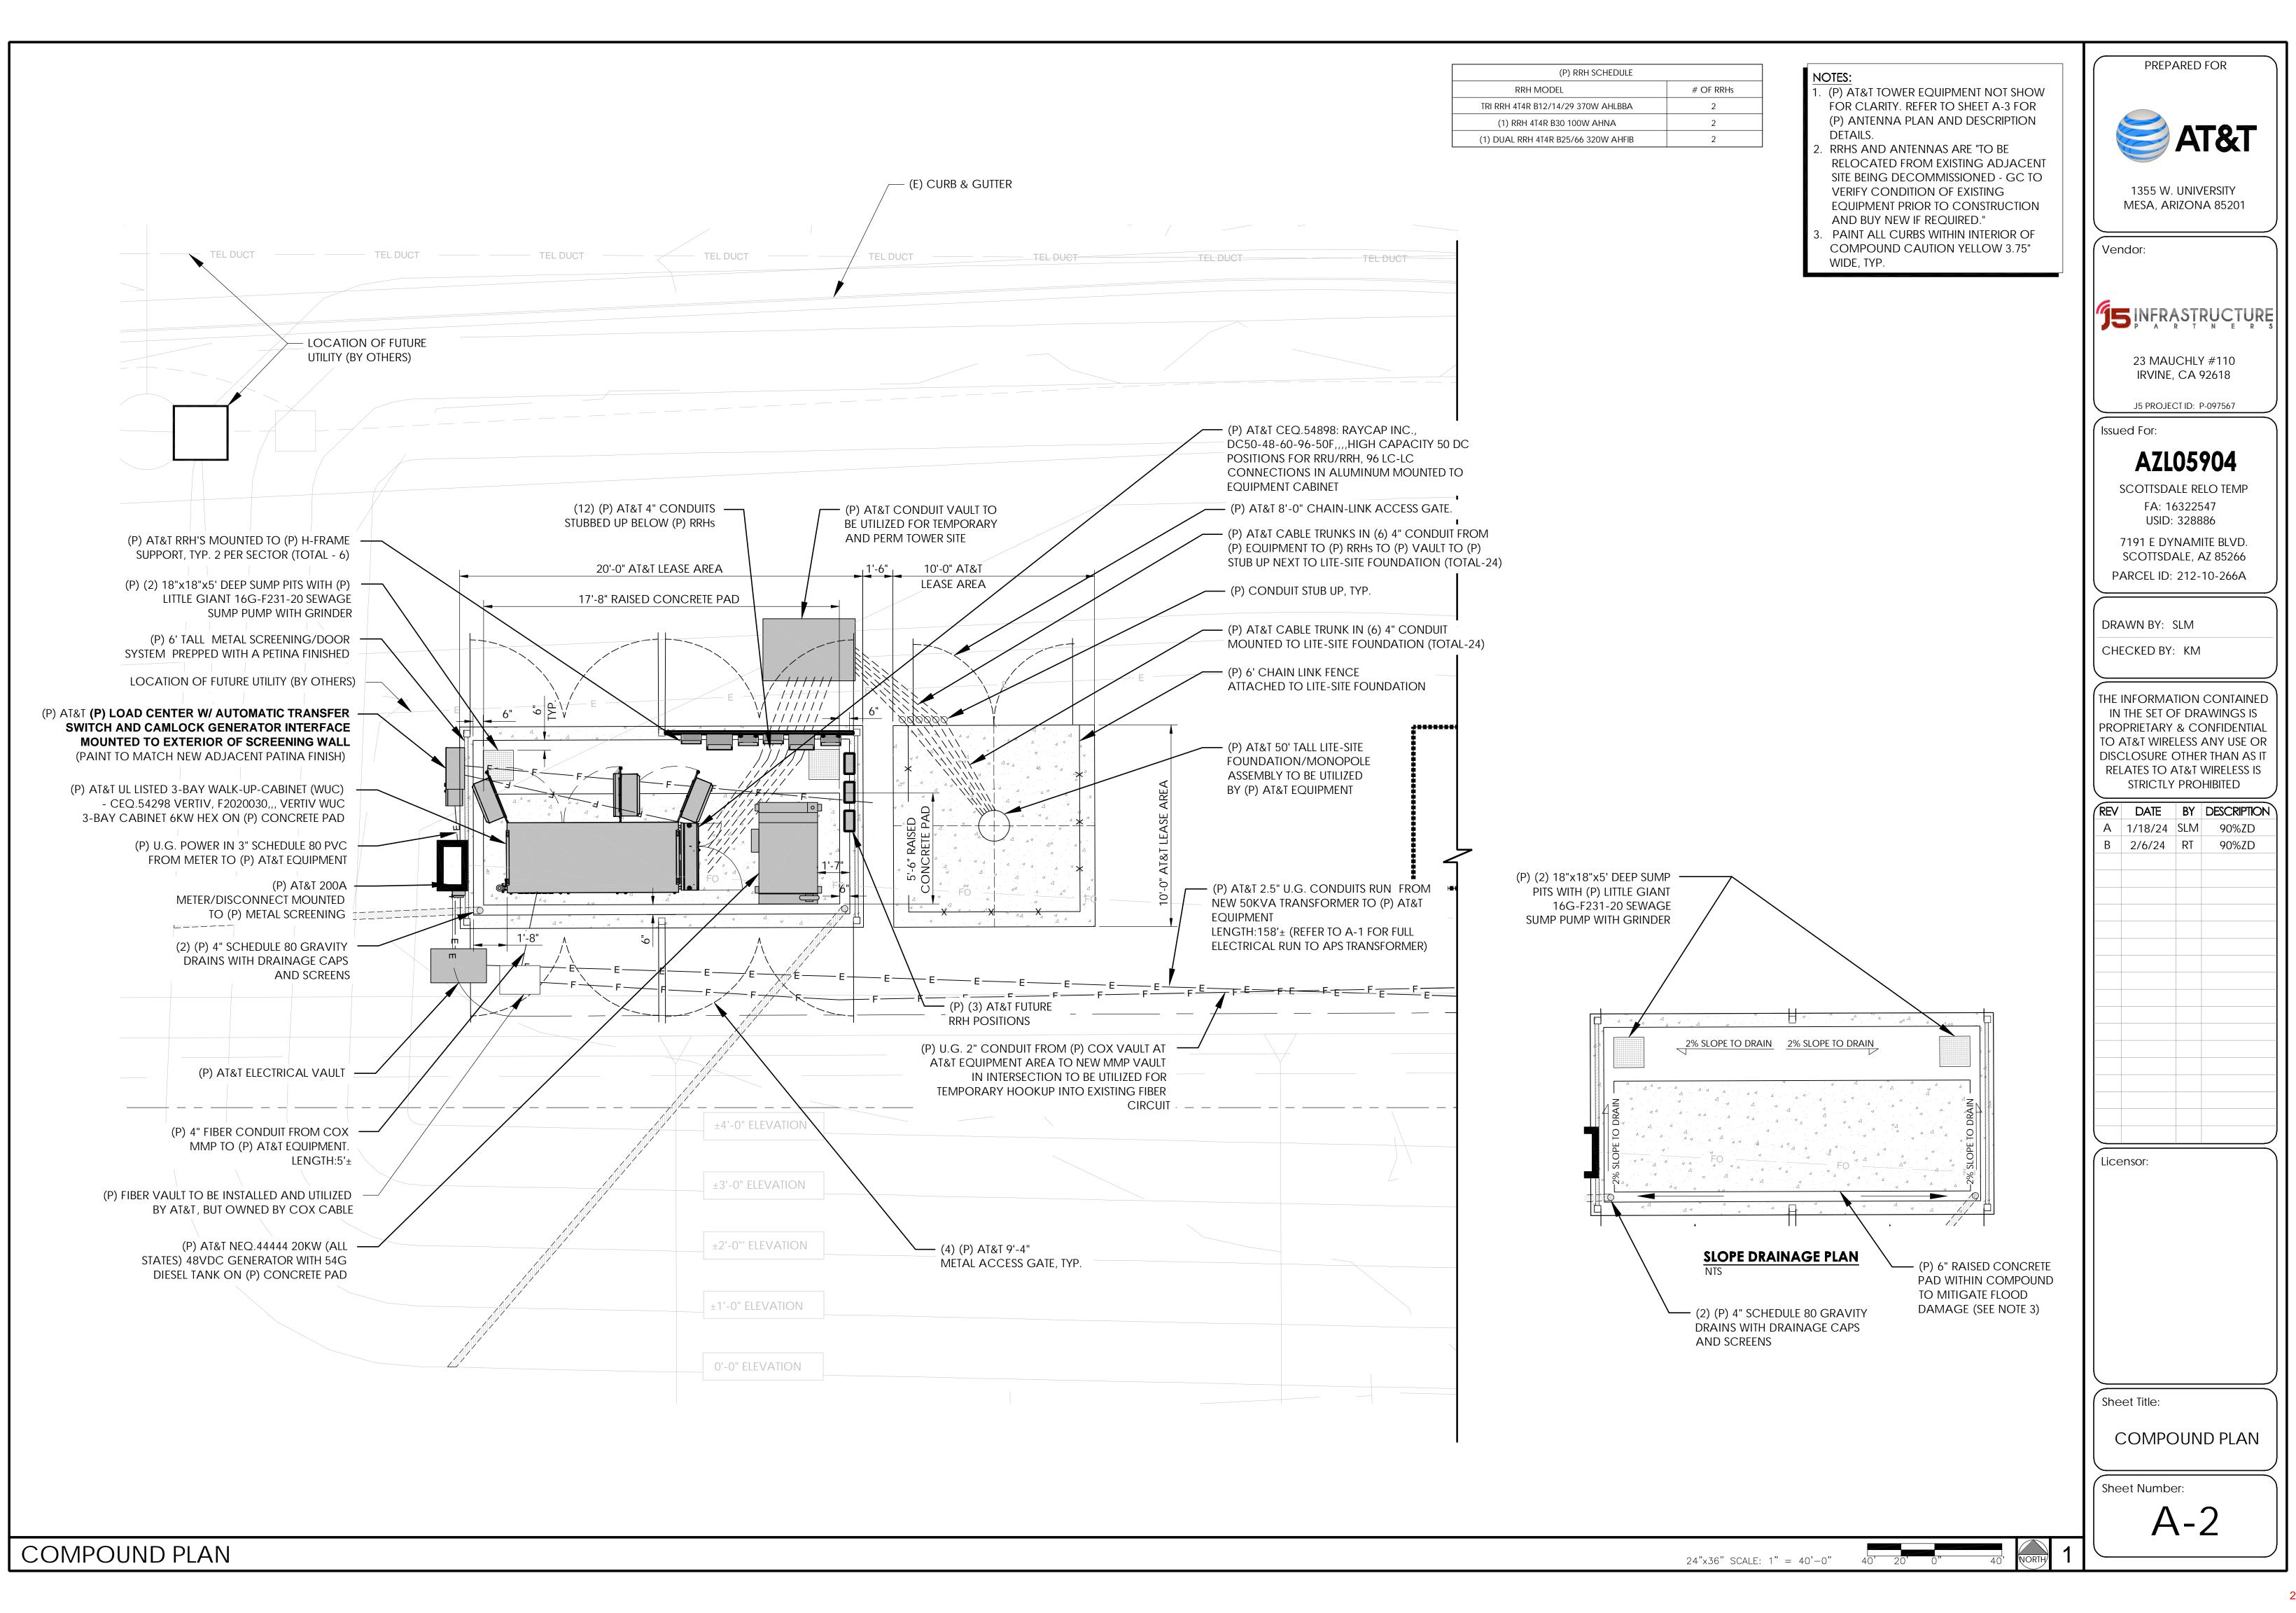
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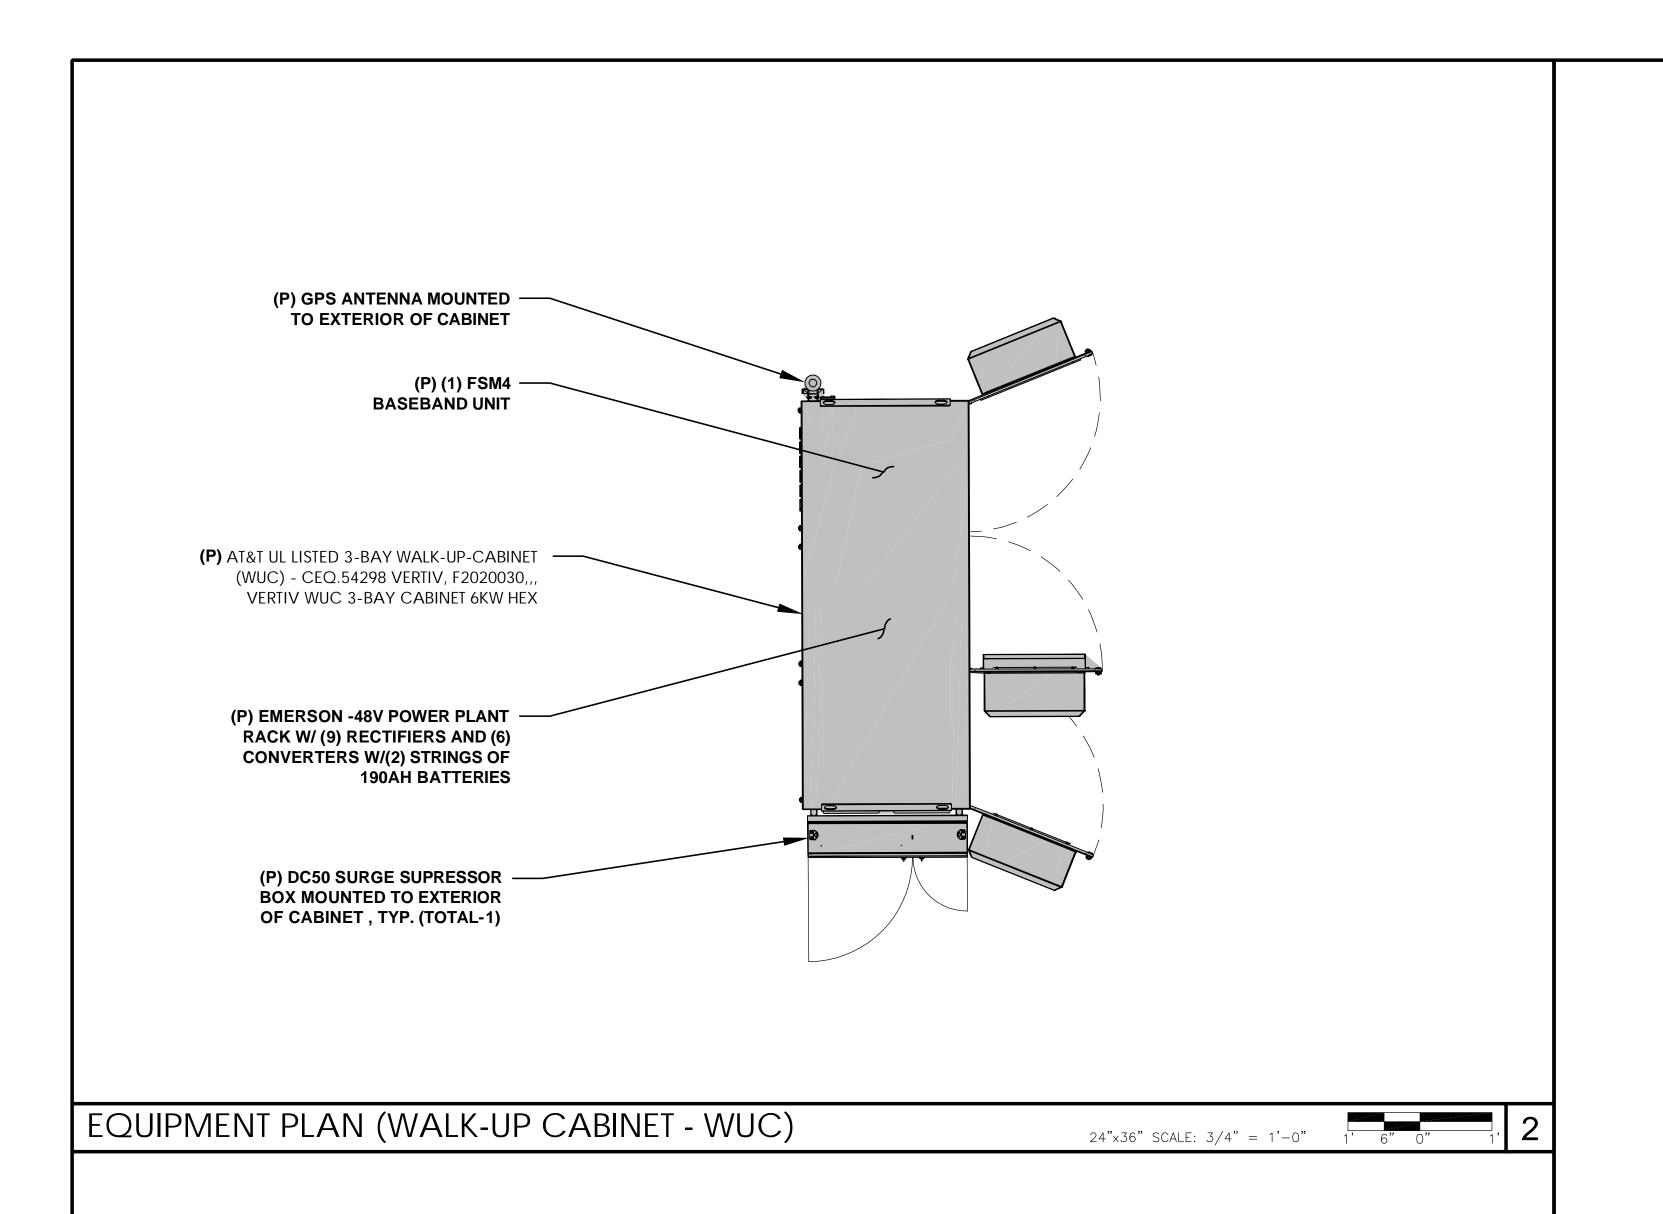
TOPOGRAPHIC SURVEY

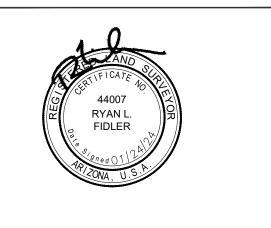SHEET NO.

REVISION: LS-'





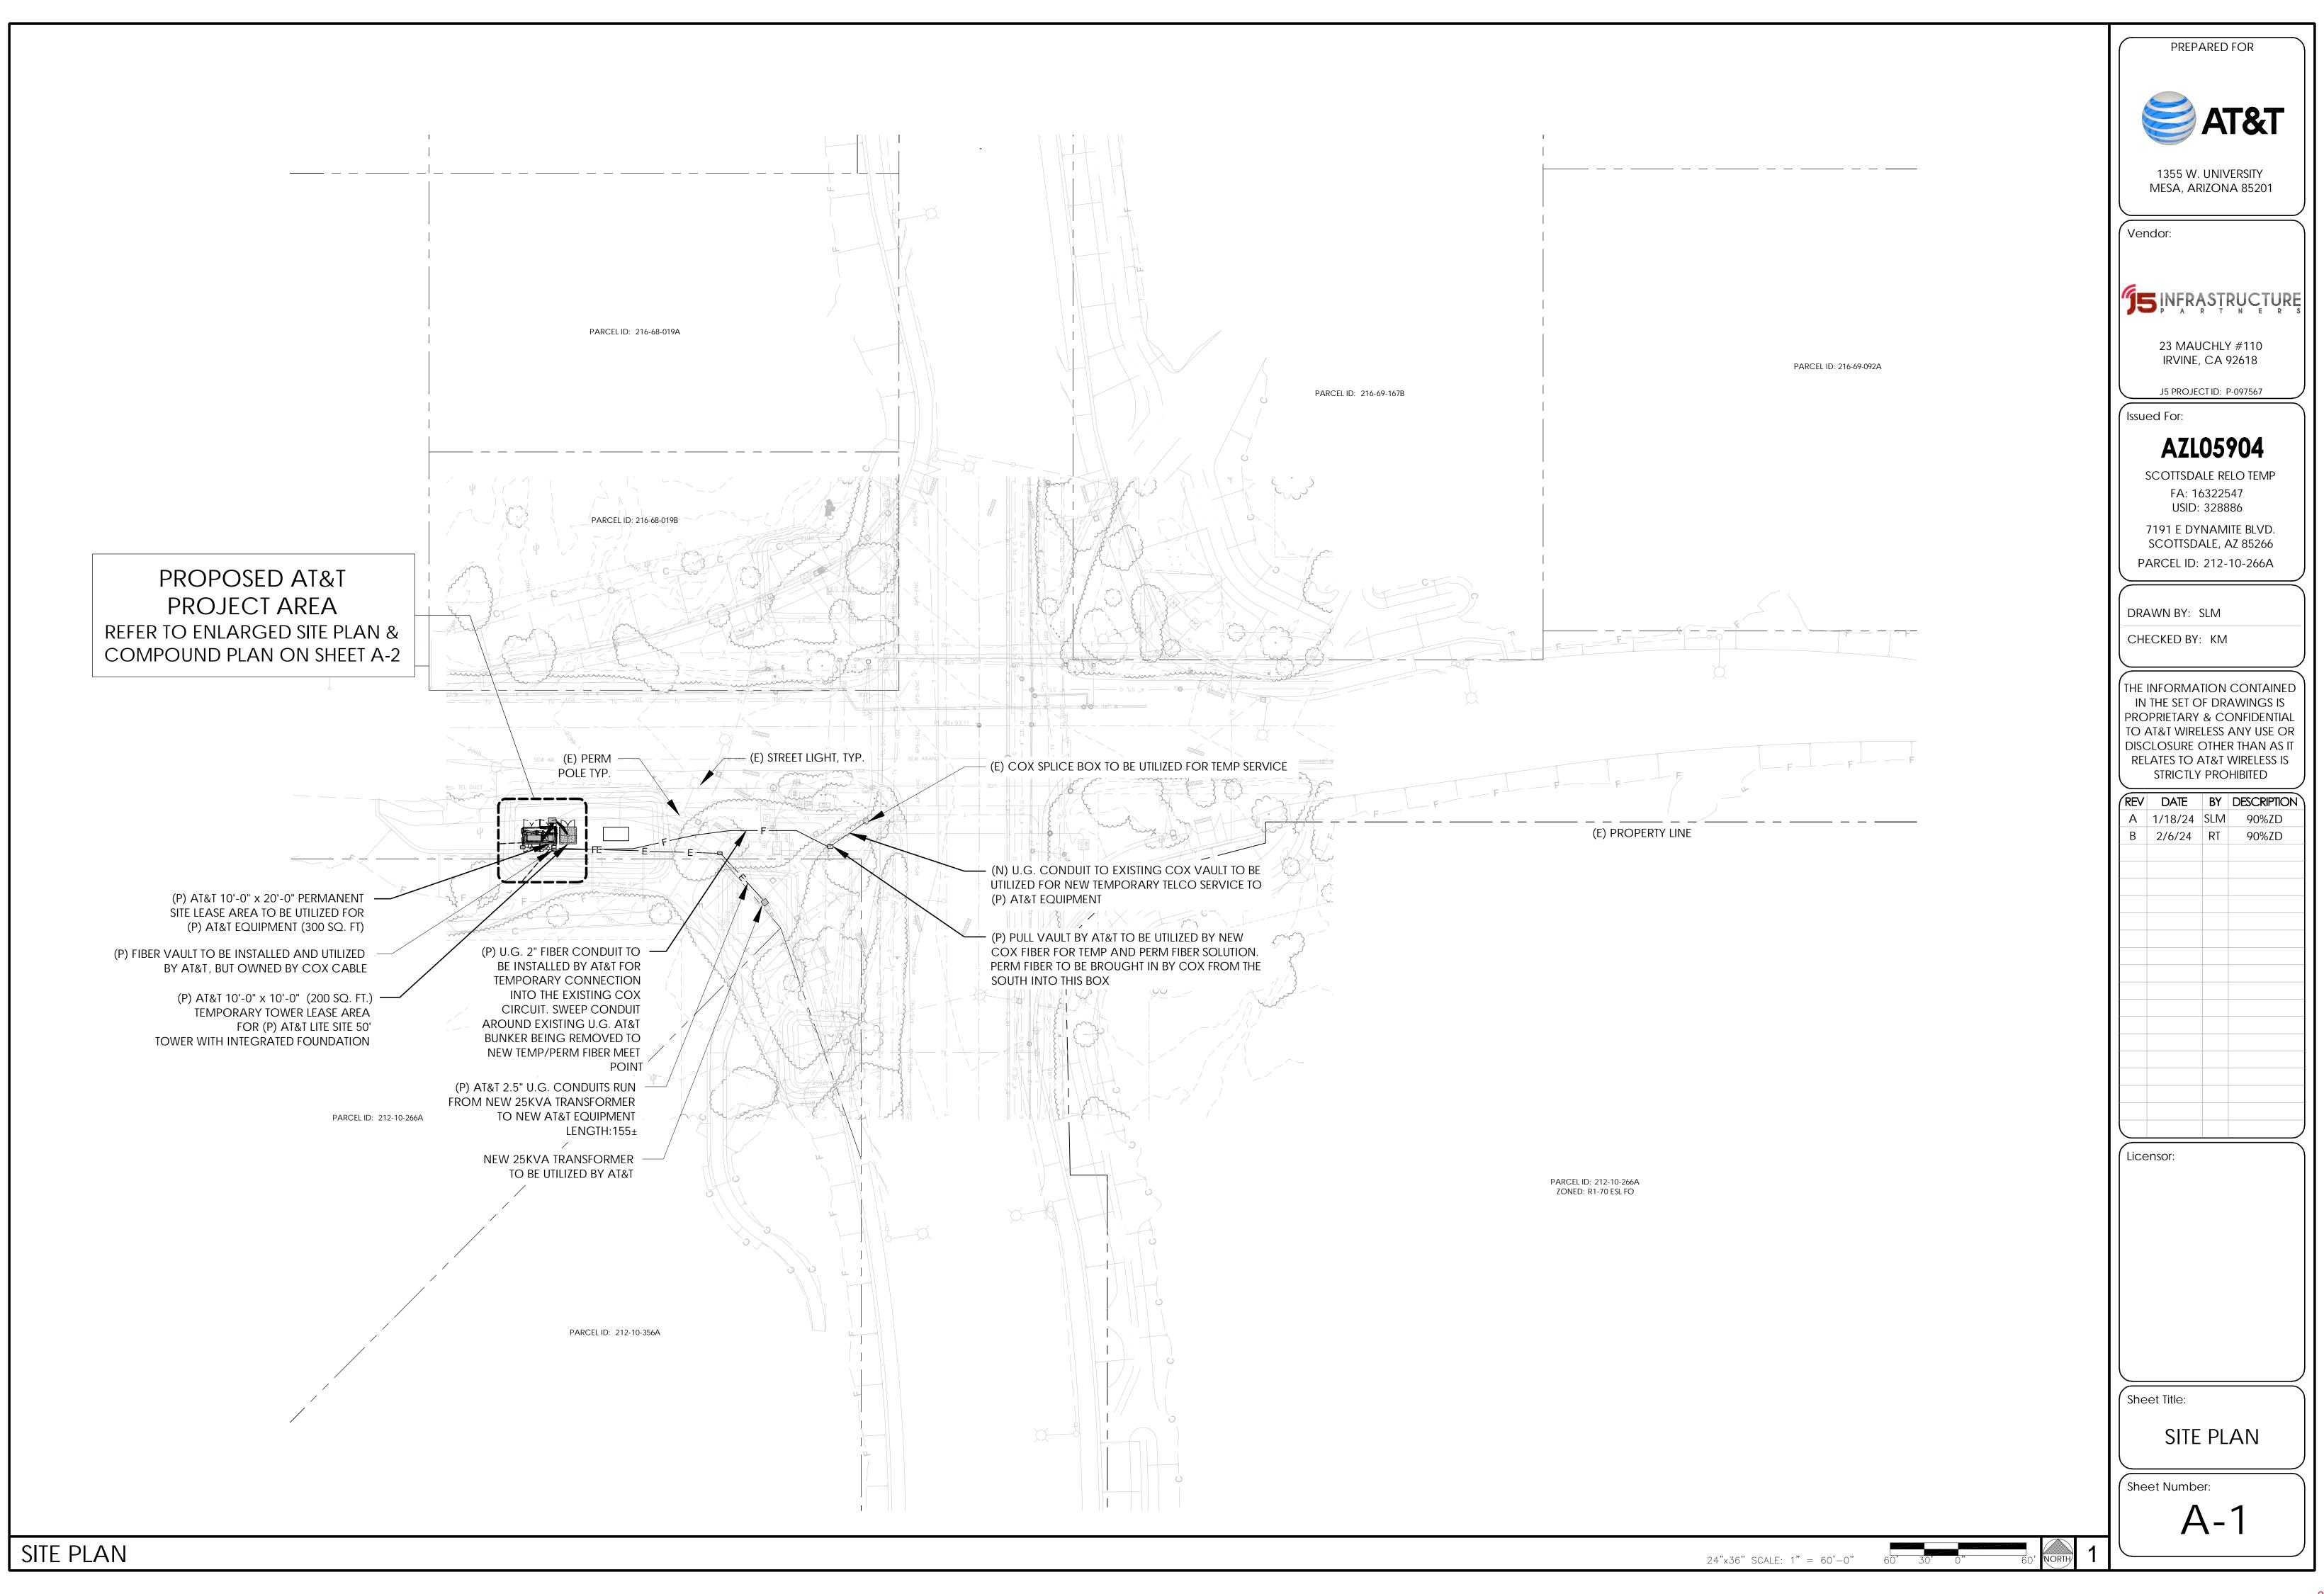

STRUCTURAL ANALYSIS NOTE:

1. ALL RELEVANT STRUCTURAL ANALYSIS IS UNDER A SEPARATE PERMIT BY OTHERS.

NOTE

- 1. ALL (P) CABLING AND EQUIPMENT MUST BE INSTALLED AND USED IN ACCORDANCE WITH THE PRODUCT'S INCLUDED INSTRUCTIONS, LISTING AND/OR LABELING REQUIREMENTS. PER NEC SECTION 110.3(B).
- ALL (P) CABLING CONFORMS WITH, AND IS TO BE INSTALLED PER NEC 356.10 & 356.12.
 RRHS AND ANTENNAS ARE "TO BE RELOCATED FROM EXISTING ADJACENT SITE BEING DECOMMISSIONED GC TO VERIFY CONDITION OF EXISTING EQUIPMENT PRIOR TO CONSTRUCTION

AND BUY NEW IF REQUIRED."

STAT&T

PREPARED FOR

1355 W. UNIVERSITY MESA, ARIZONA 85201

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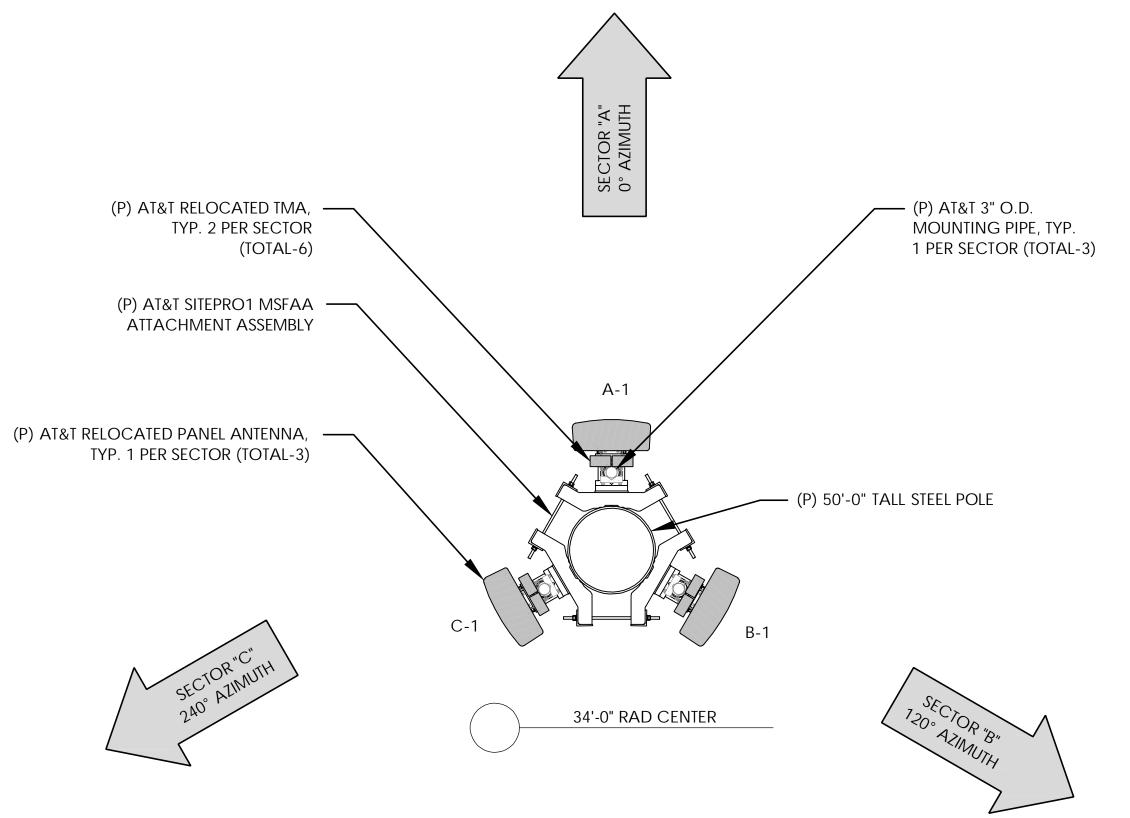


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ANTENNA PLAN &
SCHEDULE &
EQUIPMENT PLAN

Sheet Number:

A-3



	(P) ANTENNA SCHEDULE				
	POS	RAD CENTER	AZIMUTH	Antenna make	ANTENNA MODEL
SECT "A"	A1	34'-0"	0°	KATHERIN	840-370964K
SECT "B"	B1	34'-0"	120°	KATHERIN	840-370964K
SECT "C"	C1	34'-0"	240°	KATHERIN	840-370964K

24"x36" SCALE: 1/2" = 1'-0"

