DEVELOPMENT REVIEW BOARD REPORT



Meeting Date: March 16, 2023 General Plan Element: Character and Design

General Plan Goal: Foster quality design that enhances Scottsdale as a unique

southwestern desert community.

ACTION

Magnolia Waterside @ Old Town 10-DR-2022 Request for approval of a site plan, landscape plans, building elevations, and associated improvements for a new mixed-use project, consisting of 54 dwelling units and 900 square feet of commercial floor area in a four-story building with tuck-under parking, on a +/- 1-acre site.

SUMMARY

Staff Recommendation

Approve, subject to the attached stipulations (Attachment #6)

Items for Consideration

- Conformance with Development Review Board Criteria staff confirms
- Integration of Sensitive Design Principles staff confirms
- Location of required on-site loading/unloading zone
- Conceptual development plan, including preliminary building elevations and site plan, approved as part of case 1-ZN-2020
- DRB recommended approval of development plan (1-ZN-2020) with direction to original applicant to revisit building design (applicant for this case is different from zoning case). See Summary of DRB direction on Page 2 of the DRB Criteria Analysis (Attachment #4).
- Site design includes pedestrian connection from 5th Avenue to canal bank
- Public comment received

BACKGROUND

Location: 6824 E Indian School Rd **Zoning:** D/DMU-2 PBD DO

Adjacent Uses
North: SRP Canal


East: Single-story office/health studio, constructed in the 1960s

South: Two-story bank, originally constructed in the 1980s, minor

exterior remodel approved in 2013 (24-SA-2013)

West: SRP Well Site

Property Owner And MPC Indian School, LLC Do

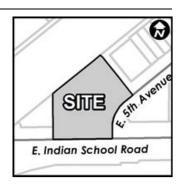

Architect/Designer

Don Wilder / Wilder Architects

Applicant	Engineer
Taylor Farden, MPC Indian School, LLC	Sustainability Engineering Group
817-791-3840	

DEVELOPMENT PROPOSAL

The applicant seeks approval of a mixed-use project, consisting of one four-story multi-family residential building that includes 900 square feet of commercial floor area at the southwest corner of the building. There is no direct access to the site from Indian School Road. Instead, all ingress and egress will occur at the alley along the east property line. With the exception of six surface spaces along the southern edge of the site, all resident parking is provided in a tuck-under garage at grade level. As required by the zoning case (1-ZN-2020), a pedestrian connection is proposed along the east edge of the site to connect pedestrians from 5th Avenue to the canal. The connection will be clearly marked and include pedestrian scale lighting.

Development Review Board Criteria

Staff confirms that the development proposal generally conforms to the applicable Development Review Board Criteria. For a detailed analysis of the Criteria, please see Attachment #4.

Sustainability

The City of Scottsdale promotes the goal of sustainability through the incorporation of appropriate design considerations in the development of the built environment. This development proposal incorporates design elements that align with the City's goal of sustainability, including recessing and deep roof overhangs over balconies and windows to mitigate solar heat gain.

STAFF RECOMMENDED ACTION

Development Review Board Liaison

Phone: 480-312-7713

RESPONSIBLE DEPARTMENTS | STAFF CONTACT

Staff recommends that the Development Review Board approve the Magnolia Waterside @ Old Town development proposal per the attached stipulations, finding that the Character and Design Element of the General Plan, Old Town Scottsdale Urban Design & Architectural Guidelines, and Development Review Board Criteria have been met.

STAIT CONTACT	
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	3/6/2022
	Date
pment Area Manager	3/8/2023 Date
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ATTACHMENTS

- 1. Context Aerial
- 2. Close-up Aerial
- 3. Applicant's Narrative
- 4. Development Review Board Criteria Analysis
- 5. Development Information
- 6. Stipulations / Zoning Ordinance Requirements
- 7. Combined Context Aerial and Site Plan
- 8. Site Plan
- 9. Site Plan (Loading/Unloading)
- 10. Landscape Plan
- 11. Open Space Plan
- 12. Circulation Plan
- 13. Building Elevations (black & white)
- 14. Building Elevations (color)
- 15. Perspectives
- 16. Materials and Colors Board
- 17. Exterior Photometric Analysis
- 18. Exterior Lighting Cutsheets
- 19. Community Involvement





MAGNOLIA WATERSIDE @ OLD TOWN

6824 E Indian School Rd Scottsdale, AZ. 85251

PROJECT NARRATIVE

25 March 2022



Magnolia Property Co.

2435 E Southlake Blvd, S. 150 Southlake, TX 76092 817.769.2580

Wilder Architects, LLC

16904 Club Hill Dr Dallas, TX 75248 214.616.5196

Magnolia Waterside at Old Town

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1. PROPERTY INFORMATION

Location:

E Indian School Road & N 68th Street

Property Size:

Net Area 38,160 SF

Total Site Area:

51,393 SF (approx. 1.17 Acres)

Approved Zoning: Case 1-ZN-2020 was approved by City Council on 8/24/2020; Current

Zoning is D/DMU-2 PDB DO

Context Aerial:



2. PROJECT OVERVIEW

Magnolia Waterside is a new Multifamily project designed to complement the unique character of the downtown setting and existing neighborhood fabric. The development site is an unusually shaped infill site that is bordered to the north by the Arizona Canal, and to the southwest by Indian School Road. The site is located in the Arizona Canal District and acts as the terminus to the Fifth Avenue District, and also borders the Scottsdale Arts District.

The proposed development includes 54 residential units and ground floor non-residential space, consistent with the zoning approval (1-ZN-2020). The project is also consistent with numerous City goals and policies, including the Old Town Scottsdale Character plan and associated design guidelines. The project site is surrounded by a variety of retail, live/work, resort, residential and entertainment businesses within close proximity to the gallery district and a range of employment opportunities.

Photos of existing condition at the site:



View from Indian School Road



View from Indian School Road



View from 5th Avenue



View from 5th Avenue

3. DRB CRITERIA DISCUSSION

DEVELOPMENT REVIEW BOARD CRITERIA

Sec. 1.904: In considering any application for development, the Development Review Board shall be guided by the following criteria:

1. The Board shall examine the design and theme of the application for consistency with the design and character components of the applicable guidelines, development standards, Design Standards and Policies Manual, master plans, character plan and General Plan.

Response: Magnolia Waterside is supportive of the desired values defined in the General Plan, which include goals and policies that benefit the community. As demonstrated in detail with the recently approved zoning case for Canalside (case 1-ZN-2020), the development plan conforms to the General Plan, Old Town Scottsdale Character Area Plan, Old Town Scottsdale Urban Design & Architectural Guidelines ("OTSUDAG"), the Planned Block Development ("PBD") Criteria, and the Scottsdale Sensitive Design Principles. Key development considerations from the zoning case are carried through with this DRB application. Further, this narrative provides design details specific to the OTSUDAG and Scottsdale Sensitive Design Principles.

- 2. The architectural character, landscaping and site design of the proposed development shall:
 - a. Promote a desirable relationship of structures to one another, to open spaces and topography, both on the site and in the surrounding neighborhood;

Response: The development request will allow for the redevelopment of an underutilized site surrounded by a variety of supporting cultural, employment, commercial and residential land uses that will offer services to the residents. Equally, the addition of residential units within the Arizona Canal District, adjacent to the Fifth Avenue District and Scottsdale Arts District, will further strengthen Old Town Scottsdale's range of synergist land uses.

The streetscape design embraces the OTSUDAG principles (as identified in more detail below) and will provide a welcoming pedestrian environment for Old Town residents and patrons walking along 5th Avenue and Indian School Road. Magnolia Waterside will provide a comfortable and safe streetscape designed with human-scale elements, shade and movement through both hardscape and building forms. The project creates a strong anchor for the corner given its unique location between 5th Avenue and 68th Street along Indian School Road. The development strengthens and extends the walkability of the neighborhood. Circulation is encouraged with 8' wide sidewalks that connect 5th Avenue and the Arizona Canal walkway and to an inviting urban plaza at the corner of 5th Ave and Indian School. Vegetation will be used to create a comfortable microclimate as well as providing visual relief that will enhance the pedestrian experience along

the street edge and encourage the use of sidewalks to get from one destination to another further enhancing the walkable character of Old Town.

b. Avoid excessive variety and monotonous repetition;

Response: Magnolia Waterside's proposed building materials, massing and architecture are inspired by some of the existing Old Town vernacular and character, both new and old. From a context perspective to the west of the site is a Salt River Project irrigation well and the property itself was previously slated for a substation for the Salt River Project. A variety of architectural styles are present in the area – including a two-story full glass building across 5th Avenue. The most prominent building in the immediate area is the Hotel Valley Ho, which is a striking example of mid-century modern architecture and seems at home in its location. The use of masonry, cast stone, poured concrete and large areas of glass create a close connection between the building and its environment. Magnolia Waterside's design vocabulary was inspired by the Hotel Valley Ho and the building's Architectural massing, colors, materials, roof eaves, and vertical fins are modern in approach and context appropriate. Proposed materials include, but are not limited to, breeze block, brick, rustic siding, stucco, and dark-bronze window framing.

c. Recognize the unique climatic and other environmental factors of this region to respond to the Sonoran Desert environment, as specified in the Sensitive Design Principles;

Response: Please see the Scottsdale Sensitive Design Principles section below.

d. Conform to the recommendations and guidelines in the Environmentally Sensitive Lands (ESL) Ordinance, in the ESL Overlay District; and

Response: Not applicable.

e. Incorporate unique or characteristic architectural features, including building height, size, shape, color, texture, setback or architectural details, in the Historic Property Overlay District.

Response: Not applicable.

3. Ingress, egress, internal traffic circulation, off-street parking facilities, loading and service areas and pedestrian ways shall be so designed as to promote safety and convenience.

Response: The Property is situated on the northwest corner of 5th Avenue and Indian School Road; Indian School being a major arterial. The site is also approximately 2.6+/- miles west of the Loop 101, which provides regional access. By creating a comfortable and inviting pedestrian experience along the adjacent streets, this proposed project will encourage alternative modes of

transportation, such as by foot, bicycle, bus and/or trolley. Encouraging these alternative means of transportation is inherent to downtown development as the Property is located near numerous restaurants, retail, and cultural destinations. Additionally, the site is located along the Arizona Canal Trail system and is within approximately 1.3+/- miles of the Indian Bend Wash multi-use path network, both of which offer easy pedestrian access and movement. The building and site design encourages residents, guests, and visitors to utilize Old Town for their everyday dining, social interaction, recreational, and cultural needs. Parking for will be provided completely on-site at the ground level with access from the alley that connects to 5th Avenue as to not impede the pedestrian environment along the streetscape.

4. If provided, mechanical equipment, appurtenances and utilities, and their associated screening shall be integral to the building design.

Response: Mechanical equipment, appurtenances and utilities, and their screening methods will be integrated into the site and building design.

- 5. Within the Downtown Area, building and site design shall:
 - a. Demonstrate conformance with the Downtown Plan Urban Design & Architectural Guidelines;
 - b. Incorporate urban and architectural design that address human scale and incorporate pedestrian-oriented environment at the street level;
 - c. Reflect contemporary and historic interpretations of Sonoran Desert architectural traditions, by subdividing the overall massing into smaller elements, expressing small scale details, and recessing fenestrations;
 - d. Reflect the design features and materials of the urban neighborhoods in which the development is located; and
 - e. Incorporate enhanced design and aesthetics of building mass, height, materials, and intensity with transitions between adjacent/abutting Type 1 and Type 2 Areas, and adjacent/abutting Type 2 Areas and existing development outside the Downtown Area.

Response: The development conforms to the OTSUDAG as outlined below and provides a pedestrian-oriented development to engage Old Town residents and patrons through streetscape design. Architectural elements take inspiration from the adjacent Valley Ho with mid-century modern influences, respecting the use of shade, overhangs/projections, appropriate massing, and material/color selection. See OTSUDAG guidelines below for more details on design, character, and compatibility.

- 6. The location of artwork provided in accordance with the Cultural Improvement Program or Public Art Program shall address the following criteria:
 - a. Accessibility to the public;

- b. Location near pedestrian circulation routes consistent with existing or future development or natural features;
- c. Location near the primary pedestrian or vehicular entrance of a development;
- d. Location in conformance with the Design Standards and Policies Manual for locations affecting existing utilities, public utility easements, and vehicular sight distance requirements; and
- e. Location in conformance to standards for public safety.

Response: As required by the approved PBD zoning approval, the 1% public art budget at this time is estimated at approximately \$91,000 will be contributed to the Old Town Cultural Improvement Trust Fund at the time of permitting

B. The property owner shall address all applicable criteria in this section.

4. OTSUDAG CONFORMANCE

"Old Town Scottsdale Urban Design & Architectural Guidelines"

Human Connectivity

Primary Guideline No. 1 - Create an interconnected, walkable downtown.

- 1.1. Provide circulation connections to, from, and within a site to support pedestrian activity and other mobility options, and enhance interconnectivity within Old Town.
- 1.2. Expand the pedestrian network throughout Old Town by incorporating pedestrian links to neighboring developments through the use of covered or shaded walkways, passageways, courtyards, and plazas.
- 1.3. Maintain the Old Town pedestrian grid pattern found within the context of each Old Town district. (See Map 2 Old Town Districts).
- 1.4. Design street-spaces that support the pedestrian. Incorporate pedestrian amenities such as safe, comfortable surfaces, seating, lighting, shade, landscape and hardscape, crosswalk refuge areas, and curb and sidewalkextensions into Old Town design.
- 1.5. Coordinate the design of pedestrian, auto, parking, and service areas to minimize pedestrian interruptions and pedestrian-vehicular conflicts.

Our response:

The project creates a strong anchor for the hard corner of Indian School Road and 5th Avenue. The development strengthens and extends the walkability of the neighborhood. Circulation is encouraged with 8' wide sidewalks that connect 5th Avenue and the Arizona Canal walkway to an inviting urban plaza at the corner of Indian School Road. The new plaza will feature enhanced paving, shaded areas and public art, and the connection to the Arizona Canal joins the pedestrian environment of 5th Avenue with leisure and recreational opportunities.

Primary Guideline No. 2 - Maintain a consistent street edge and continuity of street-spaces. A strong street edge defines and strengthens the pedestrian experience in an urban space.

- 2.1. Align new buildings with existing buildings, and minimize the space between buildings to define a continuous building-street edge.
- 2.2. Locate the majority of building frontage to a common setback line and parallel to the street. Variations to the building setback that support the pedestrian experience may be considered.
- 2.3. Create a defined street-space where building frontages do not exist by incorporating design elements such as site walls, landscaping, overhead trellis, or covered walkway.
- 2.4. Convey a unified street appearance through the provision of complementary street furniture, paving, lighting, and landscape plantings.
- 2.5. Locate linear and rhythmic landscape planting at the street edge, and at site features such as intersections, entry drives, sidewalks, and courtyards.

- 2.6. Locate outdoor dining where it will not impede public right-of-way, pedestrian clear widths. landscape areas, and other locations needed for safety and mobility.
- 2.7. Design outdoor dining improvements to maintain the openness of the adjacent street or open space by utilizing permanent fencing that is low and predominantly transparent. Specifically, these low walls/fences are to be a maximum of 3 feet in height and be 80% transparent.
- 2.8. Accommodate table seating, lighting, menu signs, host stations, patron queuing, and other features associated with outdoor dining and entertainment venues, on private land.
- 2.9. When outdoor dining space is separate from the building, design access tominimize conflict with the pedestrian clear width.

Our response:

Our project creates a strong urban streetscape along Indian School Road by locating the majority of the building at the minimum building setback, culminating in an urban plaza as the building turns to address 5th street. The building is anchored by two corner towers that feature wrap around balconies and a dramatic roof shade structure. The plaza will serve as an amenity to the residents as well as the general public and encourage pedestrian connections through the neighborhood.

Primary Guideline No. 3 - Incorporate open landscaped spaces in Old Town to encourage human interaction.

- 3.1. Provide open space for public and private outdoor activities, special events, and day-to-day activities. Incorporate temporary and permanent infrastructure into open space and streetscape designs to support activities and events year-round.
- 3.2. Utilize a cohesive palette of design elements such as fixtures, landscape plantings. hardscape, street furniture, and integrated infrastructure to support design continuity in downtown public spaces.
- 3.3. Design private development to complement and reinforce the design of adjacent public spaces
- 3.4. Implement design techniques in and around open space areas to reduce the impacts of noise on sensitive uses.

Our response: The urban plaza at the corner of the site will be a signature, defining element of the project and provide a backdrop for public and private activities. The plaza will feature native landscape elements that will provide color, texture and shade. The building also features a "folded plate" style awning at the public entry.

Primary Guideline No. 4 – Connect Old Town open spaces to the surrounding context.

- 4.1 Visually and physically connect open spaces to other spaces such as walkways, gather and activity areas and adjacent development sites.
- 4.2 Understand the relationship between open spaces and adjacent buildings. Connect public open space with adjacent private space, such as ground floor uses. Design adjacent

- buildings as the "walls" that frame open spaces, where covered walkways, vertical plant materials, or other design treatments define this vertical edge.
- 4.3 Connect the open spaces of neighboring development sites through common entry courts, linked courtyards and patios, and via coordinated landscape.
- 4.4 Distinguish between public and private spaces. Design public spaces to be transparent and welcoming and design private spaces to have a larger sense of privacy. Provide a clearly defined transition between public and private space.
- 4.5 Provide open space at intersections for pedestrian mobility and link these open spaces to other public areas.
- 4.6 When residential units occupy the ground floor, direct access to adjacent open space is encouraged.

Our response:

The site is an important piece of the existing urban fabric, and our project will link the existing 5th Avenue pedestrian to Old Town Scottsdale and the existing canal recreational path. There are no ground floor residential units in the project.

Site & Surrounding Context

Primary Guideline No. 5 - Manage access and exposure to sunlight; provide shade.

- 5.1. Design for filtered or reflected daylighting of new buildings.
- 5.2. Manage the seasonal solar exposure of site features through building orientation, vegetation, and architectural design.
- 5.3. Provide shade along pathways, in public and private outdoor spaces and as part of building design.
- 5.4. Minimize, or shade, materials that absorb and retain heat. Consider **u**ing materials that dissipate heat.

Our response:

Our building features significant shading elements that provide shade to the urban plaza at the corner of the site, as well as portions of the sidewalks throughout the site. Existing and new landscape elements will also provide shade.

Primary Guideline No. 6 - Design with context-appropriate vegetation.

- 6.1. Emphasize a variety of drought tolerant and Sonoran Desert plants that provide water conservation, shade, seasonal color, and a variety of textures and forms.
- 6.2. Take into account mature vegetation sizes, characteristics, and maintenance requirements with site layout and design.
- 6.3. Design landscape elements and palette to relate closely to the character and function of site architecture, and coordinate with neighboring properties and adjacent public areas.
- 6.4. Utilize vegetation that is multipurpose, such as landscaping that reinforcesthe character of

an area by providing shade, wayfinding, heat island relief, prominent site feature emphasis, and/or screens utility equipment and building service areas that are to be hidden from public view.

6.5. Incorporate low impact development practices into site design.

Our response:

The landscaping for the development will feature drought resistant, native plants which thrive in the desert environment and provide shade, texture and color

The overall landscape architecture will complement the architecture and provide screening to the parking area and provide a buffer between public and private spaces.

Primary Guideline No. 7 - Ensure continuity of site development.

- 7.1. Orient buildings and active uses towards streets, pedestrian corridors, and other public areas.
- 7.2. Incorporate courtyards and other outdoor spaces into site design and link them with outdoor spaces on neighboring sites, and to the street.
- 7.3. Design site layouts to appropriately integrate historic resources into new development.
- 7.4. Plan for temporary and permanent public art in site and streetscape design.

Our response:

The building defines a strong urban streetscape along Indian School Road, and turns to allow address 5th Avenue. The urban plaza at the corner of these two roads acts as the primary outdoor space and will feature landscape elements, shade elements and public art.

Primary Guideline No. 8 - Design new development to be compatible and complementary to existing development.

- 8.1. Design buildings to reflect and enhance the existing character of an area. Establish new urban design and architectural character where downtown development patterns are fragmented or evolving.
- 8.2. Create a balance between new design elements and existing architectural features and materials.
- 8.3. Design new development to be compatible with historic resources.
- 8.4. Building design that incorporates corporate or user branding is discouraged.

Our response:

The area is currently undeveloped and represents a strategic location at the corner of Indian School Road and E. 5th Avenue. To the west of the site is a Salt River Project irrigation well and the property itself was previously slated for a substation for the Salt River Project. A variety of architectural styles are present in the area – including a two-story full glass building across 5th from the site. The most prominent building in the immediate area is the Hotel Valley Ho. The Hotel Valley Ho is a striking example of mid-century modern

architecture and seems at home in its location. The use of masonry, cast stone, poured concrete and large areas of glass create a close connection between the building and its environment.

Our project's design vocabulary was inspired by the Hotel Valley Ho. Our building's Architectural massing, colors, materials, roof eaves, and vertical fins are modern in approach and context appropriate.

Primary Guideline No. 9 - Minimize the visual and physical impacts of utility equipment and building service areas.

- 9.1. Locate building service areas so as to minimize visibility from public view and reduce potential conflicts with on-site circulation.
- 9.2. Conceal utility equipment, such as mechanical, electrical, solar, and communications equipment, from public view, other on-site users, and neighboring properties.
- 9.3. Locate utility equipment and building service and delivery areas on the development site along the alley or within the site's interior.
- 9.4. Site planning that incorporates rideshare queuing and drop off is encouraged.
- 9.5. Consider building improvements such as lighting and signage on facades that face onto alleyways.

Our response:

The trash enclosure will be located adjacent to the existing alley and utility easement. The enclosure will be full height masonry with decorative metal access gates. Transformers and other utility components will be screened from public view. The surface parking layout will provide ample room for rideshare pickups and food deliveries. Decorative lighting will be incorporated into the development – particularly at building entries.

Primary Guideline No. 10 - Contribute to the ambiance, character, and safety of Old Town through architectural and site lighting (Refer to Section 7.600 of the Scottsdale Zoning Ordinance).

- 10.1. Reinforce architectural design of a building, and the surrounding context, through complementary exterior decorative light fixtures.
- 10.2. Emphasize architectural features when illuminating building facades via concealed lighting.
- 10.3. Design lighting systems to minimize glare, excessive brightness, and visual hot spots; and, incorporate transitional light levels between lower and higher illuminance.
- 10.4. Encourage exterior and interior building lights that illuminate windows and doors and contribute to increasing the light levels in pedestrian areas.
- 10.5. Provide pedestrian scale lighting to supplement street lighting and combine street and pedestrian lighting on one support pole.
- 10.6. Provide evenly distributed lighting beneath covered walkways. Fixtures that produce light at a warm color temperature are preferred (2700-3000 Kelvin).

10.7. Emphasize artwork in the public realm through complimentary exterior lighting.

Our response: An exterior lighting plan is included indicating light fixtures that comply with the criteria listed above.

Primary Guideline No. 11 - Utilize signage that supports Old Town characterand function (Refer to Article VIII of the Scottsdale Zoning Ordinance).

- 11.1. Incorporate signage that complements development design and the surrounding area.
- 11.2. Coordinate sign locations with building and landscape design to ensure visibility.
- 11.3. Provide permanent business signage at the primary street frontage.
- 11.4. Provide shingle signs under covered walkways in the Downtown Core. Located shingle signs perpendicular to the face of the building, and at theheight of no less than seven foot and six inches above the sidewalk.
- Illuminate wall signs with indirect lighting from a shielded light source. 11.5.
- 11.6. Illuminated cabinet signs are strongly discouraged in Old Town.
- 11.7. Monument signs are prohibited in the Downtown Core (Type 1 Development areas) and strongly discouraged in all other areas of Old Town.

Our response: The project will not include any cabinet signs or monument signs. All signage and graphics for the site will comply with the downtown signage guidelines.

Building Design

Primary Guideline No. 12. - Design buildings to complement the existing context. (Refer to Section 5.3006 of the Scottsdale Zoning Ordinance).

- 12.1. Provide compatible transition in building scale, height, and mass.
- 12.2. Although new buildings may be different sizes, design the first few stories to visually relate to adjacent buildings and the surrounding context, by integrating architectural elements and design details of similar scale and proportion.
- Locate more intense building mass, height, and activity of a development away from existing development at the Old Town boundary.
- Utilize building form as the primary method to make compatible transitions between 12.4. different Development Types, internal to the Old Town boundary.

Our response: Most of the buildings in the immediate context of our site are small retail buildings along 5th Avenue. Our project contains a 1-story base that fronts onto an urban at the corner of Indian School and 5th Avenue. The building is articulated with recessed, shaded balconies and decorative shade structures.

Primary Guideline No. 13 - Reduce apparent building size and mass.

13.1. Reducing apparent size and mass of buildings through architectural design that subdivides

- the building into horizontal componentsconsisting of a base, middle, and top is preferred.
- 13.2. Incorporate setbacks and stepbacks into building design to reduce their visual impact.
- 13.3. Subdivide large building mass through the addition of architectural features and material articulation.
- 13.4. Avoid long or continuous blank wall planes and monotonous wall treatments. Incorporate projections, recesses, or other architectural variation into wall planes to provide strong shadows and visual interest and help the eye divide the building into similar parts.
- 13.5. Provide physical and visual access points every 100 to 300 feet, subdividing building mass at regular vertical intervals.

Our response: The awkward shape of the site led to a unique layout and solution for the building. The unique shape provides distinct views of the building from the immediate surroundings. The use, scale and massing of the project is appropriate for the Old Town location and provides an appropriate buffer to the more mature neighborhoods to the west and south.

Primary Guideline No. 14 - Design high-rise buildings to reflect design excellence and fit within the surrounding context.

Our response: The proposed project is not a high-rise.

Primary Guideline No. 15 - Design parking facilities that fit within the surrounding context.

- 15.1. The preferred location for structured parking is below-grade. Design underground structures to provide natural air and light.
- When developed above-grade, design the parking structure to integrate into the 15.2. neighborhood context:
 - Reduce the apparent mass of a parking structure by stepping backupper levels;
 - Delineate sections in the building design;
 - Articulate corners;
 - Recess or offset the wall plane horizontally;
 - Design stair and elevator towers as distinct, taller masses, that intersect and balance with the horizontal emphasis of the structure while also orienting users to a point of entry; and,
 - Internalize ramps to minimize the angular geometry of the structure.
- 15.3. When parking must be located adjacent to public areas, incorporate architectural features such as a rhythm of wall-mass to window openings or variation in colors, materials, and textures to minimize the visual identity of an above-grade parking structure and disguise its basic structural components.
- Design podium parking and ground floor levels of above-grade parking structure to 15.4. incorporate active commercial or residential space, human-scaled elements, and design features.
- 15.5. Locate at-grade and above-grade parking facilities at the rear or interior portions of a site

- to minimize their visual impacts. When possible, provide vehicular access to these facilities from alleys, side streets, or private drives.
- 15.6. When parking must be located along the street, minimize the frontage by orienting its short dimension along the street edge and treat frontage appropriately.
- 15.7. Design the portions of above-grade parking structures adjacent to residential areas to maintain the rhythm and pattern of the overall architectural design while minimizing openings to avoid noise and light transmission directed toward residences.

Our response:

The project has at grade, surface parking on the interior of the site. Screening for the parking is achieved with breeze blocks to provide visual interest while still maintaining light and air to the parking zone. Access to the site parking will be from the alley that connects to 5th Avenue.

Primary Guideline No. 16. - Design building facades and architectural features to fit with the surrounding context.

- 16.1. Design similar floor-to-floor building heights to define the visualcontinuity of an area.
- 16.2. Align architectural features such as window bands, cornice lines, beltcourses, moldings, and other features, as appropriate.
- 16.3. Repeat architectural elements such as covered walkways, recessed bases or similar roof forms to link existing and new development.
- 16.4. Within the Downtown Core, provide either a continuous building edge with covered walkway or a shallow courtyard behind a covered walkway.
- 16.5. Outside of the Downtown Core, provide a continuous shaded walkway along pedestrian corridors.
- 16.6. Utilize variety in building design that integrates surface detail, articulated architectural features, and other elements that enrich character, visual interest, shadow, contrast, and color.

Our response:

Floor to floor heights are consistent with other developments in the immediate area. The architecture follows a mid-century modern aesthetic and features horizontal banding and large cantilevered overhangs. The palette of exterior materials includes light colored masonry, stucco, wood tone siding, and decorative metal railing. The building also features two towers that anchor the building face along Indian School Road. Each tower has a dramatic, sloped awning which creates a signature look while providing shade to the wrap around balcony.

Primary Guideline No. 17 - Design buildings that are inviting.

- 17.1 Activate the ground floor of buildings to provide interest and a saferpedestrian environment.
- 17.2 Provide a clearly defined public entrance to the building façade that reflects the existing scale of surrounding building entrances.
- 17.3 Orient the main entrance of a building toward the street.

- 17.4 Provide frequent building entrances to minimize blank walls and otherdead spaces.
 - For Type 1 Development, incorporate at least one (1) entrance for every thirty to fifty (30-50) feet of building frontage.
 - For Type 2, 2.5, and 3 Developments, incorporate at least one (1)entrance for every thirty to fifty (30-50) feet of building frontage, but not to exceed 100 feet.
- 17.5 Within Type 1 Development areas and along streets designated as Pedestrian Place, maintain a ground-level window-to-wall percentage of80% to 20%, utilizing well-insulated, transparent glass.

(Refer to Old Town Scottsdale Character Area Map - Pedestrian Connectivity)

Our response:

The urban plaza at the corner of Indian School Road and 5th Avenue serves as the front door to the development. This creates a very welcoming connection to the strong pedestrian environment of the immediate context. The main entrance to the building faces the urban plaza and is shaded by a folded plate style, cantilevered awning.

Primary Guideline No. 18 - Use context-appropriate materials, colors and textures in Old Town development.

- 18.1. Use materials with colors and coarse textures that are associated with the desert southwest.
- 18.2. Use materials that complement the existing area in texture, finish, scale, color, and other design aspects.
- 18.3. Use colors and materials that emphasize shadow patterns.
- 18.4. Reflective materials that create glare and façades that are more than 80% glass are discouraged.
- 18.5. Emphasize muted desert colors (Main Color) having a value of less thanseven (7) and a chroma between three (3) and fourteen (14), asindicated in the Munsell Book of Color. The Light Reflectance Value is to be 70% or less. Intense, saturated colors are only encouraged as accents.
- 18.6. Exterior finish materials such as concrete, brick, and tile to be left in their natural color or colored integrally, as opposed to being painted, stained or coated.
- 18.7. Natural materials are preferred over simulated materials, particularly atthe ground level of buildings and other locations where direct contact by pedestrians occur.
- 18.8. Changes in paint color, building material, and/or texture that occur with a change in horizontal wall plane, or with strongly pronounced scoring, expansion joints, reveals or other similar wall details are encouraged. Abrupt changes in materials, colors, and textures are discouraged.
- 18.9. Vertically stacked materials ordered by perceived material weight, with the "heaviest" materials at the bottom, and the "lightest" materials towards the top, are encouraged. This ordering method contributes to the appearance of the building being anchored to the ground plane, and upper levels being supported by the building base.

Our response: The building features a palette of materials that includes light-colored masonry. light colored stucco, white stucco banding, and wood-tone accent siding. The architectural expression follows a mid-century modern aesthetic and takes visual clues from the nearby Hotel Valley Ho. The exterior materials are compatible with the nearby Old Town Scottsdale district.

Arizona Canal District

Primary Guideline No. AC 1 - Promote the character and identity of the Arizona Canal District through open space, landscape, and urban design.

- AC 1.1. Relate project design to the district themes of water, desert oasis, and the natural and human history of the Southwest.
- AC 1.2. Utilize landscape and open space design to reinforce district themes, support special events, and provide access to the natural environment.
- AC 1.3. Promote district visibility and identity by incorporating gateways, such as enhanced landscape and urban design features, at key district entry points.
- AC 1.4. Design bridges, entry points, pathways, seating, and other urban design elements to promote a unified district aesthetic.
- AC 1.5. Utilize landscape design to convey a desert water oasis and to unify the diverse architectural environment along the canal corridor.

Our response:

Our project address the canal in a strong way with a clearly marked connection from the canal side path to the streetscape of 5th Avenue. The urban plaza at the corner of Indian School and 5th Avenue. This plaza creates a walkable, shaded environment with native landscaping providing texture and color.

Primary Guideline No. AC 2 - Activate the Arizona Canal District and corridor through building and site design.

- Incorporate stepbacks, recesses, and projections into the horizontalbuilding wall plane AC 2.1. to open views onto the canal corridor, while creating an enhanced frame and edge.
- Incorporate architectural cover, deeply recessed windows, raised planters, base AC 2.2. plantings, and other treatments to strengthen the baseof buildings that front the canal corridor.
- AC 2.3. Promote views into and out of the canal corridor by breaking up building massing at regular intervals and stepping height away from the canal.
- Provide pedestrian canal corridor access at 100- to 300-foot intervals, by incorporating AC 2.4. spaces between buildings. Align access points with existing paths and future bridge and pedestrian connection opportunities.
- AC 2.5. Design buildings with frontages along the Arizona Canal to provide apublic entrance at the canal level and at Old Town street level.

- AC 2.6. Enhance the human scale of the canal corridor by visually reducing the distance between opposing canal banks through canal bank design, such as cantilever sections, landscaping, and vertical elements at the canal edge.
- AC 2.7. When a Type 2 Development adjacent to the canal exceeds 30-feetin total height, as measured from the top of the canal bank, it is recommended that the building mass step back at a ratio of 1:1, untilreaching a building height of 45- feet. Stepback additional building height above 45 feet at a ratio of 2:1 until the maximum building height is reached.
- AC 2.8. When a Type 3 Development adjacent to the canal exceeds 45-feetin total height, as measured from the top of the canal bank, it is recommended that the building mass step back at a ratio of 2:1. Observe a ratio of 2:1 until the maximum building height is reached.
- AC 2.9. Outdoor dining areas are encouraged to locate along the canal corridor and adjoining public open spaces.
- AC 2.10. Outdoor dining patios located along a canal corridor building frontagemay extend a distance from the building that still maintains a pedestrian clear width. It is recommended that outdoor dining patiosadjacent to canal corridor buildings occupy no more than 50% of thelinear building frontage.
- AC 2.11. Building terraces that create a defined edge along the canal corridorare encouraged.

Our response:

The building face along the canal serves as a backdrop to the recreational trail. The building has a base of breeze block, which provides visual interest while provided light and air to the parking zone. The site features an easily identified connection from the trail to 5th Avenue. The canal building face is anchored by a stair tower on the north, and features banding, balconies with decorative railing as well as privacy screens to portions of the balconies.

Primary Guideline No. AC 3 - Reduce the impacts of noise at the source, inspaces where sound travels, and at locations with noise-sensitive landuses.

- AC 3.1. Analyze the noise compatibility of proposed development projects during the building design phase to minimize the impacts of noise generated and received once built.
- AC 3.2. In open areas where sound may travel, utilize walls, sound absorbing materials, landscaping, and other exterior site improvements toblock, deflect, and attenuate noise.
- AC 3.3. Incorporate sound attenuation and sound proofing in buildings with noise-sensitive uses through the combination of materials and building design. Building design techniques might include, but are not limited to, orientation of building openings, ventilation system planning, and siting of uses within the planned building envelope.

Our response:

Our building acts as a noise buffer for the residential areas to the north of the canal. Landscaping and architectural features will also help further reduce sound and noise pollution from Indian School Road and environmental factors.

Primary Guideline No. AC 4 - Strengthen the Arizona Canal District identity through integrated public art.

- AC 4.1. Incorporate permanent public art throughout the Arizona Canal District that contributes to the district's "sense of place" by incorporating unique characteristics about Scottsdale, the desert, and the Arizona Canal, particularly in the design of gateways, plazas, bridges, pathways, and landscape features.
- AC 4.2. Accommodate large-scale temporary public art to enhance the canal corridor as one of the primary special event and public gathering places in Old Town.

Our response:

Our project includes visual interest along the canal with architecture that features unique ground floor materials, decorative railing on the building and at the canal connection, as well as public art in the urban plaza at the corner of Indian School and 5th Avenue.

5. SCOTTSDALE SENSITIVE DESIGN CONFORMANCE

The Character and Design Element of the General Plan states that "Development should respect and enhance the unique climate, topography, vegetation and historical context of Scottsdale's Sonoran Desert environment, all of which are considered amenities that help sustain our community and its quality of life." The City has established a set of design principles, known as the Scottsdale Sensitive Design Principles, to reinforce the quality of design in our community. The follow Sensitive Design Principles are fundamental to the design and development of the Property.

1. The design character of any area should be enhanced and strengthened by new development.

Our response:

The design aesthetic for the project is complementary to the surrounding developments in the neighborhood. The architecture is appropriate to the desert environment with natural materials as the exterior material palette and significant shading and overhang elements. Ample private exterior spaces are provided for residents.

2. Development, through appropriate siting and orientation of buildings, should recognize and preserve established major vistas, as well as protect natural features.

Our response: Our site is an urban infill vacant site that does not have any significant natural site features. Our design includes strong connectivity from the canal pathway to 5th Avenue and the rest of Old Town Scottsdale.

3. Development should be sensitive to existing topography and landscaping.

Our response: The current site is vacant and virtually flat; and the new development will not change the topography. All new landscaping will be drought resistant and appropriate to the desert environment.

Development should protect the character of the Sonoran Desert by preserving and 4. restoring natural habitats and ecological processes.

Our response:

The new development will use desert appropriate landscaping which will help preserve the natural habitats and existing ecological environment.

5. The design of public realm, including streetscapes, parks, plazas and civic amenities, is an opportunity to provide identity to the community and to convey its design expectations.

Our response: The development will encourage additional pedestrian activity. The connections to the canal, 5th Avenue and Old Town Scottsdale will be strengthened. The urban plaza at the intersection will provide a strong signature to the pedestrian environment.

6. Developments should integrate alternative modes of transportation, including bicycles and bus access, within the pedestrian network that encourage social contact and interaction within the community.

Our response:

The walkability of the immediate area will be increased with this development. Our project is withing walking distance of multiple retail, restaurant and other commercial outlets as well as major employment centers including Honor Health. Additionally, the connection to the canal recreational trail further strengthens these connections.

7. Development should show consideration for the pedestrian by providing landscaping and shading elements as well as inviting access connections to adjacent developments.

Our project will incorporate design elements that are appropriate to human scale, and provide shade for public and private landscaped spaces.

8. Buildings should be designed with a logical hierarchy of masses.

Our response:

The project has a strong masonry base of the building and the ground floor. There are two towers anchoring the corners of the building along Indian School Road. The upper levels are marked with strong horizontal banding at each floor.

9. The design of the built environment should respond to the desert environment.

Our response:

The project uses an appropriate palette of exterior material for the desert environment. The use of shade elements and landscape elements also respond to the desert environment.

10. Developments should strive to incorporate sustainable and healthy building practices and products.

Our response:

The project will incorporate sustainable and green building techniques and materials where possible.

11. Landscape design should respond to the desert environment by utilizing a variety of mature landscape materials indigenous to the arid region.

Our response:

The new landscape design will be appropriate and consistent with the existing desert environment. Planting and other landscape elements will add texture, color and shade to the site.

12. Site design should incorporate techniques for efficient water use by providing desert adapted landscaping and preserving native plants.

Our response: The new landscape elements will be low-water and contextually appropriate, and will enhance the existing neighborhood.

13. The extent and quality of lighting should be integrally designed as part of the built environment.

Our response: Lighting for the building and site will be primarily decorative in nature, and will provide safe lighting levels while minimizing any light pollution.

14. Signage should consider the distinctive qualities and character of the surrounding context in terms of size, color, location and illumination.

Our response: Project signage will be elegant and minimal and will be addressed separately as the project progresses.

DEVELOPMENT REVIEW BOARD CRITERIA ANALYSIS

Per Section 1.904. of the Zoning Ordinance, in considering any application for development, the Development Review Board shall be guided by the following criteria:

1. The Board shall examine the design and theme of the application for consistency with the design and character components of the applicable guidelines, development standards, Design Standards and Policies Manual, master plans, character plan and General Plan.

GOAL CD 1: The design character of any area should be enhanced and strengthened by new development that promotes contextual compatibility.

• The design character of the area is comprised of a mix of small- and large-scale developments that span more than 50 years. The proposed building form is comprised of vertical and horizontal building forms that introduce a new contemporary urban character to the area; and responds to the Downtown urban environment and contextual design area by incorporating building forms that are complementary and assist in establishing urban character that respects and contributes to the existing and evolving context, as well as the Sonoran Desert (DP CD 1.1, 1.2, and 1.4).

GOAL CD 2: Development should sensitively transition in scale, height, and intensity at the downtown plan boundary and between adjoining urban neighborhoods of differing development.

• Per the Old Town Scottsdale Character Area Plan, the proposed development site is located within the Arizona Canal District and is designated as Type-2. Development "Types" were established to "guide the physical and built form of Downtown Scottsdale" (DP Goal LU 3). One aspect of this objective is appropriate transition of massing and building height between higher-scale development types and lower-scale development types. In this case, the project site is located at the boundary of Old Town where the boundary abuts the Arizona Canal, east of N. 68th Street. On the north side of the canal are single-story single-family residences (zoned R1-10), approximately 15-20 feet in height. The site is separated from the single-family residential by the Arizona Canal, approximately 235 feet from the nearest single-family residence, which helps to mitigate any negative impacts from height and/or massing.

GOAL CD 3: Downtown development should respect and respond to the unique climate and context of the southwestern Sonoran Desert.

• The proposed development includes upper-level balconies for each residential unit. Most of the balconies are recessed and integrated into the building design. The remaining balconies are tucked back between exaggerated overhangs to lend the appearance of physical integration. Design of balconies promotes shading, enhances the appearance of the building and mitigates solar heat gain. Additionally, the proposed balconies provide usable outdoor space for residents and attractive gathering areas that provide views to the northwest toward Camelback Mountain, east into the Old Town area and northeast to the McDowell Mountains (DP Policy CD 3.1).

GOAL CD 4: Strengthen pedestrian character and create strong pedestrian linkages.

• This proposal responds favorably to this directive by providing a new 8-foot-wide pedestrian connection along the eastern edge of the project that includes a stairway at

the canal bank. Because of the grade differential from the project site to the canal bank, an accessible ramp is not possible without cutting heavily into the bank to provide either a switchback or elongated straight ramp, which is not feasible. Instead, signage is proposed at the entrance to the connection directing those who need accessible access to the canal bank to the intersection of N. 68th Street and E. Indian School Road where an existing accessible connection is located. Additionally, an enhanced area of open space at the intersection of E. Indian School Road and E. 5th Avenue is proposed to further improve the pedestrian experience along the street. Finally, a 900 square foot commercial space is proposed near the intersection of 5th Avenue & Indian School that will be accessible to pedestrian from the street. This space could be used for a juice bar or coffee shop to serve walk-up traffic.

GOAL CD 5: Create coherent and consistent street spaces.

• The proposed development creates a consistent street space on both frontages by providing street trees and wider sidewalks detached from the street curb.

GOAL CD 6: Incorporate a regional landscape palette that complements the downtown urban character.

Most exterior landscape opportunities for the proposed development plan are within the
public right-of-way; and are required to be drought tolerant plants in accordance with the
Scottsdale Revised Code (SRC). As part of this development, the proposal incorporates a
streetscape design that is consistent with the established theme along both E. Indian
School Road and E. 5th Avenue, contributing to what is anticipated to be an enhanced
pedestrian experience.

GOAL CD 7: The extent and quality of lighting should be integrally designed as a part of the built environment.

 The proposed illumination levels are anticipated to comply with the Design Standards & Policies Manual for the Downtown Area, which should illuminate public and private spaces, and building accents (DP CD 7.1). A comprehensive exterior lighting plan will be provided with the Development Review Board application.

GOAL CD 8: Implement high quality design in downtown architecture.

- Building design was a primary concern during the zoning process. The Board reviewed
 the Development Plan, as required for a Planned Block Development (PBD), and
 ultimately recommended approval of the Development Plan with direction to revisit the
 conceptual building design prior to returning for formal DRB consideration. Below is a
 summary of the Board's direction.
 - Revisit building design prior to returning to the Board for final design approval. Specifically, the applicant was instructed to pay particular attention to the north elevation facing the canal bank. The Board indicated this project will serve as the gateway to this portion of Old Town, and as such should set a positive precedence for future redevelopment on the south side of the canal.
 - > Explore alternative colors and materials to enhance visual interest and respond more favorably to the City's guidelines.

Explore the opportunity to landscape the proposed pedestrian connection along the alley and possibly add a Public Art element to the refuse enclosure, to enhance the pedestrian experience

Additionally, the zoning case was narrowly approved by City Council (4-3 vote in favor) as some on Council believed the conceptual building design at the time was not iconic enough for a site that is essentially a gateway into Old Town. For this application, staff worked with the applicant through three review cycles in an effort to enhance design as much as possible to respond to these directives and is generally supportive of the final design.

- 2. The architectural character, landscaping and site design of the proposed development shall:
 - a. Promote a desirable relationship of structures to one another, to open spaces and topography, both on the site and in the surrounding neighborhood;
 - b. Avoid excessive variety and monotonous repetition;
 - c. Recognize the unique climatic and other environmental factors of this region to respond to the Sonoran Desert environment, as specified in the Sensitive Design Principles;
 - d. Conform to the recommendations and guidelines in the Environmentally Sensitive Lands (ESL) Ordinance, in the ESL Overlay District; and
 - e. Incorporate unique or characteristic architectural features, including building height, size, shape, color, texture, setback or architectural details, in the Historic Property Overlay District.
 - The applicant states that this request will allow for redevelopment of an underutilized site surrounded by a variety of supporting cultural, employment and commercial land uses that will offer services to the residents of this project. The streetscape design embraces the OTUSDAG principles and will provide a welcoming pedestrian environment for Old Town residents and patrons walking along 5th Avenue and Indian School Road. This project will provide a comfortable and safe streetscape designed with human-scale elements, shade and movement through both hardscape and building forms. Walkability will be strengthened by the addition of a new eight-foot-wide sidewalk that connects pedestrians to the canal bank from 5th Avenue, and the same on Indian School Road that leads to an inviting urban plaza at the intersection of 5th Avenue and Indian School Road.

Proposed materials, massing and architecture are inspired by some of the existing Old Town vernacular and character, both new and old. A variety of architectural styles are present in the area, including a two-story full glass building south of the site. The most prominent building in the area is the Valley Ho, which is a striking example of mid-century modern architecture that seems at home in its location. The use of masonry, cast stone, poured concrete and large areas of glass create a close connection between the building and its environment. This project's design vocabulary was inspired by the Valley Ho and the buildings' massing, colors, materials, roof eaves and vertical fins are modern in approach and context appropriate. Materials include but are not limited to, breeze block, brick, rustic siding and stucco. The building also features a "folded plate" style awning at the public entry.

The architecture is appropriate to the desert environment with natural materials and significant shading and overhang elements. Building design incorporates a strong masonry base at the ground floor and there are two towers anchoring the corners of the building along Indian School Road. Upper levels are marked with strong horizontal banding at each floor.

- 3. Ingress, egress, internal traffic circulation, off-street parking facilities, loading and service areas and pedestrian ways shall be designed as to promote safety and convenience.
 - The property is situated at the northwest corner of 5th Avenue and Indian School, with Indian School being a Major Arterial. The applicant states that, by creating a comfortable and inviting pedestrian experience along the adjacent streets, this project will encourage alternative modes of transportation, such as walking, bicycle, bus and/or trolley. Encouraging these alternatives is inherent to downtown development, as the property is located near numerous restaurants, retail and cultural destinations. Additionally, the site is located along the Arizona Canal trail system and is within approximately 1.3 miles of the Indian bend Wash muti-use path network. Building and site design encourage residents, guests and visitors to utilize Old Town for everyday dining, social interaction, recreational and cultural needs. Parking will be provided completely on-site at the ground level with access from the alley that connects to 5th Avenue so as not to impede the pedestrian environment along the streets.
- 4. If provided, mechanical equipment, appurtenances and utilities, and their associated screening shall be integral to the building design.
 - The proposal responds favorably to this criterion.
- 5. Within the Downtown Area, building and site design shall:
 - a. Demonstrate conformance with the Downtown Plan Urban Design & Architectural Guidelines;
 - b. Incorporate urban and architectural design that address human scale and incorporate pedestrian-oriented environment at the street level;
 - c. Reflect contemporary and historic interpretations of Sonoran Desert architectural traditions, by subdividing the overall massing into smaller elements, expressing small scale details, and recessing fenestrations;
 - d. Reflect the design features and materials of the urban neighborhoods in which the development is located; and
 - e. Incorporate enhanced design and aesthetics of building mass, height, materials and intensity with transitions between adjacent/abutting Type 1 and Type 2 Areas, and adjacent/abutting Type 2 Areas and existing development outside the Downtown Area.
 - The applicant states that this project creates a strong urban streetscape along Indian School Road by locating the majority of the building at the minimum building setback, culminating in an urban plaza as the building turns to address 5th Avenue. The plaza will serve as an amenity for residents and the general public, encouraging pedestrian connection through the neighborhood, and serve as a signature, defining element of the project; providing a backdrop for public and private activities. The plaza will feature native landscape elements that will provide color, texture and shade. Overall landscaping for the project will complement the architecture and provide screening of the parking area, and provide a buffer between the public and private spaces.

From a building design perspective, the awkward shape of the site led to a unique layout and solution for the building, providing distinct views of the building from off-site. The use, scale and massing of the project is appropriate for the Old Town location and provides an appropriate buffer for the mature neighborhoods to the west and south. Floor to floor heights are consistent with other development in the area. Architecture follows a mid-century modern aesthetic and features horizontal banding and large cantilevered overhangs. The palette of exterior materials includes light colored masonry, stucco, wood tone siding and decorative

metal railing. The two towers that anchor the building face along Indian School Road include dramatic, sloped awnings which create a signature look while providing shade to wrap around balconies. The project has at-grade parking interior to the site. Screening for the parking is achieved with breeze blocks to provide visual interest while still maintaining light and air to the parking area.

- 6. The location of artwork provided in accordance with the Cultural Improvement Program or Public Art Program shall address the following criteria:
 - a. Accessibility to the public;
 - b. Location near pedestrian circulation routes consistent with existing or future development or natural features;
 - c. Location near the primary pedestrian or vehicular entrance of a development;
 - d. Location in conformance with Design Standards and Policies Manual for locations affecting existing utilities, public utility easements, and vehicular sight distance requirements; and
 - e. Location in conformance to standards for public safety.
 - The applicant states that, as required by the approved PBD zoning for the project, one-percent (1%) of the building valuation, estimated at \$91,000, will be contributed to the Old Town Cultural Improvement Fund.

DEVELOPMENT INFORMATION

Zoning History

The site was annexed into the City in 1960 (Ord No. 89A) and assigned C-2 zoning. In 2003, the City adopted the Downtown Overlay, which was added to this site to amend the zoning to C-2 DO. No zoning activity has occurred for the site since the original annexation; however, the site was tied to a zoning case from 2007 (9-ZN-2007) that included relocation of an electrical substation to this site. That approval later expired.

Community Involvement

During the zoning process, the site is posted with the required signage and written notification was sent to property owners within 750 feet of the site, and the City's interested Parties List. Additionally, the applicant held an Open House on 1/6/2020 at the Hotel Valley Ho from 5:00 PM to 6:00 PM. According to the applicant's Citizen Review & Neighborhood Involvement Report, five people attended the Open House. Discussion focused primarily on traffic, parking and potential impact on views. A second Open House was held on 3/23/2020, again at the Hotel Valley Ho, from 5:30 PM to 6:30 PM. As this Open House occurred at the height of the COVID restrictions, the applicant team was prepared to greet attendees at the door and distribute information about the project, to prevent a group setting. Per the applicant's report, there were no attendees at the second Open House. With the submittal of this application, staff notified all property owners within 750 feet of the site. In addition, the applicant has been in communication with property owners surrounding the site. As of the date of this report, staff has received two written comments regarding this proposal.

Context

Located just east of the intersection of E. Indian School Road and E. 5th Avenue, the site is situated at the Old Town boundary (north of the site) and is surrounded by development of varying intensity and design; including the Hotel Valley Ho to the south, which includes a 7-story main hotel building and is protected by Historic Property (HP) zoning to preserve the unique architecture. Other buildings in the area include a two-story office building and several single-story buildings constructed in the 1960s. The proposed building is separated from the single-family neighborhood to the north by the Arizona Canal and is approximately 235 feet from the nearest single-family residence (measured building to building). Refer to attached context graphics.

Project Data

• Existing Use: Vacant

Proposed Use: Mixed-Use Development

• Buildings/Description: One 54,600 square foot residential building (includes 900 square

feet of commercial floor area)

Parcel Size: +/- 1.17 acres (gross)

Building Height Allowed: 66 feet (inclusive of rooftop appurtenances)
 Building Height Proposed: 56 feet (inclusive of rooftop appurtenances)

Parking Required:
 60 spaces (57 for residential, 3 for non-residential)

• Parking Provided: 66 spaces (includes 6 guest spaces)

Open Space Required: None required within Old Town boundary

Open Space Provided: 9,455 square feet (publicly accessible) + 2,055 square feet of off-

ATTACHMENT #5

Scottsdale Development Review Board Report | Case No. 10-DR-2022

site landscape improvements to canal bank

• Gross Floor Area Ratio Allowed: 1.3 (non-residential only)

• Gross Floor Ratio Proposed: 0.01 (900 square feet)

Density Allowed: 50 dwelling units per acre (58 units)
 Density Proposed: 46 dwelling units per acre (54 units)

Stipulations for the Development Review Board Application: Magnolia Waterside @ Old Town

Case Number: 10-DR-2022

These stipulations are intended to protect the public health, safety, welfare, and the City of Scottsdale.

APPLICABLE DOCUMENTS AND PLANS:

- 1. Except as required by the Scottsdale Revised Code (SRC), the Design Standards and Policies Manual (DSPM), and the other stipulations herein, the site design and construction shall substantially conform to the following documents:
 - a. Architectural elements, including dimensions, materials, form, color, and texture shall be consistent with the building elevations submitted by Wilder Architects, with a city staff date of 12/19/2022.
 - b. With the exception of loading/unloading, location and configuration of all site improvements shall be consistent with the site plan submitted by Wilder Architects, with a city staff date of 2/7/2023.
 - c. Landscape improvements, including quantity, size, and location shall be installed to be consistent with the preliminary landscape plan submitted by RVI, with a city staff date of 7/18/2022.
 - d. The case drainage report submitted by Sustainability Engineering Group and accepted in concept by the Stormwater Management Department of the Planning and Development Services.
 - e. The water and sewer basis of design report submitted by Sustainability Engineering and accepted "as-noted" by the Water Resources Department.

RELEVANT CASES:

Ordinance

A. At the time of review, the applicable Zoning case for the subject site was: 1-ZN-2020.

ARCHAEOLOGICAL RESOURCES:

Ordinance

B. Any development on the property is subject to the requirements of Scottsdale Revised Code, Chapter 46, Article VI, Section 46-134 - Discoveries of archaeological resources during construction.

ARCHITECTURAL DESIGN:

DRB Stipulations

2. All exterior window glazing shall be recessed a minimum of fifty (50) percent of the wall depth, including glass windows within any tower/clerestory elements. The amount or recess shall be measured from the face of the exterior wall to the face of the glazing, exclusive of external detailing.

- With the final plan submittal, the developer shall provide head, jamb and sill details clearly showing the amount of recess for all window types.
- 3. All exterior doors shall be recessed a minimum of thirty (30) percent of the wall depth, the amount of recess shall be measured from the face of the exterior wall to the face of the glazing, exclusive of external detailing. With the final plan submittal, the developer shall provide head, jamb and sill details clearly showing the amount of recess for all door types.

SITE DESIGN:

Ordinance

- C. A minimum eight-foot-wide sidewalk shall be provided along the eastern edge of the project site to connect pedestrians from 5th Avenue to the canal bank. The connection shall include pedestrian scale lighting along the sidewalk and step lights at the staircase leading up to the canal bank. Signage shall be provided at the entrance to the connection on 5th Avenue directing those with disabilities to the ADA compliant connection at the intersection of 68th Street & Indian School.
- D. On-site loading/unloading shall be located per the 7/18/2022 version of the site plan and shall be striped and marked accordingly. No parking spaces shall be designated for loading/unloading.
- E. Prior to issuance of any permits, except underground infrastructure and grading, a final plat to assemble the three parcels that make up the site into one parcel shall be approved and recorded.

DRB Stipulations

4. Prior to issuance of any building permit for the development project, the property owner shall submit plans and receive approval to construct a refuse enclosure in conformance with the City of Scottsdale Supplements to MAG Standard Detail 2146-1 for single enclosures. Method of collection shall be a vertical compactor with a minimum capacity of two cubic yards.

LANDSCAPE DESIGN:

DRB Stipulations

- Landscape pots and/or raised landscape planters shall be a minimum of 36 inches in diameter, a sufficient depth to support the root system of the plants located in the pots/planters, and an automatic irrigation system.
- 6. With the final plans submittal, the property owner shall update the landscape plans to show all utility lines and ensure that all new trees are placed at least eight (8) feet away from any utility lines.

EXTRIOR LIGHTING:

DRB Stipulations

- 7. All exterior luminaires shall meet all IES requirements for full cutoff and be aimed downward and away from property line except for sign and landscape lighting.
- 8. Incorporate the following parking lot and site lighting into the project's design:
 - a. The maintained average horizontal luminance level, at grade on the site, shall not exceed 2.0 foot-candles. All exterior luminaires shall be included in this calculation.
 - b. The maintained maximum horizontal luminance level, at grade on the site, shall not exceed 8.0 foot-candles. All exterior luminaires shall be included in this calculation.
 - c. The initial vertical luminance at six feet above grade, along the entire property line shall not exceed 1.0 foot-candles. All exterior luminaires shall be included in this calculation.

- d. All exterior lighting shall have a color temperature of 3,000 Kelvin or less.
- e. The total lumen per luminaire shall not exceed 24,000 lumens.

VEHICULAR AND BICYCLE PARKING:

Ordinance

F. With the final plan submittal, the site plan shall be revised to show the location of required bike parking (racks). Bike racks should be located near the main entrance to the building and so they are not obstructing pedestrian circulation.

STREET DEDICATIONS:

DRB Stipulations

- 9. Prior to the issuance of any building permit for the development project, the property owner shall make the following fee simple right-of-way dedications to the City of Scottsdale:
 - a. E. 5TH AVENUE and E. INDIAN SCHOOL ROAD INTERSECTION. Twenty-five-foot radius where street rights-of-way intersect
 - b. N. SCOTTSDALE ROAD. Twelve-foot dedication for a total north half street of fifty-five feet.

STREET INFRASTRUCTURE:

DRB Stipulations

- 10. Prior to the issuance of any building permit for the development project, the property owner shall submit and obtain approval of civil construction documents to construct the following improvements:
 - a. E. INDIAN SCHOOL ROAD.
 - i. Minimum eight-foot-wide sidewalk, detached from street curb along entire project frontage
 - b. E. 5TH AVENUE.
 - i. Minimum eight-foot-wide sidewalk, detached from street curb along entire project frontage
 - c. ALLEY.
 - i. Reconstruction/re-pavement along entire project frontage, including positive drainage
- 11. All curb ramps for public and pedestrian sidewalks that intersect public and private streets, or driveways that intersect public and private streets, shall have truncated domes that are colored to match brick red or terracotta.

WATER AND WASTEWATER:

Ordinance

G. All water and wastewater infrastructure improvements shall be constructed in accordance with this City of Scottsdale (COS) Supplement to MAG Specifications and Details, and the Design Standards and Policies Manual.

DRB Stipulations

12. Prior to issuance of any permit for the development project, the property owner shall submit and obtain approval of construction documents to construct all water and wastewater improvements, including but not limited to, the following:

- a. E. 5^{TH} AVENUE.
 - i. Replacement of the six-inch main along the property frontage with a new 12-inch ductile iron pipe (DIP) main (approximately 175 linear feet)
 - ii. Connection of the existing fire hydrant, and all domestic and fire line services, to the new 12-inch DIP main
 - iii. New sewer service line out falling into a new or existing sewer manhole in 5th Avenue

b. E. INDIAN SCHOOL ROAD.

- Reconstruction of the connection from the existing 12-inch asbestos cement pipe (ACP) main in Indian School Road to the new 12-inch DIP main in 5th Avenue, and replacement of a segment of the ACP main with DIP
- ii. Removal of existing meter in Indian School Road. Meter can eb credited against the new meter for the development.
- 13. Existing water and sewer service lines to this site shall be utilized or shall be disconnected at the main pursuant to the Water Resources Department requirements.

DRAINAGE AND FLOOD CONTROL:

DRB Stipulations

14. With the civil construction document submittal, the property owner shall submit a final drainage report that demonstrates consistency with the DSPM, and the case drainage report accepted in concept by the Stormwater Manager or designee.

EASEMENTS DEDICATIONS:

DRB Stipulations


- 15. Prior to the issuance of any building permit for the development project, the property owner shall dedicate the following easements to the City of Scottsdale on a final plat or map of dedication:
 - a. Sight Distance Easement, in conformance with figures 5.3-26 and 5.3-27 of Section 5.3 of the DSPM, where a sight distance triangle crosses on to the project site.
 - b. Sight Distance Easement over the Traffic Safety Triangle at the intersection of 5th Ave. and Indian School Road.
 - c. Continuous Public Non-Motorized Access (PNMA) Easement to the City of Scottsdale to contain any portion of the pedestrian connection from 5th Ave. to the canal bank.
 - d. Minimum twenty (20) foot wide Water + Sewer Facilities Easement to contain public water and sewer infrastructure located outside public right-of-way.
 - e. One-foot-wide Vehicular Non-Access (VNA) easement along the 5th Avenue and Indian School Road site frontages.


ADDITIONAL ITEMS:

DRB Stipulations

16. CONSTRUCTION MANAGEMENT PLAN. Prior to any permit issuance, a construction management plan that includes construction traffic routes, work force vehicle parking, and construction vehicle parking shall be provided to staff for review and approval.

17. MARSHALLING AND STORAGE YARD(S). Any use of City right-of-way, including alleys, for marshalling and/or storage yards shall require prior approval of the City's Transportation Department and payment of any associated fees through the application of a Marshalling and Storage yard permit.

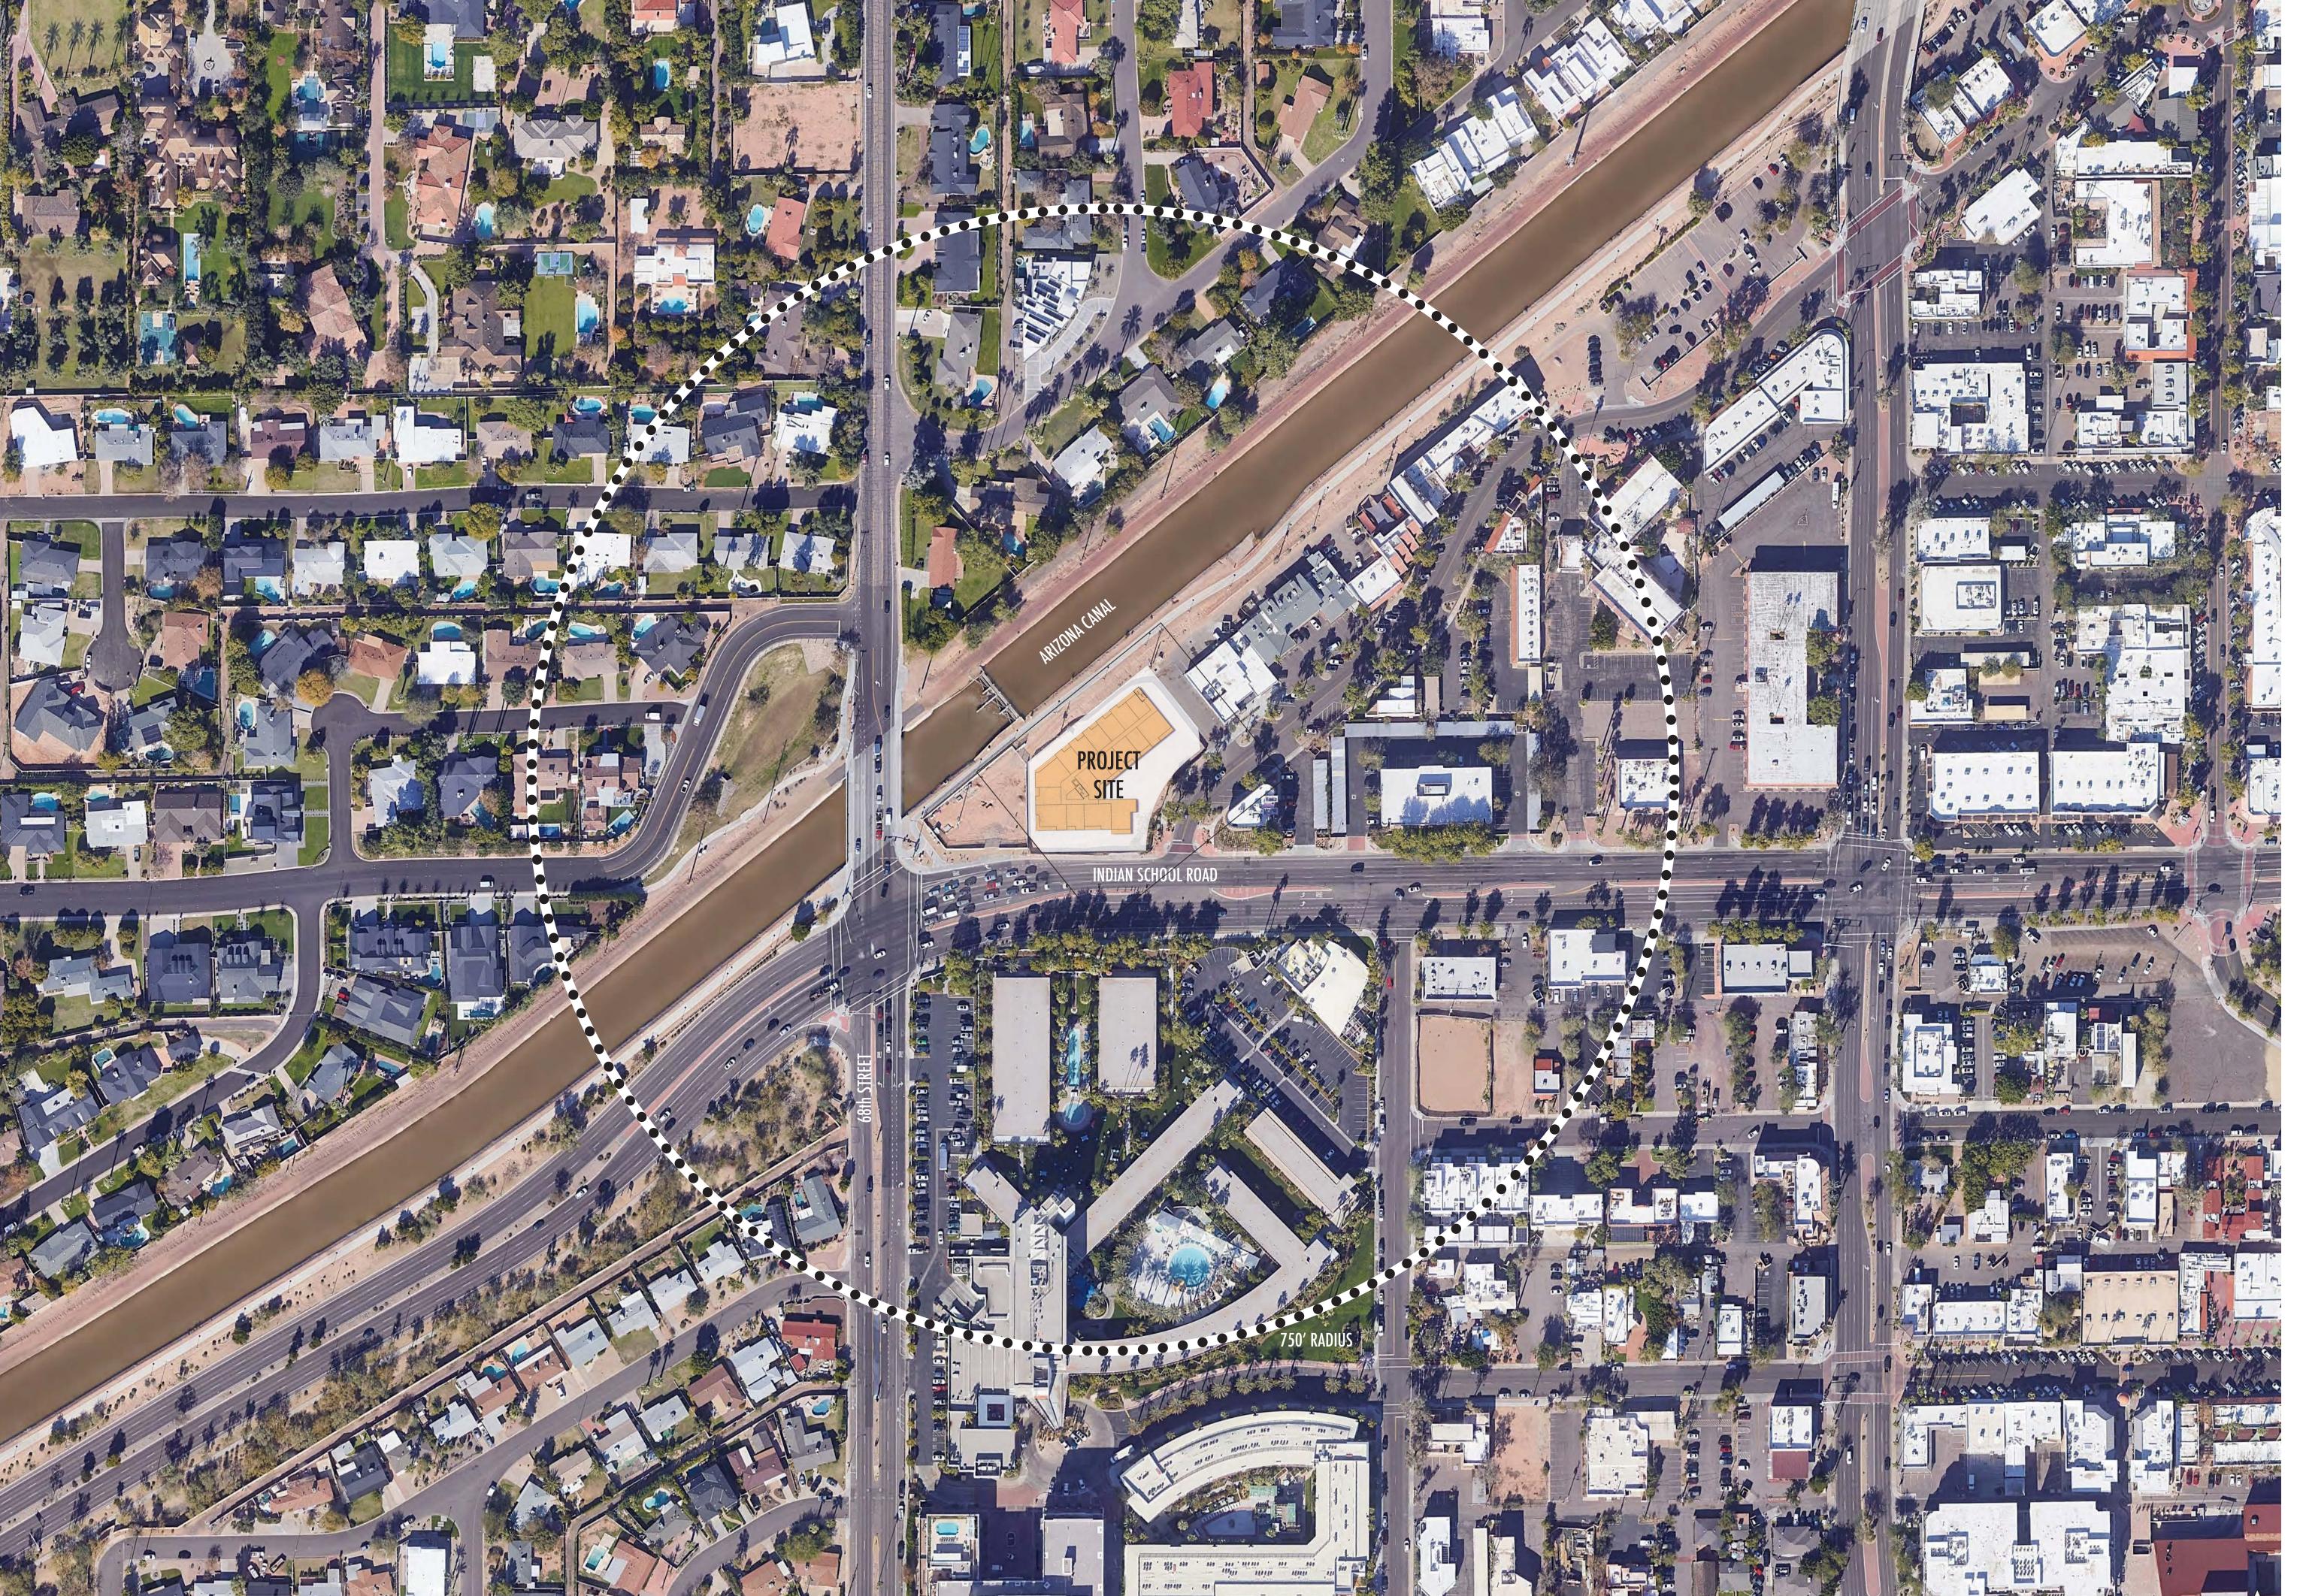

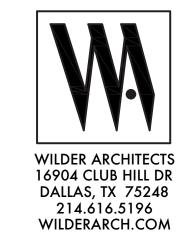



No.	Date	Issues
01	21March 22	DRB Submittal

Magnolia Property Company 2435 E Southlake Boulevard Southlake, TX 76092 817.769.2580 randy@mpcres.com

Wilder Architects 16904 Club Hill Drive Dallas, TX 75248 214.616.5196 wilder@wilderarch.com

Drawing Name:
SITE AERIAL PHOTO

Sheet Number: A001

ARIZONA CANAL ARIZONA CANAL TRAIL STAIR CONNECTION TO CANAL TRAIL with STEP LIGHTS EXISTING UTILITY POLE TO EXISTING UTILITY POLE TO PEDESTRIAN BOLLARD LIGHTS BE REMOVED AS PART OF BE REMOVED AS PART OF THE PROCESS OF BURYING TRASH ENCLOSURE PER CITY OF SCOTTSDALE DETAIL NO. 2 146-1 WITH VERTICAL COMPACTOR with UTILITY LINES UTILITY LINES -BREEZE BLOCK WALL RATIO OF 1:4 COMPACTION RATE > SIGNAGE WITH DIRECTIONS TO ADA COMPLIANT CONNECTION TO CANAL PATHWAY BREEZE BLOCK WALL -24'-0" ENTRY DRIVE NON-MOTORIZED PUBLIC ACCESS EASEMENT CONNECTION FROM 5TH AVE. TO CANAL BANK —LINE OF BUILDING ABOVE -SAFETY VISIBILITY TRIANGLE RECONSTRUCTED ALLEY WITH POSITIVE DRAINAGE 4' HIGH SCREENING WALL -MECH NON-RESIDENTIAL COMMERCIAL 900 SF LEASING / AMENITY 950 SF 1,850 SF - 8' SIDEWALK WITH ADA COMPLIANT CROSSWALKS **EXISTING ON STREET** SIGNAGE WITH DIRECTIONS TO ADA COMPLIANT CONNECTION PARKING TO REMAIN TO CANAL PATHWAY 1' VEHICULAR NON-ACCESS -EASEMENT ALONG INDIAN SCHOOL AND 5TH AVENUE CITY OF SCOTTSDALE **EXISTING ON STREET** PARKING TO REMAIN SIGNAGE WITH DIRECTIONS TO — ADA COMPLIANT CONNECTION TO CANAL PATHWAY SITE PLAN / PARKING PLAN SCALE: 1/16" = 1'-0"

PROJECT INFO

APN: PROJECT ADDRESS: 6824 E INDIAN SCHOOL RD SCOTTSDALE, AZ 85251

SITE AREA (APPROX GROSS): 51,393 SF (1.17 AC) **NET AREA** 41,885 SF TOTAL ALLOWABLE UNITS (1.17 \times 50DU/AC) 58 54 TOTAL UNITS PROVIDED

BUILDING AREA RESIDENTIAL

COMMERCIAL

LEVEL 2 (without BALCONY) 18,200 SF LEVEL 3 (without BALCONY)
LEVEL 4 (without BALCONY) 18,200 SF 18,200 SF GROSS BUILDING AREA 54,600 SF NET LEASABLE AREA 47,649 SF ALLOWABLE GFR 1.3 1.06 GFR PROVIDED (54,600 / 51,393 SF) LEVEL 1 NON-RESIDENTIAL 950 SF 900 SF LEASING / RESIDENT AMENITY

HEIGHT LIMIT - PREVIOUSLY APPROVED: 56'-6"' **BUILDING HEIGHT:** MAX DENSITY 50 DU per ACRE

REQ'D SETBACKS (FROM BACK OF CURB) Table 5.3006.C INDIAN SCHOOL 25' (PREVIOUSLY APPROVED) 5TH AVE CANAL

PARKING Table 9.103.B REQ'D RESIDENTIAL 1 SPACE per STUDIO / 1BR (48) 2 SPACES per 2BR (6) 12 REQ'D COMMERCIAL 1 SPACE per 300 SF TOTAL PARKING REQ'D

63 SPACES 65 SPACES PARKING PROVIDED 2 TANDEM SPACES 67 SPACES

MIN. ACCESSIBLE PARKING REQ'D ACCESSIBLE PARKING PROVIDED BIKE PARKING REQ'D (2 SPACES FOR EVERY 10 CAR SPACES) BIKE PARKING PROVIDED

REQUIRED OPEN SPACE TOTAL OPEN SPACE MIN. 25% OF NET LOT AREA $38,160 \text{ SF} \times 0.25 = 9,540 \text{ SF}$

PROVIDED OPEN SPACE FRONTAL OPEN SPACE:
OPEN SPACE OTHER THAN FRONTAL OPEN SPACE: 5,005 SF 9,1*77* SF 14,182 SF (37%)

2,588 SF PROVIDED PARKING LOT LANDSCAPE (11% OF 24,200 SF PARKING AREA)

REFUSE CALCULATIONS PER CITY OF SCOTTSDALE, 1 ENCLOSURE FOR EVERY 20 UNITS 54 / 20 = 2 CONTAINERS REQ'D2 CONTAINERS @ 4 CU. YDS. = 8 CU. YDS. REQ'D



Project Owner:



MAGNOLIA PROPERTY CO. 2435 SOUTHLAKE BLVD. **SUITE 150** SOUTHLAKE, TX 76092

No.	Date	Issues
01	21March 22	DRB Submittal
02	15 July 22	City comments
03	18 Nov 22	City comments
04	16 Dec 22	City comments
05	06 Feb 23	City comments

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Project Owner:

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randy@mpcres.com

wilder@wilderarch.com

Architect: Wilder Architects 16904 Club Hill Drive Dallas, TX 75248 214.616.5196

Drawing Name:

SITE / PARKING PLAN

Sheet Number:

ARIZONA CANAL ARIZONA CANAL TRAIL LEASING / RESIDENT AMENITY COMMERCIAL STAIR CONNECTION TO CANAL TRAIL EXISTING UTILITY POLE TO — BE REMOVED AS PART OF EXISTING UTILITY POLE TO BE REMOVED AS PART OF MAX DENSITY THE PROCESS OF BURYING UTILITY LINES UTILITY LINES! -TRASH ENCLOSURE PER CITY OF SCOTTSDALE DETAIL NO. 2146-1 BREEZE BLOCK WALL CANAL 1 SPACE per 300 SF BREEZE BLOCK WALL -24'-0" ENTRY DRIVE BIKE PARKING PROVIDED —LINE OF BUILDING ABOVE -_ _ _ _ _ _ _ _ _ _ LOADING ZONE RECONSTRUCTED ALLEY WITH POSITIVE DRAINAGE NON-RESIDENTIAL COMMERCIAL 900 SF LEASING / AMENITY 950 SF 1,850 SF – 8' SIDEWALK WITH ADA COMPLIANT CROSSWALKS **EXISTING ON STREET** PARKING TO REMAIN CITY OF SCOTTSDALE E. 5th AVE. 1' VEHICULAR NON-ACCESS EASEMENT ALONG INDIAN **EXISTING ON STREET** SCHOOL AND 5TH AVENUE PARKING TO REMAIN 25' RADIUS @ INTERSECTION SITE PLAN / PARKING PLAN SCALE: 1/16" = 1'-0"

PROJECT INFO

APN: PROJECT ADDRESS: 6824 E INDIAN SCHOOL RD SCOTTSDALE, AZ 85251

SITE SITE AREA (APPROX GROSS): 51,393 SF (1.17 AC) **NET AREA** 41,885 SF TOTAL ALLOWABLE UNITS (1.17 x 50DU/AC)
TOTAL UNITS PROVIDED 58 54

BUILDING AREA RESIDENTIAL

18,200 SF 18,200 SF 18,200 SF LEVEL 2 (without BALCONY) LEVEL 3 (without BALCONY)
LEVEL 4 (without BALCONY) GROSS BUILDING AREA 54,600 SF 47,649 SF NET LEASABLE AREA 1.3 ALLOWABLE GFR GFR PROVIDED (54,600 / 51,393 SF) 1.06 LEVEL 1 NON-RESIDENTIAL

950 SF 900 SF **HEIGHT LIMIT - PREVIOUSLY APPROVED:** 56'-6"' **BUILDING HEIGHT:**

50 DU per ACRE

REQ'D SETBACKS (FROM BACK OF CURB) Table 5.3006.C INDIAN SCHOOL 25' (PREVIOUSLY APPROVED) 5TH AVE

PARKING Table 9.103.B REQ'D RESIDENTIAL 1 SPACE per STUDIO / 1BR (48) 48 12 2 SPACES per 2BR (6) REQ'D COMMERCIAL

TOTAL PARKING REQ'D 63 SPACES 65 SPACES PARKING PROVIDED 2 TANDEM SPACES

MIN. ACCESSIBLE PARKING REQ'D ACCESSIBLE PARKING PROVIDED **BIKE PARKING REQ'D** (2 SPACES FOR EVERY 10 CAR SPACES)

REQUIRED OPEN SPACE TOTAL OPEN SPACE MIN. 25% OF NET LOT AREA

 $38,160 \text{ SF} \times 0.25 = 9,540 \text{ SF}$ PROVIDED OPEN SPACE FRONTAL OPEN SPACE:
OPEN SPACE OTHER THAN FRONTAL OPEN SPACE: 5,005 SF 9,1*77* SF 14,182 SF (37%)

67 SPACES

2,588 SF PROVIDED PARKING LOT LANDSCAPE (11% OF 24,200 SF PARKING AREA)

REFUSE CALCULATIONS PER CITY OF SCOTTSDALE, 1 ENCLOSURE FOR EVERY 20 UNITS 54 / 20 = 2 CONTAINERS REQ'D2 CONTAINERS @ 4 CU. YDS. = 8 CU. YDS. REQ'D



Project Owner:



MAGNOLIA PROPERTY CO. 2435 SOUTHLAKE BLVD. **SUITE 150** SOUTHLAKE, TX 76092

No.	Date	Issues
01	21 March 22	DRB Submittal
02	15 July 22	City comments

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Project Owner:

Magnolia Property Company 2435 E Southlake Boulevard Southlake, TX 76092 817.769.2580

randy@mpcres.com


wilder@wilderarch.com

Architect: Wilder Architects 16904 Club Hill Drive Dallas, TX 75248 214.616.5196

Drawing Name:

SITE / PARKING PLAN

Sheet Number:

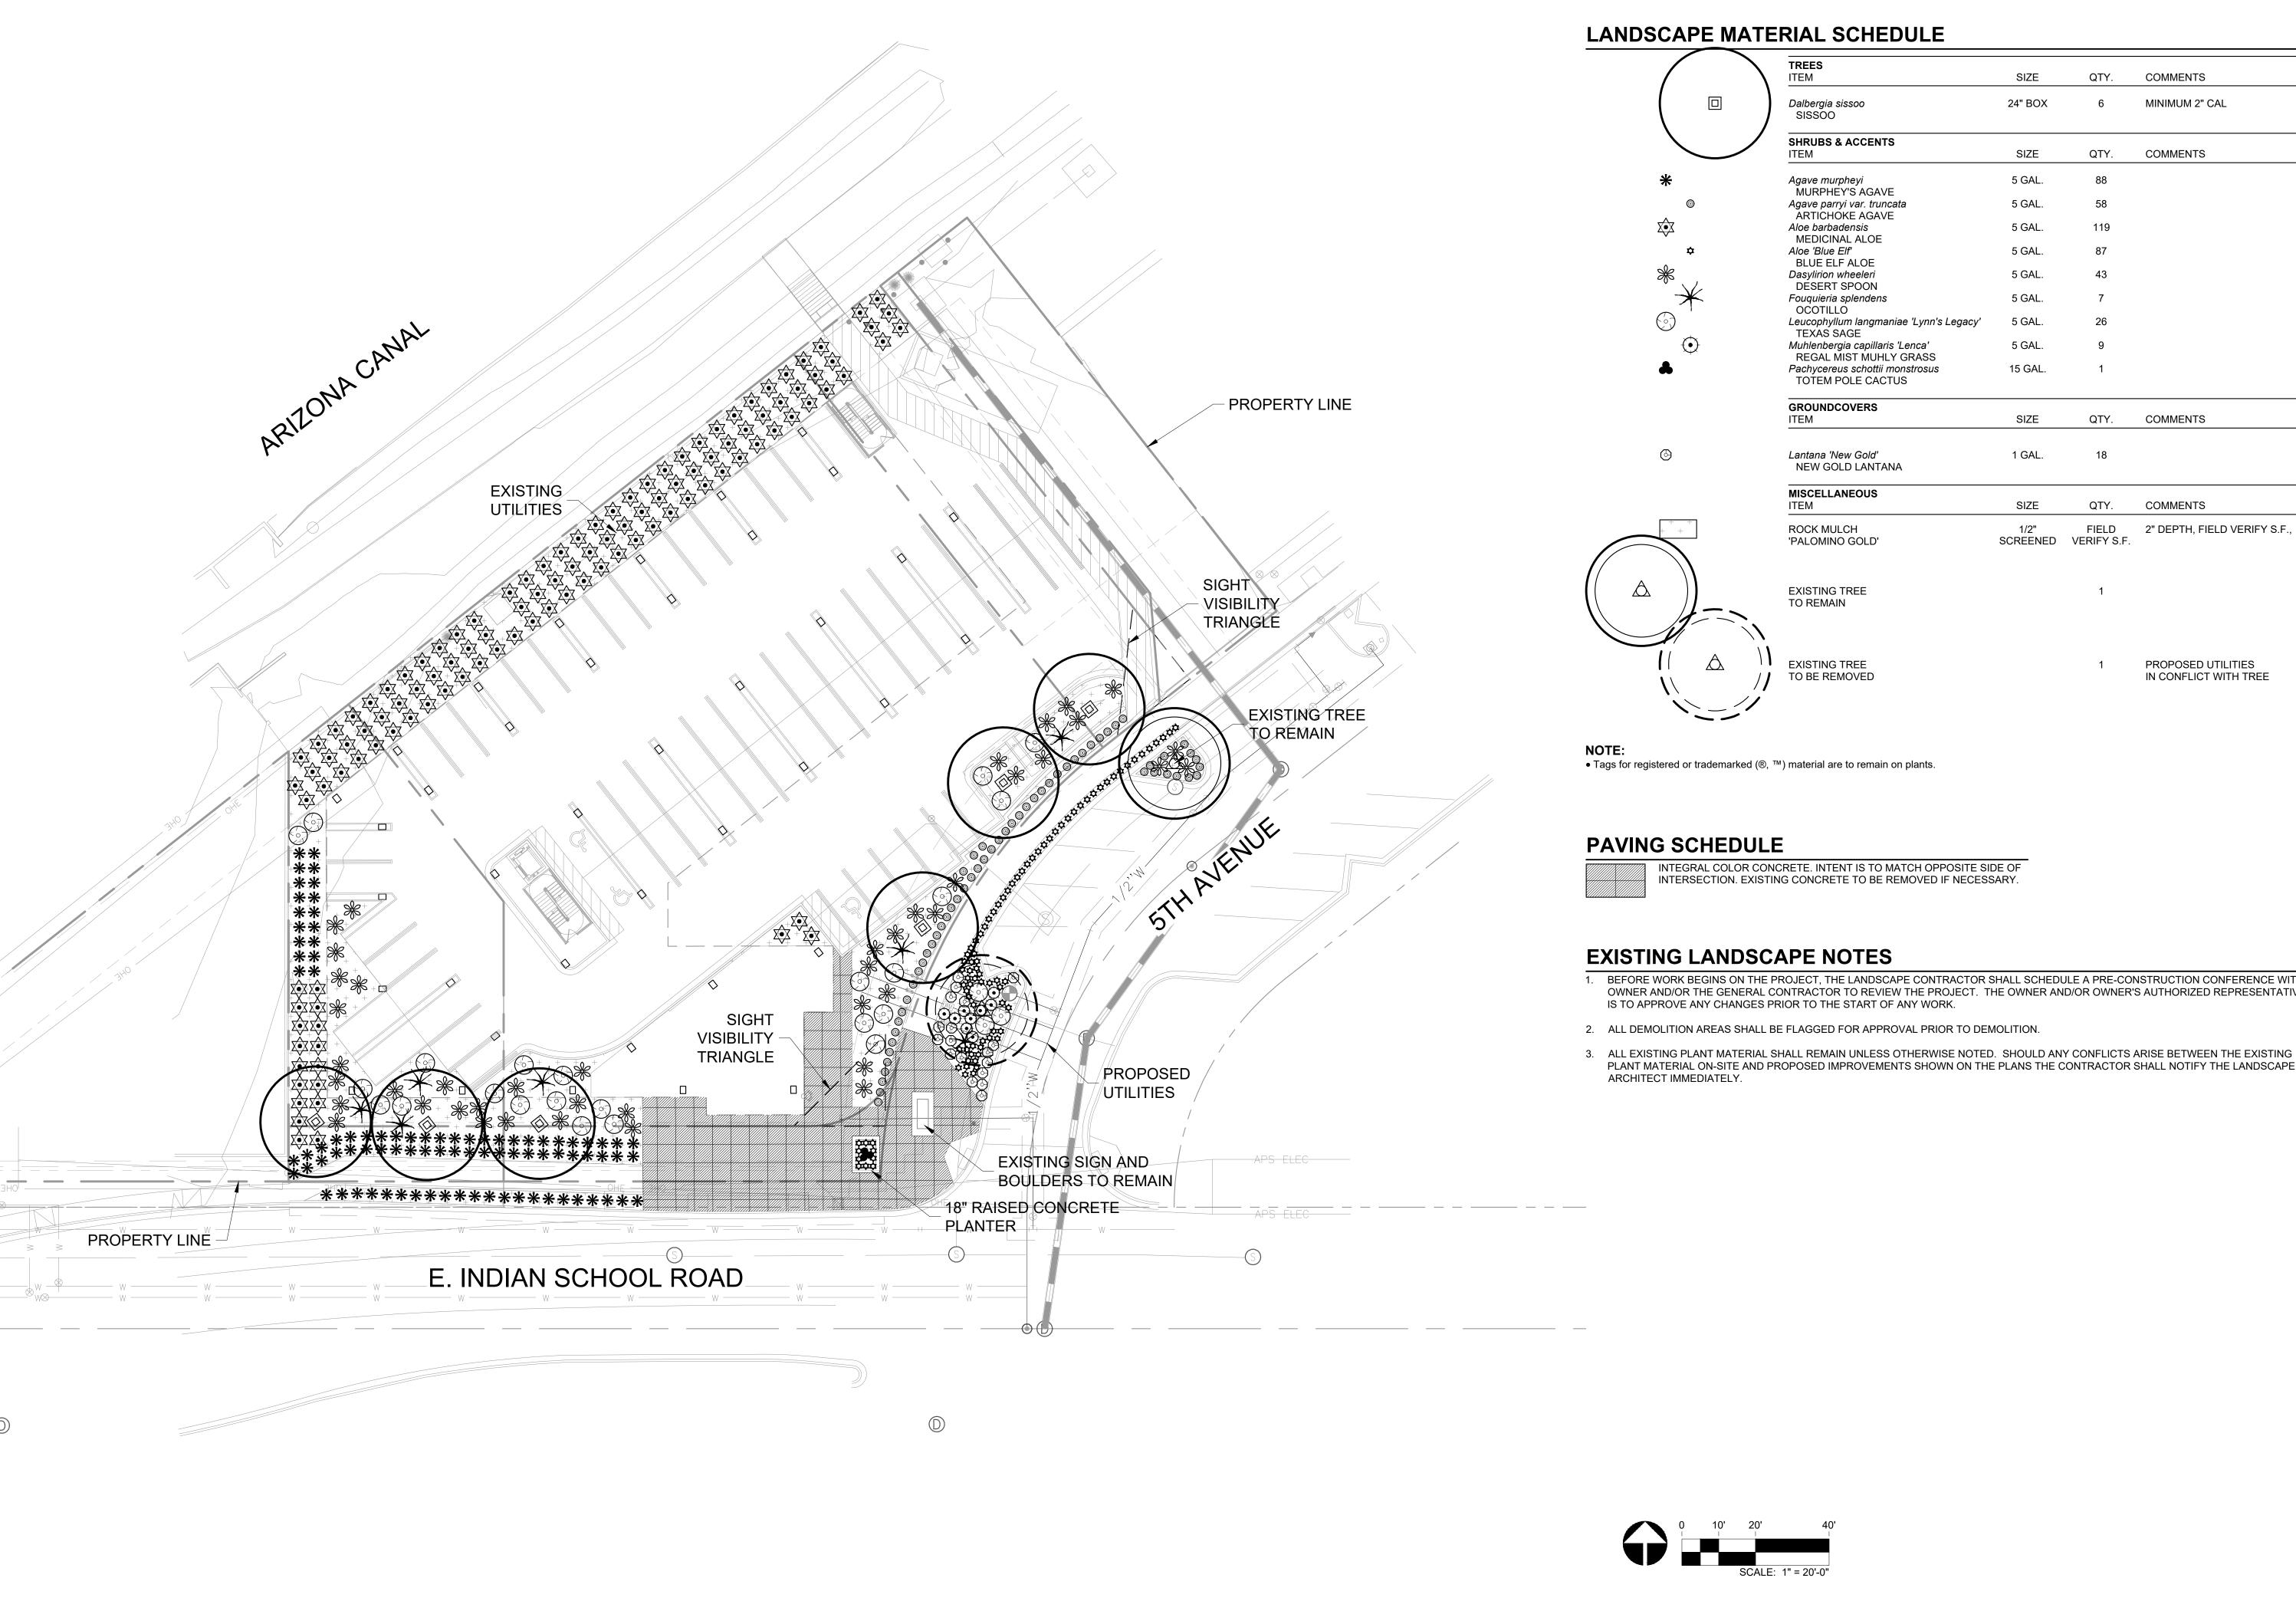

ATTACHMENT #10

COMMENTS MINIMUM 2" CAL COMMENTS

COMMENTS 2" DEPTH, FIELD VERIFY S.F.,

PROPOSED UTILITIES IN CONFLICT WITH TREE

Tempe, Arizona 85281 Tel: 480.994.0994 www.rviplanning.com




ARIZONA

PROJECT NO: 21004980 JULY 15, 2022 DRAWN: REVIEWED: REVISIONS

HARDSCAPE

AND PLANTING PLAN

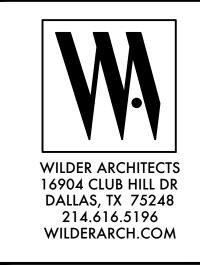

CANAL LANDSCAPE 2,210 + 219 = 2,429 SF

FRONTAL OPEN SPACE

PARKING LOT LANDSCAPE 675+295+147+1,218+253 = 2,588 \$

4,160 SF

5,005 SF



MAGNOLIA PROPERTY CO. 2435 SOUTHLAKE BLVD. SUITE 150 SOUTHLAKE, TX 76092

Issues and Revisions: 21 March 22 DRB Submittal

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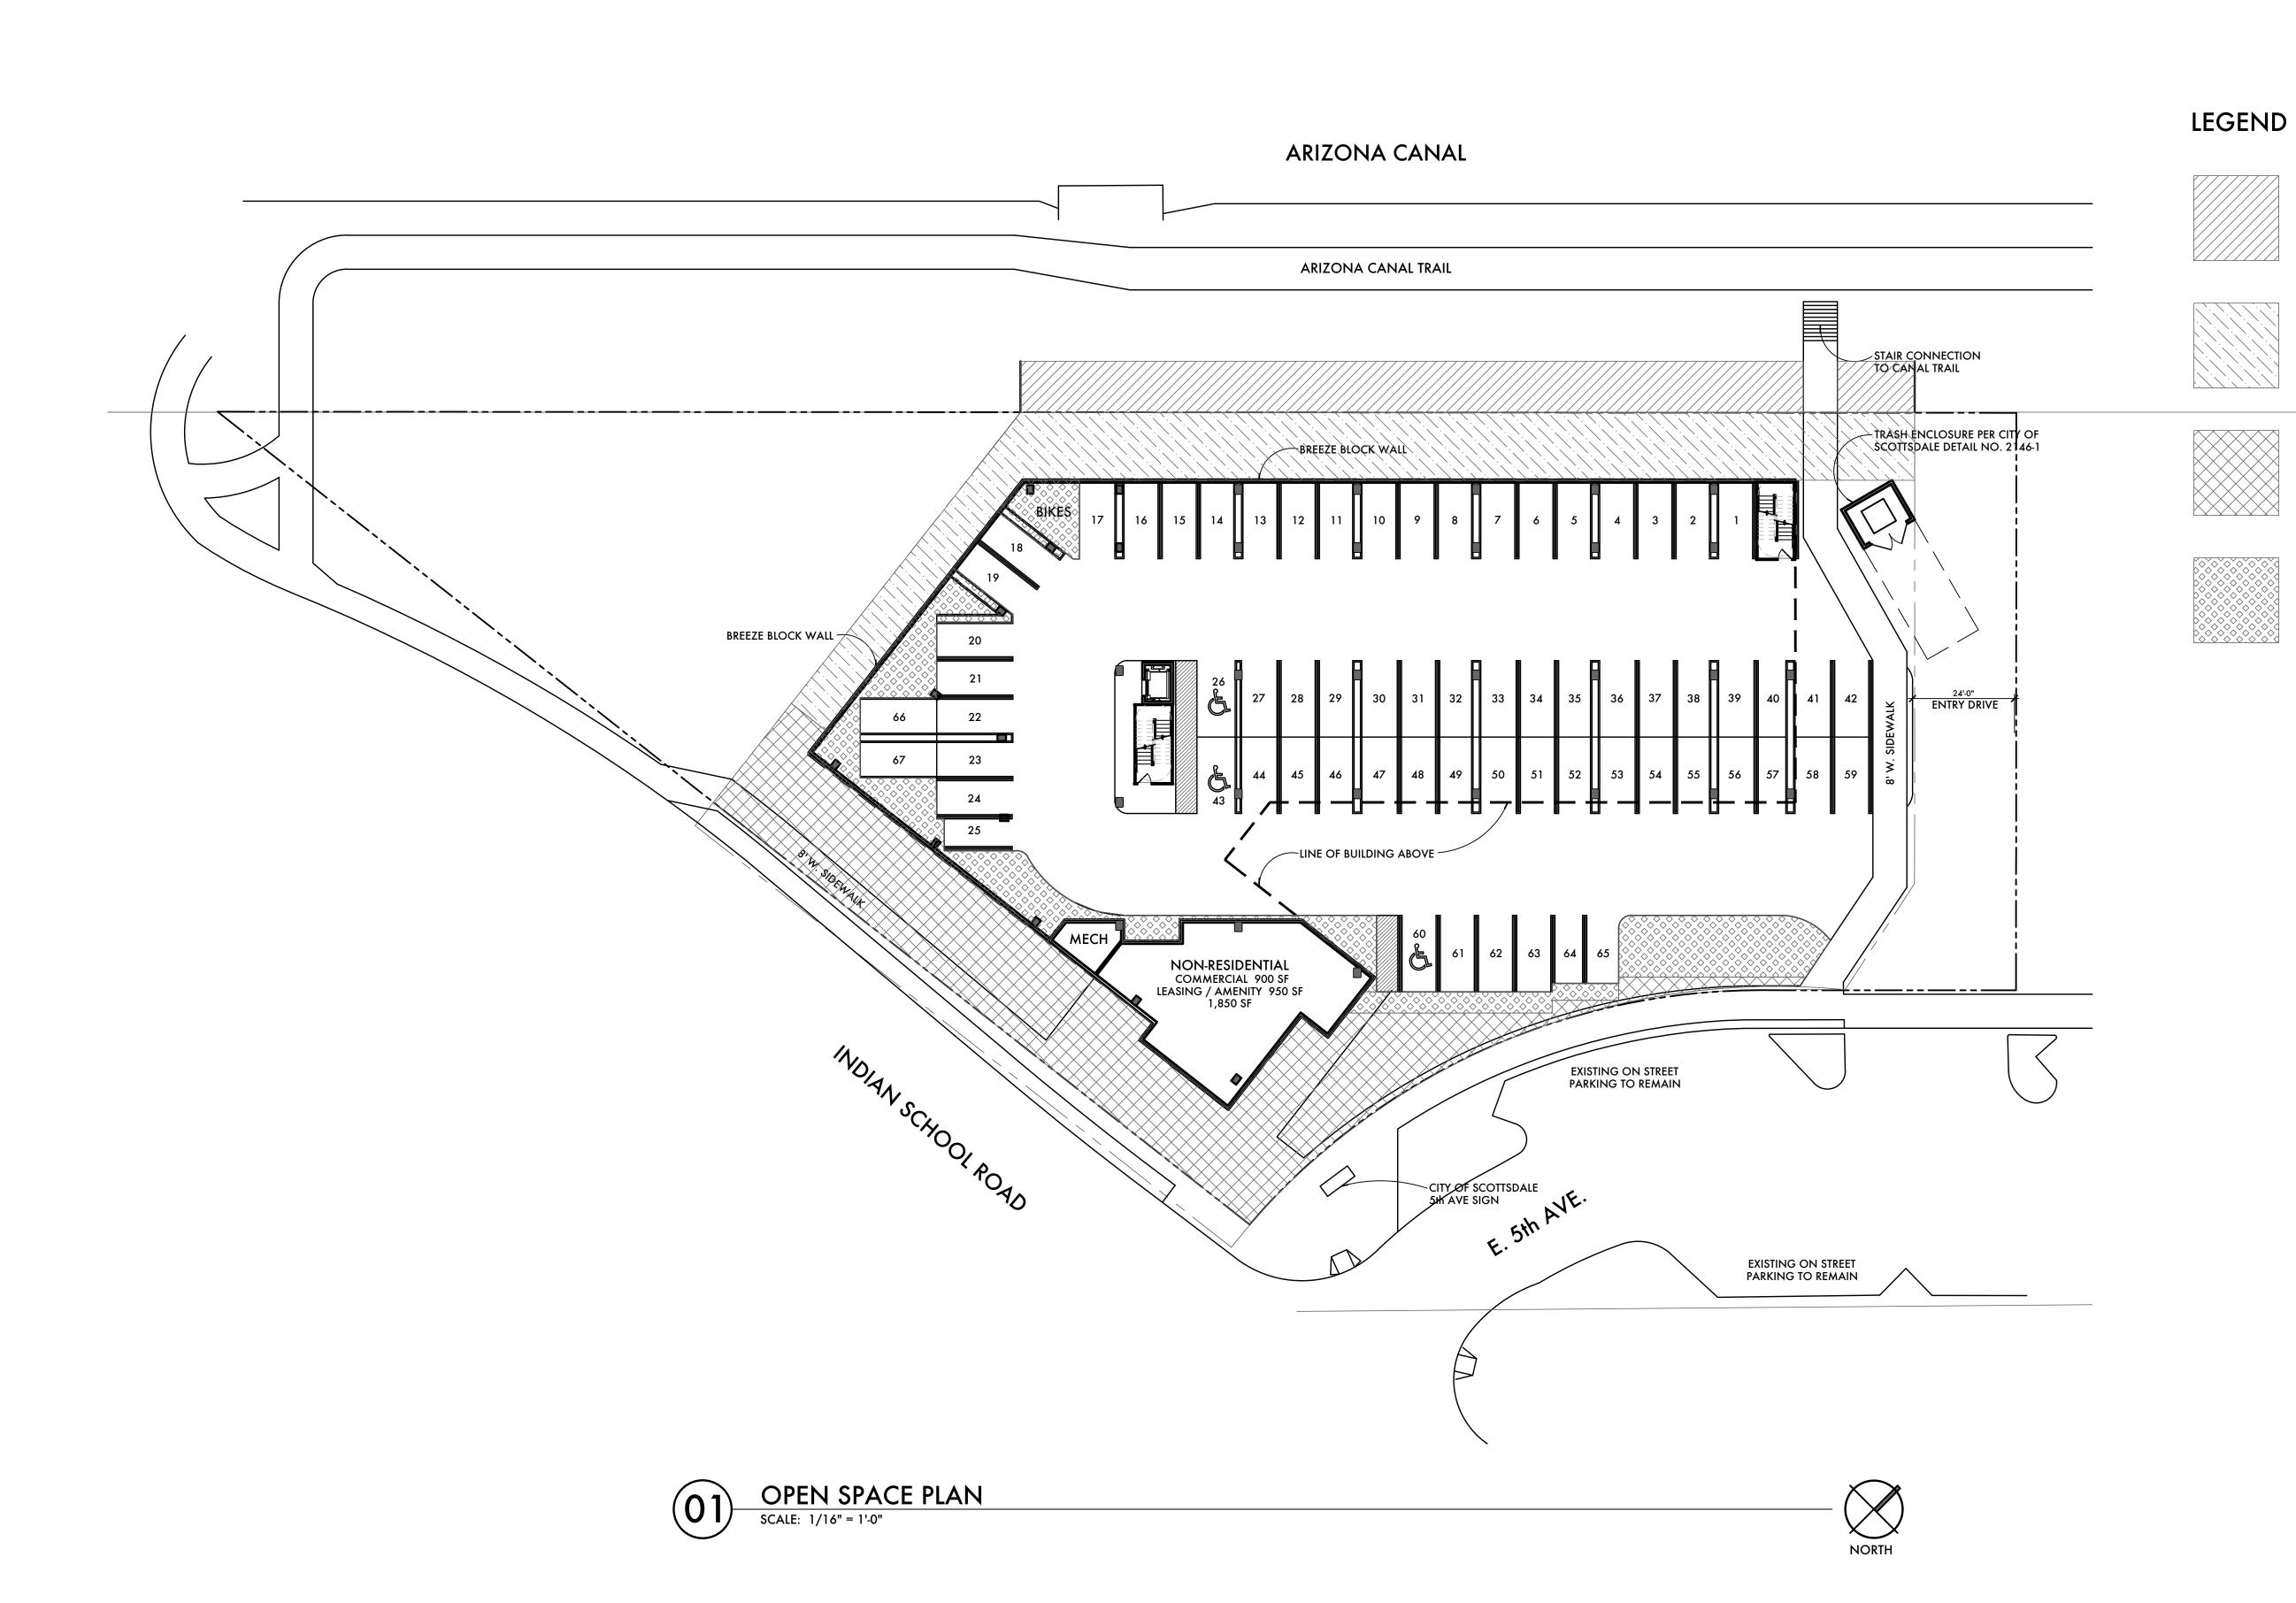
Project Owner:
Contact: Magnolia Property Company
2435 E Southlake Boulevard
Southlake, TX 76092
817.769.2580
randy@mpcres.com


Architect: Wilder Architects 16904 Club Hill Drive Dallas, TX 75248 214.616.5196 wilder@wilderarch.com

Drawing Name:

OPEN SPACE PLAN

Sheet Number:



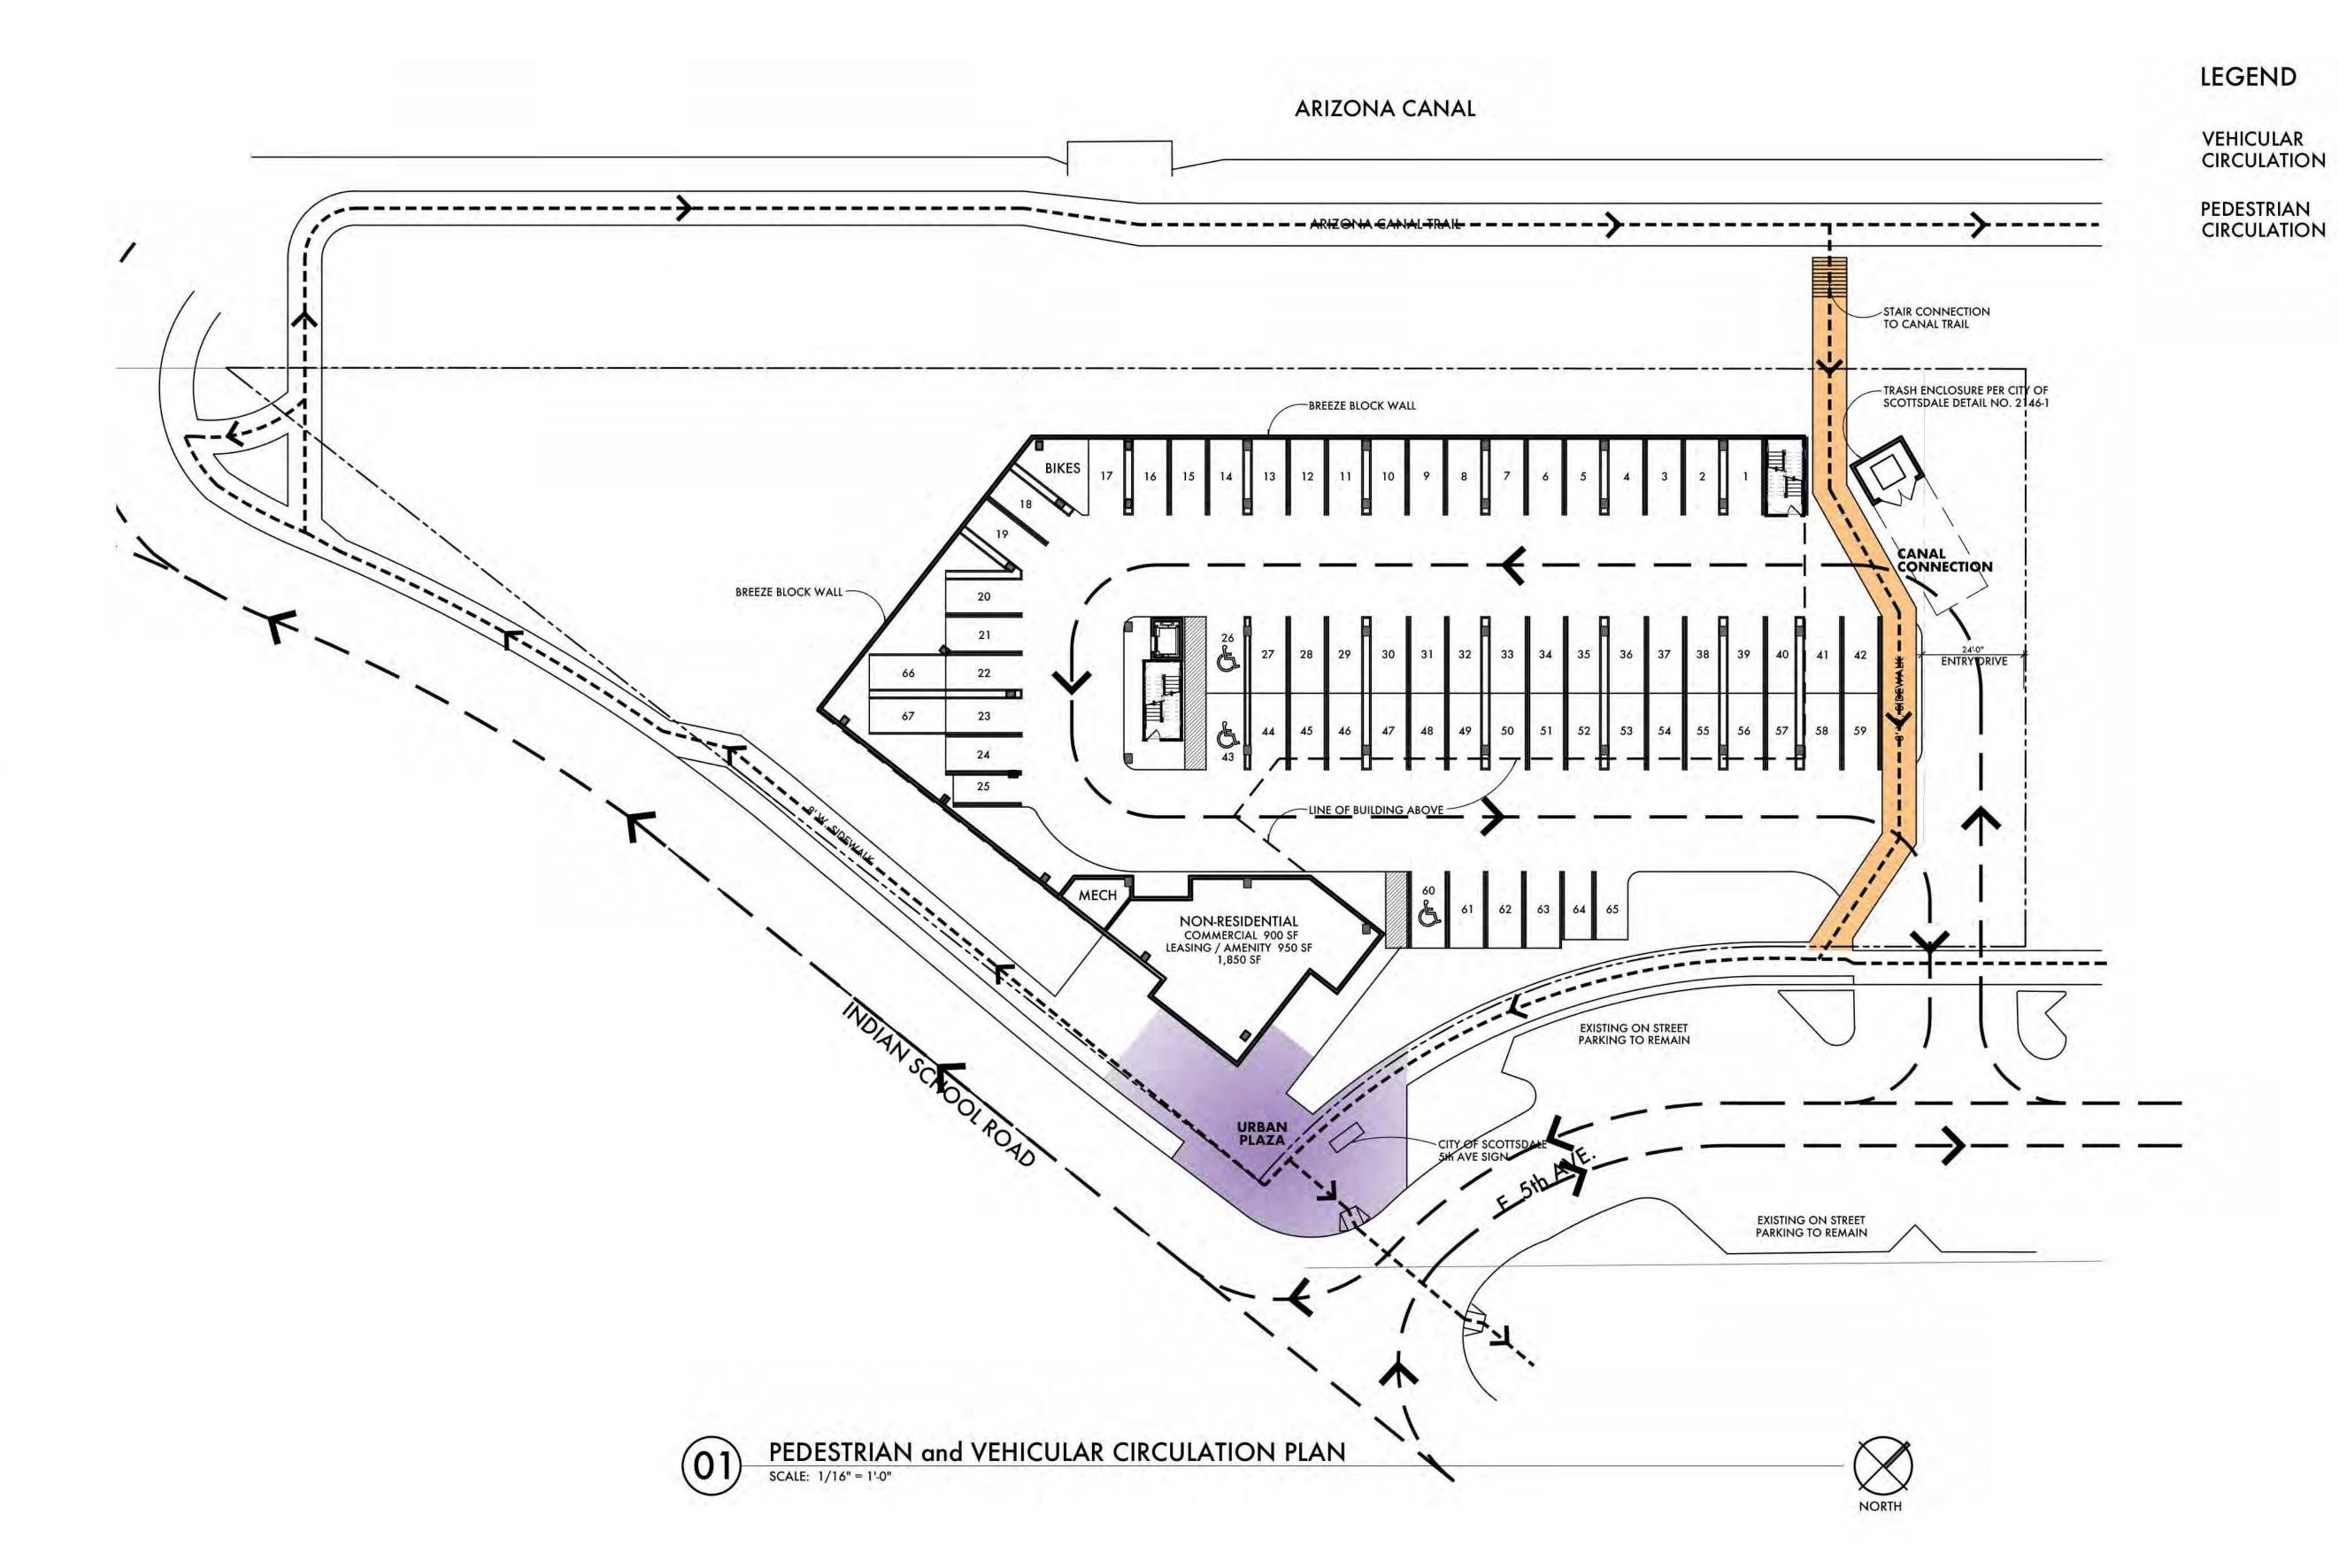





Issue	s and Revisions:	
No.	Date	Issues
01	21March 22	DRB Submitta

Project Owner:
Contact: Magnolia Property Company
2435 E Southlake Boulevard
Southlake, TX 76092
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randy@mpcres.com

Wilder Architects 16904 Club Hill Drive Dallas, TX 75248


214.616.5196 wilder@wilderarch.com Drawing Name:

CIRCULATION PLAN


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Sheet Number:

- 3.01 PORTLAND CEMENT PLASTER SW6252 "ICE CUBE" 3.02 PORTLAND CEMENT PLASTER - SW7029 "AGREEABLE GRAY"
- 3.03 PORTLAND CEMENT PLASTER SW7031 "MEGA GRIEGE"
- 3.04 FIBER CEMENT SIDING WOODTONE RUSTIC SERIES
- 3.05 FIBER CEMENT SIDING -
- 3.06 BRICK ACME 3.07 PAINTED METAL RAILING - SW
- 3.08 CEMENTITIOUS SHADE AWNING
- 3.09 PATIO PRIVACY SCREEN 3.10 BREEZE BLOCKS - IBIZA "NATURAL WHITE"
- 3.11 CMU BURNISHED FACE BLOCK3.12 VINYL WINDOW DOUBLE PANED INSULATED
 - DARK BRONZE FRAME
- 3.13 PATIO DOOR DARK BRONZE FRAME
- 3.14 STOREFRONT DARK BRONZE FRAME

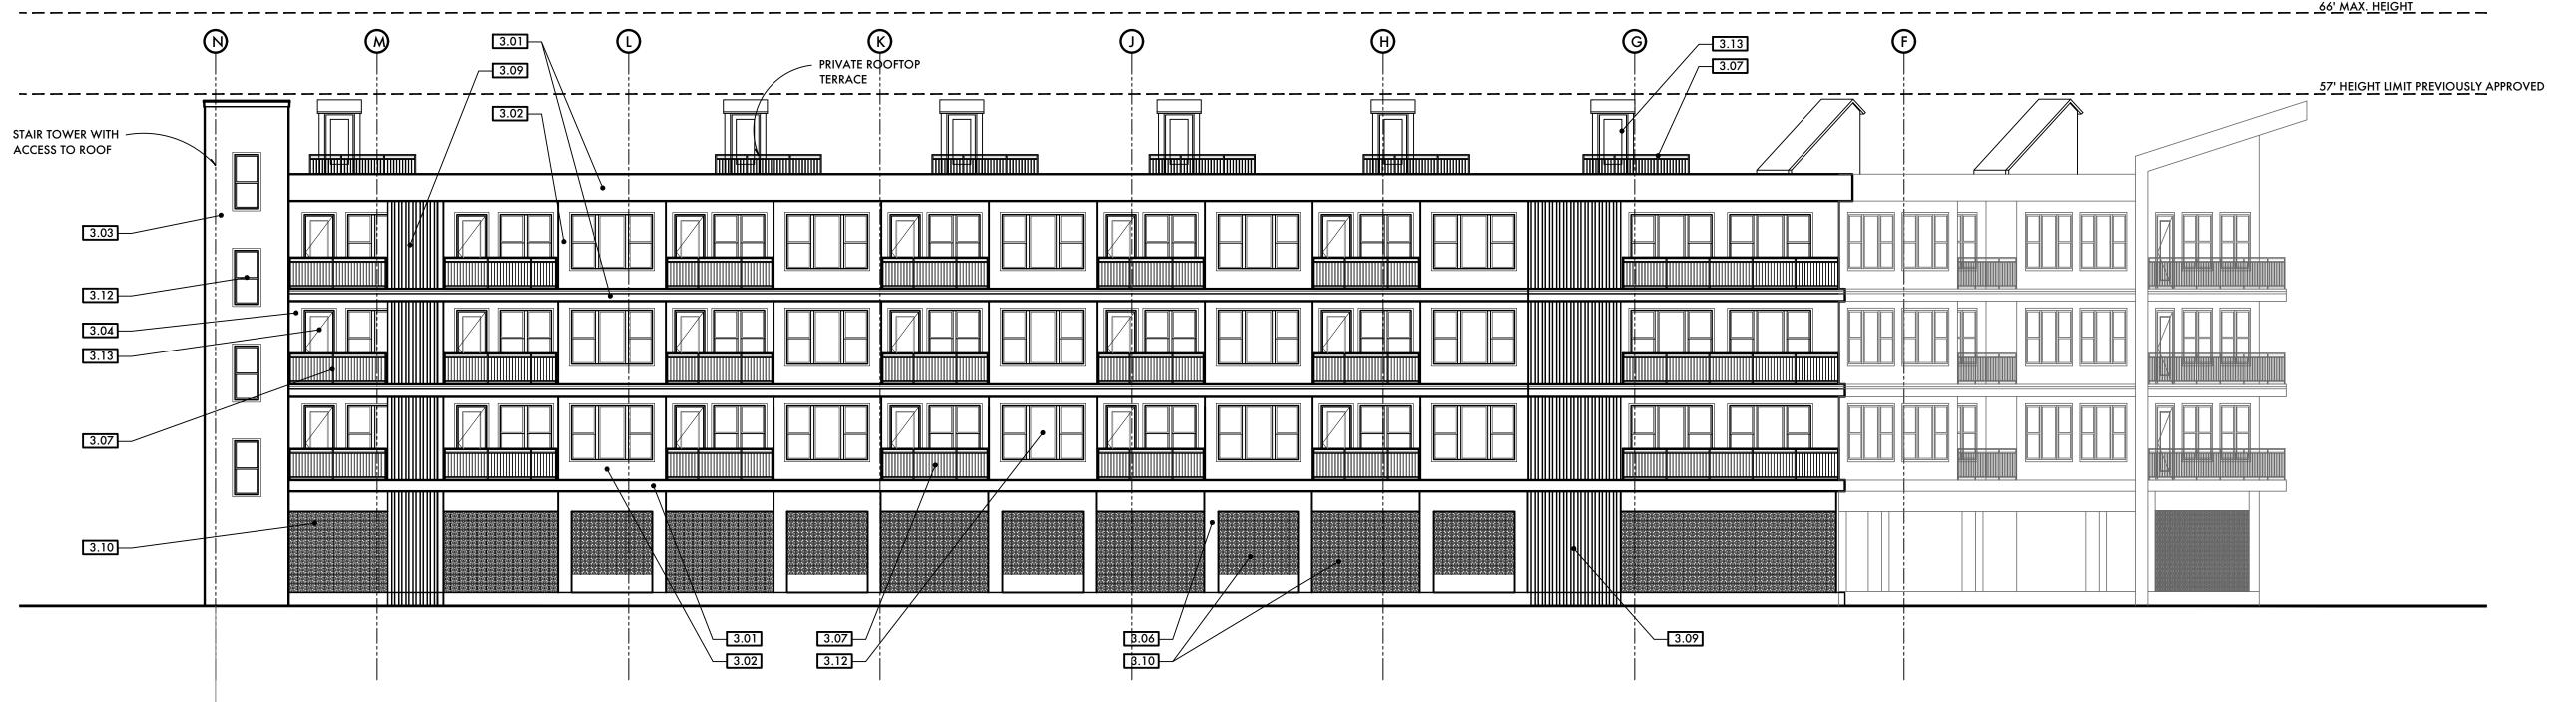

NORTHWEST ELEVATION

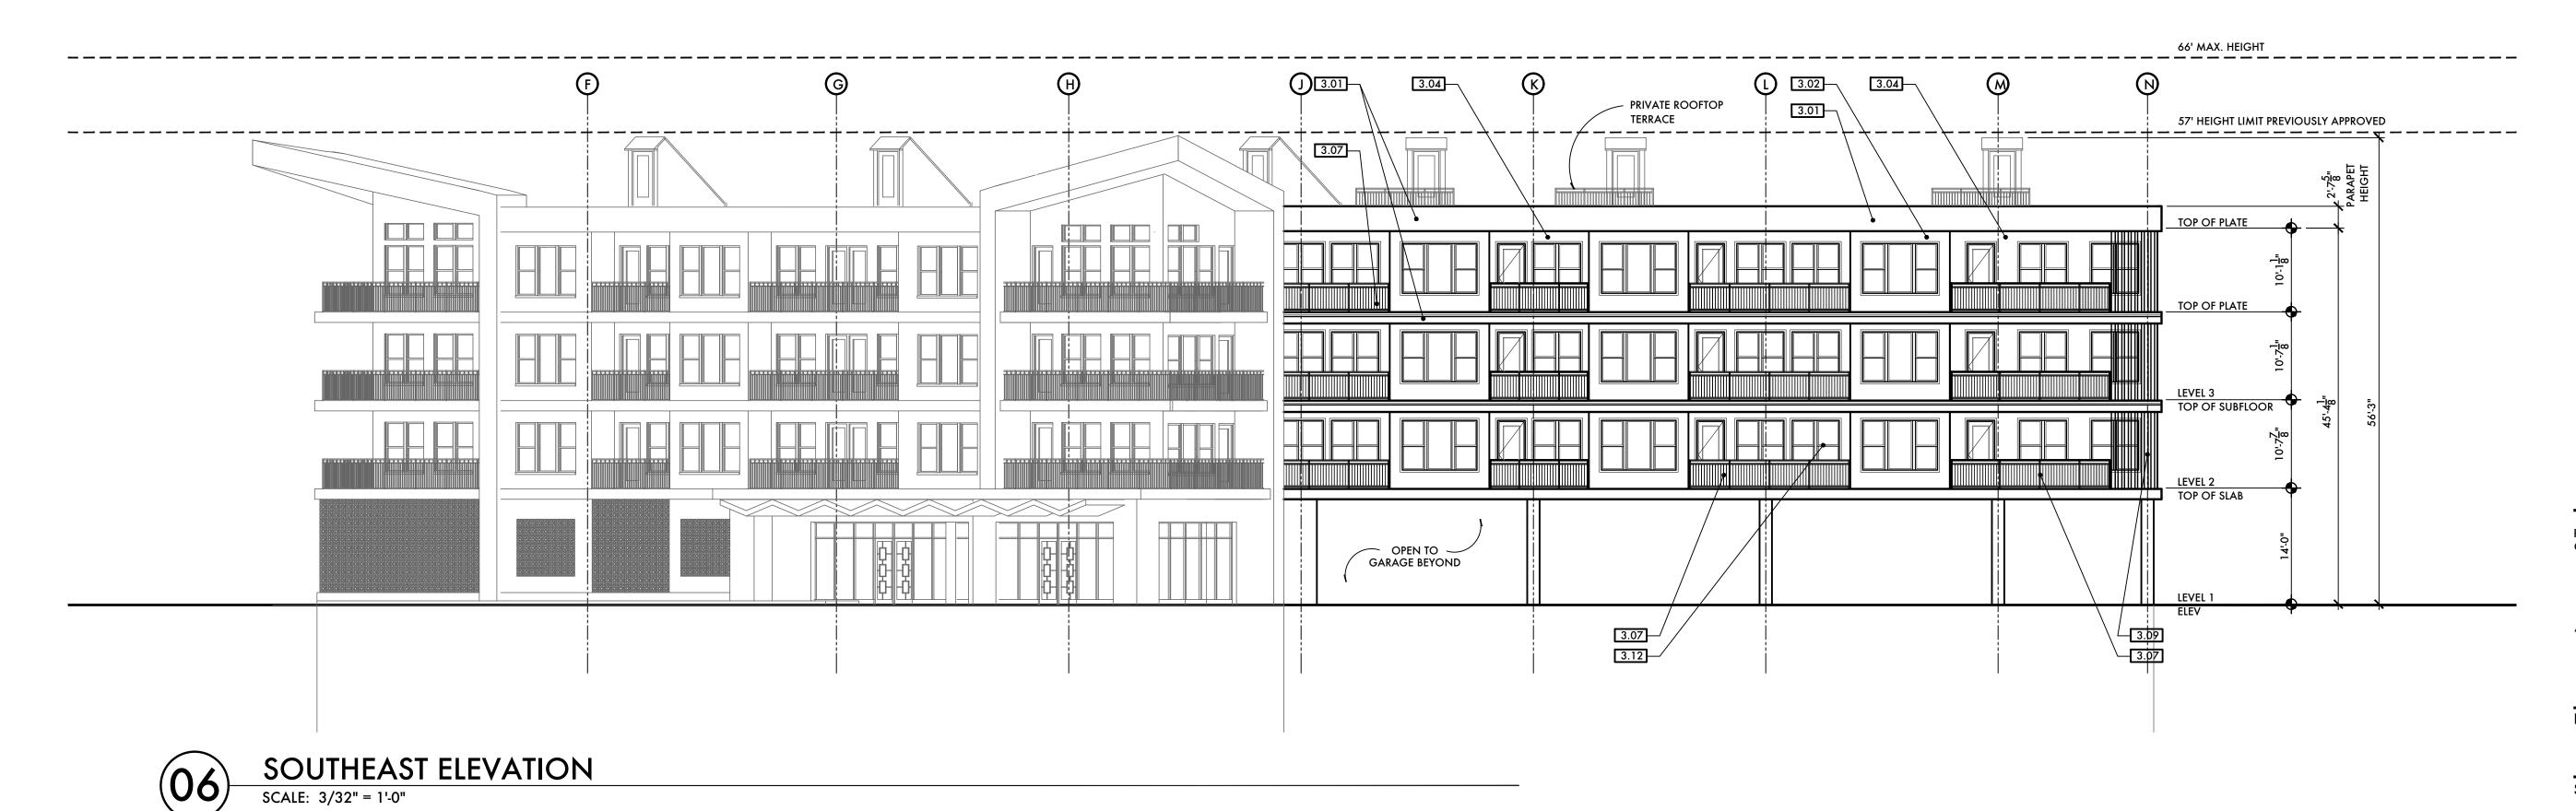

ATTACHMENT #13

WILDER ARCHITECTS 16904 CLUB HILL DR DALLAS, TX 75248 214.616.5196 WILDERARCH.COM

Project Owner:



MAGNOLIA PROPERTY CO. 2435 SOUTHLAKE BLVD. SUITE 150 SOUTHLAKE, TX 76092

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٧o.	Date	Issues
)1	21March 22	DRB Submittal

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Project Owner: Contact: Magnolia Property Company 2435 E Southlake Boulevard Southlake, TX 76092

817.769.2580

wilder@wilderarch.com


randy@mpcres.com Wilder Architects 16904 Club Hill Drive Dallas, TX 75248 214.616.5196

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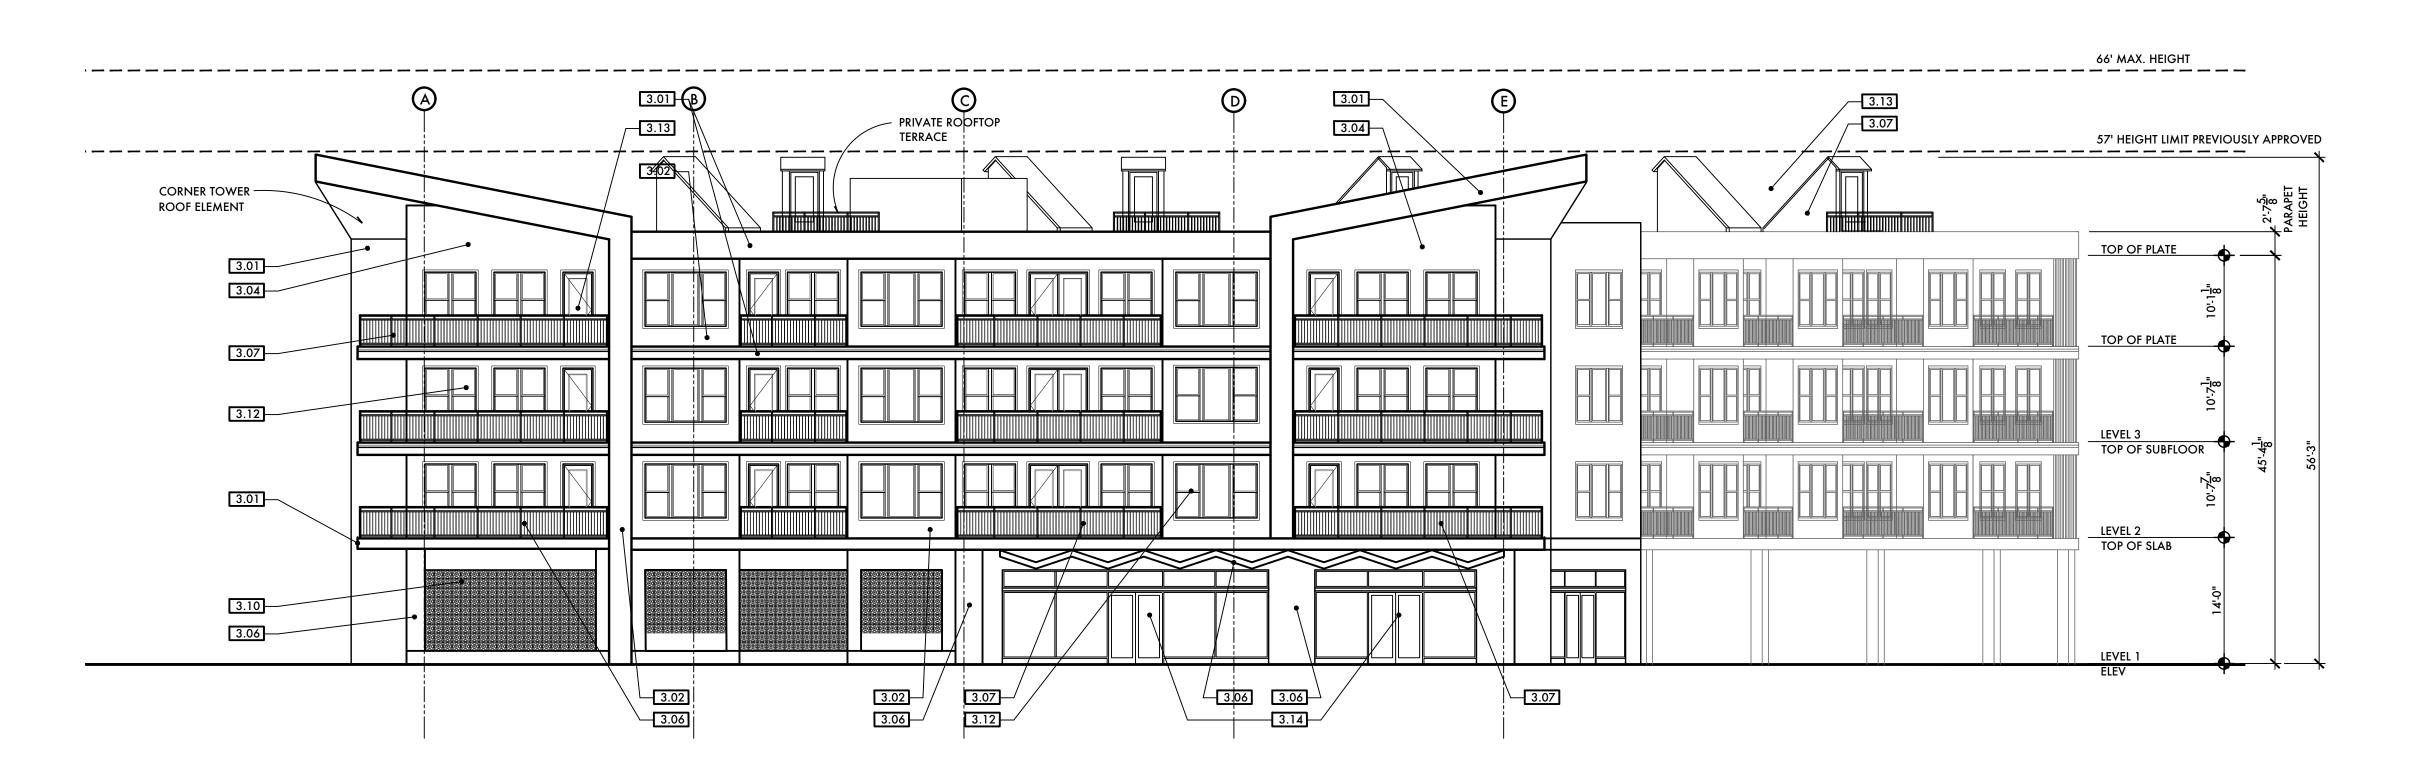
EXTERIOR ELEVATIONS

Sheet Number:

- 3.01 PORTLAND CEMENT PLASTER SW6252 "ICE CUBE" 3.02 PORTLAND CEMENT PLASTER - SW7029 "AGREEABLE GRAY"
- 3.03 PORTLAND CEMENT PLASTER SW7031 "MEGA GRIEGE"
- 3.04 FIBER CEMENT SIDING WOODTONE RUSTIC SERIES 3.05 FIBER CEMENT SIDING -
- 3.06 BRICK ACME 3.07 PAINTED METAL RAILING - SW
- 3.08 CEMENTITIOUS SHADE AWNING
- 3.09 PATIO PRIVACY SCREEN 3.10 BREEZE BLOCKS - IBIZA "NATURAL WHITE"
- 3.11 CMU BURNISHED FACE BLOCK
 3.12 VINYL WINDOW DOUBLE PANED INSULATED
- DARK BRONZE FRAME
- 3.13 PATIO DOOR DARK BRONZE FRAME
- 3.14 STOREFRONT DARK BRONZE FRAME

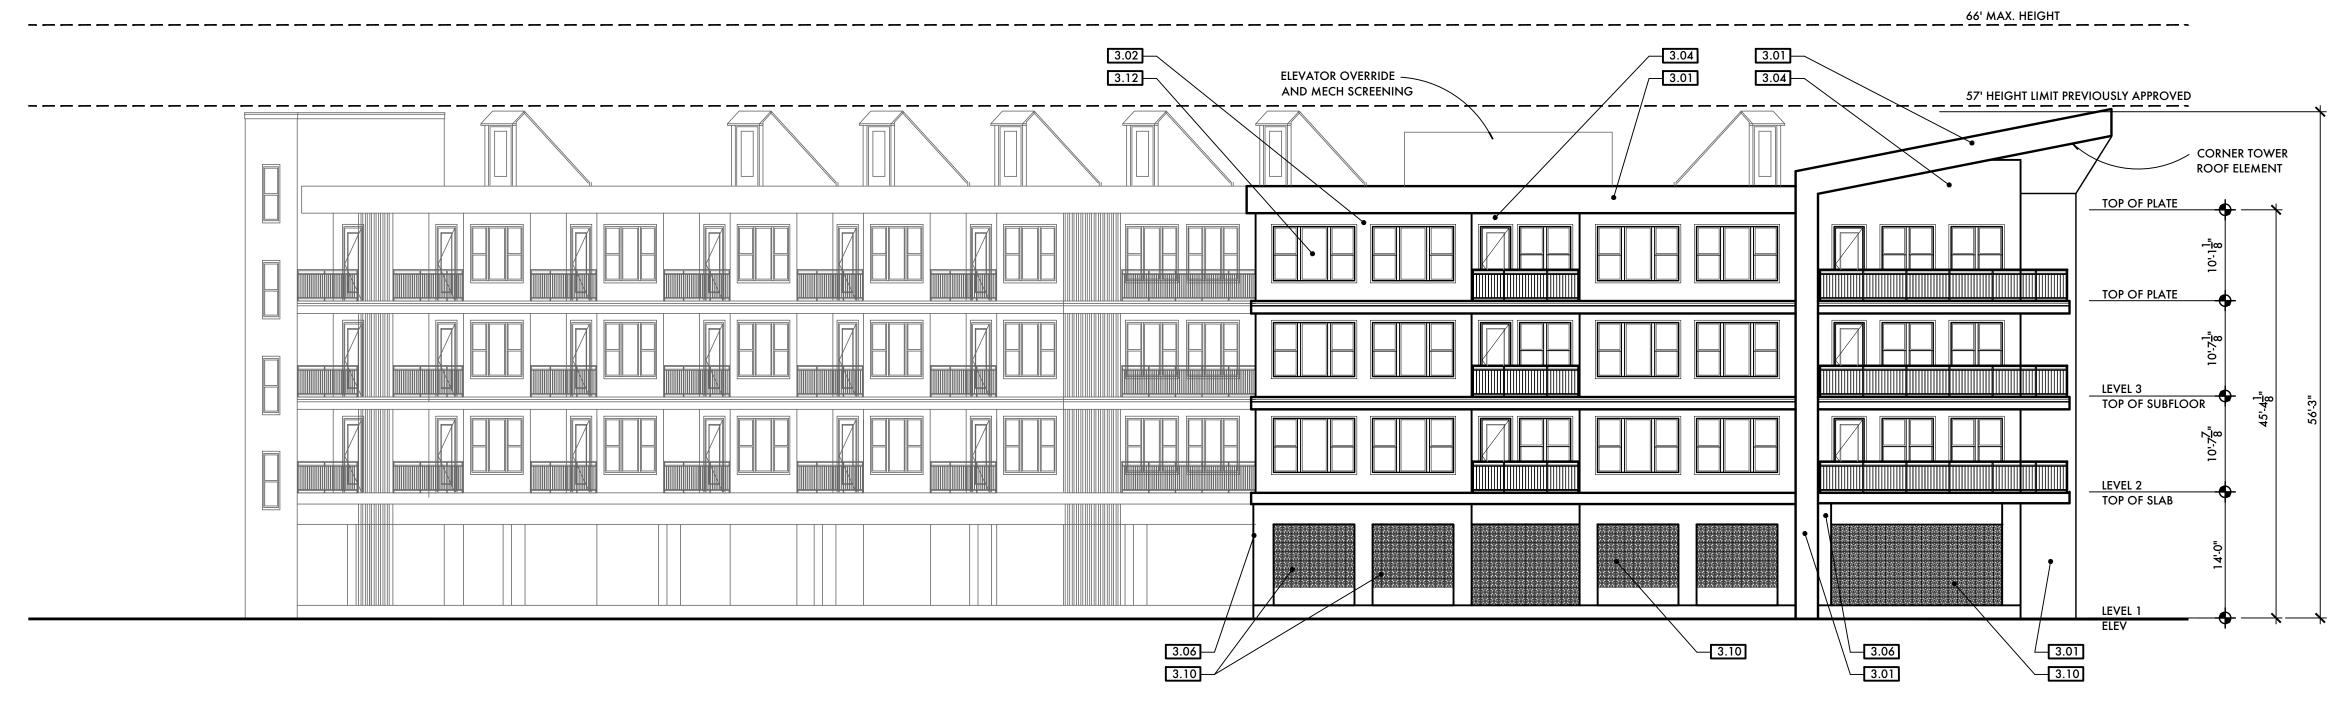

SOUTH ELEVATION





WILDER ARCHITECTS 16904 CLUB HILL DR DALLAS, TX 75248 214.616.5196 WILDERARCH.COM

Project Owner:



MAGNOLIA PROPERTY CO. 2435 SOUTHLAKE BLVD. SUITE 150 SOUTHLAKE, TX 76092

Issue	s and Revisions:	
No.	Date	Issues
01	21March 22	DRB Submittal

Project Owner:

Contact: Magnolia Property Company 2435 E Southlake Boulevard Southlake, TX 76092

> Wilder Architects 16904 Club Hill Drive Dallas, TX 75248 214.616.5196

817.769.2580 randy@mpcres.com

Drawing Name:

EXTERIOR ELEVATIONS

wilder@wilderarch.com

Sheet Number:

KEYNOTES

- 3.01 PORTLAND CEMENT PLASTER SW7021 "SIMPLE WHITE" (LRV:70) 3.02 PORTLAND CEMENT PLASTER - SW7029 "AGREEABLE GRAY"
- 3.03 PORTLAND CEMENT PLASTER SW7031 "MEGA GRIEGE"
- 3.04 FIBER CEMENT SIDING WOODTONE RUSTIC SERIES
- 3.05 FIBER CEMENT SIDING -3.06 BRICK - ACME
- 3.07 PAINTED METAL RAILING SW7020 "BLACK FOX"
- 3.08 CEMENTITIOUS SHADE AWNING 3.09 PATIO PRIVACY SCREEN
- 3.10 BREEZE BLOCKS IBIZA "NATURAL WHITE" 3.11 CMU - BURNISHED FACE BLOCK
- 3.12 VINYL WINDOW DOUBLE PANED INSULATED DARK BRONZE FRAME
- 3.13 PATIO DOOR DARK BRONZE FRAME
- 3.14 STOREFRONT DARK BRONZE FRAME
- 3.15 TILE PRIVACY SCREEN WALL



NORTHWEST ELEVATION SCALE: 3/32" = 1'-0"



SOUTHEAST ELEVATION

ATTACHMENT #14

WILDER ARCHITECTS 16904 CLUB HILL DR **DALLAS, TX 75248** 214.616.5196 WILDERARCH.COM

Project Owner:



MAGNOLIA PROPERTY CO. 2435 SOUTHLAKE BLVD. **SUITE 150** SOUTHLAKE, TX 76092

Issues and Revisions: 21 March 22 DRB Submittal 18 Nov 22 City comments 04 16 Dec 22 City comments

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randy@mpcres.com

Wilder Architects 16904 Club Hill Drive Dallas, TX 75248 214.616.5196 wilder@wilderarch.com

Drawing Name:

EXTERIOR ELEVATIONS

Sheet Number:

KEYNOTES

3.01

3.10


- 3.01 PORTLAND CEMENT PLASTER SW7021 "SIMPLE WHITE" (LRV:70) 3.02 PORTLAND CEMENT PLASTER - SW7029 "AGREEABLE GRAY"
- 3.03 PORTLAND CEMENT PLASTER SW7031 "MEGA GRIEGE"
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- 3.05 FIBER CEMENT SIDING -
- 3.06 BRICK ACME 3.07 PAINTED METAL RAILING - SW7020 "BLACK FOX"
- 3.08 CEMENTITIOUS SHADE AWNING 3.09 PATIO PRIVACY SCREEN
- 3.10 BREEZE BLOCKS IBIZA "NATURAL WHITE"
- 3.11 CMU BURNISHED FACE BLOCK
- 3.12 VINYL WINDOW DOUBLE PANED INSULATED DARK BRONZE FRAME
- 3.13 PATIO DOOR DARK BRONZE FRAME
- 3.14 STOREFRONT DARK BRONZE FRAME
- 3.15 TILE PRIVACY SCREEN WALL

66' MAX. HEIGHT 3.02 3.12 3.04 **ELEVATOR OVERRIDE** -AND MECH SCREENING 57' HEIGHT LIMIT PREVIOUSLY APPROVED CORNER TOWER **ROOF ELEMENT** TOP OF PLATE TOP OF PLATE TOP OF SUBFLOOR TOP OF SLAB LEVEL 1 3.01 3.06

SOUTH ELEVATION





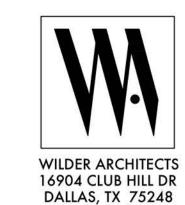

214.616.5196 WILDERARCH.COM





MAGNOLIA PROPERTY CO. 2435 SOUTHLAKE BLVD. **SUITE 150** SOUTHLAKE, TX 76092

No.	Date	Issues
01	21March 22	DRB Submittal
02	15 July 22	City comments
03	18 Nov 22	City comments
04	16 Dec 22	City comments
-		

Magnolia Property Company 2435 E Southlake Boulevard Southlake, TX 76092 817.769.2580 randy@mpcres.com

wilder@wilderarch.com

Wilder Architects 16904 Club Hill Drive Dallas, TX 75248 214.616.5196

Drawing Name:

EXTERIOR ELEVATIONS

Sheet Number:

KEYNOTES

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- 3.14 STOREFRONT DARK BRONZE FRAME



Project Owner:

MAGNOLIA PROPERTY CO. 2435 SOUTHLAKE BLVD. SUITE 150 SOUTHLAKE, TX 76092

WILDER ARCHITECTS

16904 CLUB HILL DR

DALLAS, TX 75248

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Issues and Revisions: 01 21 March 22 DRB Submittal

Wilder Architects 16904 Club Hill Drive Dallas, TX 75248 214.616.5196 wilder@wilderarch.com


Drawing Name:

STREETSCAPE ELEVATION

Sheet Number:





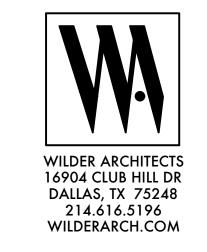



02 15 July 22 City comments	No.	Date	Issues
, ,	01	21March 22	DRB Submittal
04 16 Dec 22 City comments	02	15 July 22	City comments
	04	16 Dec 22	City comments

Project Owner:
Contact: Magnolia Property Company
2435 E Southlake Boulevard
Southlake, TX 76092
817.769.2580
randy@mpcres.com

Wilder Architects 16904 Club Hill Drive Dallas, TX 75248 214.616.5196 wilder@wilderarch.com

Drawing Name:

PERSPECTIVES

Sheet Number:

A501











No.	Date	Issues
01	21March 22	DRB Submittal
02	15 July 22	City comments
04	16 Dec 22	City comments

Magnolia Property Company 2435 E Southlake Boulevard Southlake, TX 76092 817.769.2580 randy@mpcres.com

Wilder Architects 16904 Club Hill Drive Dallas, TX 75248 214.616.5196 wilder@wilderarch.com

Drawing Name: **PERSPECTIVES**

Sheet Number:

A502











No.	Date	Issues
01	21March 22	DRB Submittal
02	15 July 22	City comments
04	16 Dec 22	City comments

Project Owner:
Contact: Magnolia Property Company
2435 E Southlake Boulevard
Southlake, TX 76092
817.769.2580
randy@mpcres.com

Wilder Architects 16904 Club Hill Drive Dallas, TX 75248 214.616.5196 wilder@wilderarch.com


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PERSPECTIVES


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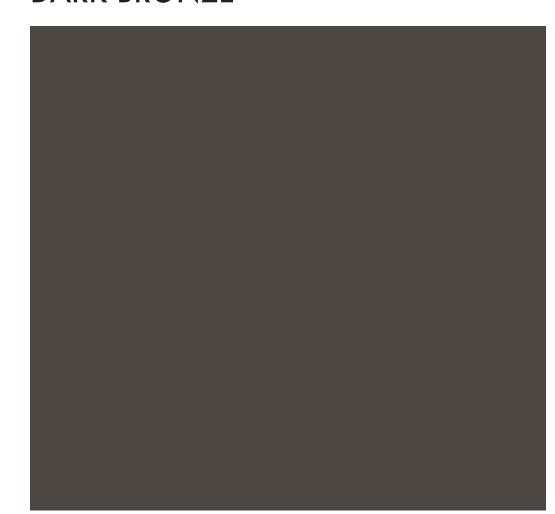
STUCCO NO. 2 SHERWIN WM - SW7029 "AGREEABLE GRAY"




STUCCO NO. 3 SHERWIN WM - SW7031 "MEGA GREIGE"

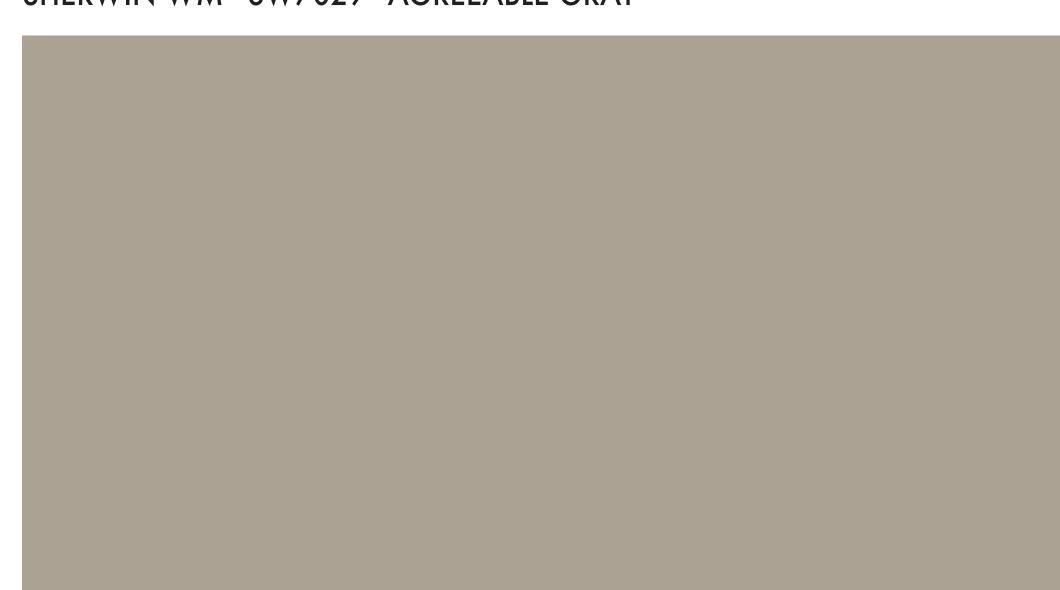

STOREFRONT / WINDOW FRAMES DARK BRONZE

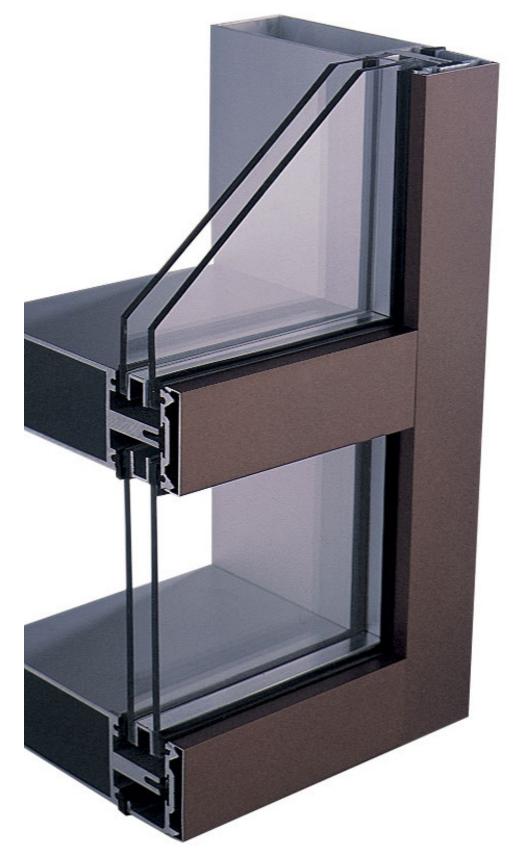

GUARDRAILS SHERWIN WM - SW7020 "BLACK FOX"

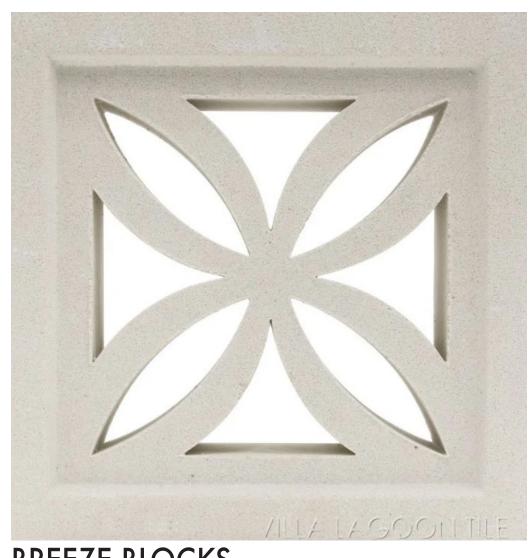


BREEZE BLOCKS
IBIZA - NATURAL WHITE




VIEW FROM INDIAN SCHOOL ROAD




SIDING WOODTONE RUSTIC SERIES

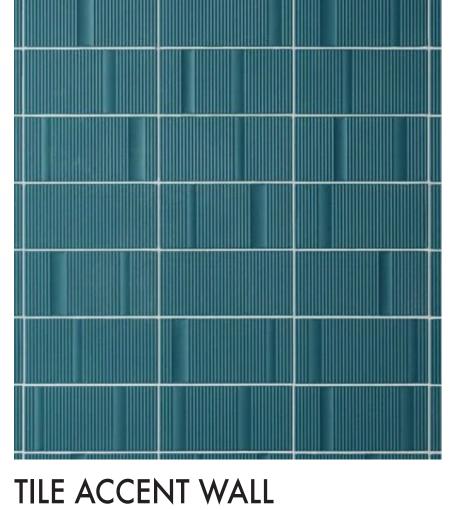

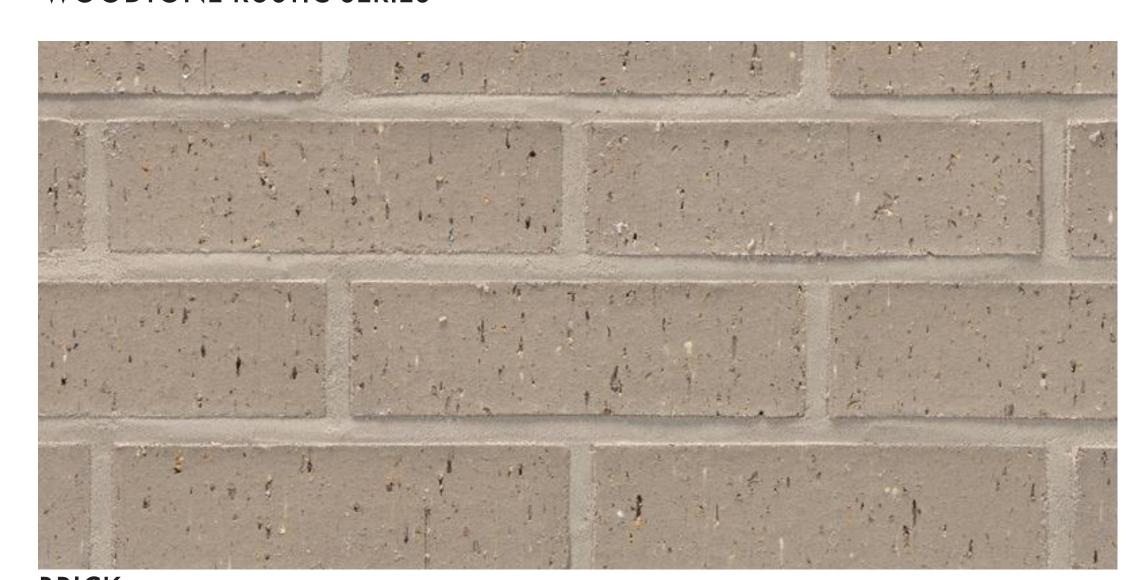

BRICK ACME

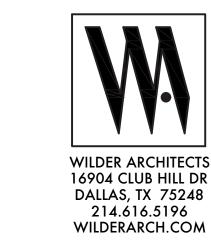



No.	Date	Issues
01	21March 22	DRB Submittal
02	15 July 22	City comments
04	16 Dec 22	City comments
•		

Issues and Revisions:

Wilder Architects 16904 Club Hill Drive Dallas, TX 75248 214.616.5196 wilder@wilderarch.com

Drawing Name:
EXTERIOR MATERIAL PALETTE

Sheet Number:

A401

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Statistics					
Description	Avg	Max	Min	Max/Min	Avg/Min
Exterior Parking	2.7 fc	7.0 fc	0.6 fc	11.7:1	4.5:1
Interior Parking Garage	4.4 fc	9.2 fc	1.0 fc	9.2:1	4.4:1
Site	1.5 fc	6.7 fc	0.0 fc	N/A	N/A
Vertical	0.9 fc	16.2 fc	0.0 fc	N/A	N/A

2.5 fc 6.7 fc 0.3 fc 22.3:1 8.3:1

24L3000K700mA







Project Owner



MAGNOLIA PROPERTY CO 2435 SOUTHLAKE BLVD SUITE 150 SOUTHLAKE, TX 76092

No.	Date	Issues
1	03/21/2022	DRB Submission

Issues and Revisions:

MAGNOLIA WATE at OLD TOWN SCOTTSDALE, ARIZONA

Contact: Magnolia Property Company 2435 E Southlake Boulevard Southlake, TX 76092 817.769.2580

randy@mpcres.com

16904 Club Hill Drive Dallas, TX 75248 214.616.5196

wilder@wilderarch.com Drawing Name:

SITE PHOTOMETRICS

Sheet Number:

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PH101

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LED SEAMLESS VAPOR PROOF FIXTURE

Premium Series

▶ **DESIGN & OPTIONS** - LED SEAMLESS VAPOR PROOF LIGHT has a waterproof polycarbonate body with a frosted lens, making this fixture impact resistant and able to maintain its luster over time. Multiple fixtures can be linked with vapor-tight strain relief connectors. The fixture is equipped with a 0-10V dimmable driver and comes with a 120-277V, 4000K or 5000K color temperature, and in two sizes: 4ft and 8ft.


INSTALLATION - Two side entry points on the fixture make it easy to connect multiple fixtures to one switch. It can be surface or pendant mounted. Refer to install instructions for detailed steps.

▶ APPLICATION - These LED SEAMLESS VAPOR PROOF LIGHTS are the perfect choice for wet and dusty locations. Common applications include: parking garages, carports, cold freezers, stainwells, tunnels, car washes, patios, barns, canopies and locker rooms. This fixture is Wet location rated with IP66 ingress protection rating. It can be operated in temperatures between -4+104°F (-20+40°C), allowing it to be utilized in a wide variety of applications and climates.

▶ ENERGY SAVINGS & EFFICIENCY - This fixture provides a lumen output equal to or higher than fluorescent fixtures and can cut your electric bill by up to 80% instantly. With a lifespan of 54,000 hours, these fixtures are made to last decades under normal operation! This fixture will save you a significant amount of money in its lifetime.

CERTIFICATION & WARRANTY - Buy with confidence: ASD provides a 5-year warranty along with UL and DLC Premium certifications to guarantee top quality products and safety!

Top US certifications allow participation in rebates; please check the rebate programs available in your state.

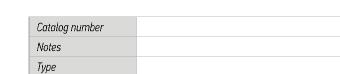



PRODUCT LEGEND:

NODOCI CCCCIND.							
Family	Modification	Lens	Size	Dimmable	Watts	CCT	Series
ASD-LVP	2S	М	Х	Χ	XX	XX	XXX
LED Seamless Vapor Proof fixture		Trans.ucent white lens	4 = 4 ft	D = Dimmable	31 = 31 W	40 = 4,000 K	PRM = Premium
			8 = 8 ft		40 = 60 W	50 = 5 000 K	

LED SEAMLESS VAPOR PROOF FIXTURE:

Model	Туре	Watts	Voltage	Dimmable	CCT	Lumens	Dimensions (LxWxH)
ASD-LVP2SM-4D3140PRM	4 ft	31 W	120-277 V	0-10 V	4,000 K	3,968 lm	48" x 3 1/2' x 3 1/8"
ASD-LVP2SM-4D3150PRM	4 ft	31 W	120-277 V	0-10 V	5,000 K	3,999 lm	48" x 3 1/2' x 3 1/8"
ASD-LVP2SM-8D6040PRM	8 ft	60 W	120-277 V	0-10 V	4,000 K	7,980 lm	94 1/2' x 3 1/2" x 3 1/8"
ASD-LVP2SM-8D6050PRM	8 ft	60 W	120-277 V	0-10 V	5,000 K	8,040 lm	94 1/2' x 3 1/2" x 3 1/8"

ORDERING INFORMATION:

Model	UPC	Pcs. per Carton	Carton Size	Carton Weight	GTIN 14
ASD-LVP2SM-4D3140PRM	857622006497	9	51' x 12' x 11'	49 lb	10857622006494
ASD-LVP2SM-4D3150PRM	857622006503	9	51' x 12' x 11'	49 lb	10857622006500
ASD-LVP2SM-8D6040PRM	857622006527	4	98" x 8.3" x 7.5"	34.9 lb	10857622006524
ASD-LVP2SM-8D6050PRM	857622006534	4	98" x 8.3" x 7.5"	34.9 lb	10857622006531

For most up-to-date spec sheets please refer to asd-lighting.com

ASD LIGHTING CORP E-mail: orders@asd-lighting.com | Web site: www.asd-lighting.com

Specifications

6-3/8"

Ordering Information

Luminaire

















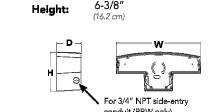

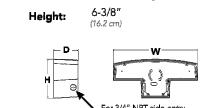

conduit (BBW only)

nighttime use and up to 74% in energy savings over comparable 250W metal halide luminaires, the D-Series Wall is a reliable, low-maintenance lighting solution that produces sites that are

exceptionally illuminated. **EXAMPLE:** DSXW1 LED 20C 1000 40K T3M MVOLT DDBTXD

The D-Series Wall luminaire is a stylish, fully

integrated LED solution for building-mount applications. It features a sleek, modern design and is carefully engineered to provide long-lasting,

energy-efficient lighting with a variety of optical and control options for customized performance.

With an expected service life of over 20 years of

DSXW1 LED							
Series	LEDs	Drive Current	Color temperature	Distribution	Voltage	Mounting	Control Options
DSXW1 LED	10C 10 LEDs (ane engine) 20C 20 LEDs (two engines) 1	350 350 mA 530 530 mA 700 700 mA 1000 1800 mA (1 A) ¹	30K 3000 K 40K 4000 K 50K 5000 K AMBPC Amber phosphor converted	T2S Type II Short T2M Type II Medium T3S Type III Short T3M Type III Medium T4M Type IV Medium TFTM Forward Throw Medium	MVOLT ² 120 ³ 208 ³ 240 ³ 277 ³ 347 ^{3,4} 480 ^{3,4}	Shipped included (blank) Surface mounting bracket BBW Surface- mounted back box (for condult entry) 5	PE Photoelectric cell, button type 5 DMG 0-10v dimming wires pulled outside fixture (for use with an external control, ordered separately) PIR 180° motion/ambient light sensor, 15-30′ mtg ht 12 PIR1FC3V Motion/ambient sensor, 8-15′ mounting height, ambient sensor enabled at 1fc 12 PIRH1FC3V Motion/ambient sensor, 15-30′ mounting height, ambient sensor enabled at 1fc 12 E20WC Emergency battery backup (includes external component enclosure), CA Title 20 compliant 3/5

Other Options				Finish (reg	Finish (regulted)						
Shipp SF DF HS SPD	ed installed Single fuse (120, 277 or 347V) 3.10 Double fuse (208, 240 or 480V) 3.10 House-side shield 11 Separate surge protection 12	Shipp BSW VG DDL	ed separately ¹¹ Bird-deterrent spikes Vandal guard Diffused drop lens	DDBXD DBLXD DNAXD DWHXD	Dark bronze Black Natural aluminum White	DSSXD DDBTXD DBLBXD DNATXD	Sandstone Textured dark bronze Textured black Textured natural aluminum	DWHGXD DSSTXD	Textured white Textured sandstone		

DSXWBSW U Bird-deterrent spikes

1 20C 1000 is not available with PIR, PIRH, PIR1FC3V or PIRH1FC3V.

MVOLT driver operates on any line voltage from 120-277V (50/60 Hz).

3 Single fuse (SF) requires 120, 277 or 347 voltage option. Double fuse (DF) requires 208, 240 or 480 voltage option. Only available with 20C, 700mA or 1000mA. Not available with PIR or PIRH.

 Back box ships installed on fixture. Cannot be field installed. Cannot be ordered as an accessory.
 Photocontrol (PE) requires 120, 208, 240, 277 or 347 voltage option. Not available with motion/ambient light sensors (PIR or PIRH). Same as old ELCW. Cold weather (-20C) rated. Not compatible with conduit entry applications. Not available with BBW mounting option. Not available with fusing. Not available with 347 or 480 voltage options. Emergency components located in back box housing. Emergency mode IES files located on product page at www.lithonia.com

Not available with SPD. 11 Also available as a separate accessory; see Accessories information.12 Not available with E20WC.

LITHONIA LIGHTING COMMERCIAL OUTDOOR

One Lithonia Way • Conyers, Georgia 30012 • Phone: 1-800-705-SERV (7378) • www.lithonia.com © 2013-2022 Acuity Brands Lighting, Inc. All rights reserved.

DSXW1-LED

ORDER NUMBER - STANDARD DESIGN

For addityional designs: please call our office 720-370-0400

Picture	Туре	#LEDs	Petal Group 1	Petal Group
	SM	24	S 3	xx
	SM	12	S 3	S0
4	SH	12	S 3	xx
	MX	36	L6	S3
	MX	24	L6	S0
	MX	24	L3	S3
	MX	12	L0	S3

Picture	Туре	#LEDs	Petal Group 1	Petal Group 2
•	LG	48	L6	xx
	LG	36	L6	L3
	LG	24	L6	LO
	LG	24	L3	xx
	LG	12	L3	LO
	LG	24	L6	xx
	LG	12	L3	xx

Fixture	Mounting	ССТ	Input Voltage	Drive Current	Туре	# LED	Petal Group 1	Petal Group 2	Тор	Color Bottom	Mount
MAR											
	TP- (Top Mount)	3 - (3500K)	1 - (120-277)	17- (175mA)	Lg - (Mega)	12	S0	S0	BLK - (Black)	BLK - (Black)	BLK - (Black)
	SUS - (Suspend)	4 - (4500K)	3 - (347-480)	35 - (350mA)	Sm - (Mini)	24	S 3	S 3	BRZ - (Bronze)	BRZ - (Bronze)	BRZ - (Bronze)
	W - (Wall)			50 - (500mA)	Mx - (Mini)	36	LO	LO	SLV - (Silver)	SLV - (Silver)	SLV - (Silver)
		•		70 - (700mA)	Lh - (1/2 Mega)	48	L3	L3	WHT - (White)	WHT - (White)	WHT - (White)
					Sh- (1/2 Mini)		L6	L6	RAL#	RAL#	RAL#
					'			XX		,	

Picture	Туре	#LEDs	Petal Group 1	Petal Group 2
	LG	48	L6	XX
	LG	36	L6	L3
	LG	24	L6	LO
	LG	24	L3	XX
	LG	12	L3	LO
	LG	24	L6	XX
	LG	12	L3	xx

e)) e)	Wall-mounted or against a pole	Margo MINI 1P 3 LED	Margo MINI 4P 180° 12 LED	Margo MINI 4P 180° 12 LED	Margo MEGA 1P 6 LED	Margo MEGA 4P 180° 12 LED	Margo MEGA 4P 180° 24 LED
	Weight (lbs)	2.2	13.2	22.0	6.6	19.8	30.9
	EPA (ft²)	0.215	0	323		0.646	

Custom applications are available - please request order sheet.

www.ragni-lighting.com



LIGHTING SCHEDULE									
			L	.AMP		FIXTURE			
TYPE	DESCRIPTION	VOLTAGE	NO.	TYPE	MOUNTING	MANUFACTURER/ CAT. #			
GA	LINEAR LED GARAGE LIGHT	120V	1	31W	SURFACE	ASD LIGHTING			
				LED		ASD-LVP2SM-4D314PRM			
S1	WALL MOUNTED LED SITE LIGHT	120V	1	19W	POLE	RAGNI LIGHTING			
	180 DEG CONFIGURATION			LED	12' AGF	MAR-TP-30K-1-50-LG-12-L3-XX			
S2	WALL MOUNTED LED SITE LIGHT	120V	1	26W	SURFACE	RAGNI LIGHTING			
	180 DEG CONFIGURATION			LED	14'AFG	MAR-W-30K-1-70-LG-12-L3-XX			
S3	POLE MOUNTED LED SITE LIGHT	120V	1	53W	POLE	RAGNI LIGHTING			
	360 DEG CONFIGURATION			LED	12' AGF	MAR-TP-30K-1-70-LG-24-L3-XX			
S4	LED WALL PACK	120V	1	73W	SURFACE	LITHONIA			
				LED	14'AFG	DSX1-20C-1000-30K-T4M-MVOLT			

1.)	ALL REQUESTS FOR SUBSITUTIONS/ALTERNATES MUST BE SUBMITTED TO ENGINEER 7 DAYS PRIOR TO BID FOR APPROVAL.
	ALL SUBMISSION SHALL INCLUDE DETAILED CUT SHEETS AND PERFORMANCE DATA FOR CONSIDERATION.
• •	CONTRACTOR MUCT CURMIT LAMBO AND RALLACTIVITY ENGINE CURMITTAL C

2.) CONTRACTOR MUST SUBMIT LAMPS AND BALLAST WITH FIXTURE SUBMITTALS.

GENERAL NOTES

3.) COORDINATE ALL FINISH SELECTIONS WITH ARCHITECT. 4.) CONTRACTOR TO PROVIDE BATTERY PACKS OR CENTRAL INVERTERS FOR ALL EMERGENCY FIXTURES.





Margo is a luminaire which fits all kinds of lighting projects thanks to its high level of modularity.

TECHNICAL CHARACTERISTICS

Top mounted	Margo MINI 4P 180° 12 LED	Margo MINI 4P 360° 12 LED	Margo MINI 8P 360° 24 LED	Margo MEGA 4P 180° 24 LED	Margo MEGA 4P 360° 24 LED	Margo MEGA 8P 360° 24 LED	Margo MEGA 8P 360° 48 LED	Margo MIX 5P 225° 24 LED	Margo MIX 8P 360° 36 LED
Weight (lbs)	13.2	13.2	22.0	19.8	19.8	24.3	30.9	22.0	26.5
EPA (ft²)		0.323 0.646							

Suspended	4	2	•	486	30				200
	Margo MINI 4P 180° 12 LED	Margo MINI 4P 360° 12 LED	Margo MINI 8P 360° 24 LED	Margo MEGA 4P 180° 24 LED	Margo MEGA 4P 360° 24 LED	Margo MEGA 8P 360° 24 LED	Margo MEGA 8P 360° 48 LED	Margo MIX 5P 225° 24 LED	Margo MIX 8P 360° 36 LED
Weight (lbs)	13.2	13.2	22.0	19.8	19.8	24.3	30.9	22.0	26.5
EPA (ft ²)		0.323				0.0	646		

WILDER ARCHITECTS 16904 CLUB HILL DR

DALLAS, TX 75248

214.616.5196

WILDERARCH.COM

MAGNOLIA PROPERTY CO.

2435 SOUTHLAKE BLVD.

SUITE 150

SOUTHLAKE, TX 76092

03/21/2022 DRB Submission

Project Owner

Issues and Revisions:

No. Date Issues

Project Owner Contact: Magnolia Property Company 2435 E Southlake Boulevard Southlake, TX 76092 817.769.2580 randy@mpcres.com

Architect: Wilder Architects 16904 Club Hill Drive Dallas, TX 75248 214.616.5196

wilder@wilderarch.com Drawing Name:

Sheet Number:

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LIGHT FIXTURE DETAILS

PH102

ATTACHMENT #18

From: Ruenger, Jeffrey
To: Bloemberg, Greg

Subject: RE: CASE 10-DR-2022 Magnolia Waterside @ Old Town

Date: Tuesday, December 27, 2022 9:12:24 AM

jckn1746@gmail.com

From: NoReply <NoReply@Scottsdaleaz.gov> Sent: Sunday, December 25, 2022 4:00 PM

To: Projectinput < Projectinput@Scottsdaleaz.gov>

Subject: CASE 10-DR-2022 Magnolia Waterside @ Old Town

City of Scottsdale

The answer is "no". four story height blocks views, don't need more new residential units that most people probably wouldn't be able to afford and where is the water source? -- sent by Carolyn Kinville (case# 10-DR-2022)