DEVELOPMENT REVIEW BOARD



Meeting Date: July 15, 2021

General Plan Element: Character and Design

General Plan Goal: Foster quality design that enhances Scottsdale as a unique

southwestern desert community.

ACTION

Toy Barn Scottsdale 9-DR-2021

Request approval of the site plan, landscape plan, and building elevations for a new vehicle storage facility, comprised of three buildings, with approximately 81,262 square feet of building area, all on a 3.86-acre site. Additionally, the request includes approval of architecturally integrated external downspouts.

SUMMARY

Staff Recommendation

Approve, subject to the attached stipulations (Attachment #6)

Key Issues

• External downspouts that are architecturally integrated.

Items for Consideration

- Conformance with Development Review Board Criteria staff confirms
- Integration of Sensitive Design Principles staff confirms
- No community input received as of the date of this report

BACKGROUND


Location: 7301 E Helm Drive and 7317 E. Helm Drive

Zoning: Industrial Office (I-1)

Adjacent Uses

North: Existing one-story industrial offices, constructed in 1980 East: Existing light industrial land that is partially developed.

South: Existing one industrial offices, constructed in mid-late 1970's. West: Existing one industrial offices, constructed in mid-late 1970's.

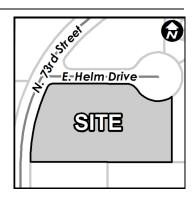

Property Owner

Windrose Square, LLC Flights Aware, LLC

Applicant

George Pasquel III, Withey Morris, PLC (602) 230-0600

Architect/Designer

Tim Thielke, DLR Group 602-381-8580

Engineer

Matthew Mancini, 3 Engineering 602-334-4387

DEVELOPMENT PROPOSAL

The applicant is requesting approval of the site plan, landscape plan and building elevations for a new vehicle storage facility, comprised of three one-story buildings, with a clubhouse, and a total building area of approximately 81,255 square feet, all on a 3.86-acre site. Additionally, the request includes approval of architecturally integrated downspouts.

Development Review Board Criteria

Staff confirms that the development proposal generally meets the applicable Development Review Board Criteria. For a detailed analysis of the Criteria, please see Attachment #4.

Sustainability

The City of Scottsdale promotes the goal of sustainability through the incorporation of appropriate design considerations in the development of the built environment. This development proposal incorporates several design elements that align with the City's goal of sustainability including recessed windows and use of low water use plant species.

STAFF RECOMMENDED ACTION

Staff recommends that the Development Review Board approve the Toy Barn Scottsdale development proposal per the attached stipulations, finding that the Character and Design Element of the General Plan and the Greater Airpark Character Area and Development Review Board Criteria have been met.

RESPONSIBLE DEPARTMENTS	STAFF CONTACTS
Planning and Development Services Current Planning Services	Meredith Tessier Senior Planner 480-312-4211 mtessier@ScottsdaleAZ.gov

APPROVED BY

06/29/2021

Meredith Tessier, Report Author Date

Dul C 7/4/2021

Brad Carr, AICP, LEED-AP, Planning & Development Area Manager

Development Review Board Liaison

Phone: 480-312-7713 Email: bcarr@scottsdaleaz.gov

Randy Grant, Executive Director

7/7/2021

Date

Planning, Economic Development, and Tourism

Phone: 480-312-2664 Email: rgrant@scottsdaleaz.gov

ATTACHMENTS

- Context Aerial
- 2. Close-up Aerial
- 3. Applicant's Narrative
- 4. Development Review Board Criteria Analysis
- 5. Development Information
- 6. Stipulations / Zoning Ordinance Requirements
- 7. Combined Context Aerial and Site Plan
- 8. Site Plan
- 9. Open Space Plan
- 10. Landscape Plan
- 11. Building Elevations (black & white)
- 12. Building Elevations (color)
- 13. Perspectives
- 14. Materials and Colors Board
- 15. Electrical Site Plan
- 16. Exterior Photometrics Plan
- 17. Exterior Lighting Cutsheets
- 18. Zoning Map
- 19. Citizen Involvement
- 20. City Notification Map

Date





<u>ToyBarn Scottsdale – Design Review Narrative</u> June 16, 2021

PROJECT OVERVIEW:

The ToyBarn Scottsdale project consists of three buildings on a +/-3.82 acre site located at the southeast corner of 73rd Street and Helm Drive that is currently vacant. The parcel to the south contains single story industrial building. The parcel to the east is a vacant site with runway access to the Airpark. The parcel north across Helm Drive is a single-story office building. The sites to the west across 73rd Street are single and multi-story office buildings. The site is currently zoned I-1 (Industrial Park) and allows for the proposed use as a storage facility under the existing zoning and is compatible with the adjacent uses. Development within the area consists mainly of professional office buildings as well as industrial uses, warehousing, repair facilities, other professional services, and retail uses.

The proposed development of the property would include three single-story buildings totaling +/-81,000 s.f. for private storage condos as well as a clubhouse amenity. The site will be secured internally beyond the clubhouse and all access points will be controlled with gates. A main access point to the site will be provided for at the northeast corner of the site from Helm Drive. A secondary emergency access point has also been provided at the southwest corner of the site from 73rd Avenue. Retention for the site will utilize a combination of above grad and underground retention. New landscape will be provided along all street frontages and on site adjacent to the clubhouse and parking areas. Parking for the site will be provided for the clubhouse (approximately 2,400 sf) at a ratio of 1 space per 300 s.f. as well as 1 space for every 50 storage units, and will be screened from public view by site walls and landscaping.

The building design is compatible with existing developments within this area and will have a similar architectural feel. Building materials will consist of masonry block, metal accents, metal canopies, and performance glazing. The building height at the parapet will be approximately 29' in height which will also screen the rooftop mechanical equipment. Exterior downspouts within the secured/screened yard are being utilized for this project in order to keep them out of the individual units and allow for access and maintenance. The downspouts will be screened with a decorative metal panels similar to the other ToyBarn project in the Airpark. The proposed development is an improvement to the existing site and surrounding environment and is designed in accordance with existing and approved buildings and will be complimentary to the area.

DEVELOPMENT REVIEW BOARD NARRATIVE:

Ordinances, Master Plans, General Plan, and Standards

Describe how the proposed development will comply with the design and character elements of the General Plan, the appropriate character area plan, all applicable city-wide master plans, the zoning ordinance development standards, the Design Standards and Policies Manual, all applicable city-wide design guidelines, and the appropriate Master Environmental Design Concept Plan.

<u>Response:</u> The proposed project has been designed in accordance with all required guidelines mentioned above. The site is designated as Employment on the Scottsdale General Plan. Within the General Plan, the site is also designated in the Greater Airpark Character Plan which both promote planned growth and concentrated development as opposed to urban sprawl. The

Streetscape section of the General Plan also designates the site to have "Suburban Streetscape", which will be provided along both the 73rd Street and Helm Drive frontages. The site is currently zoned I-1 (Industrial Park) and the proposed use of a private storage facility is an approved use. The proposed project also addresses the DSPM and Sensitive Design Principles as discussed in the responses below.

Architectural Character, Landscaping, and Site Design

Explain how the proposed development has been designed so that it:

- Promotes a desirable relationship of structures to one another, to open spaces and topography, both on the site and in the surrounding neighborhood;
- Avoids excessive variety and monotonous repetition;
- Recognizes the unique climatic and other environmental factors of this region to respond to the Sonoran Desert environment, as specified in the Sensitive Design Principles;
- Conforms to the recommendations and guidelines in the Environmentally Sensitive Lands (ESL) Ordinance, in the ESL Overlay District; and
- Incorporates unique or characteristic architectural features, including building height, size, shape, color, texture, setback, or architectural details, in the Historic Property Overlay District.

<u>Response:</u> The proposed project has been architecturally designed to be consistent with other projects in the area and has been planned for similar uses, building heights, and landscape setbacks typical to neighboring sites. The project also takes advantage of the premium views of the McDowell Mountains and proximity to nearby retail and restaurant centers, making this concept and location highly desirable to future users.

The proposed project will create a more inviting environment than the existing vacant land and will provide updated and maintained landscaping as well as appropriate lighting to encourage safety within and around the site. The project will also bridge part of the gap between the adjacent uses that surround the property to the north, west, and south while providing desired storage space for users looking to enjoy the amenities in this area of Scottsdale.

The site will utilize desert landscape consistent its surroundings and provide similar split face and smooth face CMU site walls. The proposed project features a singel-story building similar in height, colors, and architectural massing to the existing buildings directly north and south of the proposed project. The proposed design will also relate to the other adjacent single and two-story building through the use of similar exterior building materials such as split face and smooth face CMU block, high performance glass and metal accents, consistent with the approved standards of this area.

Ingress, Egress, On-Site Circulation, Parking, and Pedestrians

Describe how the site layout of the proposed development has been designed to promote safety and convenience, relative to ingress, egress, internal traffic circulation, off-street parking facilities, loading and service areas, and pedestrian ways.

<u>Response:</u> The proposed project is within the Scottsdale Airpark with all off-site infrastructure existing. The site will be secured internally beyond the clubhouse and all access points will be

controlled with gates. A main access point to the site will be provided for at the northeast corner of the site from Helm Drive. A secondary emergency access point has also been provided at the southwest corner of the site from 73rd Avenue. The sidewalk also makes a connection to the public sidewalk located along Helm Drive for pedestrian access to and from the site.

Mechanical and Utility Equipment

Describe how the proposed development will locate mechanical equipment, appurtenances, and utilities so that these elements will not conflict with street frontage open space, pedestrian amenities, resident amenities, landscape features, or on-site circulation, and has utilized screening devices that are integral to the design of the building, in order to screen mechanical equipment, appurtenances and utilities.

<u>Response</u>: All ground level utilities will be screened from public view by site walls and landscaping. Building electrical equipment has been designed internally to the buildings. The parapet walls of the building have been integrated into the overall design of the building to fully screen the roof mounted mechanical units from view.

Old Town Scottsdale

If the development proposal is within Old Town Scottsdale, specify through narrative and graphical exhibits how the proposal is in conformance with the Old Town Scottsdale Urban Design and Architectural Guidelines.

Response: The property is not located within the Old Town Scottsdale.

Location of Artwork (refer to Zoning Ordinance Sections 1.905 and 7.1010)

If the development proposal is required to participate in the Cultural Improvement Program or Public Art Program, then determine whether or not the proposed location of artwork complies with the following criteria:

- Accessible by the public;
- Location near pedestrian circulation routes consistent with existing or future development or natural features;
- Location near the primary pedestrian or vehicular entrance of a development;
- Location in conformance with the Design Standards and Policies Manual for locations affecting existing utilities, public utility easements, and vehicular sight distance requirements; and
- Location in conformance to standards for public safety.

<u>Response:</u> The property is not required to participate in the Cultural Improvement Program or Public Art Program.

DESGIN GUIDELINES:

DSPM/Sensitive Design Program/Office Design Guidelines/Lighting Design Guidelines/Shading Guidelines:

Site Design and Architecture:

The site and building will be visually integrated within their context by utilizing form, materials and colors that harmonize with the site and adjacent developments. The building has been planned with respect to solar orientation and visibility, employing geometry sympathetic to its site and surroundings. The shared clubhouse has been positioned to take advantage of views of the McDowell Mountains to the northeast. The building entry will be recessed and defined with special architectural features such as canopies, upgraded finishes and special architectural treatments to enhance the sense of arrival to the project. Building elevations will be designed with all building elevations reflecting a similar cohesive aesthetic. The elevations may vary according to their respective exposure and orientation and reflect the buildings function. The design will be sensitive to the streetscape and adjacent developments. The current site is vacant with no vegetation, however the proposed development will restore a desert landscape feel along the public streets that reflects character of the Sonoran Desert. While the development is a private development, the clubhouse is located outside of the secured gates to provide a visual connection to the surrounding community. The clubhouse also has a covered patio directly adjacent to it with an overhead door that can provide an indoor/outdoor expansion of the amenity space. The proximity also allows owners to easily access adjacent amenities like restaurants and retail shopping of the adjoining developments. Signage and lighting for the project will be integral to the design of the project and be consistent with neighboring developments and the previous developed ToyBarn project also located in the Airpark.

Lighting Design:

The proposed project will create a more inviting environment than the existing vacant land and will provide updated and maintained landscaping as well as appropriate lighting to encourage safety within and around the site. The project will also bridge part of the gap between the offices that surround the property to the north, east, and south while providing desired Class "A" office space for users looking to move or relocate to this area of Scottsdale. Lighting on site will be provided by LED fixtures and will meet the minimum levels required by code and provide a sense of safety throughout the site. Architectural elements will be illuminated at nighttime and be consistent with the surrounding area.

Shading:

The ToyBarn Scottsdale project complies with the shading guidelines identified by the City of Scottsdale. The buildings have been positioned along the east/west axis to allow for all overhead doors for the project to be either north or south facing help limit the harsh sun exposure form the east and west. The clubhouse has been positioned and faces the northeast corner of the project to take advantage of the views of the McDowell Mountains as well as limit exposure to the morning sun and protect the glazing from the south and west. The north facing entry and glass of the clubhouse is recessed from the storage portion of the building to the west to provide shade from the western summer sun. The east glazing is recessed, opens to a covered courtyard, and has a metal louvered horizontal canopy that extends over to provide shade and reduce solar exposure from late morning sun.

DEVELOPMENT REVIEW BOARD CRITERIA ANALYSIS

Per Section 1.904. of the Zoning Ordinance, in considering any application for development, the Development Review Board shall be guided by the following criteria:

- 1. The Board shall examine the design and theme of the application for consistency with the design and character components of the applicable guidelines, development standards, Design Standards and Policies Manual, master plans, character plan and General Plan.
 - The proposed project has been designed in accordance with the required guidelines mentioned above. The site is designated as Employment on the Scottsdale General Plan. Within the General Plan, the site is also designated in the Greater Airpark Character Area Plan which both promote planned growth and concentrated development as opposed to urban sprawl. The streetscape section of the General Plan also designated this site to have "Suburban Streetscape", which will be provided along both street frontages. The site is zoned Industrial Park (I-1) and the proposed use of a private storage facility is an approved use. The proposed project also addresses the DSPM and Sensitive Design Principles as discussed in the responses bellow.
 - Staff finds that the General Plan Land Use Element designates the property as Employment, Regional Use District and within the Greater Airpark Character Area Plan (GACAP). The GACAP denotes the site as Type C development that represents medium-to-higher-scale development, which supports pedestrian activity in the Greater Airpark. The Employment-Regional Use designations provides flexibility for land uses, but are not limited to corporate office, region serving retail, and major medical. The Employment category permits a range of employment uses from light manufacturing to light industrial and office uses. This proposal is consistent with the Character and Design element of the General Plan, and the GACAP.
- 2. The architectural character, landscaping and site design of the proposed development shall:
 - a. Promote a desirable relationship of structures to one another, to open spaces and topography, both on the site and in the surrounding neighborhood;
 - b. Avoid excessive variety and monotonous repetition;
 - c. Recognize the unique climatic and other environmental factors of this region to respond to the Sonoran Desert environment, as specified in the Sensitive Design Principles;
 - d. Conform to the recommendations and guidelines in the Environmentally Sensitive Lands (ESL) Ordinance, in the ESL Overlay District; and
 - e. Incorporate unique or characteristic architectural features, including building height, size, shape, color, texture, setback or architectural details, in the Historic Property Overlay District.
 - The applicant states that the project has been designed to be consistent with other projects in the area and has been planned for similar uses, building heights, and landscape setback typical to neighboring sites. The proposed project will create a more inviting environment than the existing vacant land and will provide updated and maintained landscaping as well as appropriate lighting to encourage safety within and around the site. The proposed design will also relate to other single and two-story buildings through the use of similar exterior building materials such as split face and smooth face CMU block, high performance glass and metal accents, consistent with this area.
 - Staff finds that the proposed material, color and finishes are consistent with the Scottsdale Sensitive Design Principles. Architectural details respond to the context of adjacent land uses including similar materials and colors.

- 3. Ingress, egress, internal traffic circulation, off-street parking facilities, loading and service areas and pedestrian ways shall be designed as to promote safety and convenience.
 - The applicant states the site will be secured internally beyond the clubhouse and all access points will be controlled with gates. A main access point to the site will be provided for at the northeast corner of the site from Helm Drive and secondary emergency access point from 73rd Avenue. The sidewalk also makes a connection to the public sidewalk located along Helm Drive for pedestrian access to and from the site.
 - Staff finds that the existing sites are currently vacant and one new driveway is proposed along E. Helm Drive and the existing driveway along N. 73rd Street will be maintained. Pedestrian circulation is provided with a new 6-foot-wide sidewalk from N. 73rd Street.
- 4. If provided, mechanical equipment, appurtenances and utilities, and their associated screening shall be integral to the building design.
 - The applicant states all ground level utilities will be screened from public view by site walls and landscaping. Building electrical equipment has been design internally to the buildings. The parapet walls of the building have been integrated into the overall design of the building to fully screen the roof mounted mechanical units from view.
 - Staff finds that the mechanical equipment is integrated into the building design and rooftop units are fully screened by the parapet walls.
- 5. Within the Downtown Area, building and site design shall:
 - a. Demonstrate conformance with the Downtown Plan Urban Design & Architectural Guidelines;
 - b. Incorporate urban and architectural design that address human scale and incorporate pedestrian-oriented environment at the street level;
 - Reflect contemporary and historic interpretations of Sonoran Desert architectural traditions, by subdividing the overall massing into smaller elements, expressing small scale details, and recessing fenestrations;
 - d. Reflect the design features and materials of the urban neighborhoods in which the development is located; and
 - e. Incorporate enhanced design and aesthetics of building mass, height, materials and intensity with transitions between adjacent/abutting Type 1 and Type 2 Areas, and adjacent/abutting Type 2 Areas and existing development outside the Downtown Area.
 - This criterion is not applicable.
- 6. The location of artwork provided in accordance with the Cultural Improvement Program or Public Art Program shall address the following criteria:
 - a. Accessibility to the public;
 - b. Location near pedestrian circulation routes consistent with existing or future development or natural features;
 - c. Location near the primary pedestrian or vehicular entrance of a development;
 - d. Location in conformance with Design Standards and Policies Manual for locations affecting existing utilities, public utility easements, and vehicular sight distance requirements; and
 - e. Location in conformance to standards for public safety.
 - This criterion is not applicable.

DEVELOPMENT INFORMATION

Zoning History

The site was annexed into the City in 1962 (Ord. #165) and zoned to the Industrial Park (I-1) zoning designation. The I-1 district allows aeronautical uses, educational services, warehouses and vehicle storage facilities that are not adjacent to residential districts. Adjacent zoning is I-1, therefore vehicle storage is a permitted land use.

Community Involvement

With the submittal of the application, staff notified all property owners within 750 feet of the site and the site has been posted with the required signage. As of the publishing of this report, staff has not received any community input regarding the application.

Context

Located at the southeast corner of N. 73rd Street and E. Helm Drive and surrounded by other industrial developments.

Project Data

• Existing Use: Vacant, undeveloped industrial parcel

Proposed Use: Vehicle Storage

• Parcel Size: 204,143 square feet / 4.69 acre (gross)

168,273 square feet / 3.86 acre (net)

Building Area (Garage Storage): 78,862 square feet
 Office Space (Clubhouse): 2,400 square feet
 Total Building Area: 81,255 square feet

Floor Area Ratio Allowed: 0.8
 Floor Area Ratio Provided: 0.48

• Building Height Allowed: 52 feet (exclusive of rooftop appurtenances)

Building Height Proposed:
 28 feet 0 inches (inclusive of rooftop appurtenances)

Parking Required: 10 spacesParking Provided: 10 spaces

Open Space Required: 25,409 square feet / 0.58 acre
 Open Space Provided: 26,812 square feet / 0.61 acre

Stipulations for the Development Review Board Application: Toy Barn Scottsdale

Case Number: 9-DR-2021

These stipulations are intended to protect the public health, safety, welfare, and the City of Scottsdale.

APPLICABLE DOCUMENTS AND PLANS:

- 1. Except as required by the Scottsdale Revised Code (SRC), the Design Standards and Policies Manual (DSPM), and the other stipulations herein, the site design and construction shall substantially conform to the following documents:
 - a. Architectural elements, including dimensions, materials, form, color, and texture shall be constructed to be consistent with the building elevations prepared by DLR Group, with a city staff date of 05/12/201.
 - b. The location and configuration of all site improvements shall be consistent with the site plan prepared by 3 Engineering, with a city staff date of 05/12/2021.
 - c. Landscape improvements, including quantity, size, and location shall be installed to be consistent with the preliminary landscape plan prepared by Design Ethic, with a city staff date of 05/12/2021.
 - d. The case drainage report submitted by 3 Engineering and accepted in concept by the Stormwater Management Department of the Planning and Development Services.
 - e. The water and sewer basis of design report submitted by 3 Engineering and accepted by the Water Resources Department.

RELEVANT CASES:

Ordinance

A. At the time of review, the applicable Zoning case for the subject site was 47-ZN-1964.

ARCHAEOLOGICAL RESOURCES:

Ordinance

B. Any development on the property is subject to the requirements of Scottsdale Revised Code, Chapter 46, Article VI, Section 46-134 - Discoveries of archaeological resources during construction.

ARCHITECTURAL DESIGN:

DRB Stipulations

2. All exterior window glazing shall be recessed a minimum of fifty (50) percent of the wall depth, including glass windows within any tower/clerestory elements. The amount or recess shall be measured from the face of the exterior wall to the face of the glazing, exclusive of external detailing. With the final plan submittal, the developer shall provide head, jamb and sill details clearly showing the amount of recess for all window types.

3. All exterior doors shall be recessed a minimum of thirty (30) percent of the wall depth, the amount of recess shall be measured from the face of the exterior wall to the face of the glazing, exclusive of external detailing. With the final plan submittal, the developer shall provide head, jamb and sill details clearly showing the amount of recess for all door types.

SITE DESIGN:

DRB Stipulations

4. All drive aisles that are fire lanes shall have a width of twenty-four (24) feet.

LANDSCAPE DESIGN:

Ordinance

C. The property owner shall obtain approval of a Salvage/Native Plant Plan Application and obtain a permit to remove any tree.

DRB Stipulations

5. Prior to the issuance of any building permit for the development project, the property owner shall submit landscape improvement plans that demonstrate how the salvaged vegetation from the site will be incorporated into the design of the landscape improvements.

EXTRIOR LIGHTING:

Ordinance

- D. Any exterior luminaire with a total initial lumen output of greater than 1600 lumens shall have an integral lighting shield.
- E. Any exterior luminaire with a total initial lumen output of greater than 3050 lumens shall be directed downward and comply with the Illuminating Engineering Society of North America (IES) requirements for full cutoff.

DRB Stipulations

- 6. All exterior lighting shall have a Kelvin temperature of 3000 or less.
- 7. All exterior luminaires shall meet all IES requirements for full cutoff and shall be aimed downward and away from property line except for sign and landscape lighting.
- 8. No fixture shall be mounted higher than twenty (20) feet.
- 9. All fixtures and associated hardware, including poles, shall be flat black or dark bronze.
- 10. Incorporate the following parking lot and site lighting into the project's design:
 - a. The maintained average horizontal luminance level, at grade on the site, shall not exceed 2.0 foot-candles. All exterior luminaires shall be included in this calculation
 - b. The maintained maximum horizontal luminance level, at grade on the site, shall not exceed 8.0 foot-candles. All exterior luminaires shall be included in this calculation
 - c. The initial vertical luminance at 6-foot above grade, along the entire property line shall not exceed 0.8 foot-candles. All exterior luminaires shall be included in this calculation.
 - d. The total lumen per luminaire shall not exceed 24,000 lumens.

AIRPORT:

DRB Stipulations

- 11. With the construction document submittal, the property owner shall submit an FAA FORM 7460-1 to the FAA for any proposed structures, appurtenances and/or individual construction cranes that penetrate the 100:1 slope. The elevation of the highest point of those structures, including the appurtenances, must be detailed on the FAA form 7460-1 submittal. The property owner shall provide Aviation staff a copy of the FAA determination letter prior to building permit issuance.
- 12. With the construction document submittal, the property owner shall submit an aircraft noise and overflight disclosure notice that is to be provided to occupants, potential homeowners, employees and/or students. The disclosure form shall bin in a form acceptable to the Scottsdale Aviation Director, prior to the issuance of any building permit, not including a native plant permit.
- 13. With the construction document submittal, the applicant shall submit a Airport Vicinity Development short form.

STREET INFRASTRUCTURE:

Ordinance

F. All street infrastructure improvements shall be constructed in accordance with this City of Scottsdale (COS) Supplement to MAG Specifications and Details, and the Design Standards and Policies Manual.

DRB Stipulations

14. All curb ramps for public and pedestrian sidewalks that intersect public and private streets, or driveways that intersect public and private streets, shall have truncated domes that are colored to match OSHA Safety Yellow, FED-STD-595C, 13591.

DRAINAGE AND FLOOD CONTROL:

DRB Stipulations

15. With the civil construction document submittal, the property owner shall submit a final drainage report that demonstrates consistency with the DSPM and the case drainage report accepted in concept by the Stormwater Manager or designee.

EASEMENTS DEDICATIONS:

DRB Stipulations

- 16. Prior to the issuance of any building permit for the development project, the property owner shall dedicate the following easements to the City of Scottsdale on a final plat or map of dedication:
 - a. An avigation easement per Section 5-357.
 - b. A sight distance easement, in conformance with figures 5.3-26 and 5.3-27 of Section 5.3 of the DSPM, where a sight distance triangle(s) cross on to the property.

ADDITIONAL ITEMS:

DRB Stipulations

17. At time of final plans, the applicant shall assemble current parcel numbers 215-56-029 and 215-56-027C. The land assemblage shall be recorded prior to issuance of any building permit for the site.



NOT FOR CONSTRUCTION



BARN SCOTTSDALE


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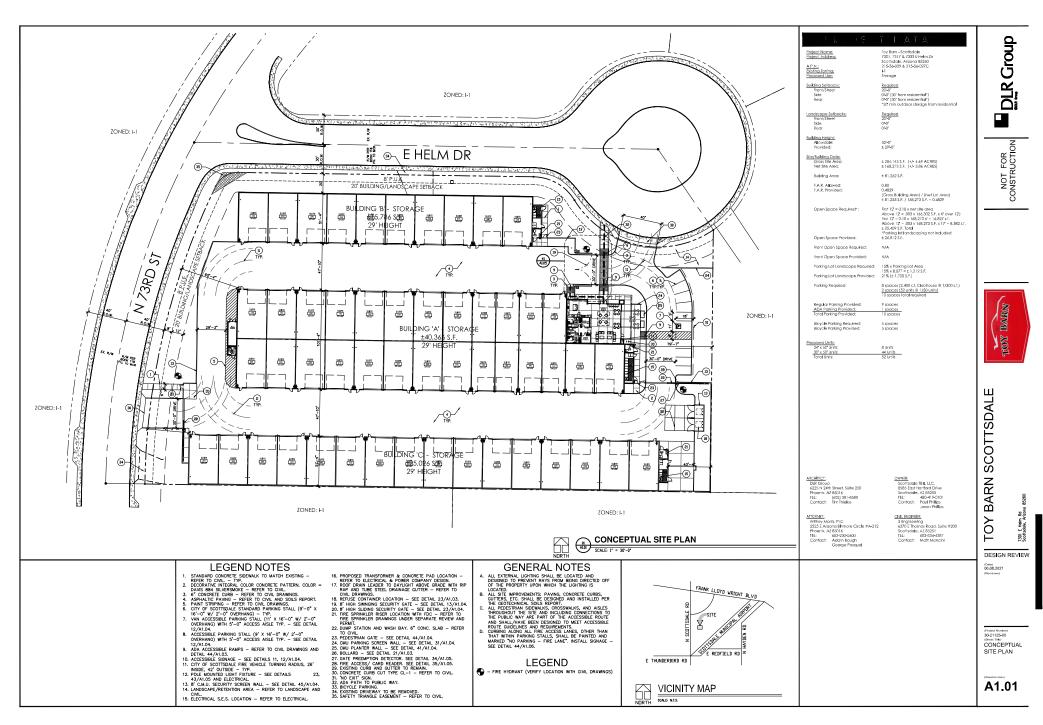
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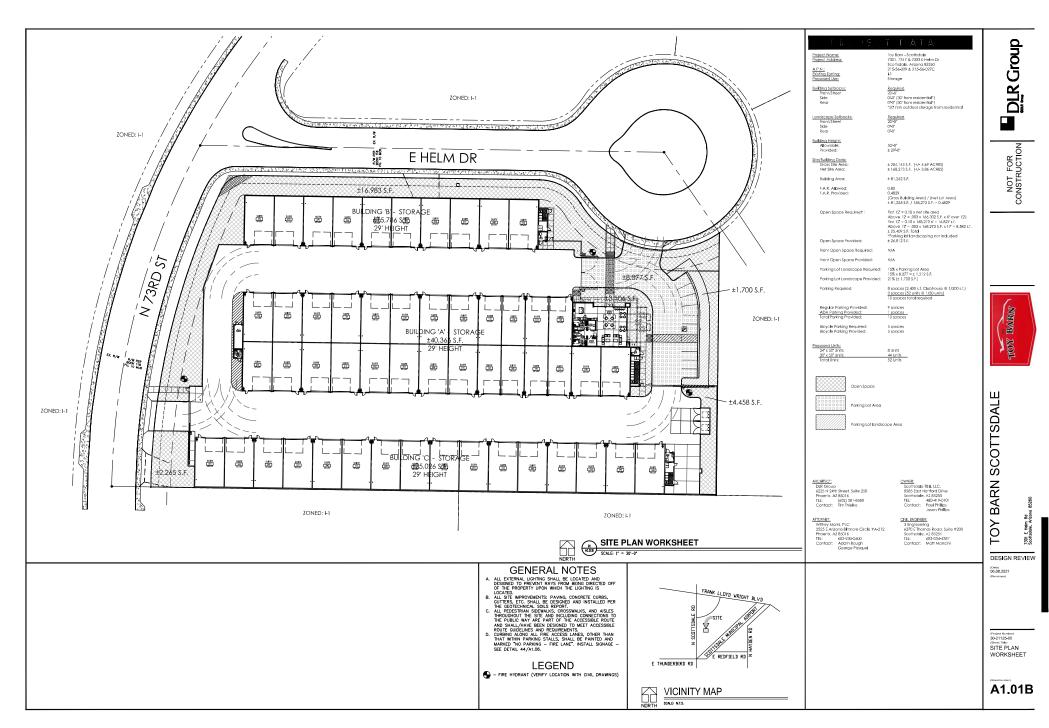
(Date) 3.5.2021 (Revenue)

(Project Number) 30-21125-00 (Sheet Tille) CONTEXT PLAN

A1.01A





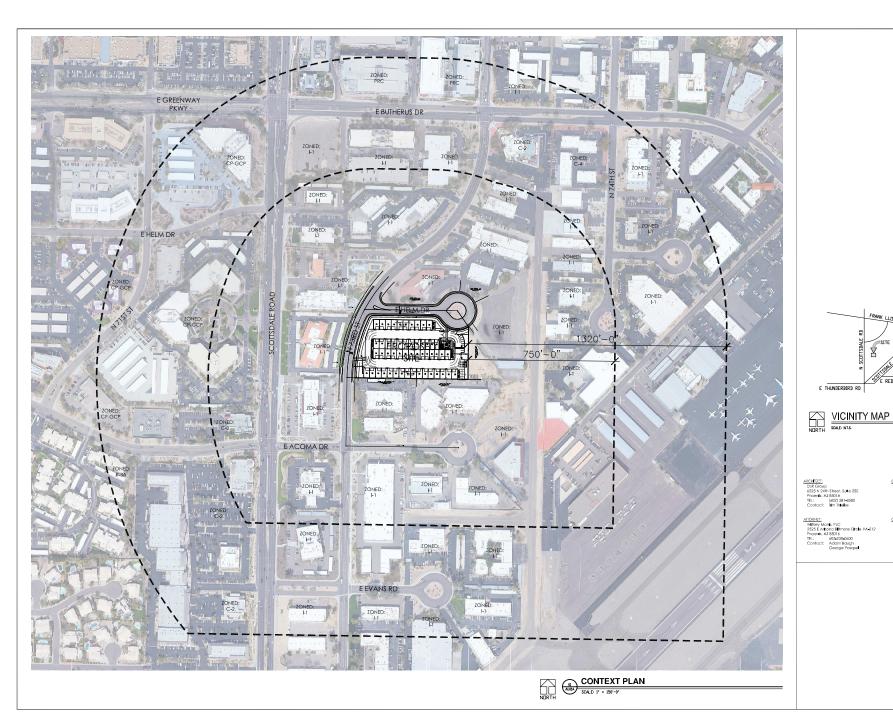

TOY BARN - SCOTTSDALE

roject consultants

CBC 2345, LLC 8585 E HARTFORD ROAD #116 SCOTISDALE, AZ 85255 PROJECT CONTACT: PAUL PHILLIPS PHONE: 480.419.0101

Ismalacana arabitactura

DESIGN ETHIC, LLC 7525 EAST 6TH AVENUE 7525 EAST 6TH AVENUE 7525 EAST EAST EAST PROJECT CONTACT: BRANDON PAUL PHONE: 480 225,707 EMAIL:Scott.bpaul@designethic.net

\$ ENGINEERING 63/0 E. THOMAS RD #200 \$COTISDALE. AZ 85251 PROJECT CONTACT: MATT MANCINI PHONE: 602.334.4387 EMAIL: matt@3engineering.com


GROUP N 24TH STREET, SUITE 250 ENIX, AZ 85016 JECT CONTACT: CHANDLER ESKEW NE: 602.381.8580

sheet index

SHEET	TITLE	
L.01	COVER SHEET	
L.02 - L.03	PLANTING PLAN	

site data

215-56-029 & 215-56-0270 204,241 S.F. (+/- 4.69 ACRES + 84,403 S.F.

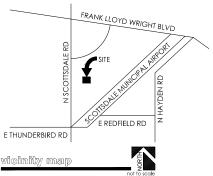



city of scottsdale notes:

- AREAS OF DECOMPOSED GRANITE WITHOUT PLANT MATERIALS/GROUNDCOVERS SHALL NOT EXCEED DIMENSIONS OF MORE THAN 7' IN ANY ONE DIRECTION. MEASURED BETWEEN PLANT CANOPIES AND/OR COVERAGE.
- 2. A MINIMUM OF 50% OF THE PROVIDED TREES SHALL BE MATURE TREES, PURSUANT TO THE CITY OF SCOTTSDALE'S ZONING ORDINANCE ARTICLE X, SECTION 10.301, AS DEFINED IN THE CITY OF SCOTTSDALE'S ZONING ORDINANCE ARTICLE III. SECTION 3.100
- A SINGLE TRUNK TREE'S CALIPER SIZE, THAT IS TO BE EQUAL OR LESS THAN 4" SHALL BE DETERMINED BY UTILIZING THE SMALLEST DIAMETER OF THE TRUNK 6 INCHES ABOVE FINISHED GRADE ADJACENT TO THE TRUNK, TREE'S CALIPER SIZE, FOR SINGLE TRUNK TREES THAT ARE TO HAVE A DIAMETER GREATER THAN 4-INCHES, SHALL BE DETERMINED BY UTILIZING THE SMALLEST DIAMETER OF THE TRUNK 12-INCHES ABOVE FINISHED GRADE ADJACENT TO THE TRUNK, A MULTIPLE TRUNK TREE'S CALIPER SIZE IS MEASURED AT 6" ABOVE THE LOCATION THAT THE TRUNK SPLITS ORIGINATES, OR 6" ABOVE FINISHED GRADE IF ALL TRUNKS ORIGINATE FROM THE SOIL.
- AREA WITHIN THE SIGHT DISTANCE TRIANGLES IS TO BE CLEAR OF LANDSCAPING, SIGNS, OR OTHER VISIBILITY OBSTRUCTIONS WITH A HEIGHT GREATER THAN 2 FEET. TREES WITHIN THE SAFETY TRIANGLE SHALL HAVE A CANOPY THAT BEGINS AT 7 FEET IN HEIGHT UPON INSTALLATION. ALL HEIGHTS ARE MEASURED FROM NEAREST STREET LINE ELEVATION.
- NO TURF AREAS ARE TO BE PROVIDED.
- RETENTION/DETENTION BASINS SHALL BE CONSTRUCTED SOLELY FROM THE APPROVED DESIGN (ADDITIONAL FILL, BOULDERS, ETC.) SHALL REQUIRE ADDITIONAL FINAL PLANS STAFF REVIEW AND APPROVAL.
- ALL RIGHTS-OF-WAY ADJACENT TO THIS PROPERTY SHALL BE LANDSCAPED AND MAINTAINED BY THE PROPERTY OWNER.
- PRIOR TO THE ESTABLISHMENT OF WATER SERVICE, NON-RESIDENTIAL PROJECTS WITH AN ESTIMATED ANNUAL WATER DEMAND OF TEN (10) ACRE-FEET OF MORE SHALL SUBMIT A CONSERVATION PLAN IN CONFORMANCE WITH SECTIONS 49-245 THROUGH 49-248 OF THE CITY CODE TO THE WATER CONSERVATION OFFICE.
- NO LIGHTING IS PROPOSED WITH THIS SUBMITTAL.
- 10. THE LANDSCAPE SPECIFICATION SECTION(S) OF THESE PLANS ARE NOT REVIEWED AND SHALL NOT BE PART OF THE CITY OF SCOTTSDALE'S APPROVAL.
- 11. ALL SIGNS REQUIRE SEPARATE PERMITS AND APPROVALS.
- 12. NEW LANDSCAPING, INCLUDING SALVAGED PLANT MATERIAL, AND LANDSCAPING INDICATED TO REMAIN WHICH IS DESTROYED, DAMAGED, OR EXPIRES DURING CONSTRUCTION SHALL BE REPLACED WITH LIKE SIZE, KIND. AND QUANTITY PRIOR TO THE ISSUANCE OF THE CERTIFICATE OF OCCUPANCY / LETTER OF ACCEPTANCE TO THE SATISFACTION OF THE INSPECTION SERVICES STAFF.

LANDSCAPE PLAN APPROVED CITY OF SCOTTSDALE

CASE NUMBER

APPROVED BY

CONSTRUCTION AND INSTALLATION SHALL BE IN ACCORDANCE WITH THIS PLAN AND ALL DEVIATIONS WILL REQUIRE REAPPROVAL, THE CITY WILL NOT ISSUE A C OF O UNTIL INSPECTION SERVICES STAFF APPROVES THE LANDSCAPE INSTALLATION.

ALL LANDSCAPE AREAS AND MATERIALS, INCLUDING THOSE LOCATED IN PUBLIC RIGHTS-OF-WAY, SHALL BE MAINTAINED IN A HEALTHY, NEAT CLEAN AND WEED- FREE CONDITION. AMERICAN NATIONAL STANDARDS INSTITUTE (ANSI) A300 STANDARD PRACTICES FOR PRUNING, SUPPORT SYSTEMS, AND SAFETY SHALL BE USED FOR MAINTENANCE CRITERIA. THIS SHALL BE THE RESPONSIBILITY OF THE PROPERTY OWNER.







COTTSDALE, ARIZONA

SET:

21-009

COVER SHEET

JOB NO: DATE: DRAWN BY bo SUBMITTED: 04.29.2021

SHEET L.01

of



plant legend

	botanical name common name	size	qty	comments
trees				
· 3/~	ACACIA ANEURA MULGA	24" BOX	21	H., W., CAL. STAKE'IN PLACI
	PARKINSONIA PRAECOX	24"	25	H., W., CAL.
:714/	PALO BREA PITHECELLOBIUM FLEXICAULE	BÓX 24"	8	STAKE IN PLAC
9	TEXAS EBONY	24" BOX	0	H., W., CAL. STAKE'IN PLAC
shrubs	ERICAMERIA LARICIFOLIA	5 GAL.	78	
_	TURPENTINE BUSH LARREA TRIDENTATA	5 GAL.	20	
3	CREOSOTE			
0	TECOMA STANS YELLOW BELLS	5 GAL.	15	
accents				
*	ALOE BARBADENSIS ALOE VERA	5 GAL.	8	
•	ALOE X. BLUE ELF BLUE ELF ALOE	5 GAL.	108	
*	ASCLEPIAS SUBULATA DESERT MILKWEED	5 GAL.	60	
3	EUPHORBIA TRICUCALLI STICKS OF FIRE	5 GAL.	24	
*	FOUQUIERIA SPLENDENS OCOTILLO	5 GAL.	24	
0	MUHLENBERGIA RIGENS DEER GRASS	5 GAL.	134	
•	MUHLENBERGIA RIGIDA NASHVILLE DEER GRASS	5 GAL.	46	
•	OPUNTIA FICUS INDICA INDIAN FIG. PRICKLY PEAR	5 GAL.	8	
⊛	OPUNTIA SANTA-RITA PURPLE PRICKLY PEAR	5 GAL.	23	
•	PEDILANTHUS MACROCARPUS SLIPPER PLANT	5 GAL.	53	
•	PORTULACARIA AFRA ELEPHANTS FOOD	5 GAL.	21	
•	YUCCA PALLIDA PALE LEAF YUCCA	5 GAL.	149	
groundco				
	EREMOPHILA GLABRA	5 GAL.	199	
_	'MIGNEW GOLD'. OUTBACK SUNRISE EMU			

planting key notes

thorny planting note:

2" MINIMUM IN ALL PLANTERS

THORNY TREES, SHRUBS AND CACTI SHALL BE PLANTED

1/2" MINUS

SO THAT THEIR MATURE SIZE/CANOPY WILL BE AT LEAST PROPERTY LINE / RIGHT OF WAY LINE 4 FEET AWAY FROM ANY WALKWAYS OR PARKING AREA CURBING. PLEASE REFER TO DSPM SEC. DECOMPOSED GRANITE IN ALL PLANTING AREAS 2-1.501.L. SIGHT VISIBILITY TRIANGLE, MAXIMUM MATURE PLANT MATERIAL HEIGHT IN THE SIGHT VISIBILITY TRIANGLES IS 24 INCHES

1/2" DECOMPOSED GRANITE

ACCESSIBLE RAMP. SEE CIVIL ENG. PLANS.

8'-4" SIDEWALK.

6'-0" SIDEWALK.

FIRE HYDRANT -3'-0" CLEAR OF ALL PLANT MATERIA

FIRE LINE BACKFLOW PREVENTOR - SCREEN MAINTAIN 3' ACCESS & CLEARANCE PER MAG STANDARD DETAIL 362.

VEHICLE GATE

CURB. SEE CIVIL ENG. PLANS.

STORMWATER RETENTION. SEE CIVIL ENG. PLANS.

DRAINAGE STRUCTURE, SEE CIVIL ENG. PLANS.

TRASH ENCLOSURE. SEE ARCHITECT'S SITE PLAN.

NOTE: NOT ALL KEYNOTES USED ON THIS SHEET

TOY BARN SCOTTSDALE

21-009

SCOTTSDALE, ARIZONA


PLANTING PLAN

JOB NO: DATE: DRAWN BY:

bp 04.29.2021

L.02 of




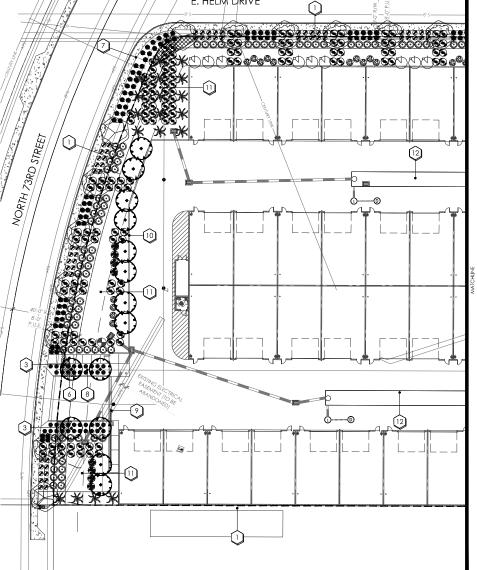

CALL TWO WORKING DAYS BEFORE YOU DIG

602-263-1100 1-800-STAKE-IT


(OUTSIDE MARICOPA COUNT

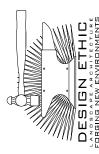







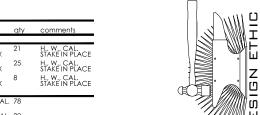







SCOTTSDALE **TOY BARN**

JOB NO:

DRAWN BY

SUBMITTED:

L.03

DATE:

SET:

21-009


OTTSDALE, ARIZONA

PLANTING PLAN

bp 04.29.2021

of



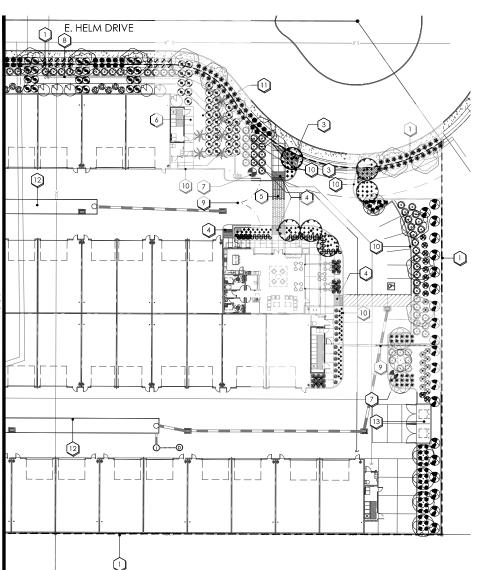

plant legend botanical name common name size ACACIA ANEURA MULGA 24" BOX PARKINSONIA PRAECOX PALO BREA 24" BOX PITHECELLOBIUM FLEXICAULE TEXAS EBONY 24" BOX ERICAMERIA LARICIFOLIA TURPENTINE BUSH 5 GAL. 78 LARREA TRIDENTATA CREOSOTE 5 GAL. 20 TECOMA STANS YELLOW BELLS 5 GAL. 15 <u>accents</u> ALOE BARBADENSIS ALOE VERA 5 GAL. 8 5 GAL. 108 ASCLEPIAS SUBULATA DESERT MILKWEED 5 GAL. 60 EUPHORBIA TRICUCALLI STICKS OF FIRE 5 GAL. 24 FOUQUIERIA SPLENDENS OCOTILLO 5 GAL. 24 MUHLENBERGIA RIGENS DEER GRASS 5 GAL. 134 0 MUHLENBERGIA RIGIDA NASHVILLE DEER GRASS 5 GAL. 46 OPUNTIA FICUS INDICA INDIAN FIG PRICKLY PEAR 5 GAL. 8 OPUNTIA SANTA-RITA PURPLE PRICKLY PEAR 5 GAL. 23

PEDILANTHUS MACROCARPUS SLIPPER PLANT PORTULACARIA AFRA ELEPHANTS FOOD

YUCCA PALLIDA PALE LEAF YUCCA • groundcover

EREMOPHILA GLABRA 'MIGNEW GOLD'. OUTBACK SUNRISE EMU •

1/2" DECOMPOSED GRANITE 1/2" MINUS

5 GAL. 53

5 GAL, 21

5 GAL. 149

5 GAL. 199

2-1.501.L.

2" MINIMUM IN ALL PLANTERS S.F.

thorny planting note:

THORNY TREES, SHRUBS AND CACTI SHALL BE PLANTED SO THAT THEIR MATURE SIZE/CANOPY WILL BE AT LEAST

4 FEET AWAY FROM ANY WALKWAYS OR PARKING AREA CURBING. PLEASE REFER TO DSPM SEC.

planting key notes

PROPERTY LINE / RIGHT OF WAY LINE

DECOMPOSED GRANITE IN ALL PLANTING AREAS

SIGHT VISIBILITY TRIANGLE, MAXIMUM MATURE PLANT MATERIAL HEIGHT IN THE SIGHT VISIBILITY TRIANGLES IS 24 INCHES

ACCESSIBLE RAMP. SEE CIVIL ENG. PLANS.

8'-4" SIDEWALK.

(6) 6'-0" SIDEWALK.

2

FIRE HYDRANT -3'-0" CLEAR OF ALL PLANT MATERIA

FIRE LINE BACKFLOW PREVENTOR - SCREEN MAINTAIN 3' ACCESS & CLEARANCE PER MAG STANDARD DETAIL 362.

VEHICLE GATE

CURB. SEE CIVIL ENG. PLANS.

STORMWATER RETENTION. SEE CIVIL ENG. PLANS.

DRAINAGE STRUCTURE. SEE CIVIL ENG. PLANS.

TRASH ENCLOSURE. SEE ARCHITECT'S SITE PLAN.

NOTE: NOT ALL KEYNOTES USED ON THIS SHEET

CALL TWO WORKING DAYS BEFORE YOU DIG 602-263-1100 1-800-STAKE-IT (OUTSIDE MARICOPA COUNT

MFR: SHERWINN-WILLIAMS (OR APPROVED EQUAL)
COLOR: SW 7640 - 'FAWN BRINDLE', LRV: 36
TO MATCH COLOR FINISH 'E'
APPLICATION: DOORS

MFR: SHERWINN-WILLIAMS (OR APPROVED EQUAL)
COLOR: SW 7083 - 'DARKRODM', LRV: 5
TO MATCH COLOR FINISH 'G' STEEL
APPLICATION: DOORS & SITE ELEMENTS

ARCADIA (OR APPROVED EQUAL) ANODIZED ALUMINUM DARK BRONZE AB-7

SUPERLITE BLOCK (OR APPROVED EQUAL) CENTER SCORE CMU STANDARD GRAY PAINT TO MATCH SHERWINN-WILLIAMS SW 7640 - 'FAWN BRINDLE', LRV: 36

SUPERLITE BLOCK (OR APPROVED EQUAL) SMOOTH FACE CMU STANDARD GRAY PAINT TO MATCH SHERWINN-WILLIAMS SW 7015 - 'REPOSE GRAY', LRV:58

SUPERLITE BLOCK (OR APPROVED EQUAL) SPLIT FACE CMU STANDARD GRAY PAINT TO MATCH SHERWINN-WILLIAMS SW 7083 - 'DARKROOM', LRV: 5

SUPERLITE BLOCK (OR APPROVED EQUAL) SMOOTH FACE CMU STANDARD GRAY PAINT TO MATCH SHERWINN-WILLIAMS SW 9166 - 'DRIFT OF MIST'

MFR: VITRO (OR APPROVED EQUAL)
TYPE: 11 INSULATED GLAZING UNITS
SOLARCOOL (2) GRAY FLOAT GLASS
WITH SOLARBAN 60 (3)
EXTERIOR WINDOWS

PAINT:

A MFR: COLOR:

C MFR: COLOR:

B MFR: FINISH: COLOR: GLAZING:

D MFR: TYPE:

CMU BLOCK


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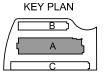
F MFR: TYPE: COLOR:

G MFR: TYPE: COLOR:

H MFR: TYPE: COLOR:


ALUMINUM STOREFRONT:



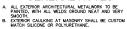







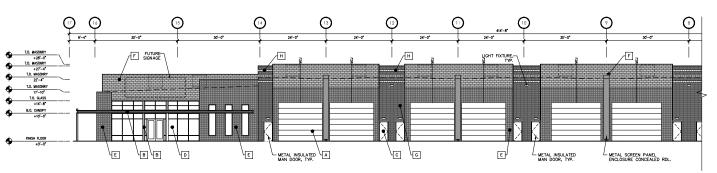

BUILDING A - SOUTH ELEVATION

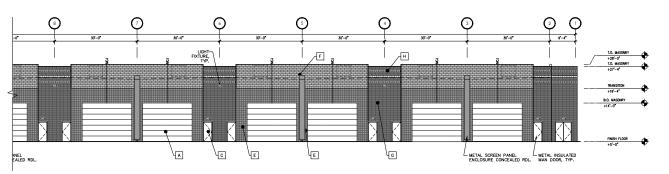

BUILDING A - SOUTH ELEVATION

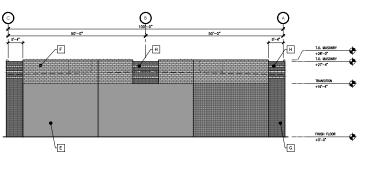

BUILDING A - WEST ELEVATION

ATTACHMENT #11

Z0

DESIGN REVIEW

TO MATCH COLOR FINISH 'E'

SW 7083 - 'DARKROÒM', LRV: 5 TO MATCH COLOR FINISH 'G' STEEL

ARCADIA (OR APPROVED EQUAL)

VITRO (OR APPROVED EQUAL)

WITH SOLARBAN 60 (3)

1" INSULATED GLAZING UNITS

TO MATCH SHERWINN-WILLIAMS

TO MATCH SHERWINN-WILLIAMS SW 7015 - 'REPOSE GRAY', LRV: 58

MATCH SHERWINN-WILLIAMS SW 7083 - 'DARKROOM', LRV: 5

TO MATCH SHERWINN-WILLIAMS

PARASOLEIL (OR APPROVED EQUAL)

SW 9166 - 'DRIFT OF MIST'

PERFORATED MESH PANEL

GOTHAM

AGED BRONZE

SW 7640 - 'FAWN BRINDLE', LRV: 36

SOLARCOOL (2) GRAY FLOAT GLASS

SUPERLITE BLOCK (OR APPROVED EQUAL)

SUPERLITE BLOCK (OR APPROVED EQUAL)

SUPERLITE BLOCK (OR APPROVED EQUAL)

SUPERLITE BLOCK (OR APPROVED EQUAL) SMOOTH FACE CMU STANDARD GRAY PAINT

SPLIT FACE CMU STANDARD GRAY PAINT TO

SMOOTH FACE CMU STANDARD GRAY PAINT

CENTER SCORE CMÙ STANDARD GRAY PÁINT

ANODIZED ALUMINUM

DARK BRONZE AB-7

SHERWINN-WILLIAMS (OR APPROVED EQUAL) SW 7640 - 'FAWN BRINDLE', LRV: 36

SHERWINN-WILLIAMS (OR APPROVED EQUAL)

PAINT:

A MFR: COLOR:

C MFR: COLOR:

B MFR: FINISH:

COLOR:

<u>GLAZING:</u> ____ MFR:

D MFR:

CMU BLOCK

| E | TYPE:

F TYPE: COLOR:

___ MFR:

G TYPE: COLOR:

H MFR: TYPE: COLOR:

. MFR: J TYPE:

METAL ACCENT:

COLOR:

APPLICATION: DOORS


ALUMINUM STOREFRONT:

APPLICATION: DOORS & SITE ELEMENTS

APPLICATION: EXTERIOR WINDOWS


(Project Number) 30-21125-00 (Sheet Title) **EXTERIOR ELEVATIONS BUILDING 'A'**

(Sheet Number) A5.01

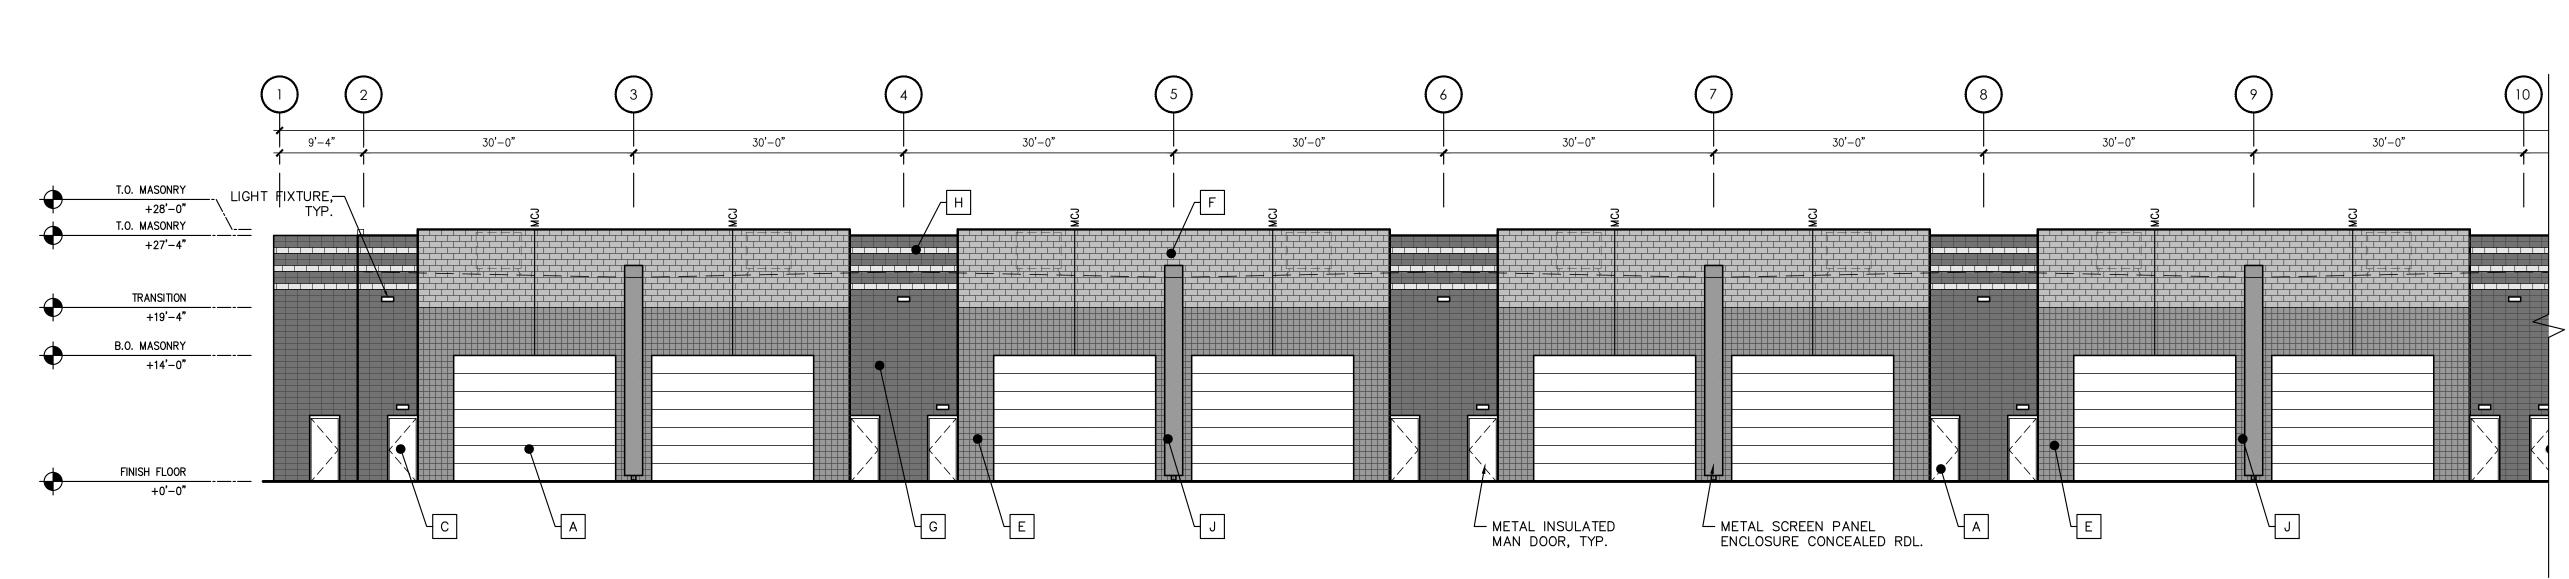


BUILDING A - NORTH ELEVATION

SCALE: 3/32" = 1'-0"

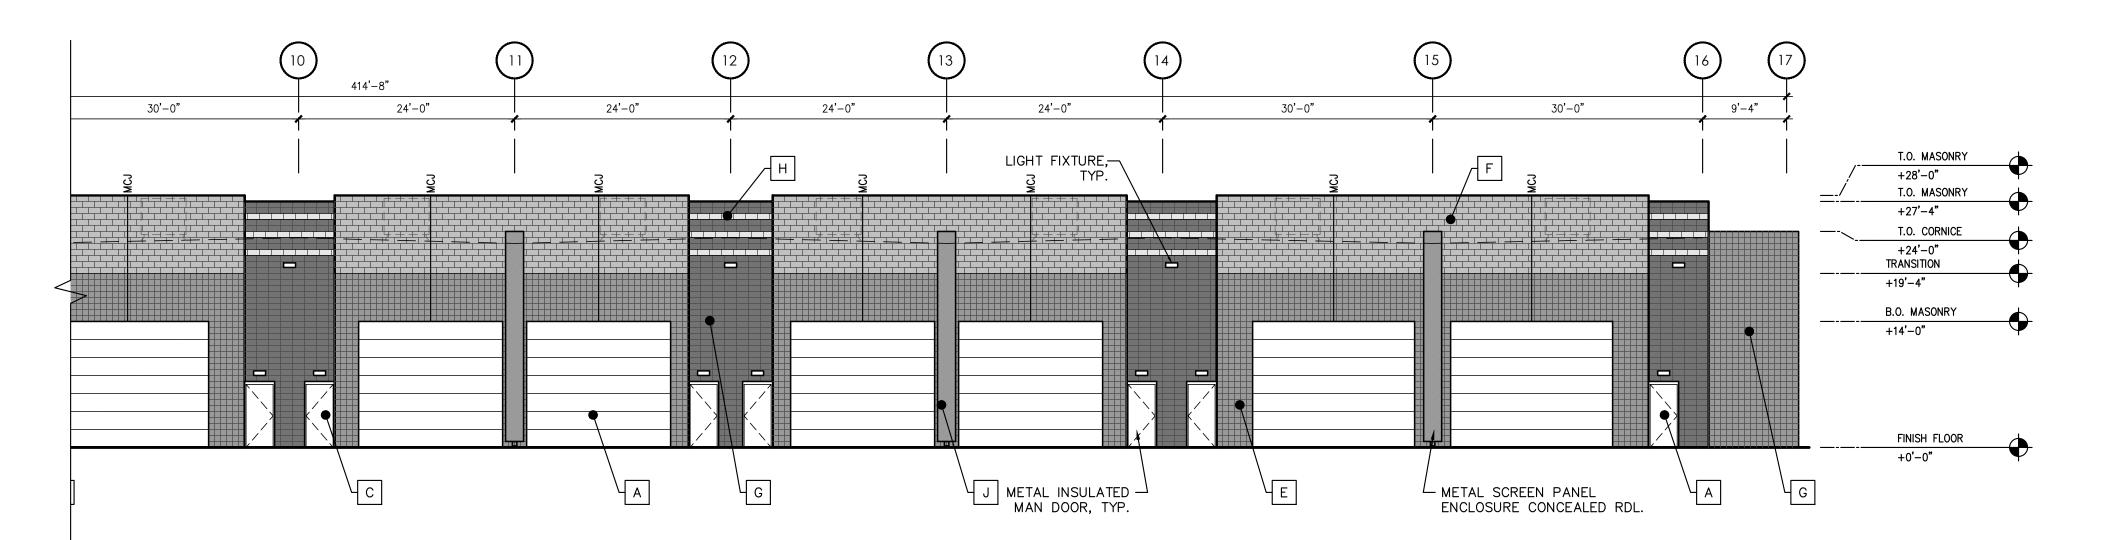

BUILDING A - NORTH ELEVATION

SCALE: 3/32" = 1'-0"

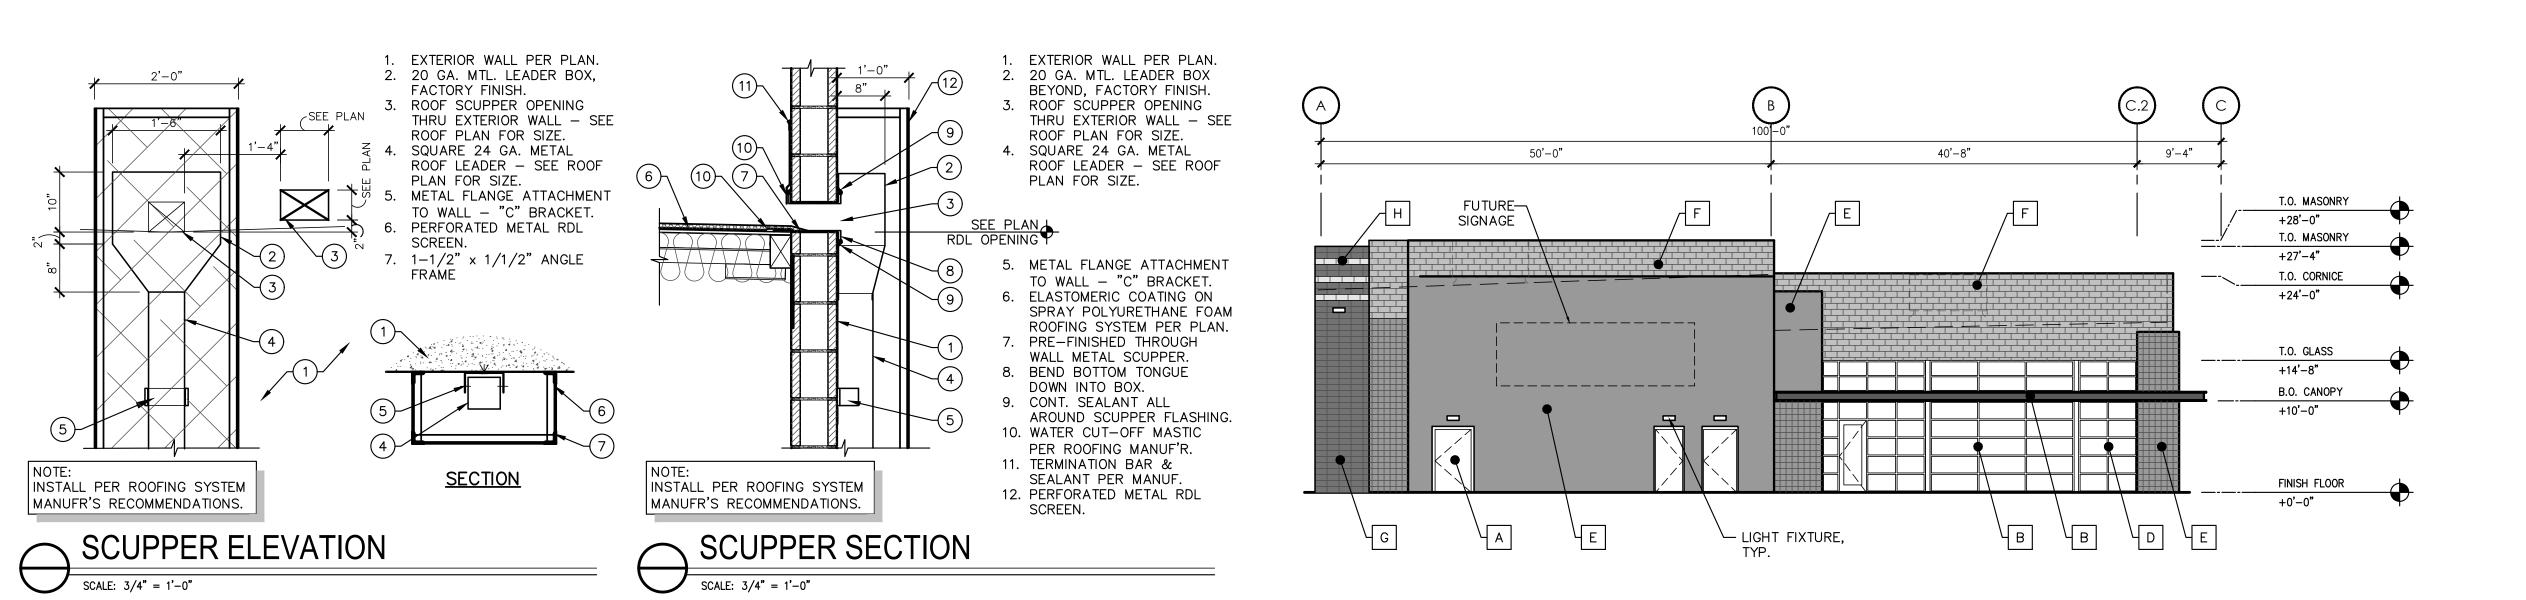



BUILDING A - EAST ELEVATION

SCALE: 3/32" = 1'-0"

GENERAL NOTES

A. ALL EXTERIOR ARCHITECTURAL METALWORK TO BE PAINTED, WITH ALL WELDS GROUND NEAT AND VERY

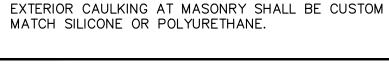

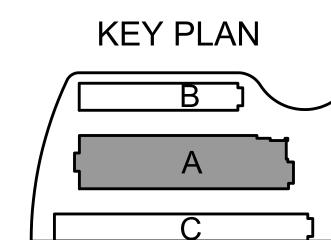

MFR: SHERWINN-WILLIAMS (OR APPROVED EQUAL)
COLOR: SW 7640 - 'FAWN BRINDLE', LRV: 36
TO MATCH COLOR FINISH 'E'
APPLICATION: DOORS

MFR: SHERWINN-WILLIAMS (OR APPROVED EQUAL)
COLOR: SW 7083 - 'DARKRODM', LRV: 5
TO MATCH COLOR FINISH 'G' STEEL
APPLICATION: DOORS & SITE ELEMENTS

ARCADIA (OR APPROVED EQUAL) ANODIZED ALUMINUM DARK BRONZE AB-7

SUPERLITE BLOCK (OR APPROVED EQUAL) CENTER SCORE CMU STANDARD GRAY PAINT TO MATCH SHERWINN-WILLIAMS SW 7640 - 'FAWN BRINDLE', LRV: 36

SUPERLITE BLOCK (OR APPROVED EQUAL) SMOOTH FACE CMU STANDARD GRAY PAINT TO MATCH SHERWINN-WILLIAMS SW 7015 - 'REPOSE GRAY', LRV:58

SUPERLITE BLOCK (OR APPROVED EQUAL) SPLIT FACE CMU STANDARD GRAY PAINT TO MATCH SHERWINN-WILLIAMS SW 7083 - 'DARKROOM', LRV: 5

SUPERLITE BLOCK (OR APPROVED EQUAL) SMOOTH FACE CMU STANDARD GRAY PAINT TO MATCH SHERWINN-WILLIAMS SW 9166 - 'DRIFT OF MIST'

MFR: VITRO (OR APPROVED EQUAL)
TYPE: 11 INSULATED GLAZING UNITS
SOLARCOOL (2) GRAY FLOAT GLASS
WITH SOLARBAN 60 (3)
EXTERIOR WINDOWS

PAINT:

A MFR: COLOR:

C MFR: COLOR:

B MFR: FINISH: COLOR:

GLAZING:

D MFR: TYPE:

CMU BLOCK


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F MFR: TYPE: COLOR:


G MFR: TYPE: COLOR:

H MFR: TYPE: COLOR:


ALUMINUM STOREFRONT:



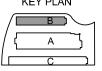


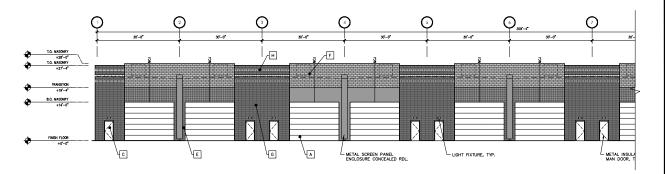

BUILDING B - SOUTH ELEVATION

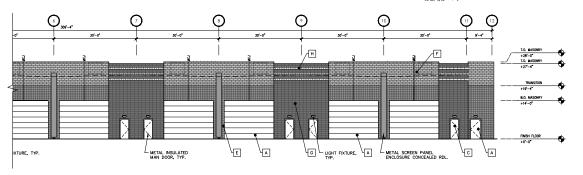

BUILDING B - SOUTH ELEVATION

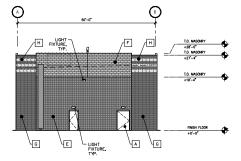

BUILDING B - EAST ELEVATION

SCALE: 3/32" = 1'-0"


GENERAL NOTES

- A. ALL EXTERIOR ARCHITECTURAL METALWORK TO BE PAINTED, WITH ALL WELDS GROUND NEAT AND VERY SMOOTH.


 B. EXTERIOR CAULKING AT MASONRY SHALL BE CUSTOM MATCH SILICONE OR POLYURETHANE.

ELEVATIONS -BUILDING 'B' A5.04


(Project Number) 30-21125-00 (Sheet Title) EXTERIOR

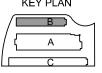




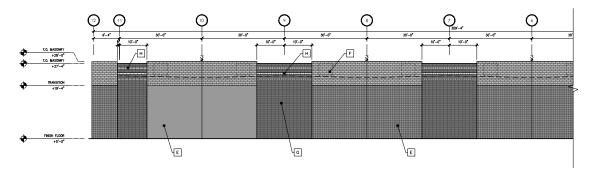

BUILDING B - NORTH ELEVATION

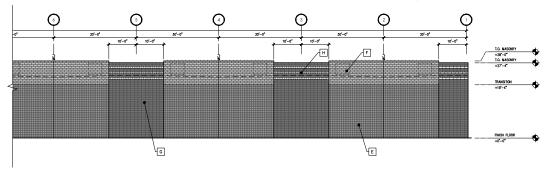

BUILDING B - NORTH ELEVATION

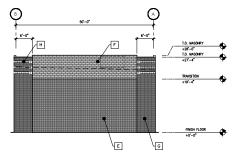

BUILDING B - WEST ELEVATION

SCALE: 3/32" = 1'-0"

FINISH SCHEDULE

PAINT: A MFR: COLOR:

MFR: SHERWINN-WILLIAMS (OR APPROVED EQUAL)
COLOR: SW 7640 - 'FAWN BRINDLE', LRV: 36
TO MATCH COLOR FINISH 'E'
APPLICATION: DOORS

C MFR: COLOR:

MFR: SHERWINN-WILLIAMS (OR APPROVED EQUAL)
COLOR: SW 7083 - 'DARKRODM', LRV: 5
TO MATCH COLOR FINISH 'G' STEEL
APPLICATION: DOORS & SITE ELEMENTS

ALUMINUM STOREFRONT:

ARCADIA (OR APPROVED EQUAL) ANODIZED ALUMINUM DARK BRONZE AB-7 B MFR: FINISH: COLOR:

GLAZING: D MFR: TYPE:

MFR: VITRO (OR APPROVED EQUAL)
TYPE: 11 INSULATED GLAZING UNITS
SOLARCOOL (2) GRAY FLOAT GLASS
WITH SOLARBAN 60 (3)
EXTERIOR WINDOWS

CMU BLOCK

E MFR: TYPE: COLOR:

SUPERLITE BLOCK (OR APPROVED EQUAL) CENTER SCORE CMU STANDARD GRAY PAINT TO MATCH SHERWINN-WILLIAMS SW 7640 - 'FAWN BRINDLE', LRV: 36

F MFR: TYPE: COLOR:

SUPERLITE BLOCK (OR APPROVED EQUAL) SMOOTH FACE CMU STANDARD GRAY PAINT TO MATCH SHERWINN-WILLIAMS SW 7015 - 'REPOSE GRAY', LRV:58

G MFR: TYPE: COLOR:

SUPERLITE BLOCK (OR APPROVED EQUAL) SPLIT FACE CMU STANDARD GRAY PAINT TO MATCH SHERWINN-WILLIAMS SW 7083 - 'DARKROOM', LRV: 5


H MFR: TYPE: COLOR:

SUPERLITE BLOCK (OR APPROVED EQUAL) SMOOTH FACE CMU STANDARD GRAY PAINT TO MATCH SHERWINN-WILLIAMS SW 9166 - 'DRIFT OF MIST'

70∕ DESIGN REVIEW


(Project Number) 30-21125-00 (Sheet Title) EXTERIOR ELEVATIONS -BUILDING 'B'

A5.03

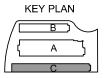


(Project Number) 30-21125-00 (Sheet Title) EXTERIOR ELEVATIONS -BUILDING 'C'


A5.05

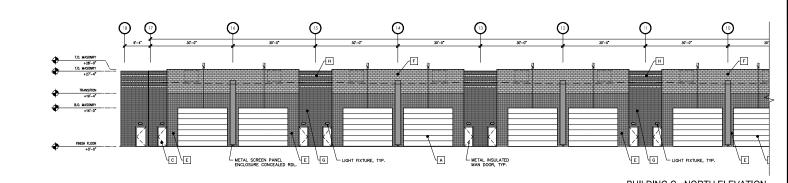

BUILDING C - NORTH ELEVATION

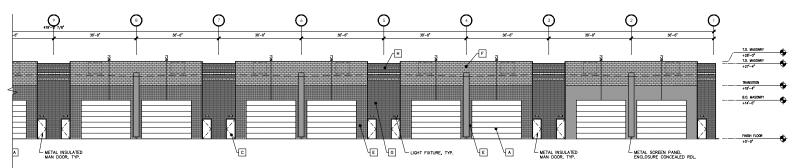

BUILDING C - NORTH ELEVATION

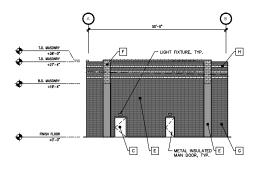

BUILDING C - EAST ELEVATION

FINISH SCHEDULE

PAINT: A MFR: COLOR:

MFR: SHERWINN-WILLIAMS (OR APPROVED EQUAL)
COLOR: SW 7640 - 'FAWN BRINDLE', LRV: 36
TO MATCH COLOR FINISH 'E'
APPLICATION: DOORS

C MFR: COLOR:

MFR: SHERWINN-WILLIAMS (OR APPROVED EQUAL)
COLOR: SW 7083 - 'DARKRODM', LRV: 5
TO MATCH COLOR FINISH 'G' STEEL
APPLICATION: DOORS & SITE ELEMENTS

ALUMINUM STOREFRONT: ARCADIA (OR APPROVED EQUAL) ANODIZED ALUMINUM DARK BRONZE AB-7

B MFR: FINISH: COLOR:

GLAZING:

MFR: VITRO (OR APPROVED EQUAL)
TYPE: 11 INSULATED GLAZING UNITS
SOLARCOOL (2) GRAY FLOAT GLASS
WITH SOLARBAN 60 (3)
EXTERIOR WINDOWS D MFR: TYPE:

CMU BLOCK

E MFR: TYPE: COLOR:

SUPERLITE BLOCK (OR APPROVED EQUAL) CENTER SCORE CMU STANDARD GRAY PAINT TO MATCH SHERWINN-WILLIAMS SW 7640 - 'FAWN BRINDLE', LRV: 36

F MFR: TYPE: COLOR:

SUPERLITE BLOCK (OR APPROVED EQUAL) SMOOTH FACE CMU STANDARD GRAY PAINT TO MATCH SHERWINN-WILLIAMS SW 7015 - 'REPOSE GRAY', LRV:58



SUPERLITE BLOCK (OR APPROVED EQUAL) SPLIT FACE CMU STANDARD GRAY PAINT TO MATCH SHERWINN-WILLIAMS SW 7083 - 'DARKROOM', LRV: 5



SUPERLITE BLOCK (OR APPROVED EQUAL) SMOOTH FACE CMU STANDARD GRAY PAINT TO MATCH SHERWINN-WILLIAMS SW 9166 - 'DRIFT OF MIST'

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GENERAL NOTES

A. ALL EXTERIOR ARCHITECTURAL METALWORK TO BE PAINTED, WITH ALL WELDS GROUND NEAT AND VERY SMOOTH.

B. EXTERIOR CAULKING AT MASONRY SHALL BE CUSTOM MATCH SILICONE OR POLYURETHANE.

MFR: SHERWINN-WILLIAMS (OR APPROVED EQUAL)
COLOR: SW 7640 - 'FAWN BRINDLE', LRV: 36
TO MATCH COLOR FINISH 'E'
APPLICATION: DOORS

MFR: SHERWINN-WILLIAMS (OR APPROVED EQUAL)
COLOR: SW 7083 - 'DARKRODM', LRV: 5
TO MATCH COLOR FINISH 'G' STEEL
APPLICATION: DOORS & SITE ELEMENTS

ARCADIA (OR APPROVED EQUAL) ANODIZED ALUMINUM DARK BRONZE AB-7

SUPERLITE BLOCK (OR APPROVED EQUAL) CENTER SCORE CMU STANDARD GRAY PAINT TO MATCH SHERWINN-WILLIAMS SW 7640 - 'FAWN BRINDLE', LRV: 36

SUPERLITE BLOCK (OR APPROVED EQUAL) SMOOTH FACE CMU STANDARD GRAY PAINT TO MATCH SHERWINN-WILLIAMS SW 7015 - 'REPOSE GRAY', LRV:58

SUPERLITE BLOCK (OR APPROVED EQUAL) SMOOTH FACE CMU STANDARD GRAY PAINT TO MATCH SHERWINN-WILLIAMS SW 9166 - 'DRIFT OF MIST'

MFR: VITRO (OR APPROVED EQUAL)
TYPE: 11 INSULATED GLAZING UNITS
SOLARCOOL (2) GRAY FLOAT GLASS
WITH SOLARBAN 60 (3)
EXTERIOR WINDOWS

PAINT:

A MFR: COLOR:

C MFR: COLOR:

B MFR: FINISH: COLOR: GLAZING:

D MFR: TYPE:

CMU BLOCK


E MFR: TYPE: COLOR:


F MFR: TYPE: COLOR: G MFR: TYPE: COLOR:


H MFR: TYPE: COLOR:


ALUMINUM STOREFRONT:

GENERAL NOTES

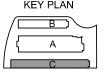


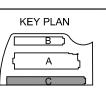

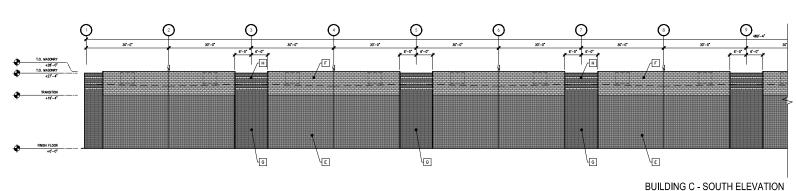

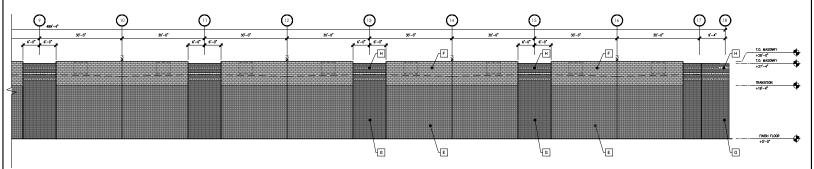

BUILDING C - SOUTH ELEVATION SCALE: 3/32" = 1'-0"

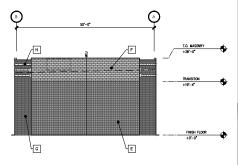

BUILDING C - WEST ELEVATION

SCALE: 3/32" = 1'-0"

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(Date) 06.08.2021

(Project Number) 30-21125-00 (Sheet Title) EXTERIOR ELEVATIONS -BUILDING 'C'

A5.06

MFR: SHERWINN-WILLIAMS (OR APPROVED EQUAL)
COLOR: SW 7640 - 'FAWN BRINDLE', LRV: 36
TO MATCH COLOR FINISH 'E'
APPLICATION: DOORS

MFR: SHERWINN-WILLIAMS (OR APPROVED EQUAL)
COLOR: SW 7083 - 'DARKROOM', LRY: 5
TO MATCH COLOR FINISH 'G' STEEL
APPLICATION: DOORS & SITE ELEMENTS

ARCADIA (OR APPROVED EQUAL) ANODIZED ALUMINUM DARK BRONZE AB-7

SUPERLITE BLOCK (OR APPROVED EQUAL) CENTER SCORE CMU STANDARD GRAY PAINT TO MATCH SHERWINN-WILLIAMS SW 7640 - 'FAWN BRINDLE', LRV: 36

SUPERLITE BLOCK (OR APPROVED EQUAL) SMOOTH FACE CMU STANDARD GRAY PAINT TO MATCH SHERWINN-WILLIAMS SW 7015 - 'REPOSE GRAY', LRV:58

SUPERLITE BLOCK (OR APPROVED EQUAL) SPLIT FACE CMU STANDARD GRAY PAINT TO MATCH SHERWINN-WILLIAMS SW 7083 - 'DARKROOM', LRV: 5

SUPERLITE BLOCK (OR APPROVED EQUAL) SMOOTH FACE CMU STANDARD GRAY PAINT TO MATCH SHERWINN-WILLIAMS SW 9166 - 'DRIFT OF MIST'

MR: VITRO (OR APPROVED EQUAL)

TYPE: 1" INSULATED GLAZING UNITS
SOLARCOOL (2) GRAY FLOAT GLASS
WITH SOLARBAN 60 (3)
EXTERIOR WINDOWS

PAINT:

A MFR: COLOR:

C MFR: COLOR:

B MFR: FINISH: COLOR: GLAZING:

D MFR: TYPE:

CMU BLOCK

E MFR: TYPE: COLOR:

F MFR: TYPE: COLOR:

G MFR: TYPE: COLOR:

H MFR: TYPE: COLOR:

ALUMINUM STOREFRONT:

(Date) 06.08.2021


A. ALL EXTERIOR ARCHITECTURAL METALWORK TO BE PAINTED, WITH ALL WELDS GROUND NEAT AND VERY SMOOTH.

B. EXTERIOR CAULKING AT MASONRY SHALL BE CUSTOM MATCH SILICONE OR POLYURETHANE.


KEY PLAN

(Project Number) 30-21125-00 (Sheet Title) EXTERIOR ELEVATIONS -BUILDING 'A'


A5.02c

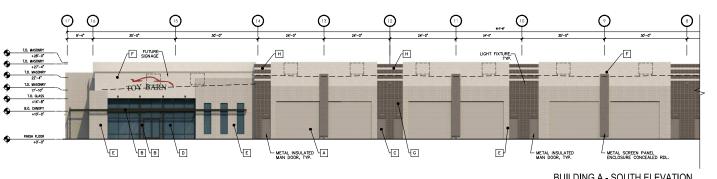

BUILDING A - SOUTH ELEVATION

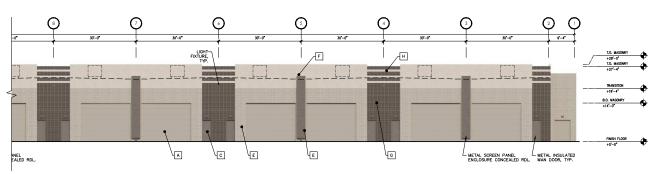



BUILDING A - SOUTH ELEVATION

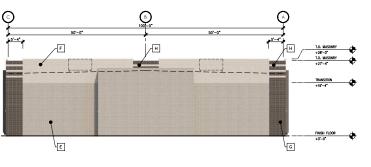


BUILDING A - WEST ELEVATION


ATTACHMENT #12

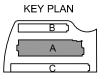

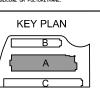


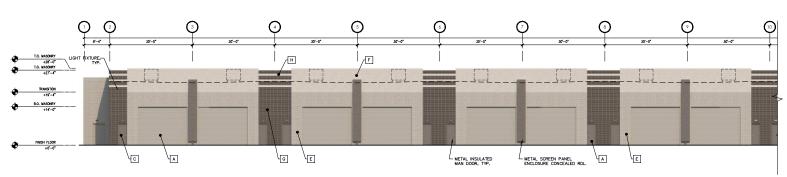

BUILDING A - NORTH ELEVATION

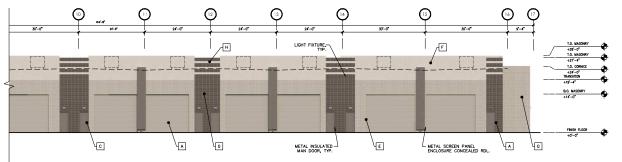

BUILDING A - NORTH ELEVATION

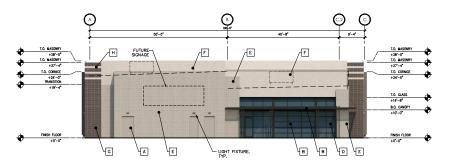

BUILDING A - EAST ELEVATION

FINISH SCHEDULE

PAINT: A MFR: COLOR:

MFR: SHERWINN-WILLIAMS (OR APPROVED EQUAL)
COLOR: SW 7640 - 'FAWN BRINDLE', LRV: 36
TO MATCH COLOR FINISH 'E'
APPLICATION: DOORS

C MFR: COLOR:

MFR: SHERWINN-WILLIAMS (OR APPROVED EQUAL)
COLOR: SW 7083 - 'DARKRODM', LRV: 5
TO MATCH COLOR FINISH 'G' STEEL
APPLICATION: DOORS & SITE ELEMENTS

ALUMINUM STOREFRONT: ARCADIA (OR APPROVED EQUAL) ANODIZED ALUMINUM DARK BRONZE AB-7

B MFR: FINISH: COLOR:

GLAZING: MFR: VITRO (OR APPROVED EQUAL)
TYPE: 11 INSULATED GLAZING UNITS
SOLARCOOL (2) GRAY FLOAT GLASS
WITH SOLARBAN 60 (3)
EXTERIOR WINDOWS D MFR: TYPE:

CMU BLOCK

E MFR: TYPE: COLOR:

SUPERLITE BLOCK (OR APPROVED EQUAL) CENTER SCORE CMU STANDARD GRAY PAINT TO MATCH SHERWINN-WILLIAMS SW 7640 - 'FAWN BRINDLE', LRV: 36

F MFR: TYPE: COLOR:

SUPERLITE BLOCK (OR APPROVED EQUAL) SMOOTH FACE CMU STANDARD GRAY PAINT TO MATCH SHERWINN-WILLIAMS SW 7015 - 'REPOSE GRAY', LRV:58

G MFR: TYPE: COLOR:

SUPERLITE BLOCK (OR APPROVED EQUAL) SPLIT FACE CMU STANDARD GRAY PAINT TO MATCH SHERWINN-WILLIAMS SW 7083 - 'DARKROOM', LRV: 5

H MFR: TYPE: COLOR:

SUPERLITE BLOCK (OR APPROVED EQUAL) SMOOTH FACE CMU STANDARD GRAY PAINT TO MATCH SHERWINN-WILLIAMS SW 9166 - 'DRIFT OF MIST'

GENERAL NOTES

A. ALL EXTERIOR ARCHITECTURAL METALWORK TO BE PAINTED, WITH ALL WELDS GROUND NEAT AND VERY SMOOTH.

B. EXTERIOR CAULKING AT MASONRY SHALL BE CUSTOM MATCH SILCONE OR POLYURETHANE.

(Project Number) 30-21125-00 (Sheet Title) EXTERIOR ELEVATIONS -BUILDING 'A'

(Date) 06.08.2021

A5.01c

MFR: SHERMINI-WILLIAMS (OR APPROVED EQUAL)
COLOR: SW 7640 - "FAWN BRINDLE", LRV: 36
APPLICATION: DOORS

APPLICATION: TO AITCH COLOR FINISH E"

MFR: SHERWINN-WILLIAMS (OR APPROVED EQUAL)
COLOR: SW 7083 - 'DARKRODM', LRV: 5
TO MATCH COLOR FINISH 'G' STEEL
APPLICATION: DOORS & SITE ELEMENTS

ARCADIA (OR APPROVED EQUAL) ANODIZED ALUMINUM DARK BRONZE AB-7

SUPERLITE BLOCK (OR APPROVED EQUAL) CENTER SCORE CMU STANDARD GRAY PAINT TO MATCH SHERWINN-WILLIAMS SW 7640 - 'FAWN BRINDLE', LRV: 36

SUPERLITE BLOCK (OR APPROVED EQUAL) SMOOTH FACE CMU STANDARD GRAY PAINT TO MATCH SHERWINN-WILLIAMS SW 7015 - 'REPOSE GRAY', LRV:58

SUPERLITE BLOCK (OR APPROVED EQUAL) SPLIT FACE CMU STANDARD GRAY PAINT TO MATCH SHERWINN-WILLIAMS SW 7083 - 'DARKROOM', LRV: 5

SUPERLITE BLOCK (OR APPROVED EQUAL) SMOOTH FACE CMU STANDARD GRAY PAINT TO MATCH SHERWINN-WILLIAMS SW 9166 - 'DRIFT OF MIST'

MFR: VITRO (OR APPROVED EQUAL)
TYPE: 11 INSULATED GLAZING UNITS
SOLARCOOL (2) GRAY FLOAT GLASS
WITH SOLARBAN 60 (3)
EXTERIOR WINDOWS

PAINT:

A MFR: COLOR:

C MFR: COLOR:

GLAZING:

D MFR: TYPE:

CMU BLOCK

ALUMINUM STOREFRONT:


(Date) 06.08.2021

(Project Number) 30-21125-00 (Sheet Title) EXTERIOR


ELEVATIONS -BUILDING 'B'

A5.04c




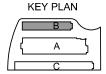




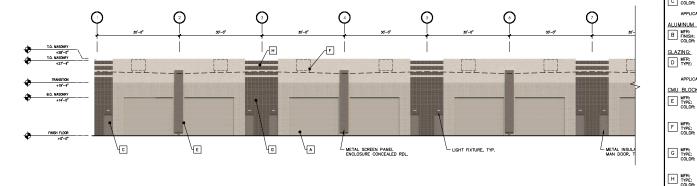

BUILDING B - SOUTH ELEVATION

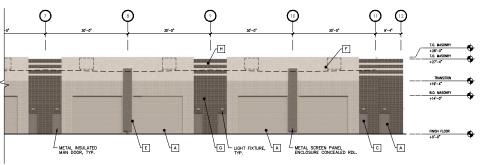

BUILDING B - SOUTH ELEVATION

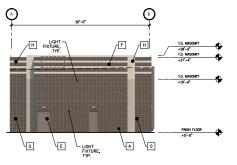


BUILDING B - EAST ELEVATION


SCALE: 3/32" = 1'-0"

A. ALL EXTERIOR ARCHITECTURAL METALWORK TO BE PAINTED, WITH ALL WELDS GROUND NEAT AND VERY SMOOTH.


B. EXTERIOR CAULKING AT MASONRY SHALL BE CUSTOM MATCH SILCONE OR POLYURETHANE.

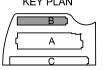




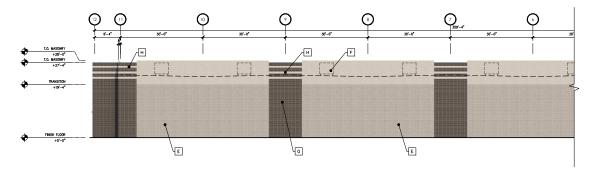

BUILDING B - NORTH ELEVATION

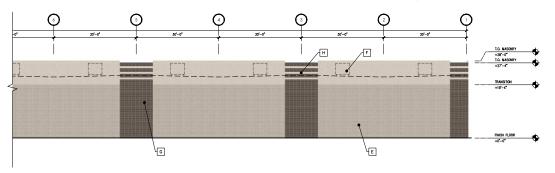

BUILDING B - NORTH ELEVATION

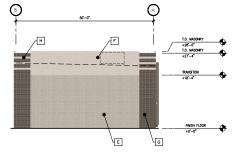

BUILDING B - WEST ELEVATION

SCALE: 3/32" = 1'-0"

FINISH SCHEDULE

PAINT: A MFR: COLOR:

MFR: SHERMINN-WILLIAMS (OR APPROVED EQUAL)
SW 7640 - "FAWN BRINDLE", LRV: 36
TO MATCH COLOR FINISH "E"
APPLICATION: DOORS

C MFR: COLOR:

MFR: SHERWINN-WILLIAMS (OR APPROVED EQUAL)
COLOR: SW 7083 - 'DARKROOM', LRV: 5
TO MATCH COLOR FINISH 'O' STEEL
APPLICATION: DOORS & SITE ELEMENTS

ALUMINUM STOREFRONT: ARCADIA (OR APPROVED EQUAL) ANODIZED ALUMINUM DARK BRONZE AB-7

B MFR: FINISH: COLOR:

GLAZING: MFR: VITRO (OR APPROVED EQUAL)
TYPE: 11 INSULATED GLAZING UNITS
SOLARCOOL (2) GRAY FLOAT GLASS
WITH SOLARBAN 60 (3)
EXTERIOR WINDOWS D MFR: TYPE:

CMU BLOCK

SUPERLITE BLOCK (OR APPROVED EQUAL) CENTER SCORE CMU STANDARD GRAY PAINT TO MATCH SHERWINN-WILLIAMS SW 7640 - 'FAWN BRINDLE', LRV: 36 E MFR: TYPE: COLOR:

F MFR: TYPE: COLOR:

SUPERLITE BLOCK (OR APPROVED EQUAL) SMOOTH FACE CMU STANDARD GRAY PAINT TO MATCH SHERWINN-WILLIAMS SW 7015 - 'REPOSE GRAY', LRV:58

G MFR: TYPE: COLOR:

SUPERLITE BLOCK (OR APPROVED EQUAL) SPLIT FACE CMU STANDARD GRAY PAINT TO MATCH SHERWINN-WILLIAMS SW 7083 - 'DARKROOM', LRV: 5


H MFR: TYPE: COLOR:

SUPERLITE BLOCK (OR APPROVED EQUAL) SMOOTH FACE CMU STANDARD GRAY PAINT TO MATCH SHERWINN-WILLIAMS SW 9166 - 'DRIFT OF MIST'

DESIGN REVIEW

(Project Number) 30-21125-00 (Sheet Title) EXTERIOR ELEVATIONS -BUILDING 'B'

A5.03c

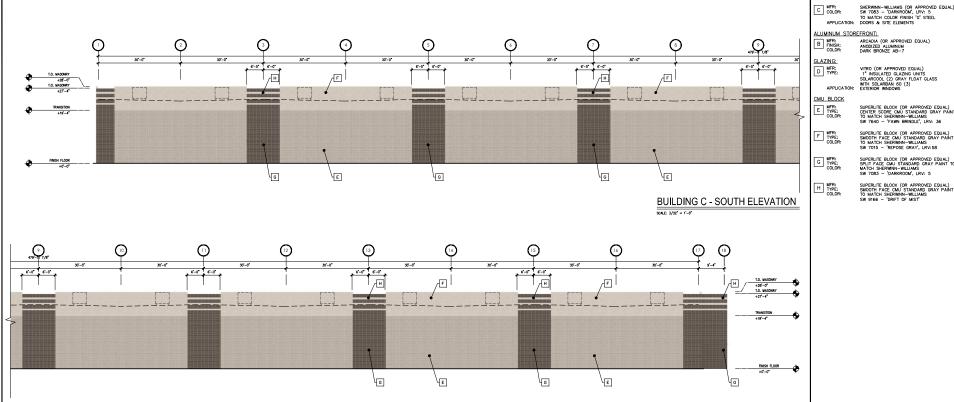

BUILDING C - SOUTH ELEVATION SCALE: 3/32" = 1'-0"

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BUILDING C - WEST ELEVATION

GENERAL NOTES

FINISH SCHEDULE

MFR: SHERWINN-WILLIAMS (OR APPROVED EQUAL)
COLOR: SW 7640 - 'FAWN BRINDLE', LRV: 36
TO MATCH COLOR FINISH 'E'
APPLICATION: DOORS

ARCADIA (OR APPROVED EQUAL) ANODIZED ALUMINUM DARK BRONZE AB-7

SUPERLITE BLOCK (OR APPROVED EQUAL) CENTER SCORE CMU STANDARD GRAY PAINT TO MATCH SHERWINN-WILLIAMS SW 7640 - 'FAWN BRINDLE', LRV: 36


SUPERLITE BLOCK (OR APPROVED EQUAL) SMOOTH FACE CMU STANDARD GRAY PAINT TO MATCH SHERWINN-WILLIAMS SW 7015 - 'REPOSE GRAY', LRV:58

SUPERLITE BLOCK (OR APPROVED EQUAL) SMOOTH FACE CMU STANDARD GRAY PAINT TO MATCH SHERWINN-WILLIAMS SW 9166 - 'DRIFT OF MIST'

PAINT:


A MFR: COLOR:


ALL EXTERIOR ARCHITECTURAL METALWORK TO BE PAINTED, WITH ALL WELDS GROUND NEAT AND VERY SMOOTH.
EXTERIOR CAULKING AT MASONRY SHALL BE CUSTOM MATCH SILICONE OR POLYURETHANE.

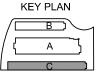


(Project Number) 30-21125-00 (Sheet Title) EXTERIOR ELEVATIONS -BUILDING 'C'


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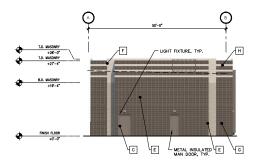


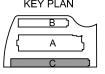

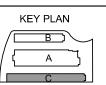BUILDING C - NORTH ELEVATION

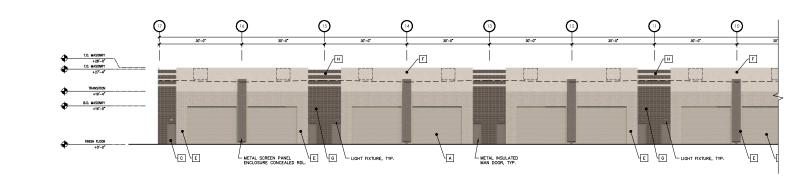

BUILDING C - NORTH ELEVATION

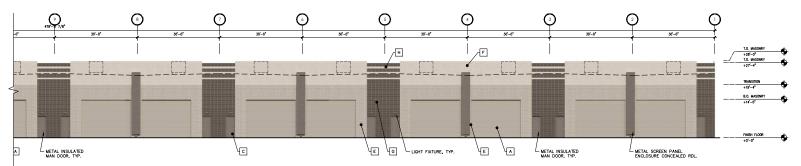

BUILDING C - EAST ELEVATION

ELEVATIONS -BUILDING 'C' A5.05c

(Project Number) 30-21125-00 (Sheet Title) EXTERIOR

GENERAL NOTES

A. ALL EXTERIOR ARCHITECTURAL METALWORK TO BE PAINTED, WITH ALL WELDS GROUND NEAT AND VERY SMOOTH.

B. EXTERIOR CAULKING AT MASONRY SHALL BE CUSTOM MATCH SILICONE OR POLYURETHANE.

SUPERLITE BLOCK (OR APPROVED EQUAL) SMOOTH FACE CMU STANDARD GRAY PAINT TO MATCH SHERWINN-WILLIAMS SW 7015 - 'REPOSE GRAY', LRV:58 SUPERLITE BLOCK (OR APPROVED EQUAL) SPLIT FACE CMU STANDARD GRAY PAINT TO MATCH SHERWINN-WILLIAMS SW 7083 - 'DARKROOM', LRV: 5 SUPERLITE BLOCK (OR APPROVED EQUAL) SMOOTH FACE CMU STANDARD GRAY PAINT TO MATCH SHERWINN-WILLIAMS SW 9166 - 'DRIFT OF MIST'

FINISH SCHEDULE

MFR: SHERWINN-WILLIAMS (OR APPROVED EQUAL)
COLOR: SW 7640 - 'FAWN BRINDLE', LRV: 36
TO MATCH COLOR FINISH 'E'
APPLICATION: DOORS

MFR: SHERWINN-WILLIAMS (OR APPROVED EQUAL)
COLOR: SW 7083 - 'DARKRODM', LRV: 5
TO MATCH COLOR FINISH 'G' STEEL
APPLICATION: DOORS & SITE ELEMENTS

ARCADIA (OR APPROVED EQUAL) ANODIZED ALUMINUM DARK BRONZE AB-7

SUPERLITE BLOCK (OR APPROVED EQUAL) CENTER SCORE CMU STANDARD GRAY PAINT TO MATCH SHERWINN-WILLIAMS SW 7640 - 'FAWN BRINDLE', LRV: 36

MFR: VITRO (OR APPROVED EQUAL)
TYPE: 11 INSULATED GLAZING UNITS
SOLARCOOL (2) GRAY FLOAT GLASS
WITH SOLARBAN 60 (3)
EXTERIOR WINDOWS

PAINT:

A MFR: COLOR:

C MFR: COLOR:

B MFR: FINISH: COLOR: GLAZING:

D MFR: TYPE:

CMU BLOCK

E MFR: TYPE: COLOR:

F MFR: TYPE: COLOR:

G MFR: TYPE: COLOR:

H MFR: TYPE: COLOR:

ALUMINUM STOREFRONT:

TOY BARN

DESIGN REVIEW (Date) 06.08.2021



VIEW FROM 73RD STREET & HELM DRIVE



VIEW AT MAIN ENTRY

PAINT:

COLOR:

SHERWINN-WILLIAMS (OR APPROVED EQUAL) SW 7640 - 'FAWN BRINDLE', LRV: 36

TO MATCH COLOR FINISH 'E'

APPLICATION: DOORS

COLOR:

SHERWINN-WILLIAMS (OR APPROVED EQUAL) SW 7083 - 'DARKROOM', LRV: 5

TO MATCH COLOR FINISH 'G' STEEL

APPLICATION: DOORS & SITE ELEMENTS

ALUMINUM STOREFRONT:

MFR: FINISH:

ARCADIA (OR APPROVED EQUAL)

ANODIZED ALUMINUM COLOR: DARK BRONZE AB-7

GLAZING:

VITRO (OR APPROVED EQUAL) 1" INSULATED GLAZING UNITS SOLARCOOL (2) GRAY FLOAT GLASS

WITH SOLARBAN 60 (3)

APPLICATION: **EXTERIOR WINDOWS**

CMU BLOCK

MFR: TYPE: COLOR: SUPERLITE BLOCK (OR APPROVED EQUAL)
CENTER SCORE CMU STANDARD GRAY PAINT
TO MATCH SHERWINN-WILLIAMS

SW 7640 - 'FAWN BRINDLE', LRV: 36

TYPE:

SUPERLITE BLOCK (OR APPROVED EQUAL)
SMOOTH FACE CMU STANDARD GRAY PAINT

TO MATCH SHERWINN-WILLIAMS SW 7015 - 'REPOSE GRAY', LRV: 58

TYPE:

SUPERLITE BLOCK (OR APPROVED EQUAL)
SPLIT FACE CMU STANDARD GRAY PAINT TO

MATCH SHERWINN-WILLIAMS

SW 7083 - 'DARKROOM', LRV: 5

TYPE:

SUPERLITE BLOCK (OR APPROVED EQUAL)
SMOOTH FACE CMU STANDARD GRAY PAINT

TO MATCH SHERWINN-WILLIAMS

SW 9166 - 'DRIFT OF MIST'

METAL ACCENT:

TYPE:


PARASOLEIL (OR APPROVED EQUAL)

PERFORATED MESH PANEL

GOTHAM

COLOR: AGED BRONZE




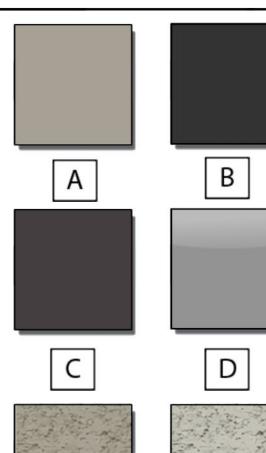








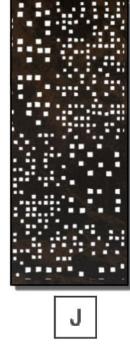




ATTACHMENT #14

ES1.0

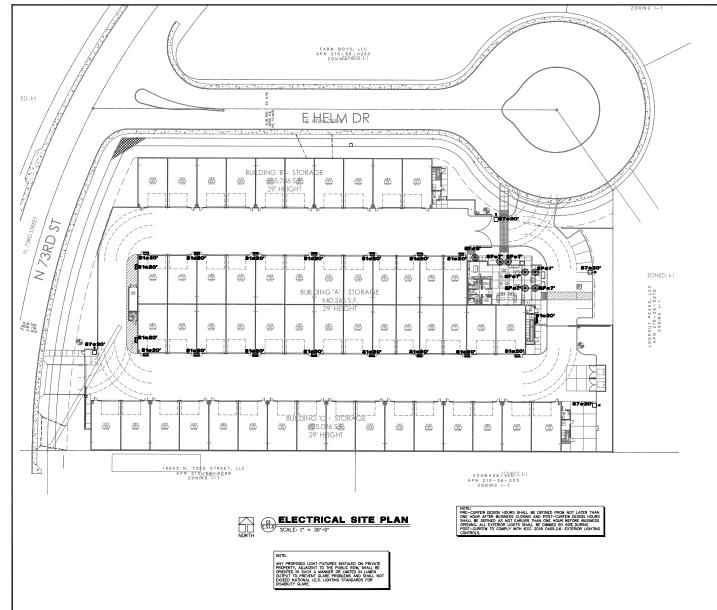

GENERAL NOTES - SITE

- REFER TO ELECTRICAL SPECIFICATIONS FOR ADDITIONAL REQUIREMENTS AND COMPLETE CONTRACTUAL OBLIGATIONS.
- ELECTRICAL CONTRACTOR SHALL CONTACT TELEPHONE COMPANY REGARDING EXACT LOCATION OF ALL PRIMARY SERVICE EQUIPMENT, TRENCH LOCATION, ETC.
- ELECTRICAL CONTRACTOR SHALL PROVIDE ALL NECESSARY TELEPHONE TRENCHING, BACKFILL, AND CONDUIT STUDS INTO TRENCH AS REQUIRED BY TELEPHONE COMPANY AND TO THEIR SPECIFICATIONS.
- 4. ALL WINNS FOR OUTSIDE LIGHTING SHALL BE A MINIUM OF #10 COPPER WITH TYPE THINN INSULATION. RUN UNDERGROUND CIRCUITS IN P.V.C. AND PROVIDE A #10 COPPER BOND IN ADDITION TO CIRCUIT CONDUCTORS. UNDERGROUND WIRING SHALL COMPLY WITH APPLICABLE CODES OF THE NEC.
- ELECTRICAL CONTRACTOR SHALL PROVIDE NECESSARY SECONDARY CONDUCTORS POWER TRENCHING, BACKFILL AND CONCRETE PADS FOR TRANSFORMERS AND SERVICE EQUIPMENT. ADDITIONALLY PROVIDE CONDUIT STUBS INTO TRENCH PER POWER COMPANY SPECIFICATIONS AND REQUIREMENTS.
- 6. ALL WIRING SHALL BE COPPER. WRING #4 AWG AND LARGER SHALL BE XHHW TYPE INSULATION.

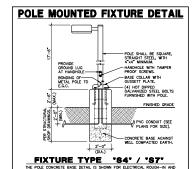


LUMINAIRE SCHEDULE

- PROVIDE 90 MINUTE EMERGENCY BATTERY BACK-UP FOR ALL EMERGENCY FIXTURES, SEE SCHEDULE BELOW FOR SPECIFICATIONS AND LUMEN REQUIREMENTS. MODULAR WRING SYSTEM FOR LIGHT FIXTURES IS AN ACCEPTABLE ALTERNATE.
- BASE BID FOR LUMINAIRES SHALL BE BASED ON MANUFACTURERS LISTED IN CONTRACT DOCUMENTS, UPON MAWARD OF PROLECT, ALTERNATES PROPOSED BY CONTRACTOR SHALL BE SUBMITTED WITH MEDITED OWNER APPROVAL & AN INTEMIZED DEDUCT TO BASE BD.
- ALTERNATE FIXTURE SELECTIONS MAY REQUIRE ADDITIONAL TIME FOR SUBMITTAL REVIEW & POSSIBLE ENGINEERING DESIGN CHANGES, TO BE BILLED TO THE CONTRACTOR. PROVIDE MINIMUM 10 MINUTE TIME DELAY ON EMERGENCY FIXTURES WHEN HID AREA LIGHTING IS USED.

MARK	MANUFACTURER MODEL NUMBER	VOLTS	LAMPS CRI/CCT INPUT WATTS	REMARKS/MOUNTING
81	LITHONIA LIGHTING DSXW2-LED-20C-1000 30K-T4M-NVOLT-DBLXD	MVOLT	LED 3000K 109W	WALL MOUNTED AREA LIGHT. PROVIDE WITH 90 MINUTE BATTERY BACKUP WHERE NOTED 'EM'.
84	UTHONIA LIGHTING RSX1-LED-P3-30K-R3 HS-SPA-DBLXD	MVOLT	LED 3000K 110W	POLE MOUNTED FIXTURE, REFER TO POLE MOUNTED FIXTURE DETAIL THIS SHEET.
87	LITHONIA LIGHTING RSX1-LED-P3-30K-R4 HS-DBLXD	MVOLT	LED 3000K 110W	POLE MOUNTED FIXTURE, REFER TO POLE MOUNTED FIXTURE DETAIL THIS SHEET.
87	LITHONIA LIGHTING LDN6CYL-30/05-L06AR LD-WM-DBL	MVOLT	LED >80/3000K 6W	6" WALL MOUNTED CYLINDER, WET LOCATION RATED, DIMMABLE.


PRELIMINARY NOT FOR CONSTRUCTION


KEY PLAN

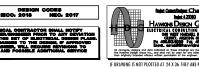

ES2.0



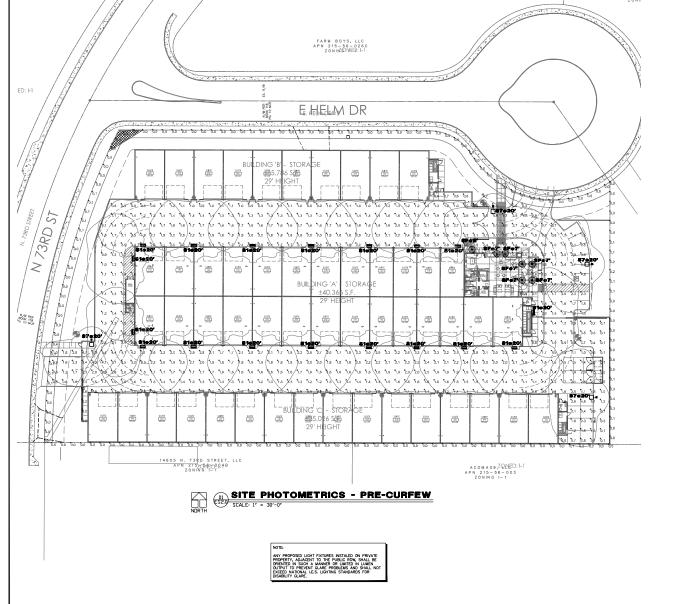


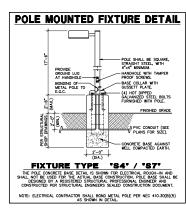





Statistics								
Description	Symbol	Avg	Max	Min	Max/Min	AvgiMin		
FC @ GRADE	+	1,810	7,2 fo	0.0%	NA	NIA		
PROPERTY LINE @	+	0,0 tc	0.5 fc	0,0 fc	N/A	N/A		

Schodule:									
Symbol	Label	QTY	Monufecturer	Catalog Number	Description	Lamp	Lumens per Leggs	LLF	Watage
-	\$1	55	Liberia Lighting	DISKWELED 200 1000 SOK THE MWOLT DISERCE	DISSING LED WITH SLIGHT ENGINES, SO LEDY, 1900-1A DRIVER, 3000K LED, TYPE 4 MEDIJM OPTIC	LED - XXXXX	7076	0.95	73
₽	84	0	Lithonia Lighting	RSKI LED PO 30K R3 H3 SPA DBLKD / SSS 17.9 POLE WITH 2.9 BASE	RSK Area Filtzine Star 1 P2 Lumen Package 3000K CCT Type R3 Distribution with HS Shield	LED -3000K	9737	0.96	109,443
7	87	4	Lithonia Lighting	R8X1 LED P9 30K R4 H8 D8LXD / 888 17 // POLE WITH 2 // 848E	RSK Area Filtaire Star 1 PS Lumen Paulsage 3000K CCT Type R4 Distribution with HS Shieti	LED - 3000K	9094	0.96	109,442
0	86	7	Lithonia Lighting	LONGCYL 35/06 LOSAR LD WM	ON LON CYLINDER, 3000K, SOXLM, CLEAR, MATTE DIPPUSE REPLECTOR, CRED	LED - 3000K	462	0,99	5,74

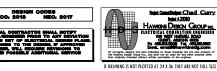

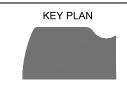

ES2.1

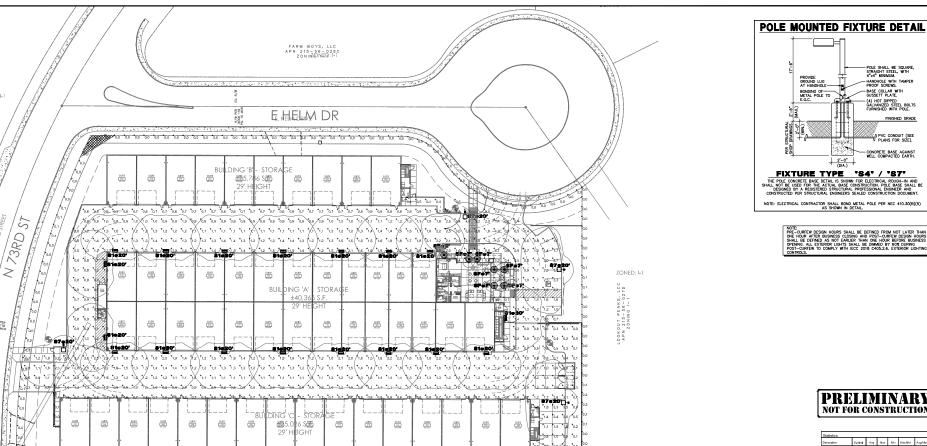

A C O M A O 9 , ZQNED: I-1 A P N 215 - 56 - 003 Z O N IN G I-1

PRELIMINARY NOT FOR CONSTRUCTION

HANDHOLE WITH TAMPER PROOF SCREWS. BASE COLLAR WITH GUSSETT PLATE.

Statistics								
Description	Symbol	Avg	Max	Min	MaxWin	AvgiMi		
FC @ GRADE	+	1,240	4,9 %	0.0 %	NA	NKA		
PROPERTY LINE @	+	0.0 to	0.3 fc	0.0 fc	N/A	N/A		


School.									
Symbol	Label	QTY	Monufacturer	Catalog Number	Description	Lamp	Lumens per Lemo	LUF	Watage
-	\$1	15	Literals Lighting	DISKWIZ LED 200 1000 30K T4M MWGLT DBLKD	DISKING LED WITH S LIGHT ENGINES, 20 LEDs, 1000mA DRIVER, 3000K LED, TYPE 4 MEDIUM OPTIC	LED - 3000K	TOTE	oves	TS
₽	84	0	Lithonia Lighting	RSK1 LED P3 30K R3 HS SPA DBLKD / SSS 17.9 PQLE WITH 2.9 BASE	RSX Area Fixture Stre 1 P2 Lumen Package 3900K CCT Type R3 Distribution with RS Shield	LED - 3000K	9737	0.05	100,443
7	87	4	Lithonia Lighting	R8X1 LED P9 30K R4 H8 D8LXD / 888 17 J7 POLE WITH 2 JF 848E	RSK Area Fisters Size 1 P3 Lurien Pannage 3800K CCT Type R4 Distribution with HS Shield	LED - 3000K	9084	0,66	109,442
•	SF SF	7	Lithonia Lighting	LONGCYL 35/06 LOSAR LO WM	KIN LON CYLINDER, 3000K, SOOLM, CLEAR, MATTE DIFFUSE PEPLECTOR, CHISO	LED-3000K	462	0,65	5,74

SITE PHOTOMETRICS - POST-CURFEW

W PER W 118 U MOR


14605 N. 73RD STREET, LLC

01 SITE PHO

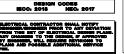






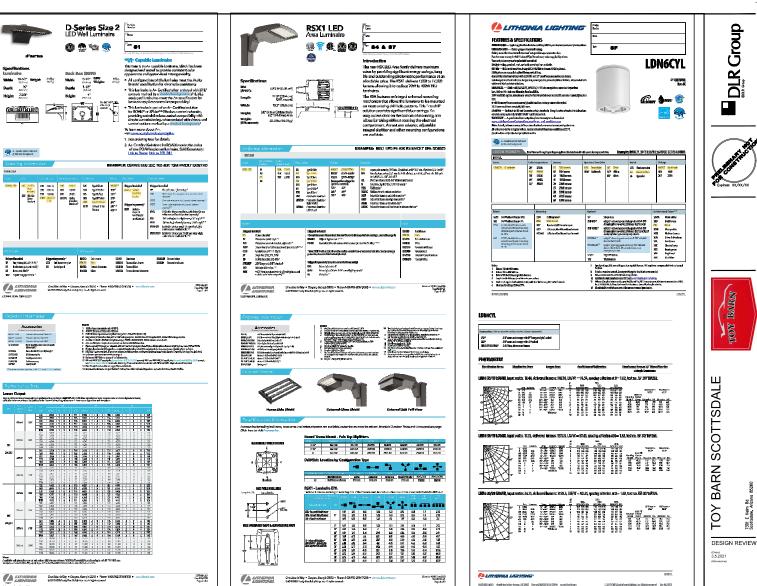





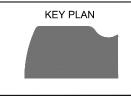





ELECTRICAL

ES3.0

Lumen Gyonut



ATTACHMENT #18



March 1, 2021

Re: 7301 E. Helm Drive, Scottsdale – Development Application (#22-PA-2021)

Dear Property Owner or Interested Citizen:

Our office represents the Toy Barn regarding the roughly 4.7-acre site located at the southeast corner of 73rd Street and Helm Drive in Scottsdale, Assessor Parcel No. 215-56-027C and 215-56-029 (the "Property"), as seen on the attached aerial exhibit. The purpose of this letter is simply to introduce ourselves and to let you know we will be filing a Development Review application with the City of Scottdale for the development of a new Toy Barn at this location.

As you may know, the Toy Barn is an upscale, garage storage community with individual ownership. This is not a standard, self-storage facility, but rather a premium, storage solution for collector enthusiasts of cars, trucks, boats, RVs and other such toys. Each garage condominium is a titled unit with individual ownership. Owners also have access to common areas and a "Member's Only" clubhouse which gives the project a country club atmosphere. This new project is anticipated to have fifty-three (53), for sale units. Attached are some preliminary exhibits. The site layout is oriented with primary access off the cul-de-sac road of Helm Drive. The clubhouse and office are located near the entrance. Gated entries allow access deeper into the site for owner's individual units. A secondary exitonly drive is provided to 73rd Street. The buildings are organized into three (3) rows with two (2) forty-eight (48) foot wide drive aisles. Each building is masonry with metal louvered mechanical screening. Buildings top out around thirty (30) feet in height.

The Property is currently zoned Industrial Park (I-1) and is located within the Greater Airpark Character Area Plan which provides a designation of Airpark Mixed Use (AMU). The existing zoning and Overlay permit the proposed use by right. As with all new development in Scottsdale, a Development Review application is required, and we anticipate submitting that application shortly.

Should you have any questions or comments, I can be reached at George@WitheyMorris.com or 602.230.0600. You may also reach the City's Project Coordinator, Meredith Tessier at 480.312.4211 or at MTessier@Scottsdaleaz.gov. In the future, you should receive notification postcards from the City regarding the case and its scheduled hearing before the Development Review Board (DRB). The DRB reviews architectural design and layout of proposed projects. Information can also be found on the City's website at: http://www.scottsdaleaz.gov/planning-development/projects-in-process.

Again, I would be happy to answer any questions you may have. Feel free to contact me at 602.230.0600 or George@WitheyMorris.com. Thank you for your courtesy and consideration.

Sincerely,

Withey Morris P.L.C.

George Pasquel III


Enclosure: aerial, preliminary site plan, elevations and sample images


ATTACHMENT #19

Aerial Map





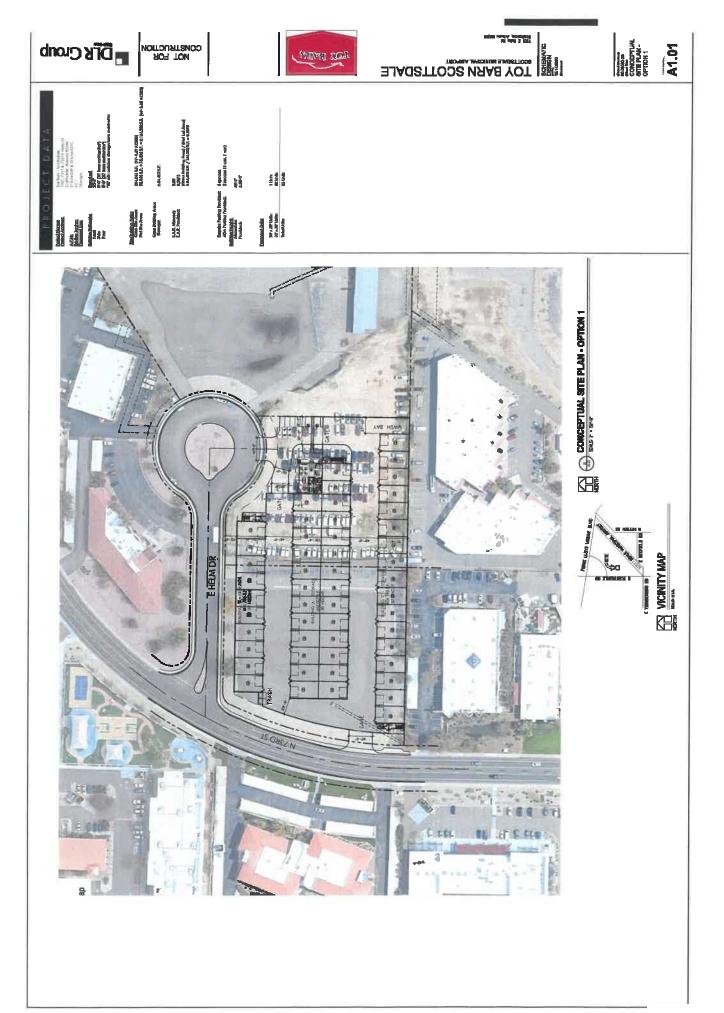

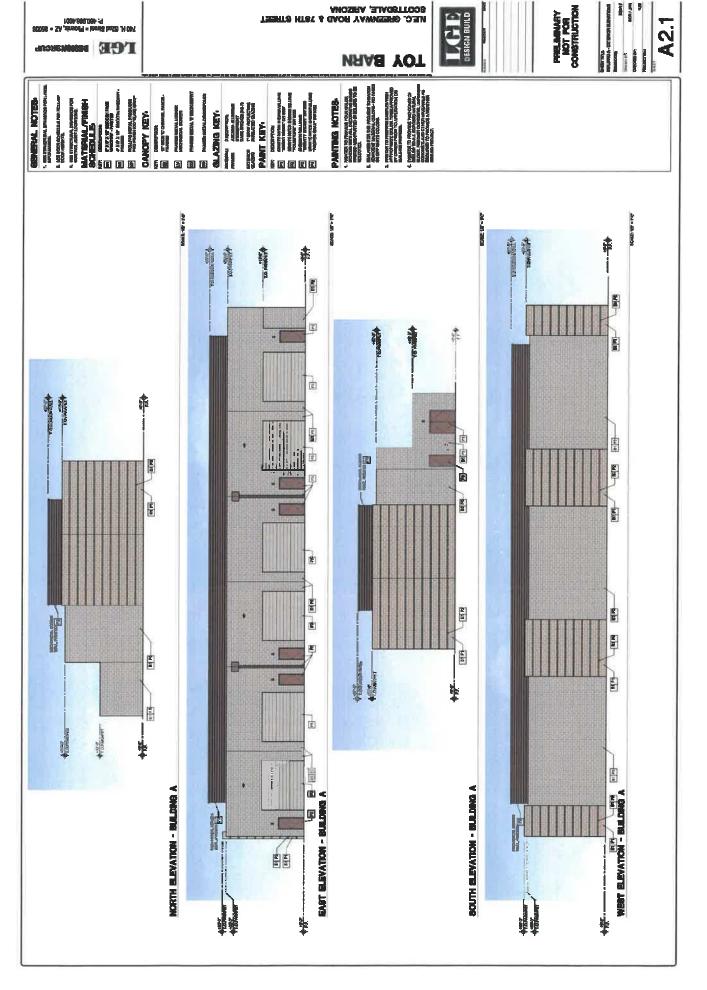

Sample Images





7301 E Helm Dr.

City Notifications – Mailing List Selection Map

Toy Barn Scottsdale

